2006 CONVERSION OF KINDFRGARTFN ARFA AT LAWRENCE CENTRAL RELATED WORK

METROPOLITAN SCHOOL DISTRICT OF LAWRENCE TOWNSHIP

INDIANAPOLIS, INDIANA

GIBRALTAR

DESIGN

ARCHITECTURE ENGINEERING INTERIOR DESIGN

SHEET INDEX

GIO01 COVER SHEET AND INDEX

GI101 LIFE SAFETY PLAN GI201 TYPICAL ACCESSIBLE MOUNTING HEIGHTS, ABBREVIATIONS,

SYMBOLOGY, AND WALL TYPES

S-001 STRUCTURAL TYPICAL SECTION, DETAILS AND NOTES SB101 UNIT "A" STRUCTURAL FOUNDATION/SLAB PLAN SF101 UNIT "A" STRUCTURAL ROOF FRAMING PLAN

AD101 UNIT "A" ARCHITECTURAL FIRST FLOOR DEMOLITION PLAN AD102 UNIT "B" ARCHITECTURAL FIRST FLOOR DEMOLITION PLAN AE101 UNIT "A" ARCHITECTURAL FIRST FLOOR PLAN AE102 UNIT "B" ARCHITECTURAL FIRST FLOOR PLAN AE201 CORRIDOR ELEVATION AND SECTION (ALTERNATE BID) AE202 CORRIDOR SECTIONS (ALTERNATE BID) AE601 DOOR SCHEDULE, FRAME ELEVATIONS, AND DETAILS AR101 CORRIDOR ROOF PLAN AND DETAILS (ALTERNATE BID)

AI801 PLASTIC LAMINATE, WOOD AND WOOD SCIENCE CASEWORK ELEVATIONS, AND SCHEDULES

PD101 UNIT "A" PLUMBING FIRST FLOOR DEMOLITION PLAN PD102 UNIT "B" PLUMBING FIRST FLOOR DEMOLITION PLAN P-101 UNIT "A" PLUMBING FIRST FLOOR PLAN P-102 UNIT "B" PLUMBING FIRST FLOOR PLAN

FP101 FIRE PROTECTION PLAN

MECHANICAL

M-001 MECHANICAL LEGEND AND GENERAL NOTES MD101 UNIT "A" MECHANICAL FIRST FLOOR DEMOLITION PLAN MD102 UNIT "B" MECHANICAL FIRST FLOOR DEMOLITION PLAN M-101 UNIT "A" MECHANICAL FIRST FLOOR PLAN M-102 UNIT "B" MECHANICAL FIRST FLOOR PLAN M-601 MECHANICAL DETAILS & SCHEDULES

E-001 ELECTRICAL SYMBOLS, SCHEDULE, DETAILS & NOTES ED101 UNIT "A" ELECTRICAL FIRST FLOOR DEMOLITION PLAN ED102 UNIT "B" ELECTRICAL FIRST FLOOR DEMOLITION PLAN EL101 UNIT "A" ELECTRICAL FIRST FLOOR LIGHTING PLAN EL102 UNIT "B" ELECTRICAL FIRST FLOOR LIGHTING PLAN EP101 UNIT "A" ELECTRICAL FIRST FLOOR POWER PLAN EP102 UNIT "B" ELECTRICAL FIRST FLOOR POWER PLAN E-601 ELECTRICAL DIAGRAMS, DETAILS AND NOTES



ARCHITECTURE • ENGINEERING • INTERIOR DESIGN

GIBRALTAR DESIGN

CONVERSION of **KINDERGARTEN** AREA at LAWRENCE **CENTRAL** HIGH SCHOOL RELATED WORK PROJECT #1 METROPOLITAN SCHOOL DISTRICT

OF LAWRENCE TOWNSHIP

INDIANAPOLIS, INDIANA

GIBRALTAR DESIGN

9102 N. Meridian St., Ste.

Indianapolis, IN 4626

STATE OF

Homepage www.GibraltarDesign.cc Email info@GibraltarDesign.cc Phone 317.580.5777 Fax 317.580.577

04/03/06 COORDINATED E DRAWN BY MAM CHECKED BY


COPYRIGHT NOTICE: THIS INFORMATION SHALL BE USED BY ANY PERSON OR FIF FOR ANY PURPOSE WITHOUT THE EXPRESS WRITTEN CONSE OF GIBRALTAR DESIGN. THE OWNER MAY RETAIN COPIES FOR INFORMATION AND REFERENCE IN CONNECTION ONLY WITH THE


REVISIONS MARK DATE ISSUED FOR

3/24/06 95% CD REVIEW |4/03/06| 100% CD

SCHOOL AND RELATED WORK

GI00

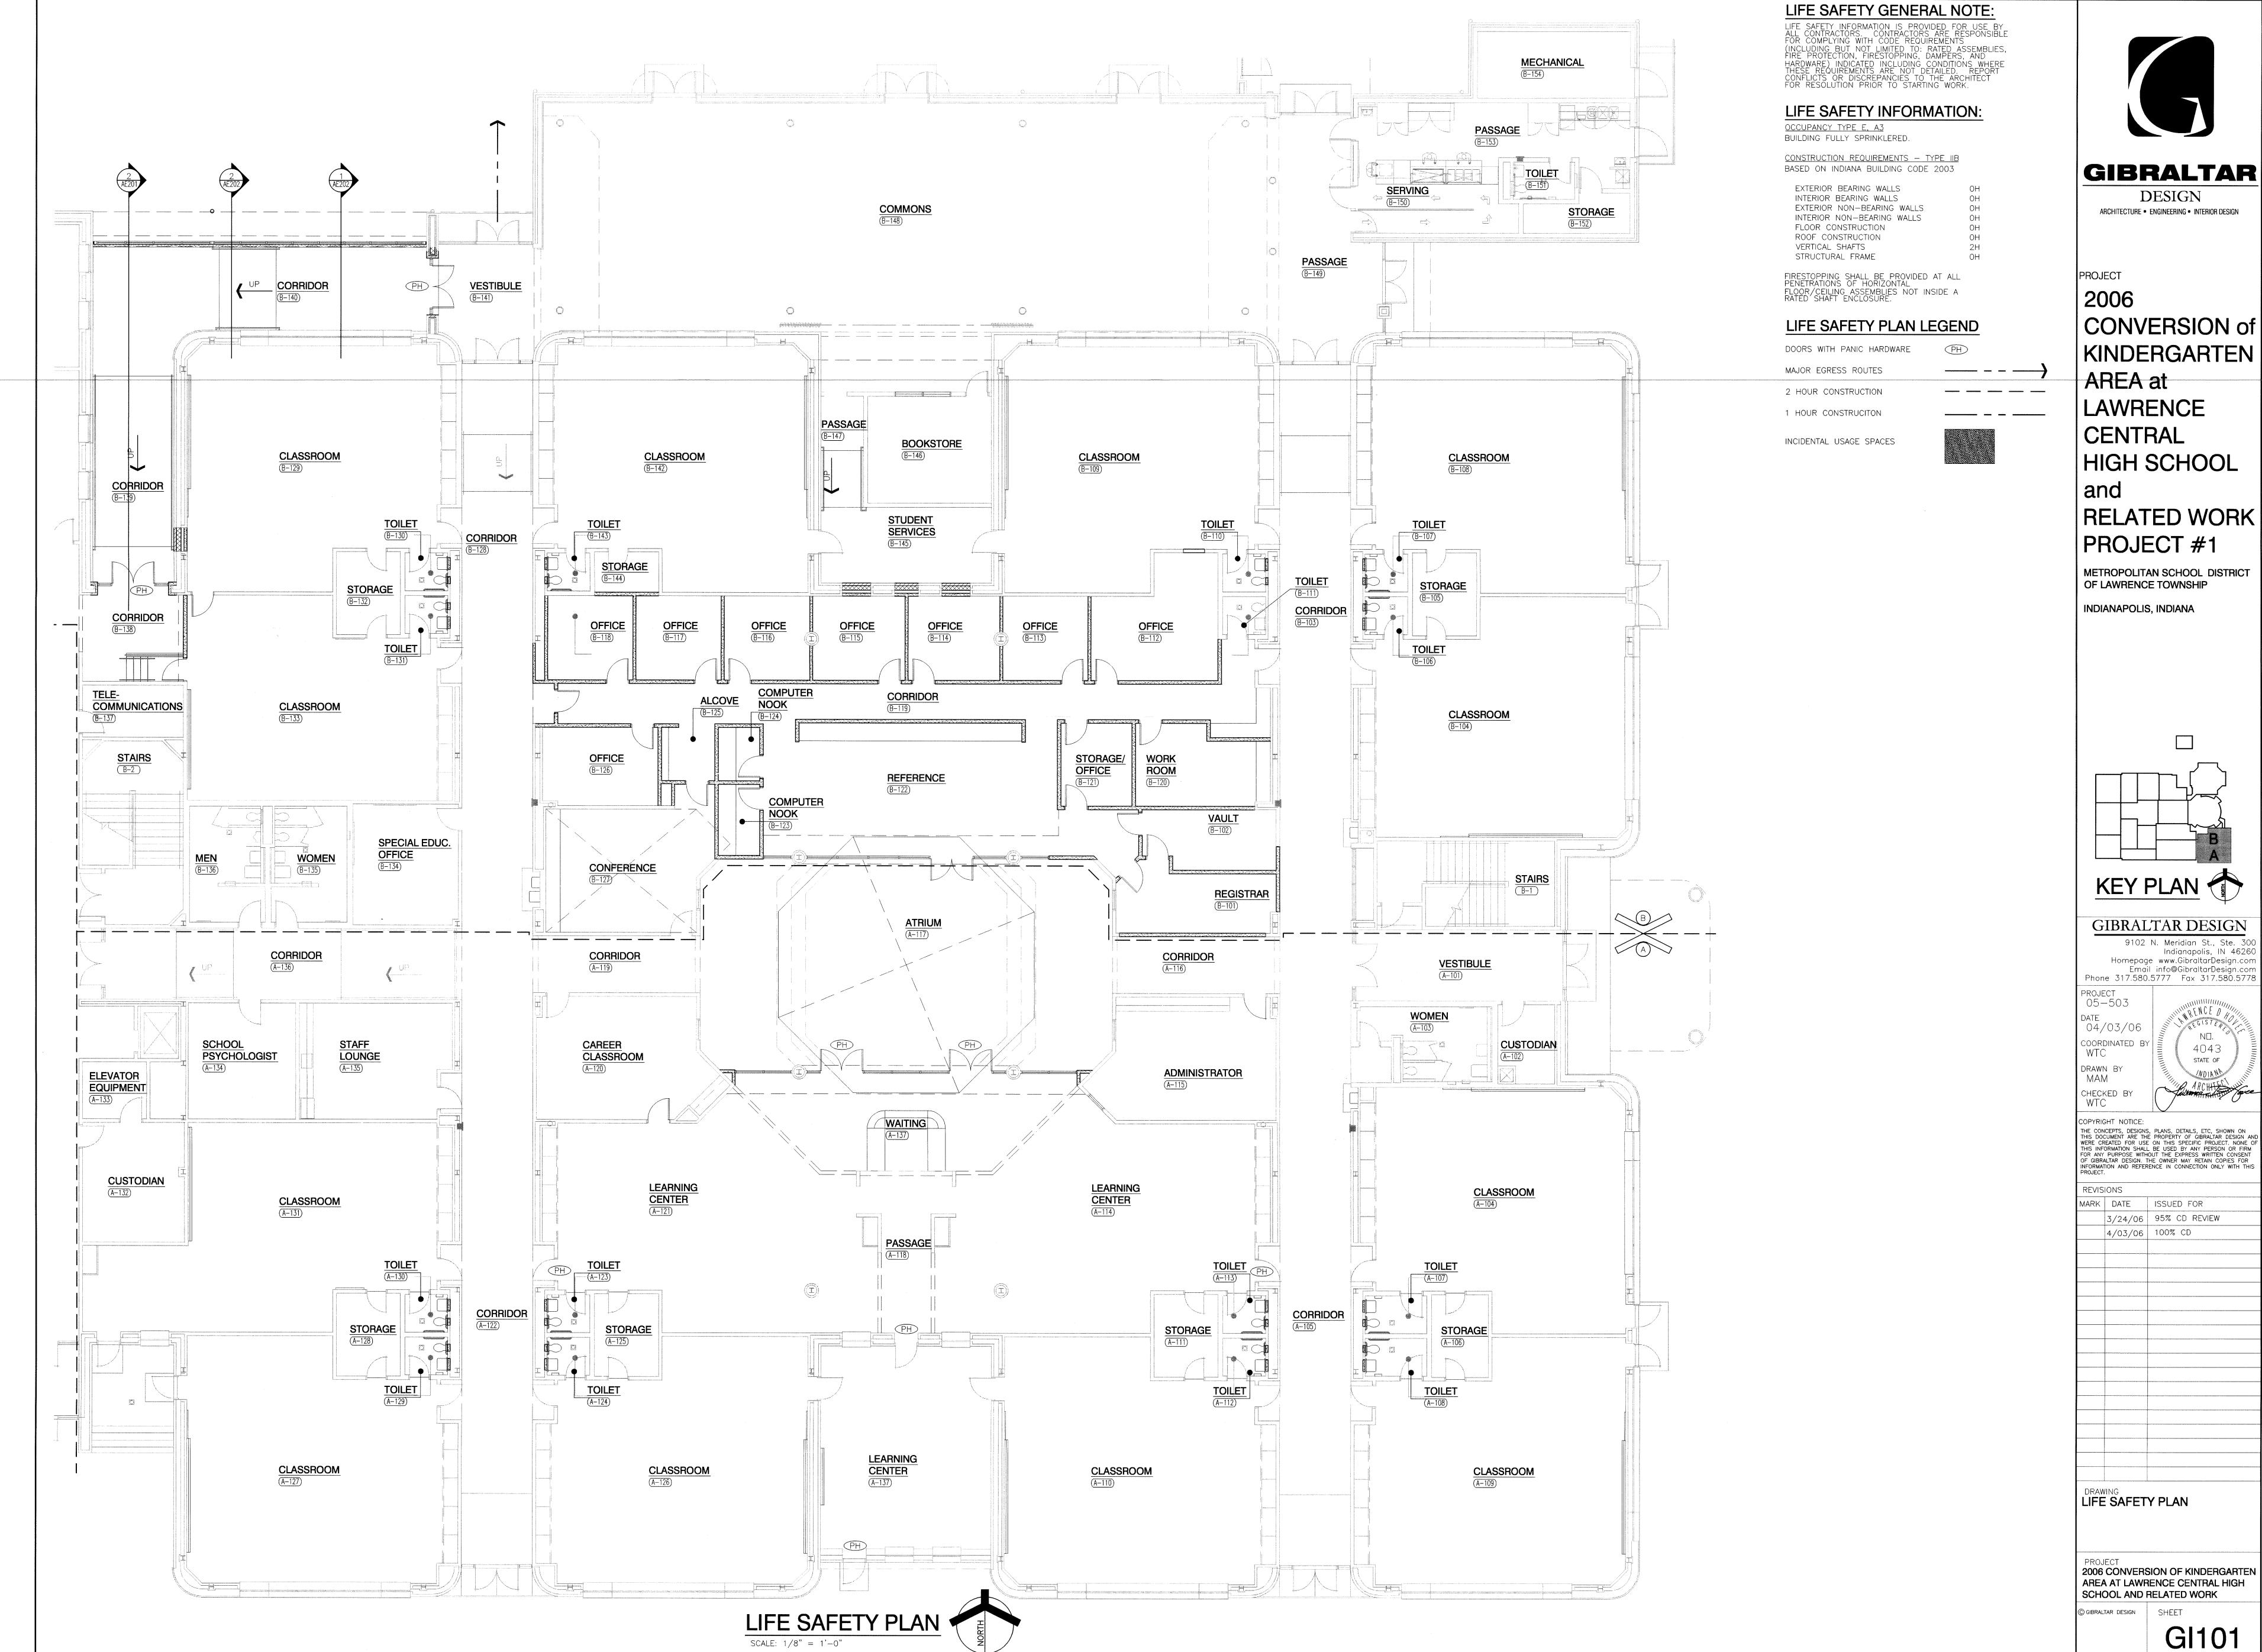


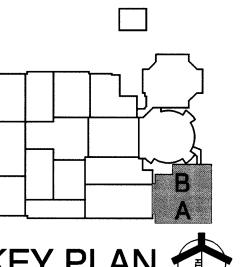

9102 N. Meridian St., Ste. 30

2006 CONVERSION OF KINDERGARTEN AREA AT LAWRENCE CENTRAL HIGH

GI101

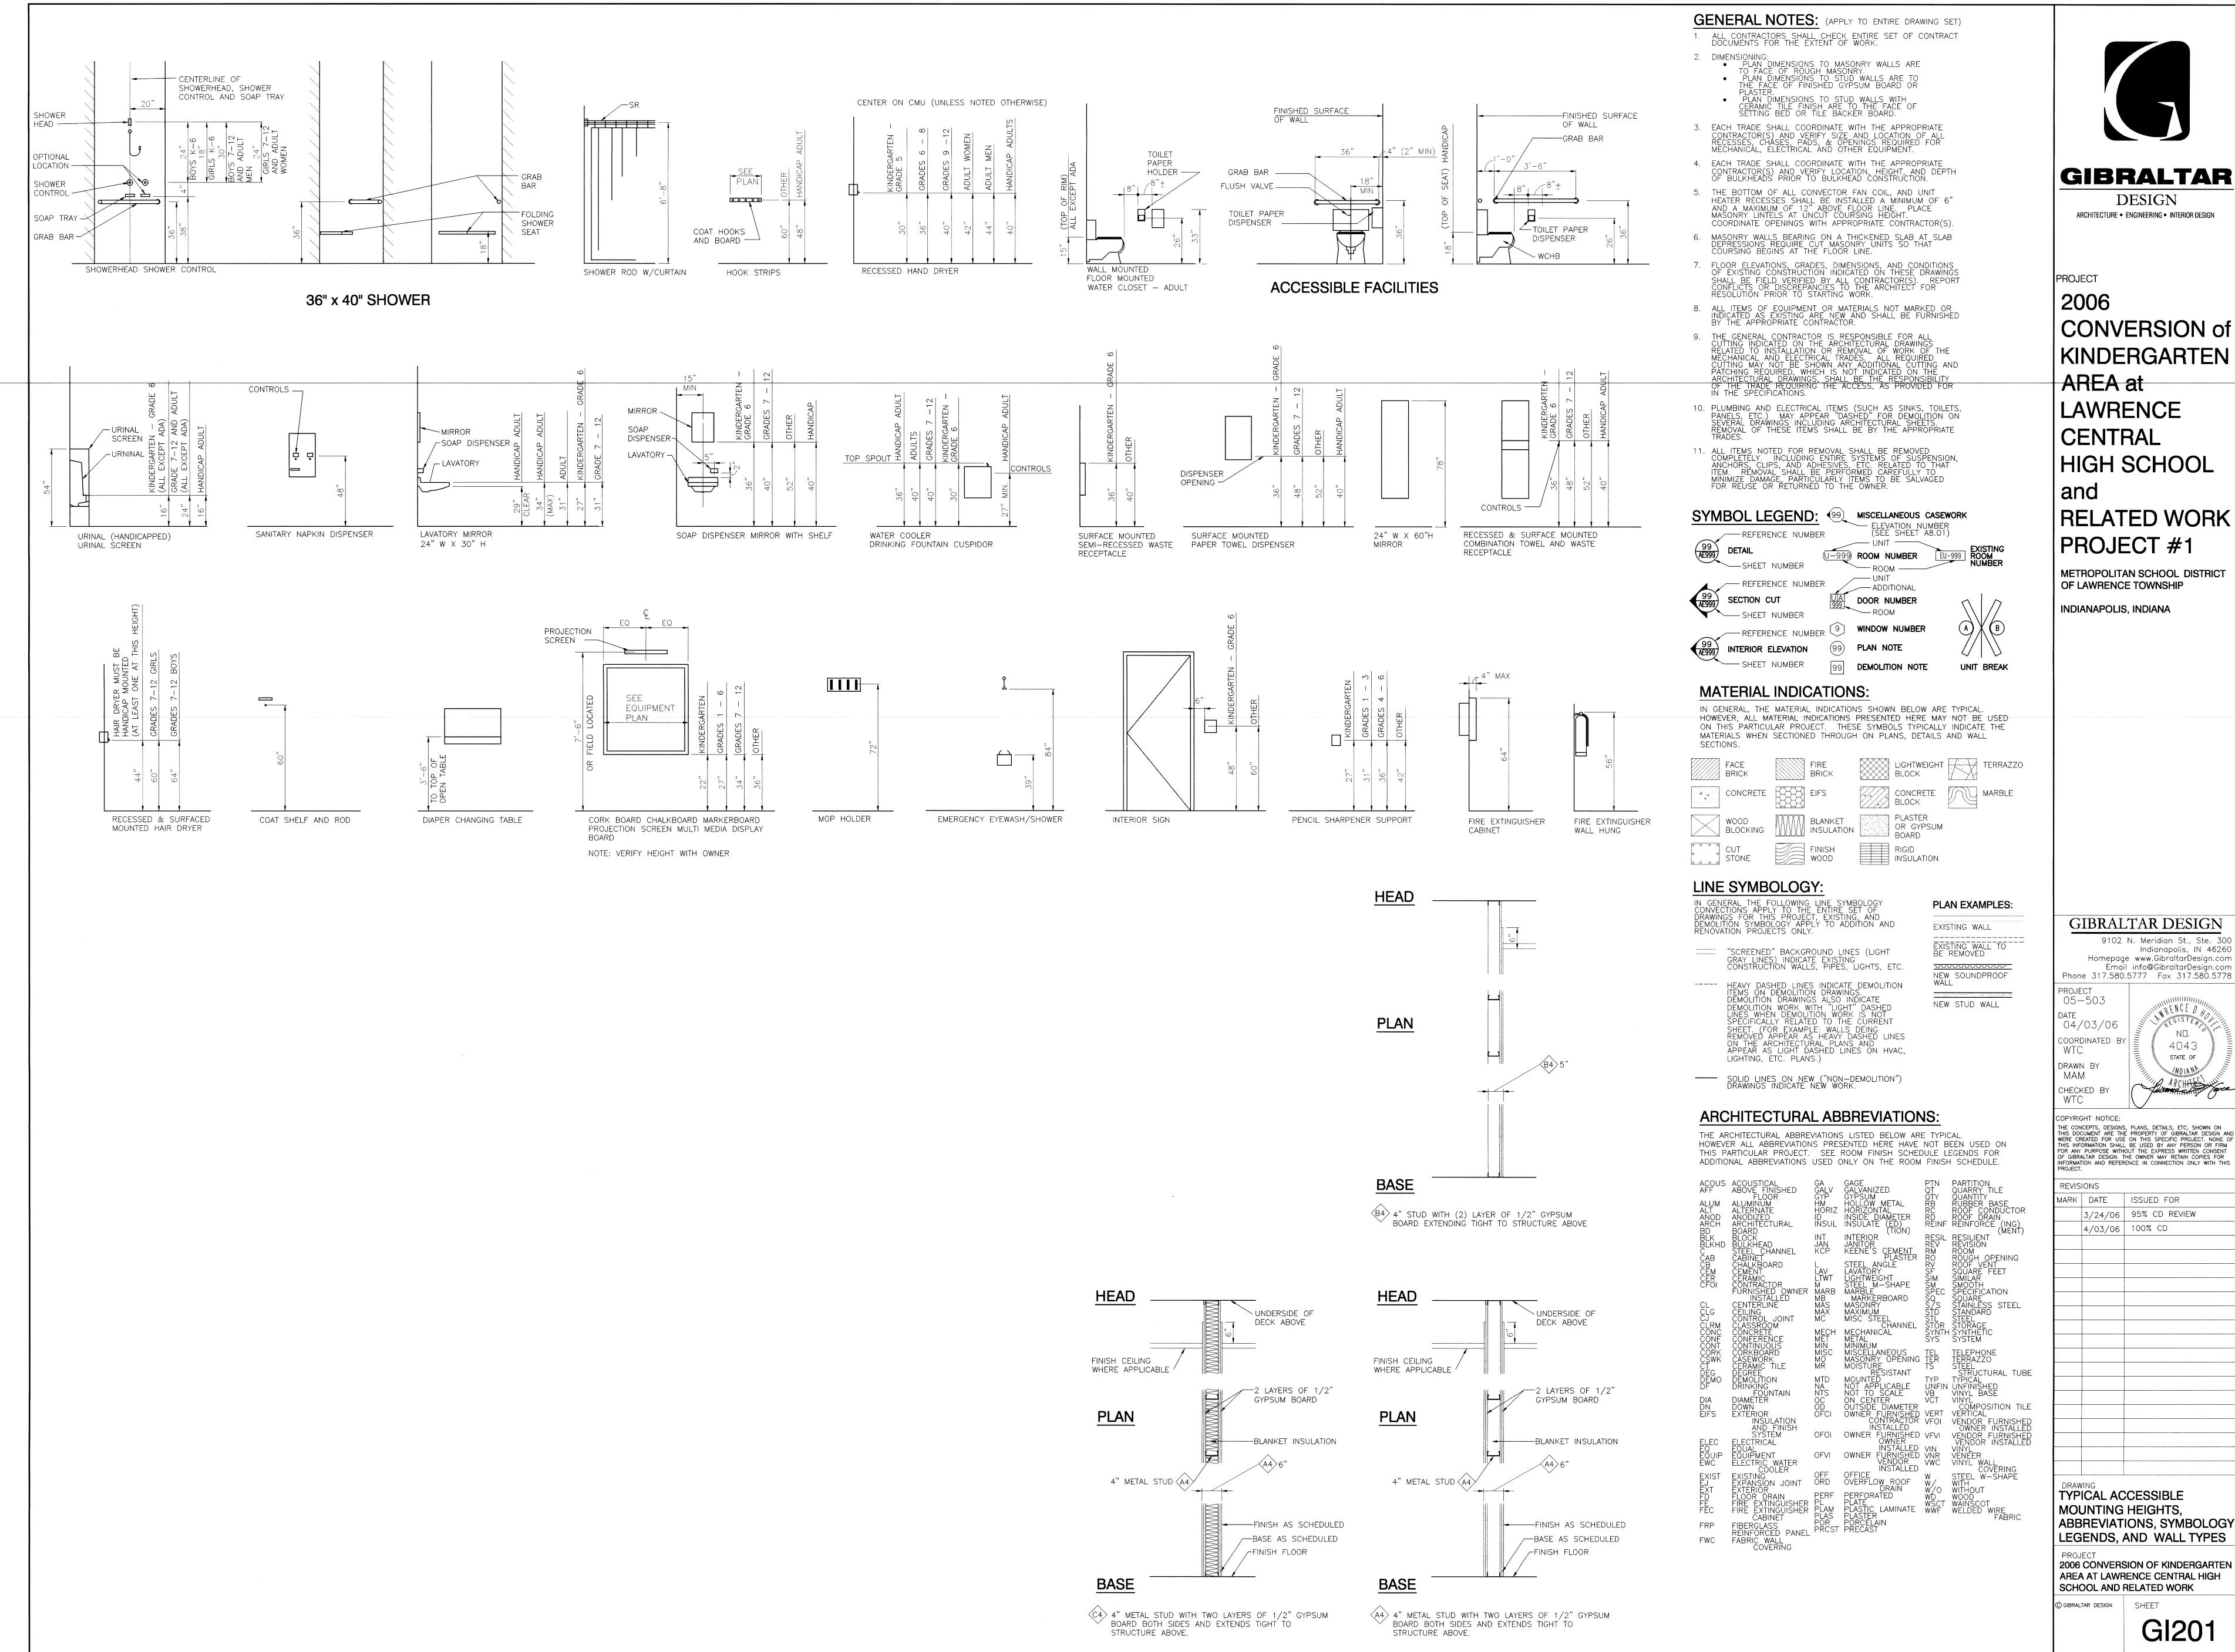

DESIGN ARCHITECTURE • ENGINEERING • INTERIOR DESIGN

CONVERSION of **KINDERGARTEN** LAWRENCE HIGH SCHOOL RELATED WORK PROJECT #1

METROPOLITAN SCHOOL DISTRICT OF LAWRENCE TOWNSHIP

GIBRALTAR DESIGN

9102 N. Meridian St., Ste. 30 Indianapolis, IN 4626 Homepage www.GibraltarDesign.com Email info@GibraltarDesign.com Phone 317.580.5777 Fax 317.580.5778

 $N\square$.

4043


MARK DATE ISSUED FOR 3/24/06 | 95% CD REVIEW 4/03/06 | 100% CD

TYPICAL ACCESSIBLE

MOUNTING HEIGHTS, ABBREVIATIONS, SYMBOLOGY LEGENDS, AND WALL TYPES

2006 CONVERSION OF KINDERGARTEN AREA AT LAWRENCE CENTRAL HIGH SCHOOL AND RELATED WORK

GI201

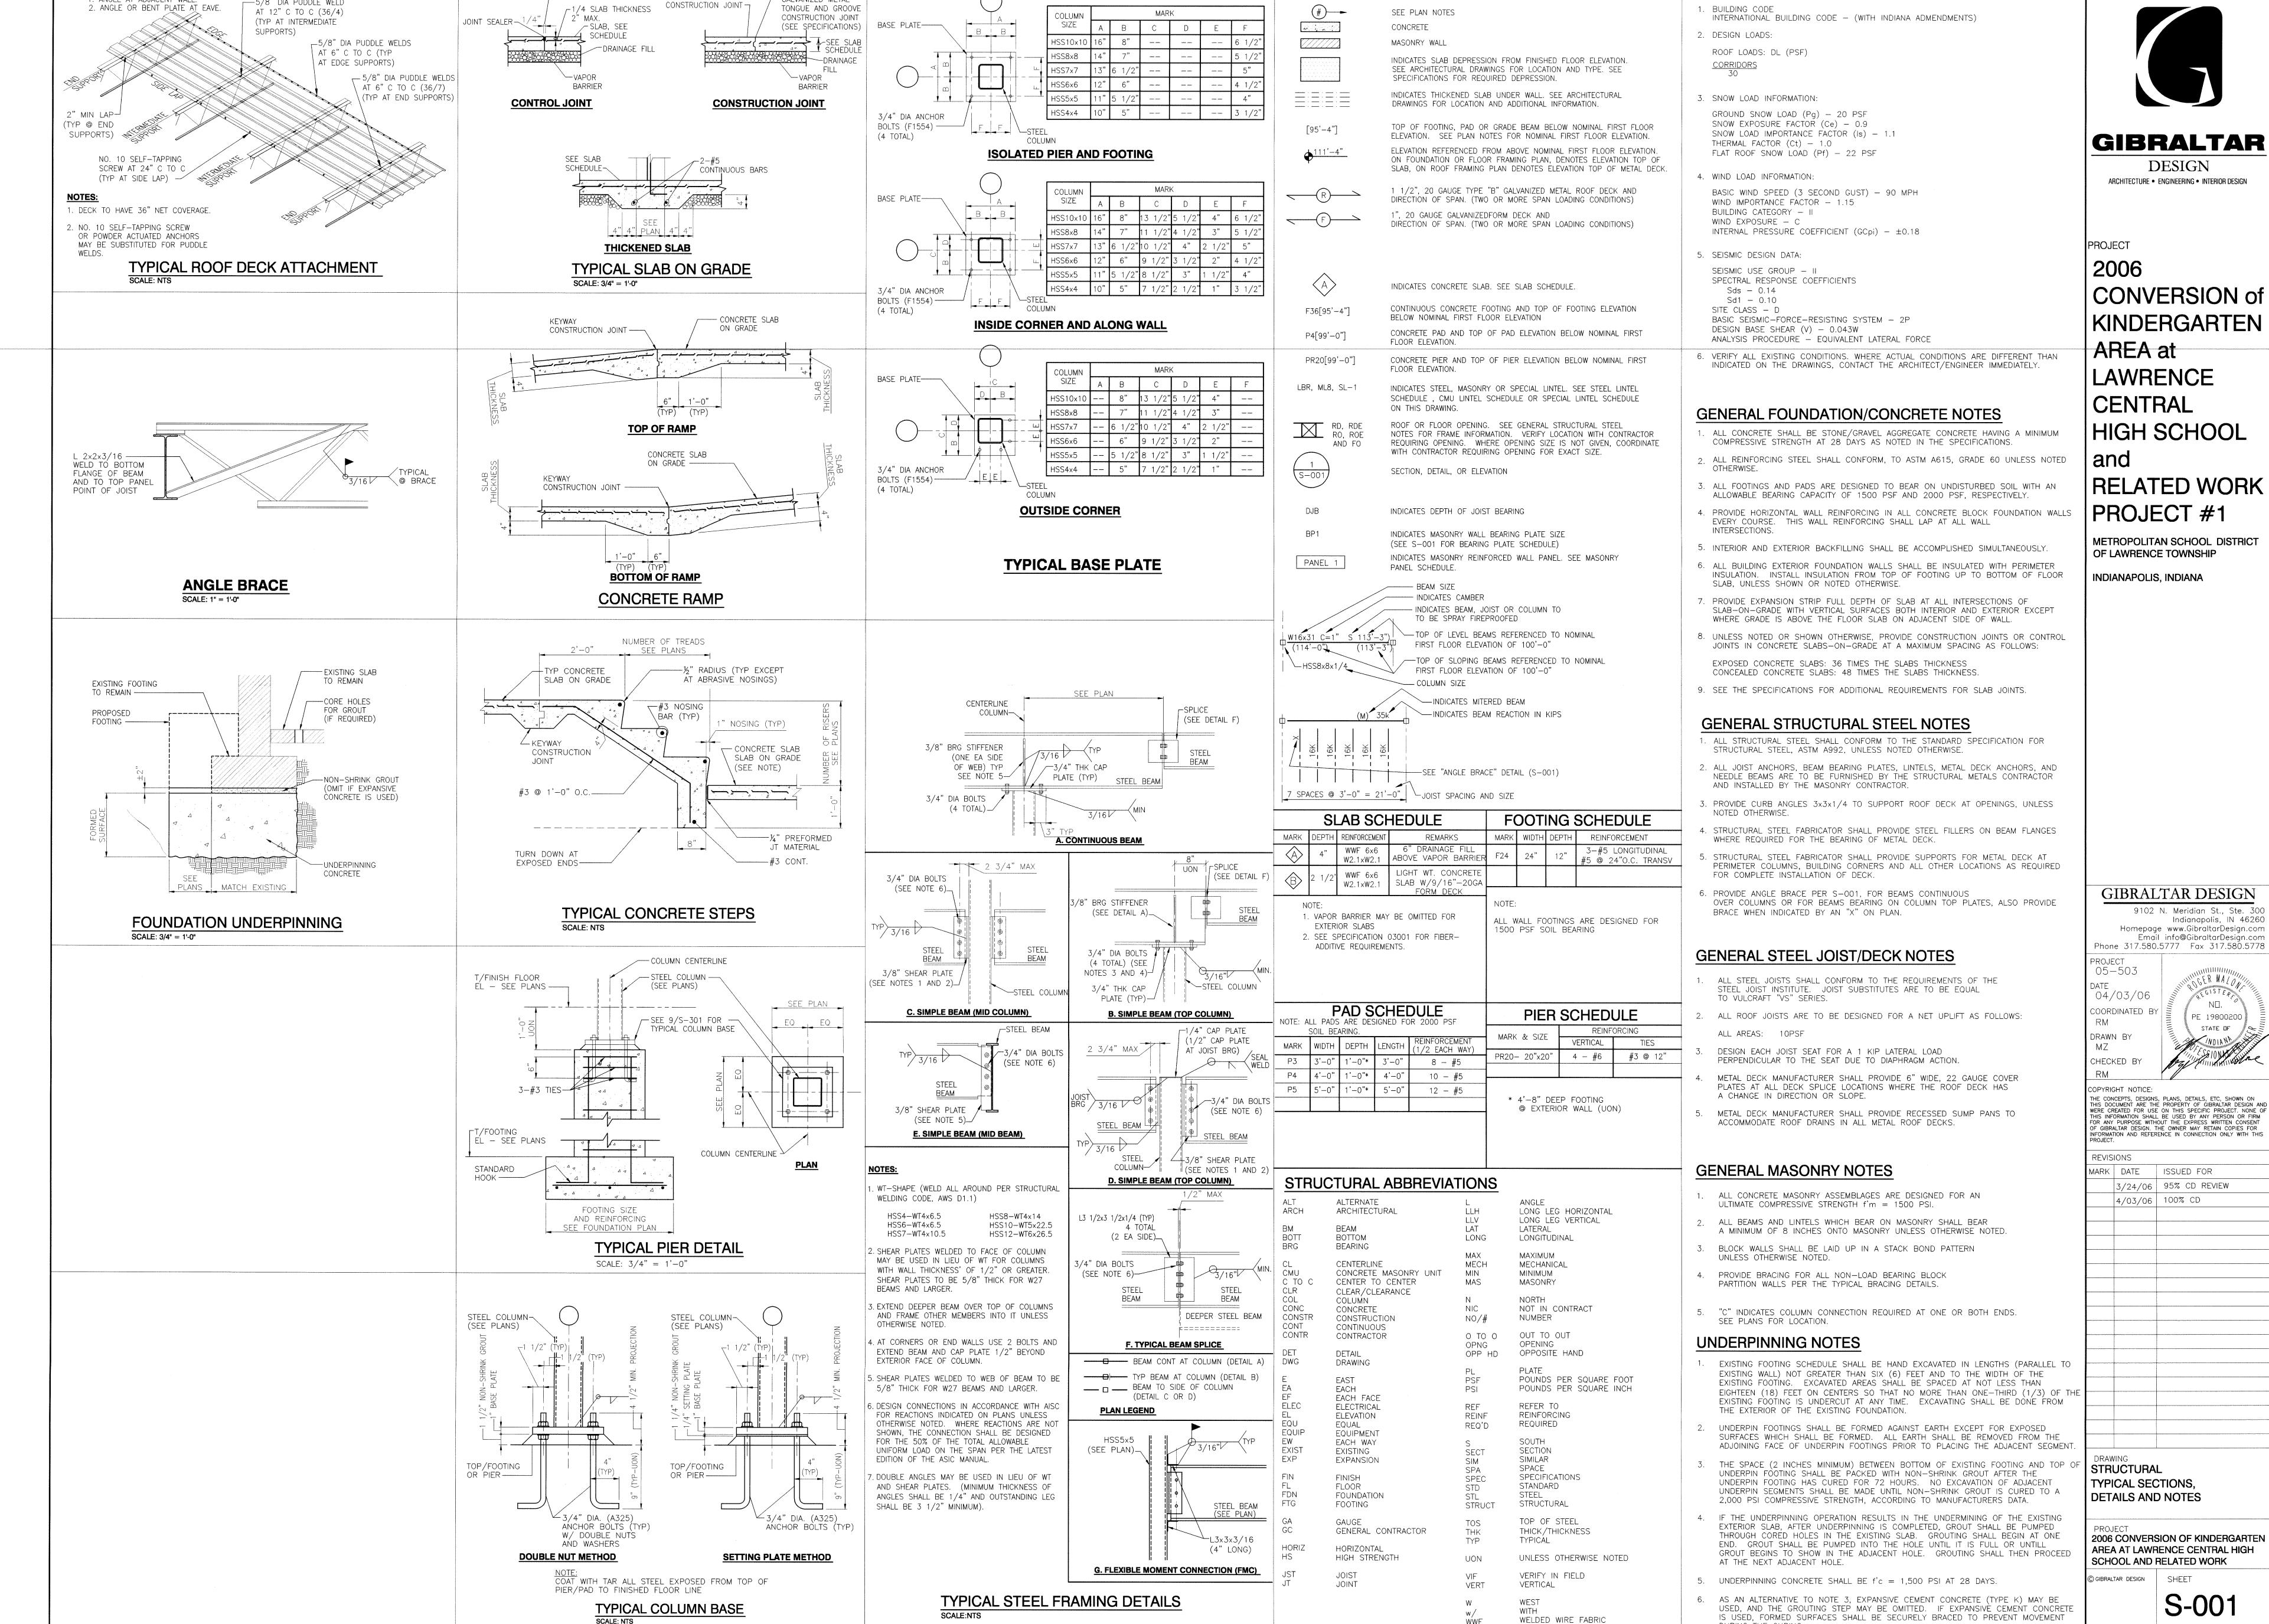

STRUCTURAL LEGEND

GENERAL DESIGN NOTES

SLAB PER PLAN

REINFORCEMENT IS NOT

CONTINUOUS ACROSS THE

GALVANIZED METAL


- SAW-CUT CONTROL

JOINT AS INDICATED.

TYPICAL EDGE SUPPORTS

. ANGLE AT ADJACENT WALL.

—5/8" DIA PUDDLE WELD

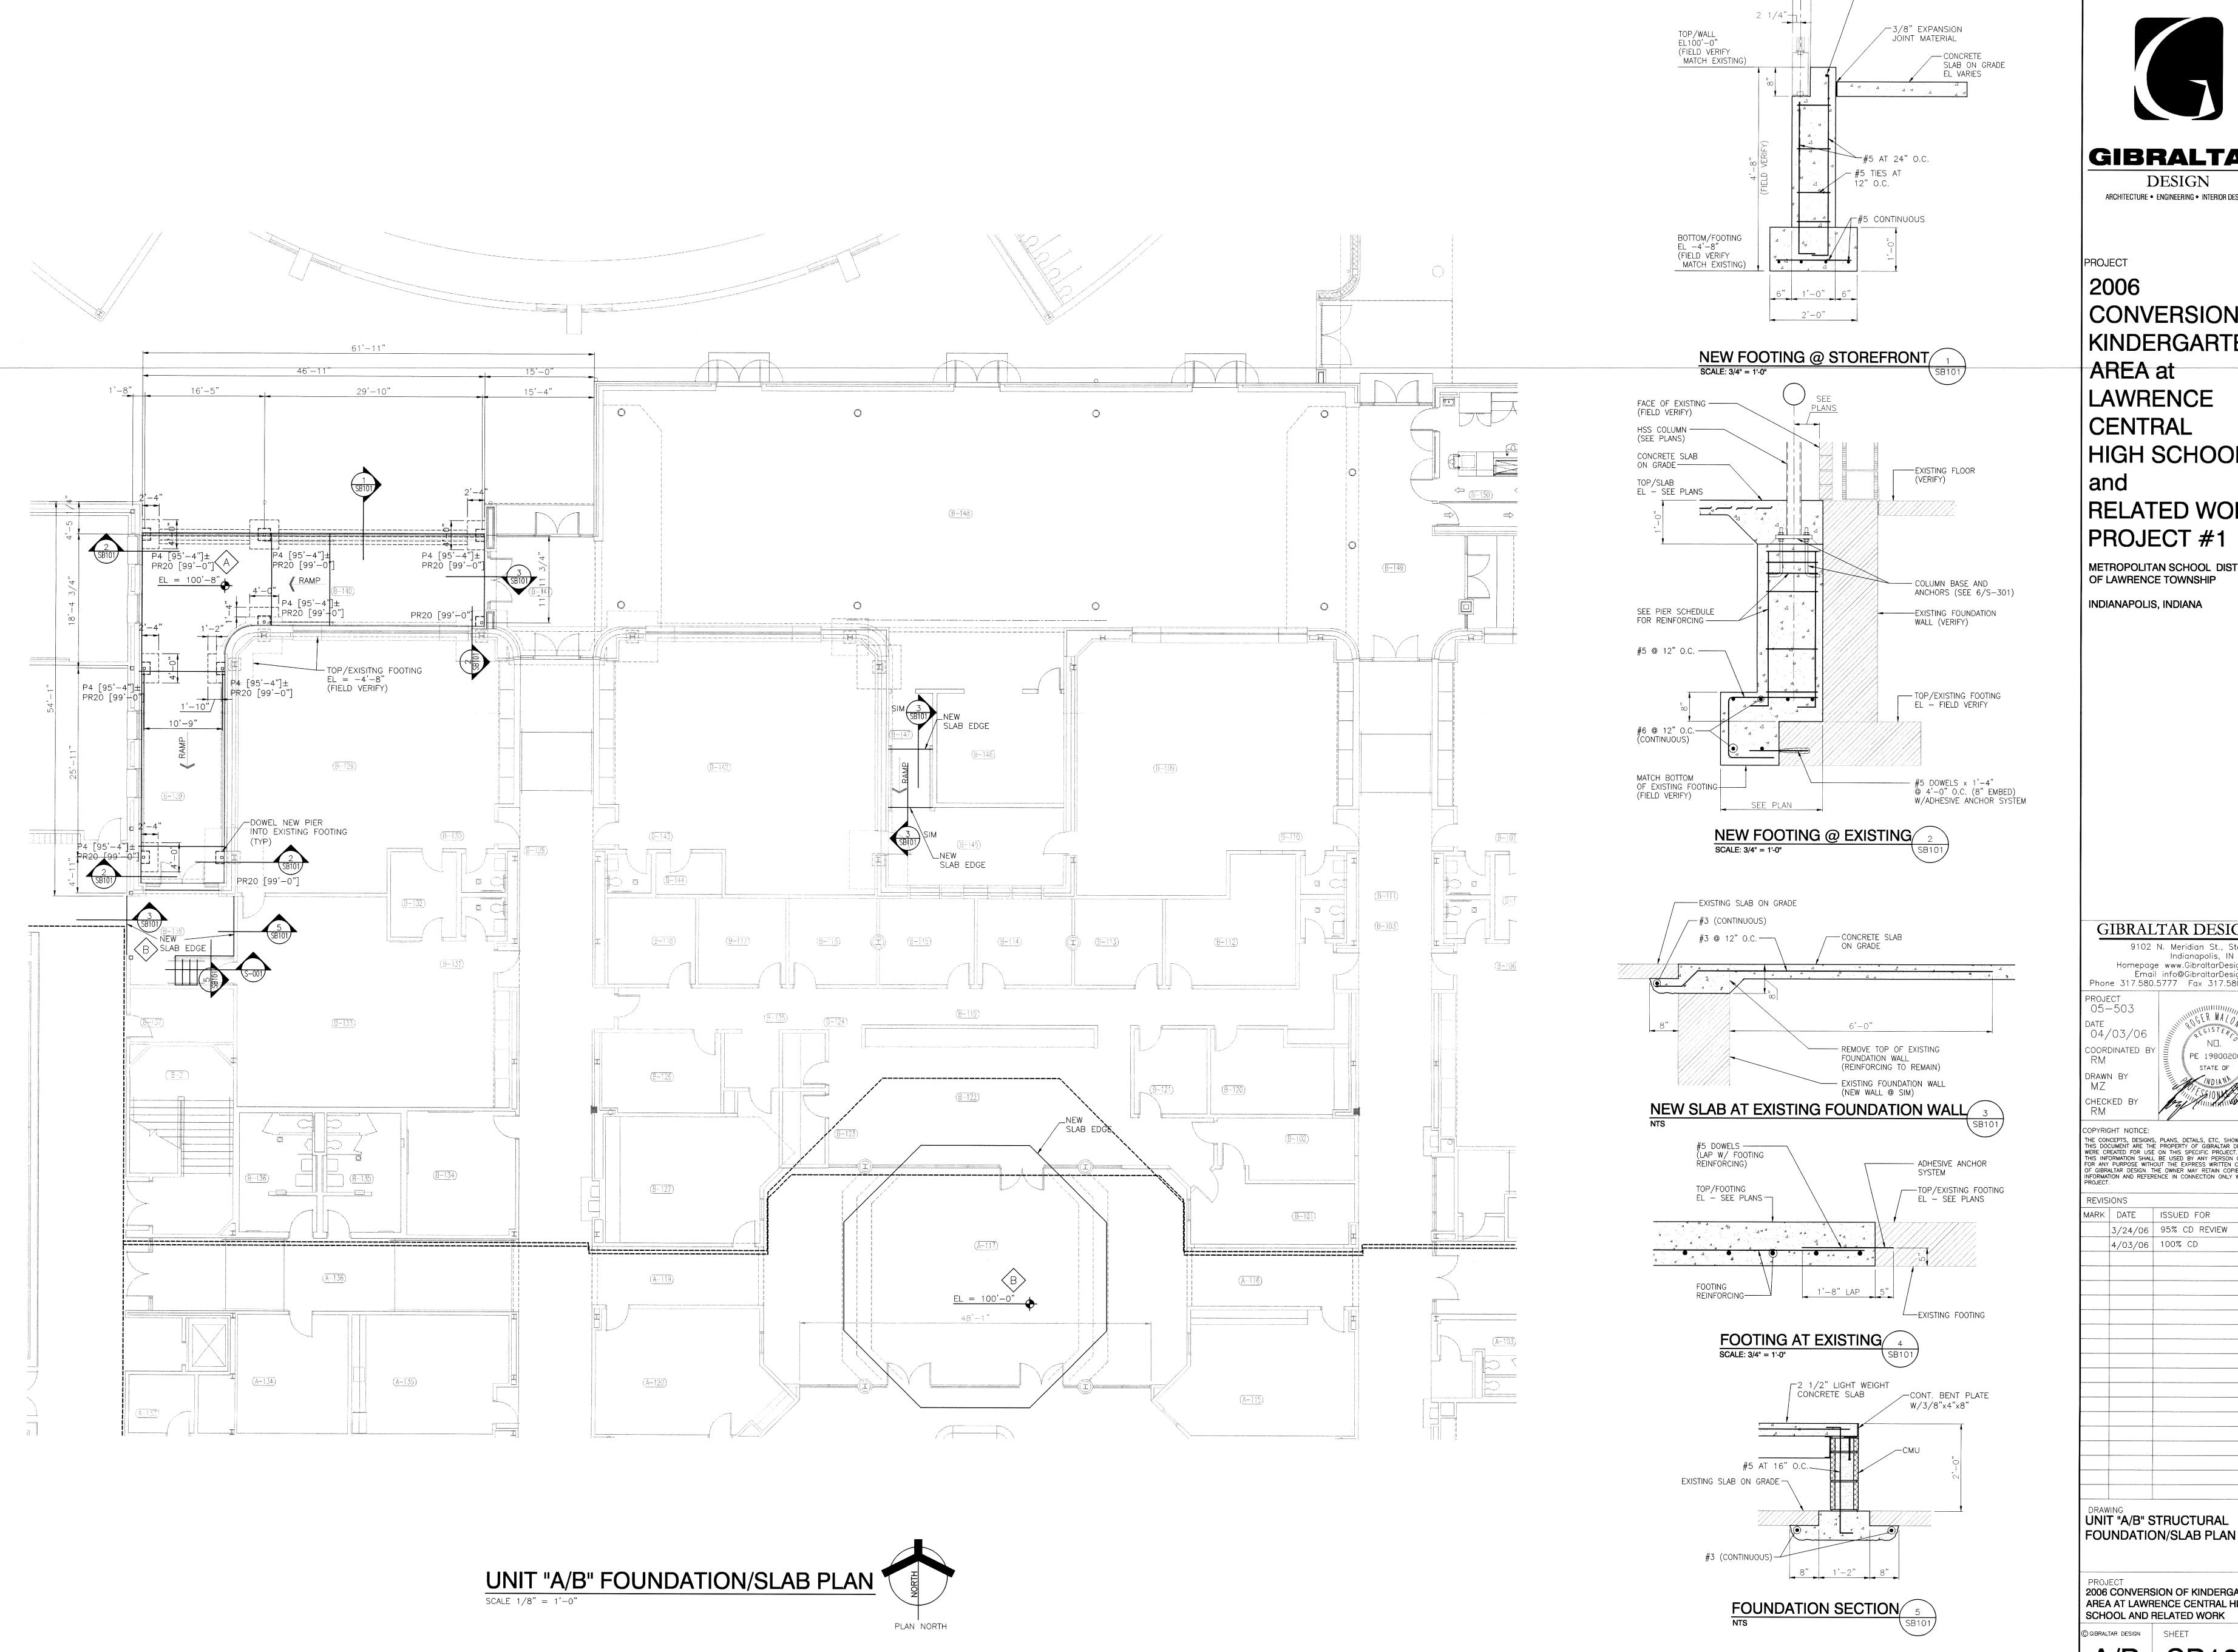

GIBRALTAR

DESIGN ARCHITECTURE • ENGINEERING • INTERIOR DESIGN

_#5 CONTINUOUS

PROJECT 2006 CONVERSION of KINDERGARTEN AREA at LAWRENCE CENTRAL HIGH SCHOOL and RELATED WORK PROJECT #1


METROPOLITAN SCHOOL DISTRICT
OF LAWRENCE TOWNSHIP INDIANAPOLIS, INDIANA

9102 N. Meridian St., Ste. 3 Homepage www.GibraltarDesign.com
Email info@GibraltarDesign.com
Phone 317.580.5777 Fax 317.580.5778 PROJECT 05-503 04/03/06 coordinated b' RM PE 19800200 drawn by MZ CHECKED BY RM COPYRIGHT NOTICE: THE CONCEPTS, DESIGNS, PLANS, DETAILS, ETC, SHOWN ON THIS DOCUMENT ARE THE PROPERTY OF GIBRALTAR DESIGN AND WERE CREATED FOR USE ON THIS SPECIFIC PROJECT. NONE OF THIS INFORMATION SHALL BE USED BY ANY PERSON OR FIRM FOR ANY PURPOSE WITHOUT THE EXPRESS WRITTEN CONSENT OF GIBRALTAR DESIGN. THE OWNER MAY RETAIN COPIES FOR INFORMATION AND REFERENCE IN CONNECTION ONLY WITH THIS PROJECT. REVISIONS MARK DATE ISSUED FOR 3/24/06 | 95% CD REVIEW 4/03/06 100% CD UNIT "A/B" STRUCTURAL

GIBRALTAR DESIGN

PROJECT
2006 CONVERSION OF KINDERGARTEN
AREA AT LAWRENCE CENTRAL HIGH
SCHOOL AND RELATED WORK

SB101

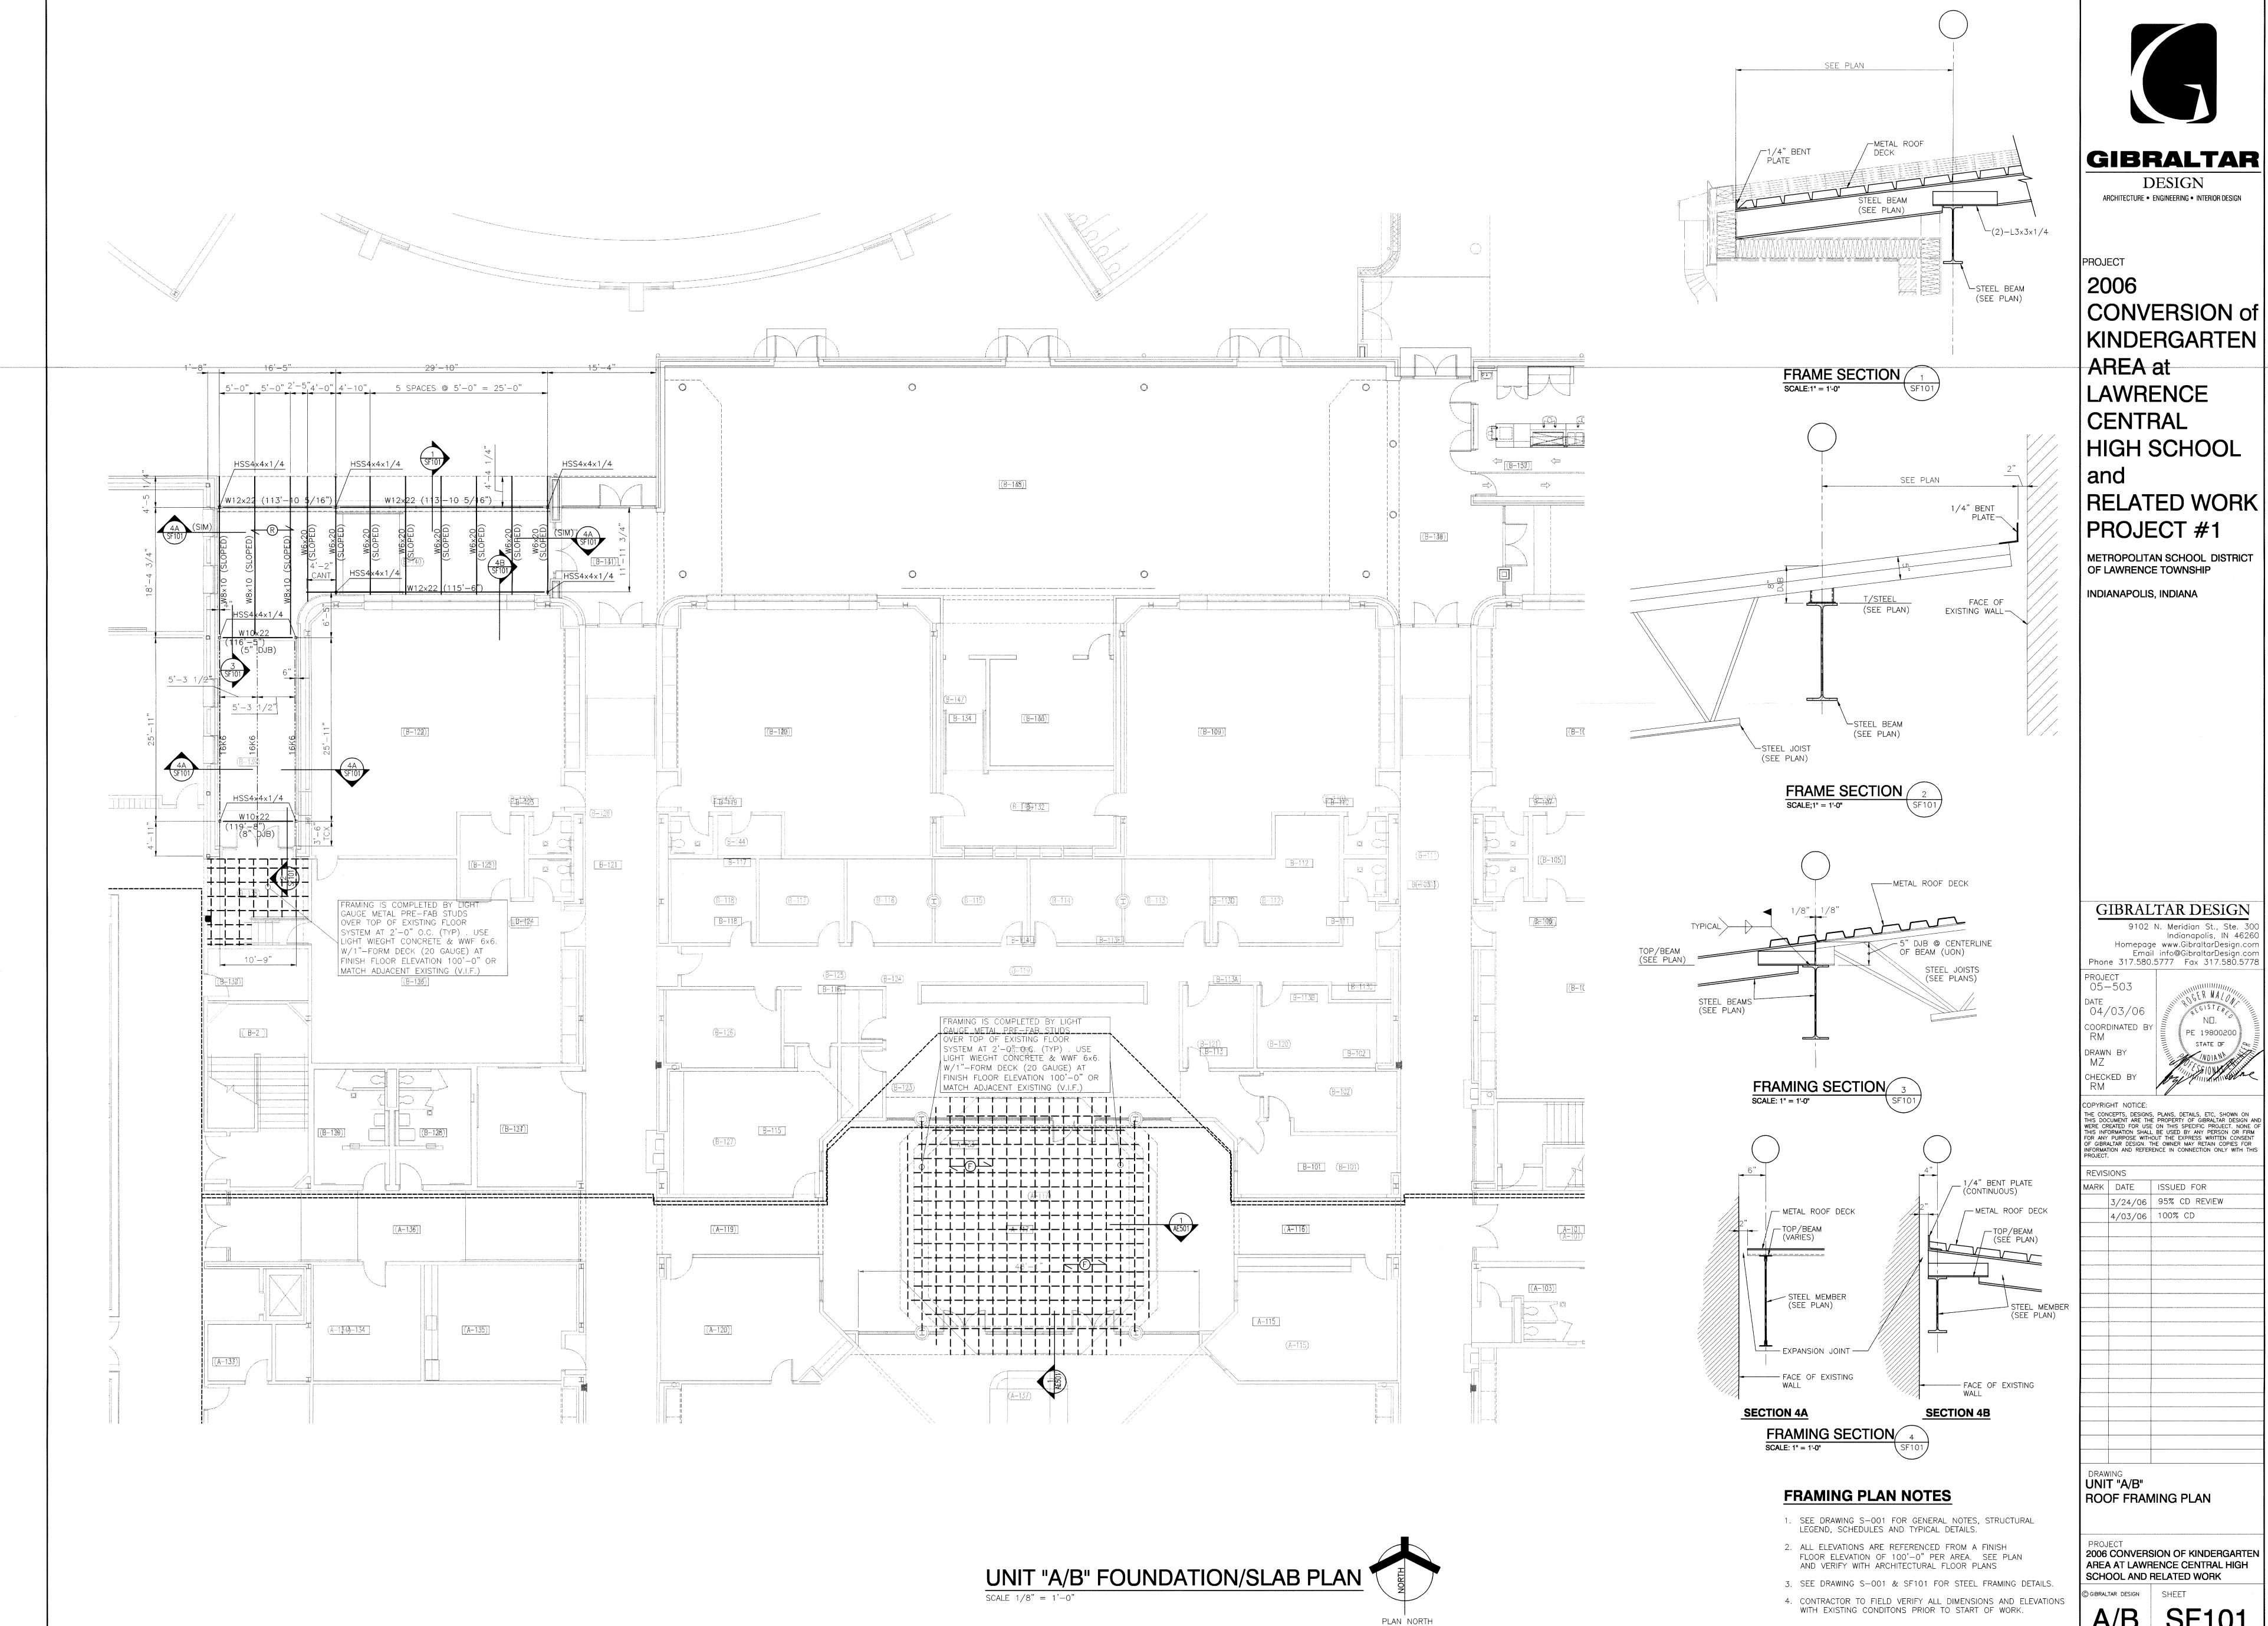

ALL EXISTING CONSTRUCTION AFFECTED BY THE DEMOLITION WORK INDICATED ON THIS SHEET SHALL BE PATCHED AND REPAIRED AS REQUIRED TO RECEIVE NEW FINISHES. ALL PATCHING AND REPAIR WORK RELATED TO THE DEMOLITION OR SPECIFICALLY NOTED ON THIS SHEET SHALL BE THE RESPONSIBILITY OF THE CONTRACTOR WHO WOULD INSTALL THE PATCHED OR REPAIRED MATERIAL IF IT WERE IN NEW CONSTRUCTION.

CONTRACTORS ENCOUNTERING EXISTING MATERIAL WHICH IS SUSPECTED OF CONTAINING ASBESTOS SHALL STOP WORK IMMEDIATELY AND NOTIFY THE OWNER AND THE OWNERS REPRESENTATIVE.

DEMOLITION PLAN NOTES:

(APPLY TO THIS SHEET ONLY)
ALL NOTES ARE TO BE UNDERSTOOD IN ACCORDANCE WITH PHASING PLAN.

1 REMOVE EXISTING KINDERGARTEN LOFT. PATCH AND REPAIR FLOOR/WALL FINISHES AS REQUIRED. SALVAGE CARPET ON LOFT TO USE FOR PATCHING EXISTING ROOM CARPET.

2 REMOVE EXISTING CHALKBOARD. REMOVE CUBBIES BELOW OVERHEAD CASEWORK. UPPER CASEWORK AND BULKHEAD TO REMAIN.

REMOVE EXISTING ELECTRIC WATER COOLERS TO REINSTALL AT NEW MOUNTING HEIGHT AT SAME LOCATION. SEE PLUMBING DRAWINGS FOR EXTENT OF WORK.

5 REMOVE EXISTING CASEWORK. PATCH AND REPAIR FLOOR/WALL FINISHES AS REQUIRED. CUT AND CAP ALL PIPING BELOW FLOOR SLAB. SEE PLUMBING DRAWINGS FOR EXTENT OF WORK.

6 REMOVE EXISTING GYPSUM BOARD AND STUD FRAMING TO 9'-3" AFF. PATCH AND REPAIR FLOOR/WALL FINISHES AS REQUIRED. COORDINATE WITH NEW CONSTRUCTION.

7 REMOVE EXISTING ISLAND CASEWORK. CUT AND CAP ALL PIPING BELOW FLOOR SLAB. SEE PLUMBING FOR EXTENT OF WORK. DISCONNECT AND CAP ALL CONDUIT BELOW FLOOR SLAB. SEE ELECTRICAL DRAWINGS FOR EXTENT OF WORK. PATCH AND REPAIR SLAB UPON COMPLETION OF CAPPING UTILITIES.

8 REMOVE EXISTING CARPET AND BASE. PATCH AND REPAIR FLOOR/WALL AS REQUIRED FOR NEW FLOOR FINISH AND BASE. COORDINATE WITH NEW CONSTRUCTION.

9 REMOVE EXISTING SHEET VINYL. PATCH AND REPAIR FLOOR SLAB AS REQUIRED FOR NEW FLOOR FINISH. 10 REMOVE EXISTING WALL FABRIC. PATCH AND REPAIR AS REQUIRED FOR NEW FINISH.

11 REMOVE EXISTING DOOR AND FRAME. TURN HARDWARE OVER TO THE OWNER. 12 REMOVE EXISTING RAMP. PATCH AND REPAIR AS REQUIRED FOR THIS AREA TO BE FILLED.

REMOVE EXISTING STUD WALL CONSTRUCTION. PATCH AND REPAIR FLOOR/WALL FINISHES AS REQUIRED.

14 REMOVE PORTION OF GYPSUM BOARD AND STUD FRAMING AS REQUIRED FOR NEW OPENING. 15 REMOVE PARTIAL HEIGHT STUD WALL CONSTUCTION. PATCH AND REPAIR FLOOR/WALL FINISHES AS REQUIRED. 16 REMOVE EXISTING DOOR. DOOR FRAME TO REMAIN.

17 REMOVE EXISTING HANDRAIL. REMOVE ANY PIPING IN WALL AT THIS LOCATION.
MECHANICAL TRADES TO CUT AND CAP ALL PIPING
BELOW AND/OR BEHIND FINISH SURFACES.

19 REMOVE TACKBOARD. 20 REMOVE SIGNAGE.


GIBRALTAR

DESIGN ARCHITECTURE • ENGINEERING • INTERIOR DESIGN

PROJECT CONVERSION of KINDERGARTEN AREA at LAWRENCE CENTRAL HIGH SCHOOL

PROJECT #1 METROPOLITAN SCHOOL DISTRICT OF LAWRENCE TOWNSHIP INDIANAPOLIS, INDIANA

RELATED WORK

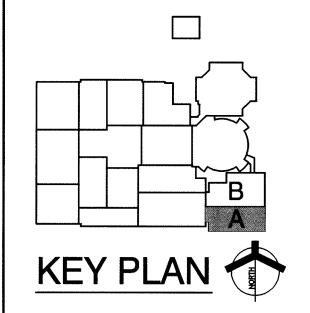

GIBRALTAR DESIGN 9102 N. Meridian St., Ste. 30 Indianapolis, IN 4626 Homepage www.GibraltarDesign.cor Email info@GibraltarDesign.com Phone 317.580.5777 Fax 317.580.577

PROJECT 05-503 04/03/06 COORDINATED I 4043 STATE OF DRAWN BY MAM CHECKED BY

COPYRIGHT NOTICE: THE CONCEPTS, DESIGNS, PLANS, DETAILS, ETC, SHOWN ON THIS DOCUMENT ARE THE PROPERTY OF GIBRALTAR DESIGN AN WERE CREATED FOR USE ON THIS SPECIFIC PROJECT. NONE O THIS INFORMATION SHALL BE USED BY ANY PERSON OR FIRM FOR ANY PURPOSE WITHOUT THE EXPRESS WRITTEN CONSENT OF GIBRALTAR DESIGN. THE OWNER MAY RETAIN COPIES FOR INFORMATION AND REFERENCE IN CONNECTION ONLY WITH THIS PROJECT.

MARK DATE ISSUED FOR 3/24/06 | 95% CD REVIEW 4/03/06 | 100% CD


DRAWING UNIT "A" ARCHITECTURAL FIRST FLOOR
DEMOLITON PLAN


2006 CONVERSION OF KINDERGARTEN AREA AT LAWRENCE CENTRAL HIGH SCHOOL AND RELATED WORK

GIBRALTAR DESIGN SHEET

A

AD101

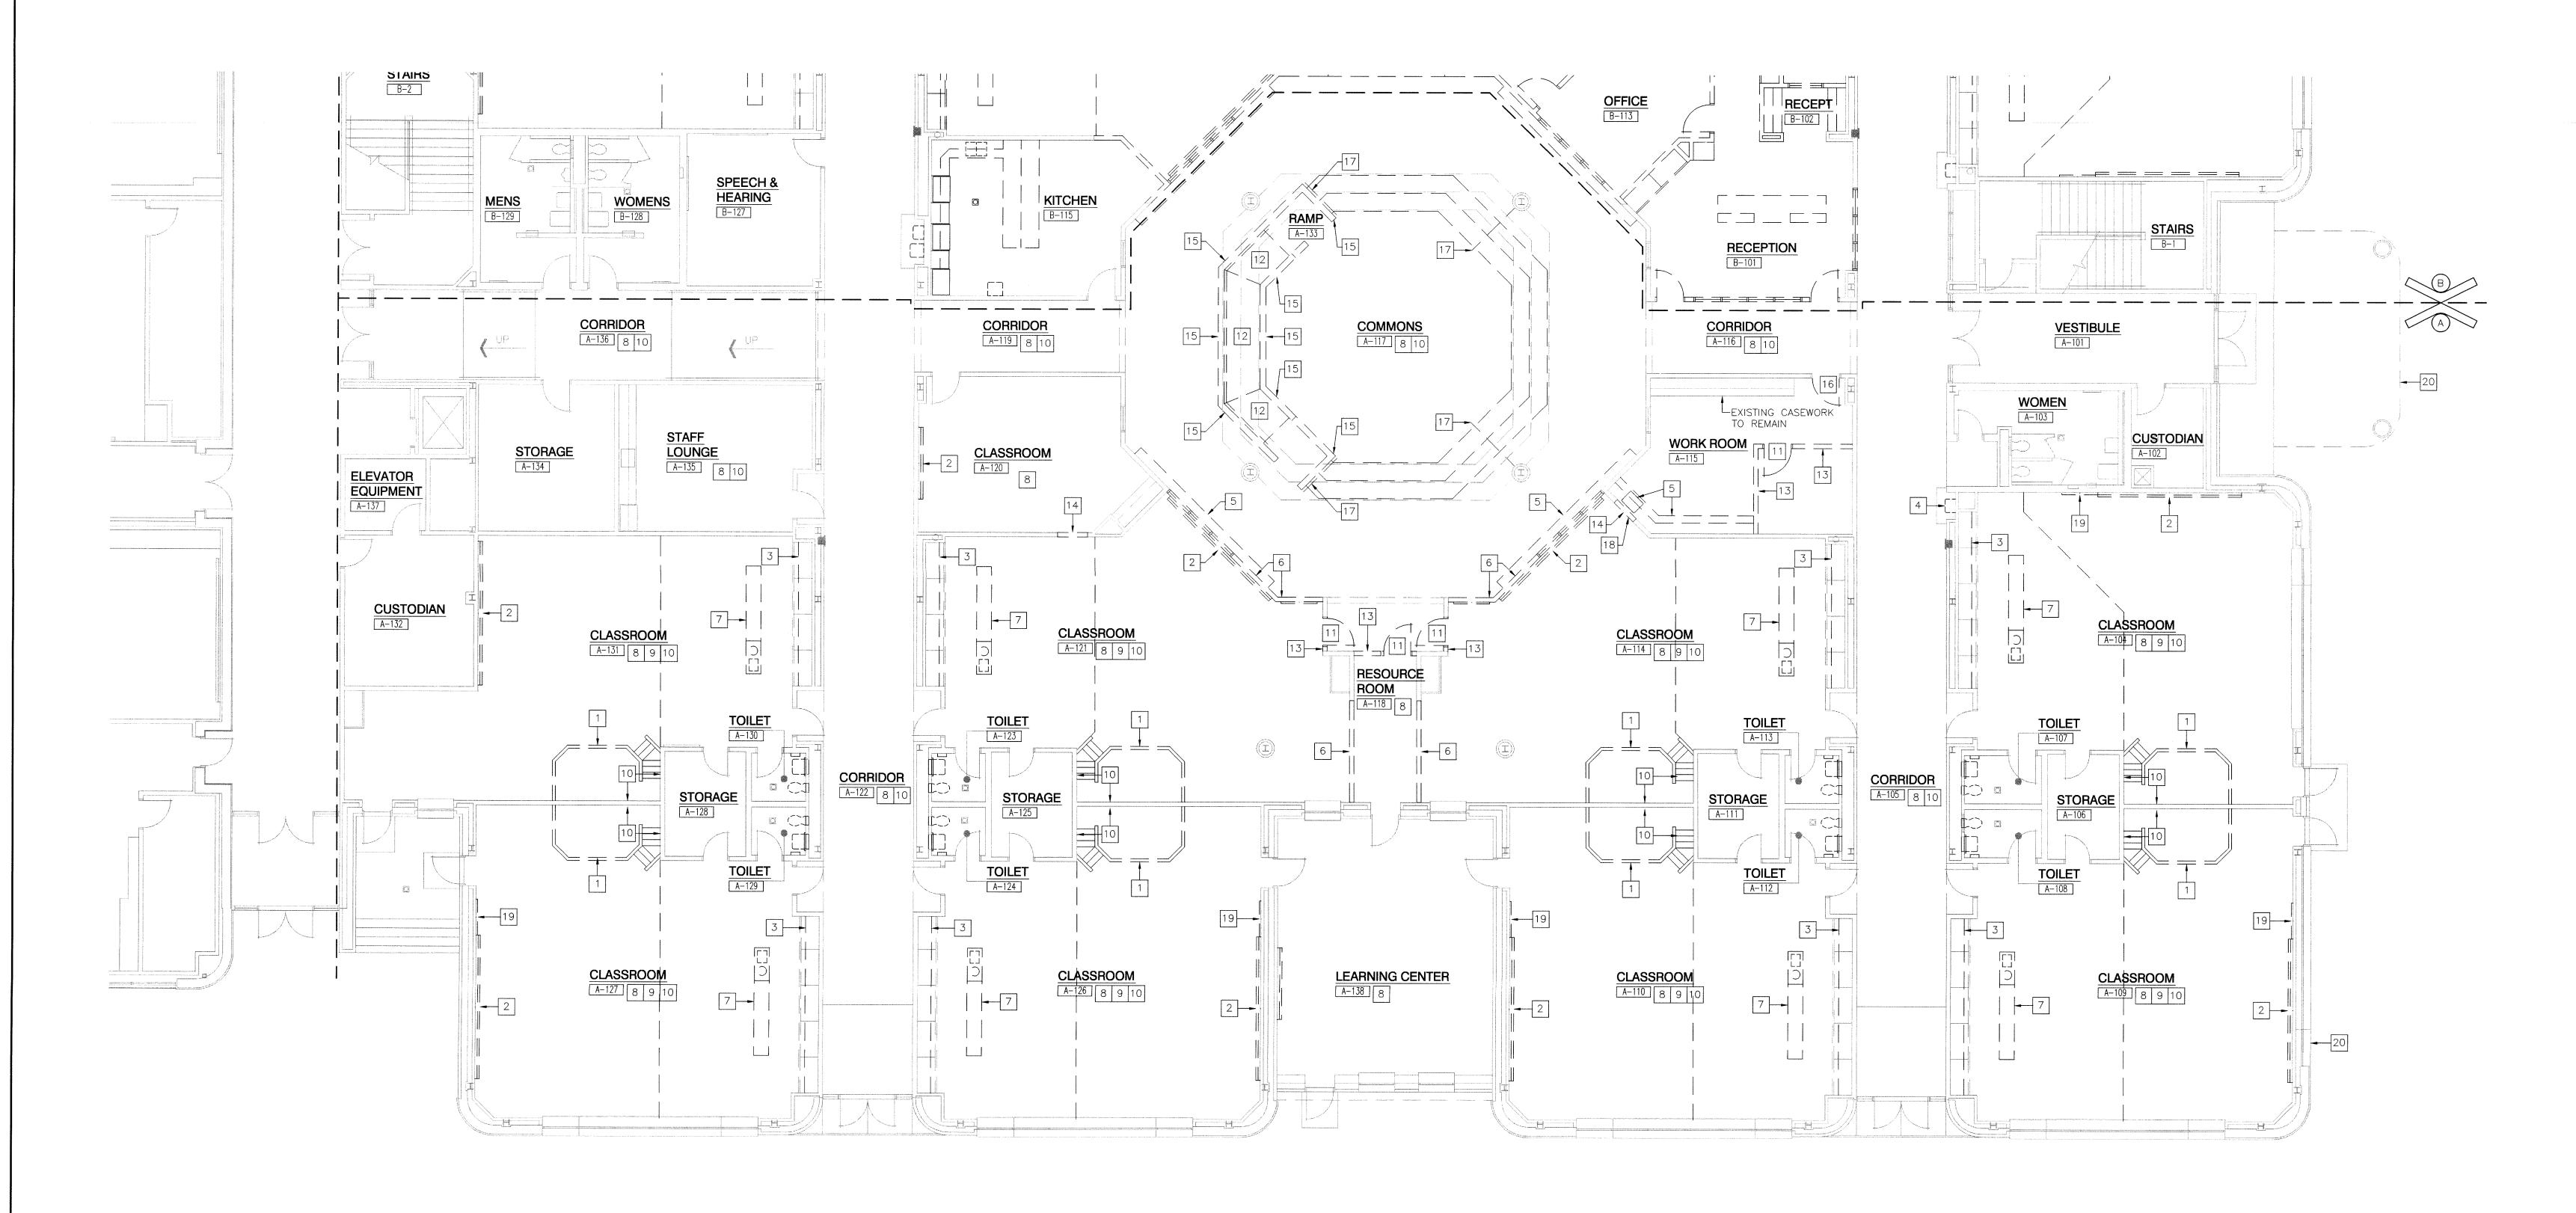

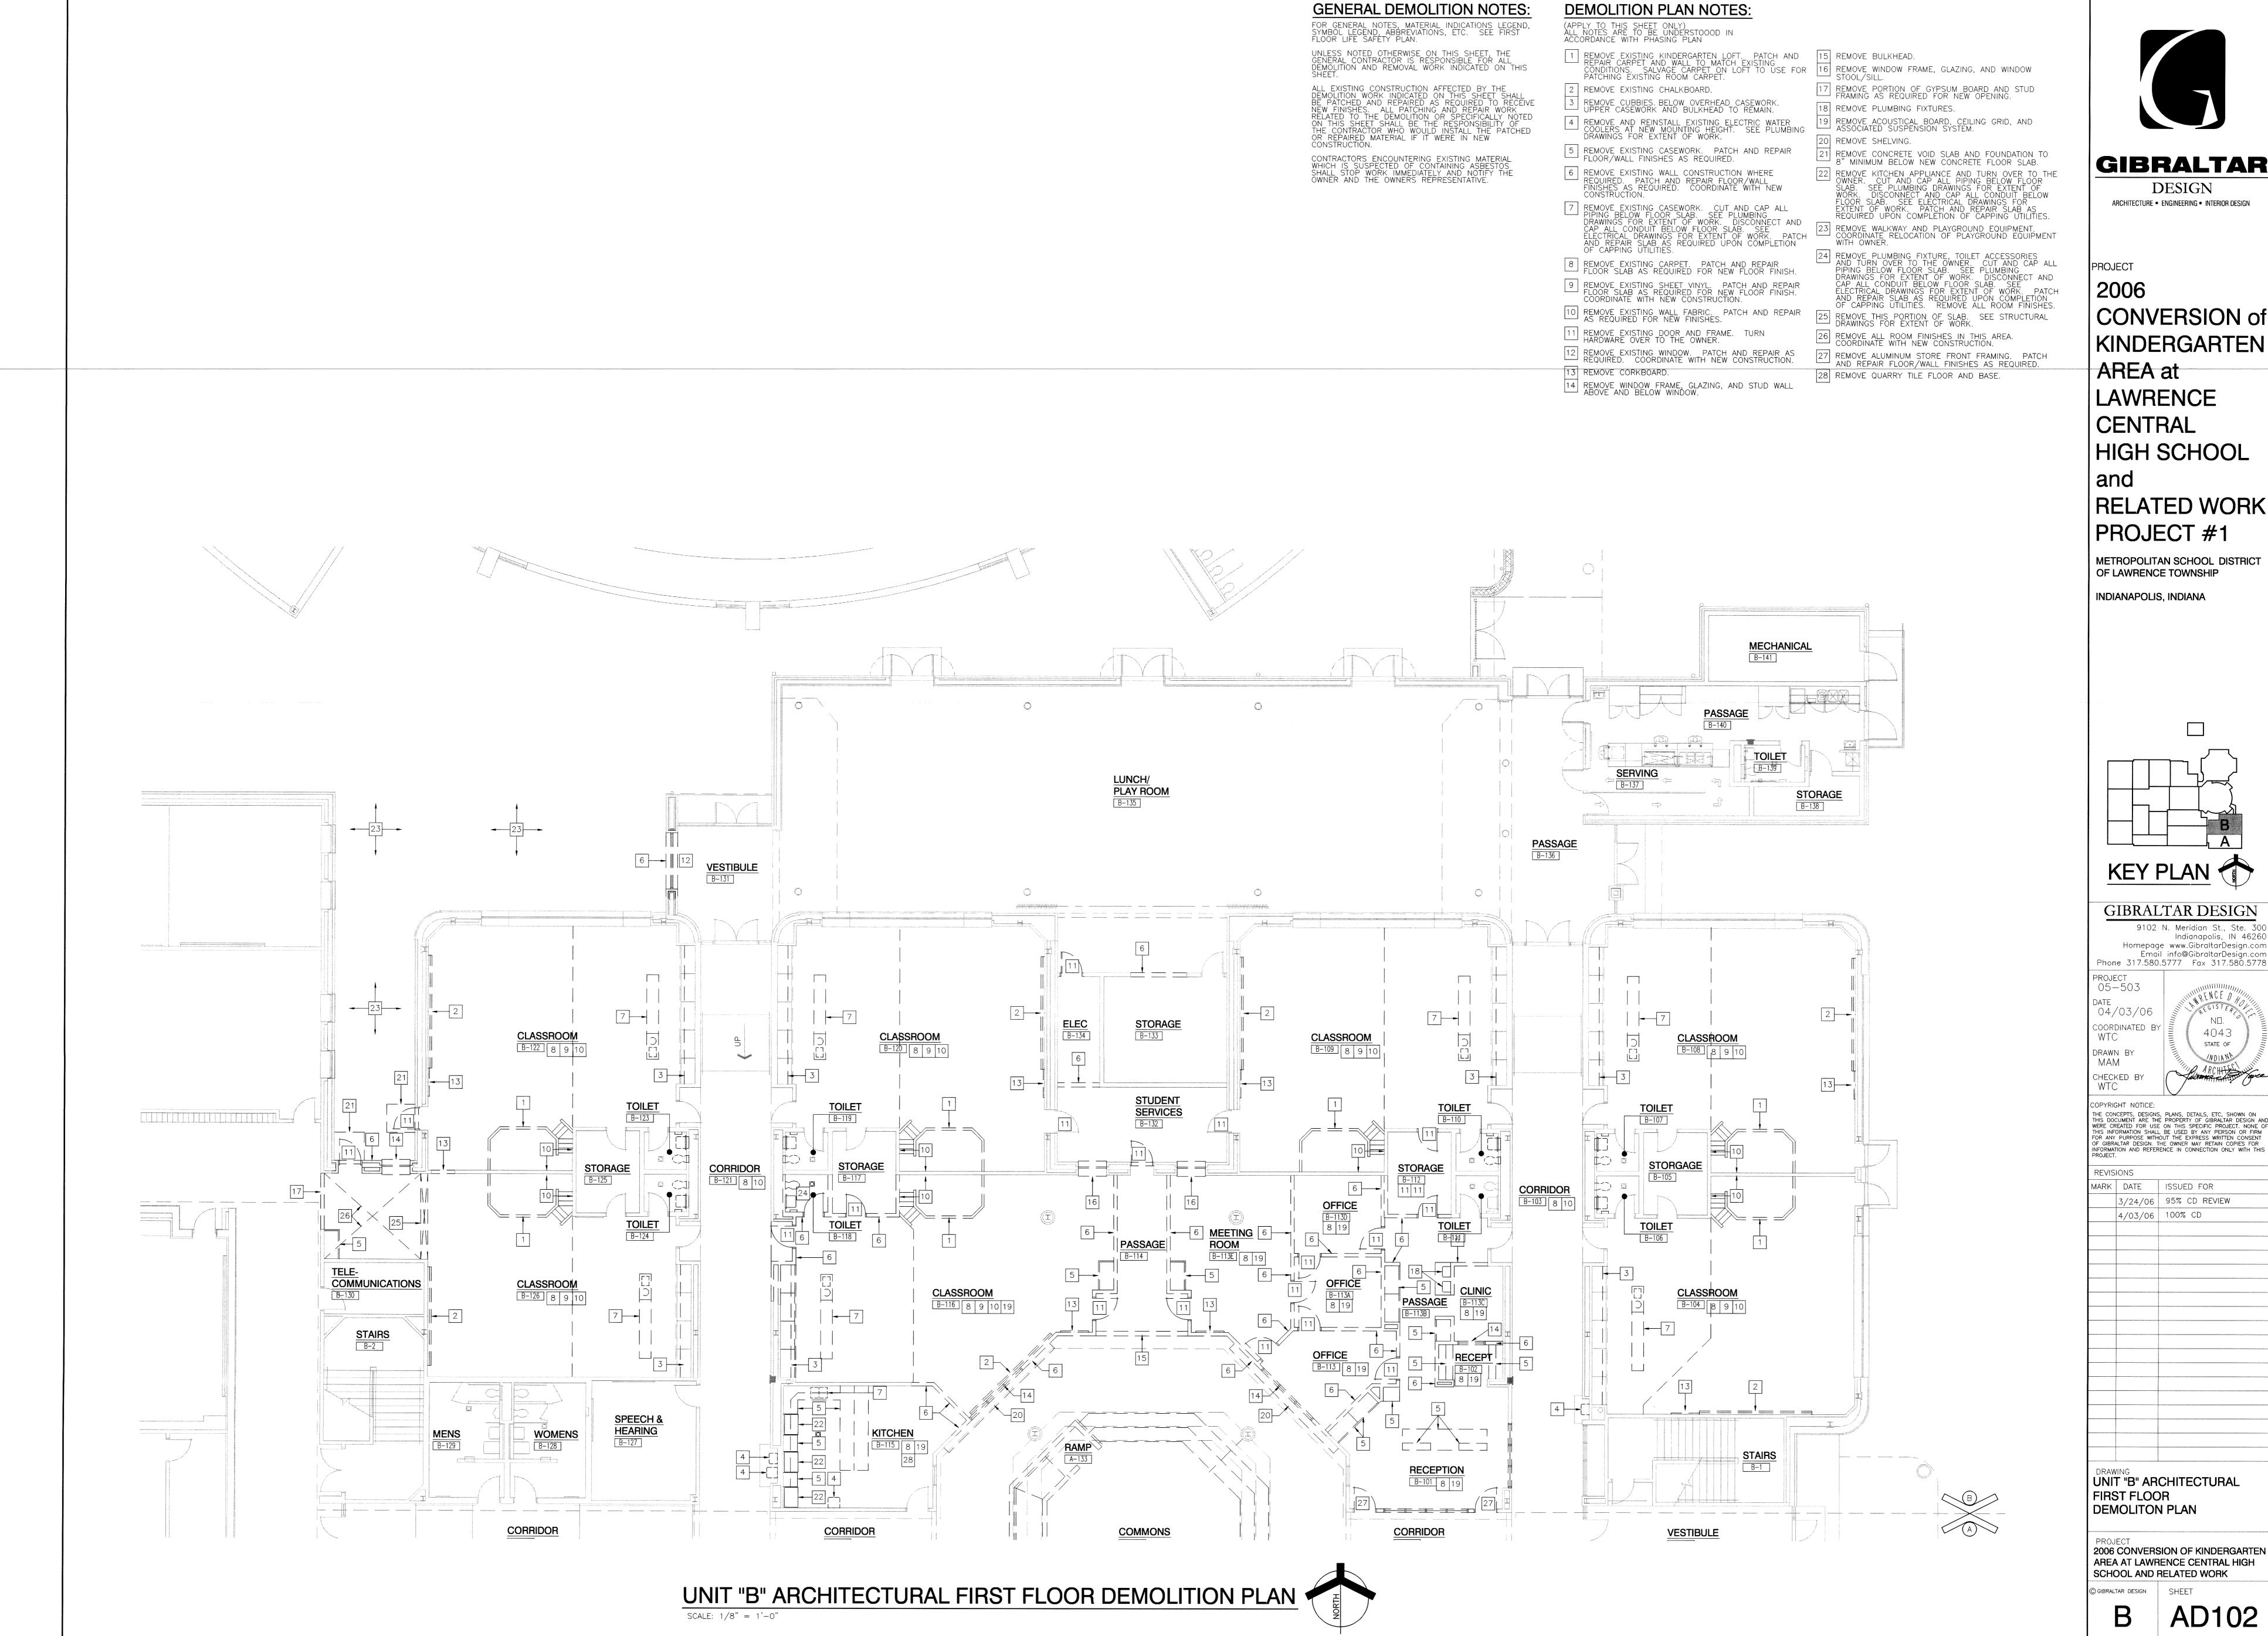


GIBRALTAR

ARCHITECTURE • ENGINEERING • INTERIOR DESIGN

CONVERSION of KINDERGARTEN HIGH SCHOOL RELATED WORK

METROPOLITAN SCHOOL DISTRICT

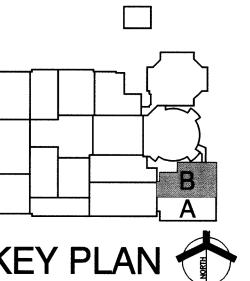

GIBRALTAR DESIGN

PROJECT
2006 CONVERSION OF KINDERGARTEN AREA AT LAWRENCE CENTRAL HIGH

GENERAL NOTES:

FOR GENERAL NOTES, MATERIAL INDICATIONS LEGEND, SYMBOL LEGEND, ABBREVIATIONS, ETC. SEE FIRST FLOOR LIFE SAFETY PLAN.

SEE DEMOLITION SHEETS FOR ADDITIONAL PATCHING AND REPAIR WORK.

MISCELLANEOUS CASEWORK ELEVATION SYMBOL — SEE SHEET AI801 THRU AI8XX FOR MISCELLANEOUS CASEWORK ELEVATIONS.

PLAN NOTES:

(APPLY TO THIS SHEET ONLY)
ALL NOTES ARE TO BE UNDERSTOOD IN ACCORDANCE
WITH PHASING PLAN.

1 FLOOR AND WALL FINISHES PATCHED AND REPAIRED IN AREA OF REMOVED KINDERGARTEN LOFT. SALVAGED CARPET FROM LOFT USED TO PATCH ROOM CARPET.

4 EXISTING ELECTRIC WATER COOLERS REINSTALLED AT NEW MOUNTING HEIGHT. REFER TO GI102 FOR MOUNTING HEIGHTS.

5 ADJUST EXISTING CEILING AS REQUIRED TO ACCOMMODATE FOR WALL DEMOLITION IN THIS AREA.

6 PATCH/REPAIR AND COORDINATE ACOUSTICAL BOARD CEILING BETWEEN ADJOINING ROOMS WHERE WALL DEMOLITION HAS OCCURED.

7 CONCRETE FLOOR IN-FILL.

8 4'-0" CORKBOARD———

9 8'-0" MARKERBOARD ———

(10) EXISTING CEILING TO REMAIN.

(11) EXISTING BULKHEAD AT 9'-3" AFF.

(12) PLUMBING FIXTURE AND ASSOCIATED TO

PLUMBING FIXTURE AND ASSOCIATED TOILET
ACCESSORIES REINSTALLED AT NEW MOUNTING HEIGHT.
PATCH AND REPAIR FINISHES AS REQUIRED. SEE
PLUMBING FOR EXTENT OF WORK (ALTERNATE).

(13) 2" WOOD TRIM FROM CEILING TO OP OF CARPET
BASE.

14) NEW ACOUSTICAL BOARD CEILING TO BE COORDINATED WITH EXISTING CEILING.

GIBRALTAR

DESIGN

ARCHITECTURE • ENGINEERING • INTERIOR DESIGN


PROJECT

2006
CONVERSION of
KINDERGARTEN
AREA at
LAWRENCE
CENTRAL
HIGH SCHOOL
and

METROPOLITAN SCHOOL DISTRICT OF LAWRENCE TOWNSHIP INDIANAPOLIS, INDIANA

RELATED WORK

PROJECT #1

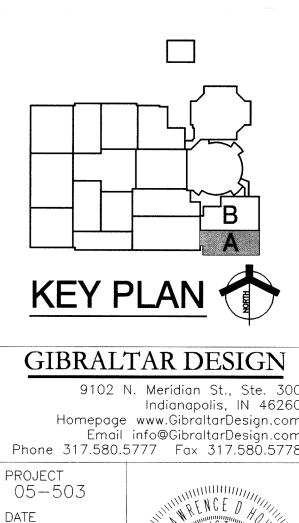

PROJECT

05-503

DATE

04/03/06

COORDINATED BY

WTC

DRAWN BY

MAM

CHECKED BY

WTC

COPYRIGHT NOTICE:

THE CONCEPTS, DESIGNS, PLANS, DETAILS, ETC, SHOWN ON THIS DOCUMENT ARE THE PROPERTY OF GIBRALTAR DESIGN AND WERE CREATED FOR USE ON THIS SPECIFIC PROJECT. NONE OF THIS INFORMATION SHALL BE USED BY ANY PERSON OR FIRM FOR ANY PURPOSE WITHOUT THE EXPRESS WRITTEN CONSENT OF GIBRALTAR DESIGN. THE OWNER MAY RETAIN COPIES FOR INFORMATION AND REFERENCE IN CONNECTION ONLY WITH THIS PROJECT.

INFORMATION AND REFERENCE IN CONNECTION ONLY WITH THE PROJECT.

REVISIONS

MARK DATE ISSUED FOR


3/24/06 95% CD REVIEW


4/03/06 100% CD

DRAWING
UNIT "A" ARCHITECTURAL
FIRST FLOOR PLAN


PROJECT
2006 CONVERSION OF KINDERGARTEN
AREA AT LAWRENCE CENTRAL HIGH
SCHOOL AND RELATED WORK

SHEET
AE101

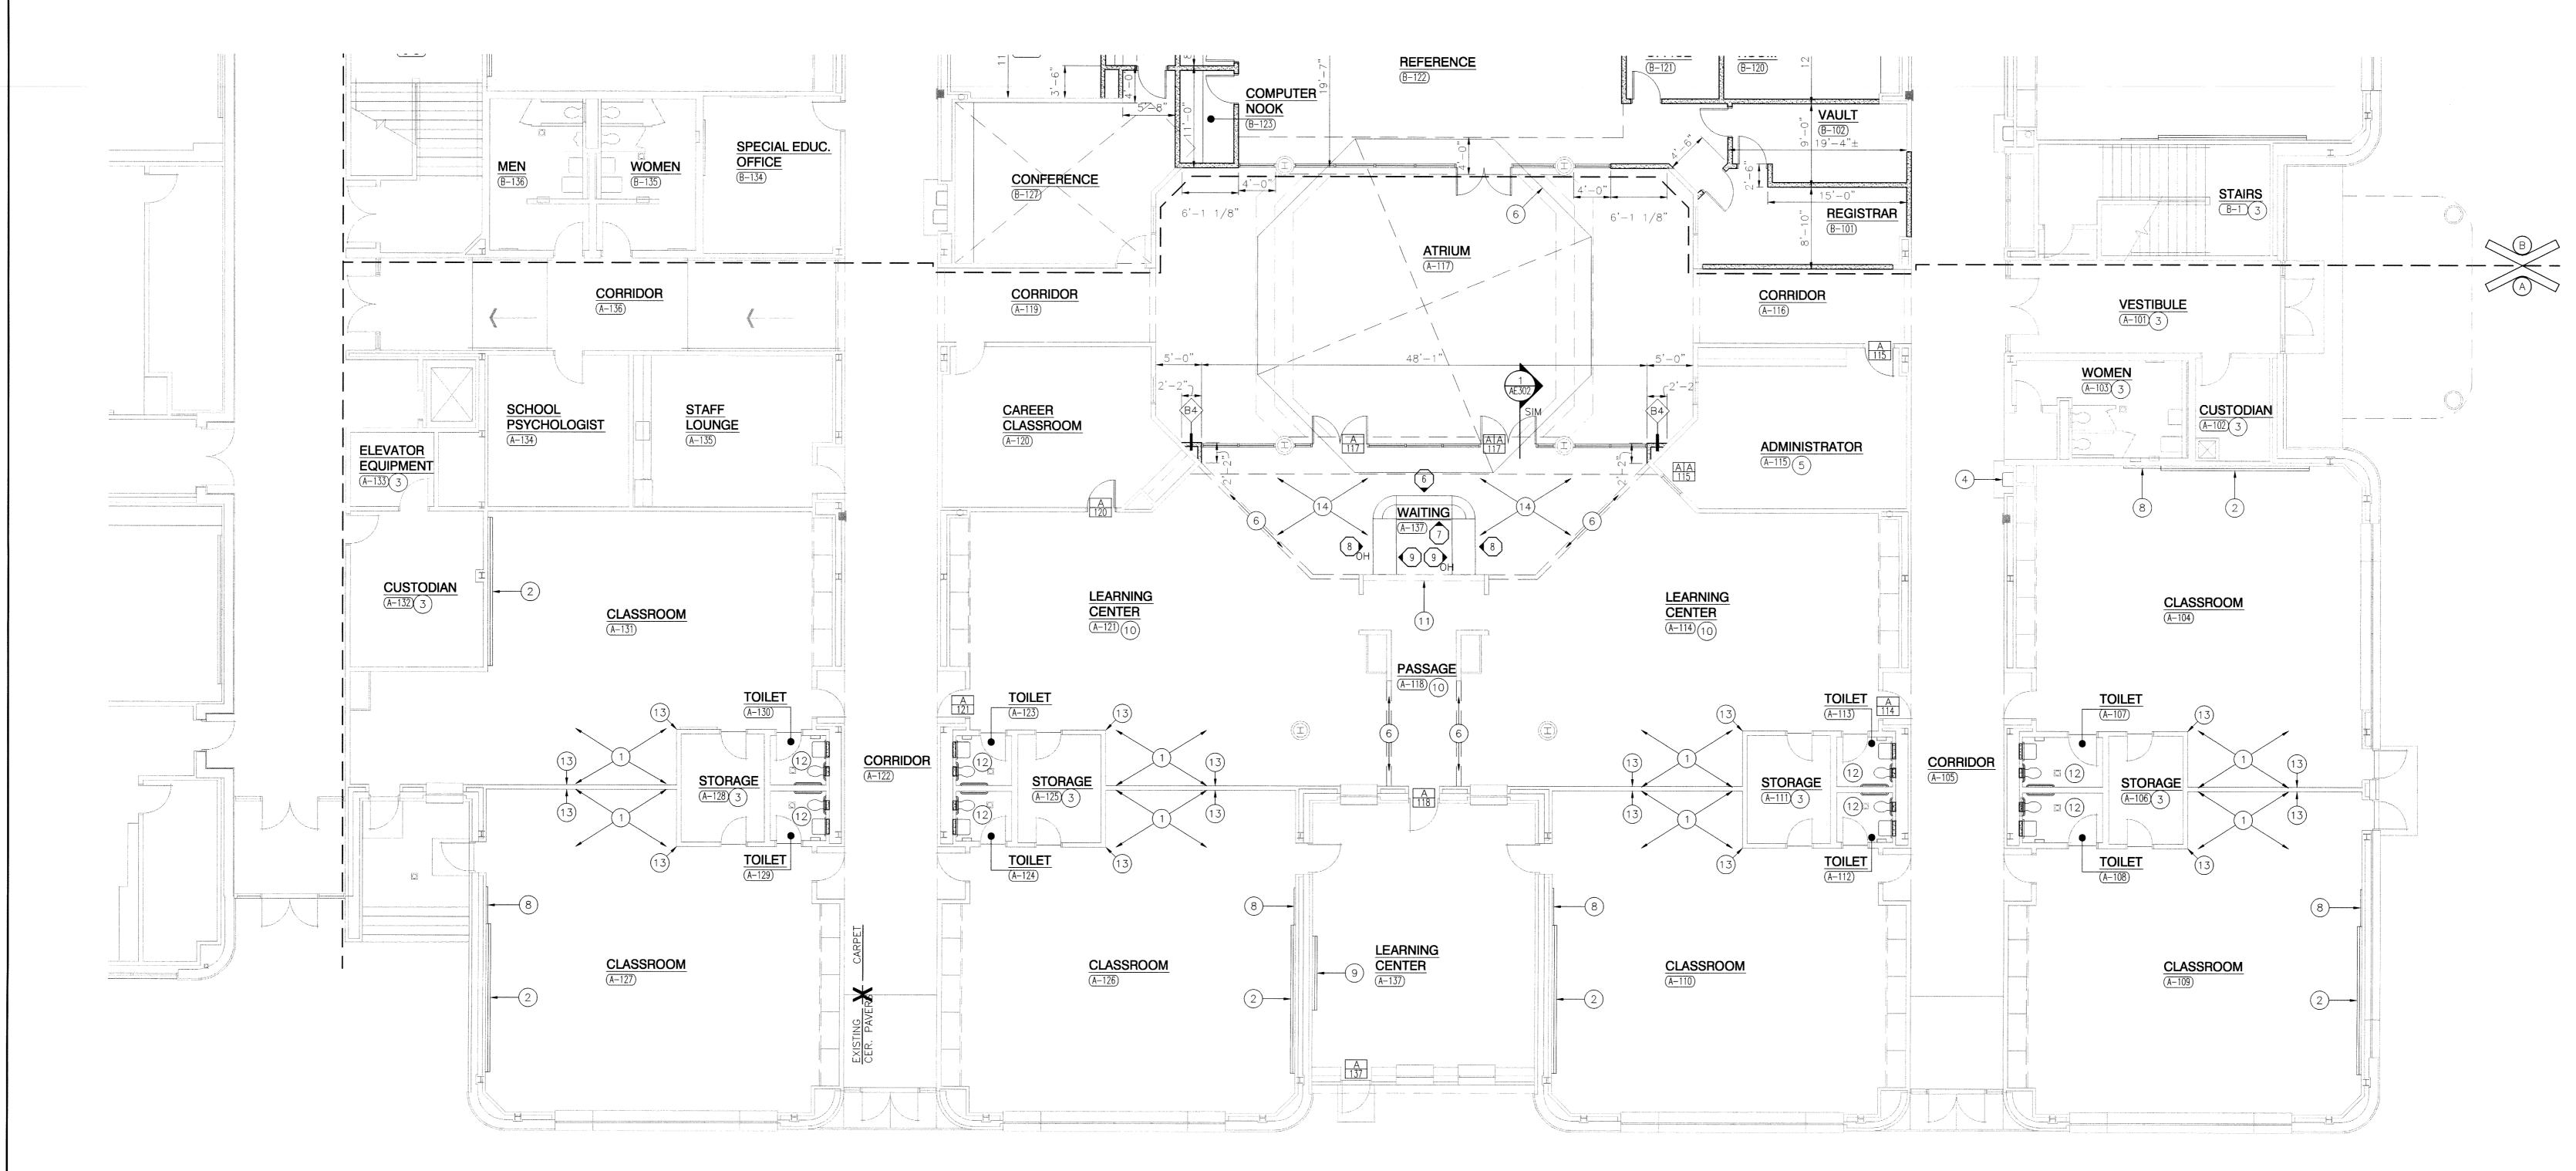

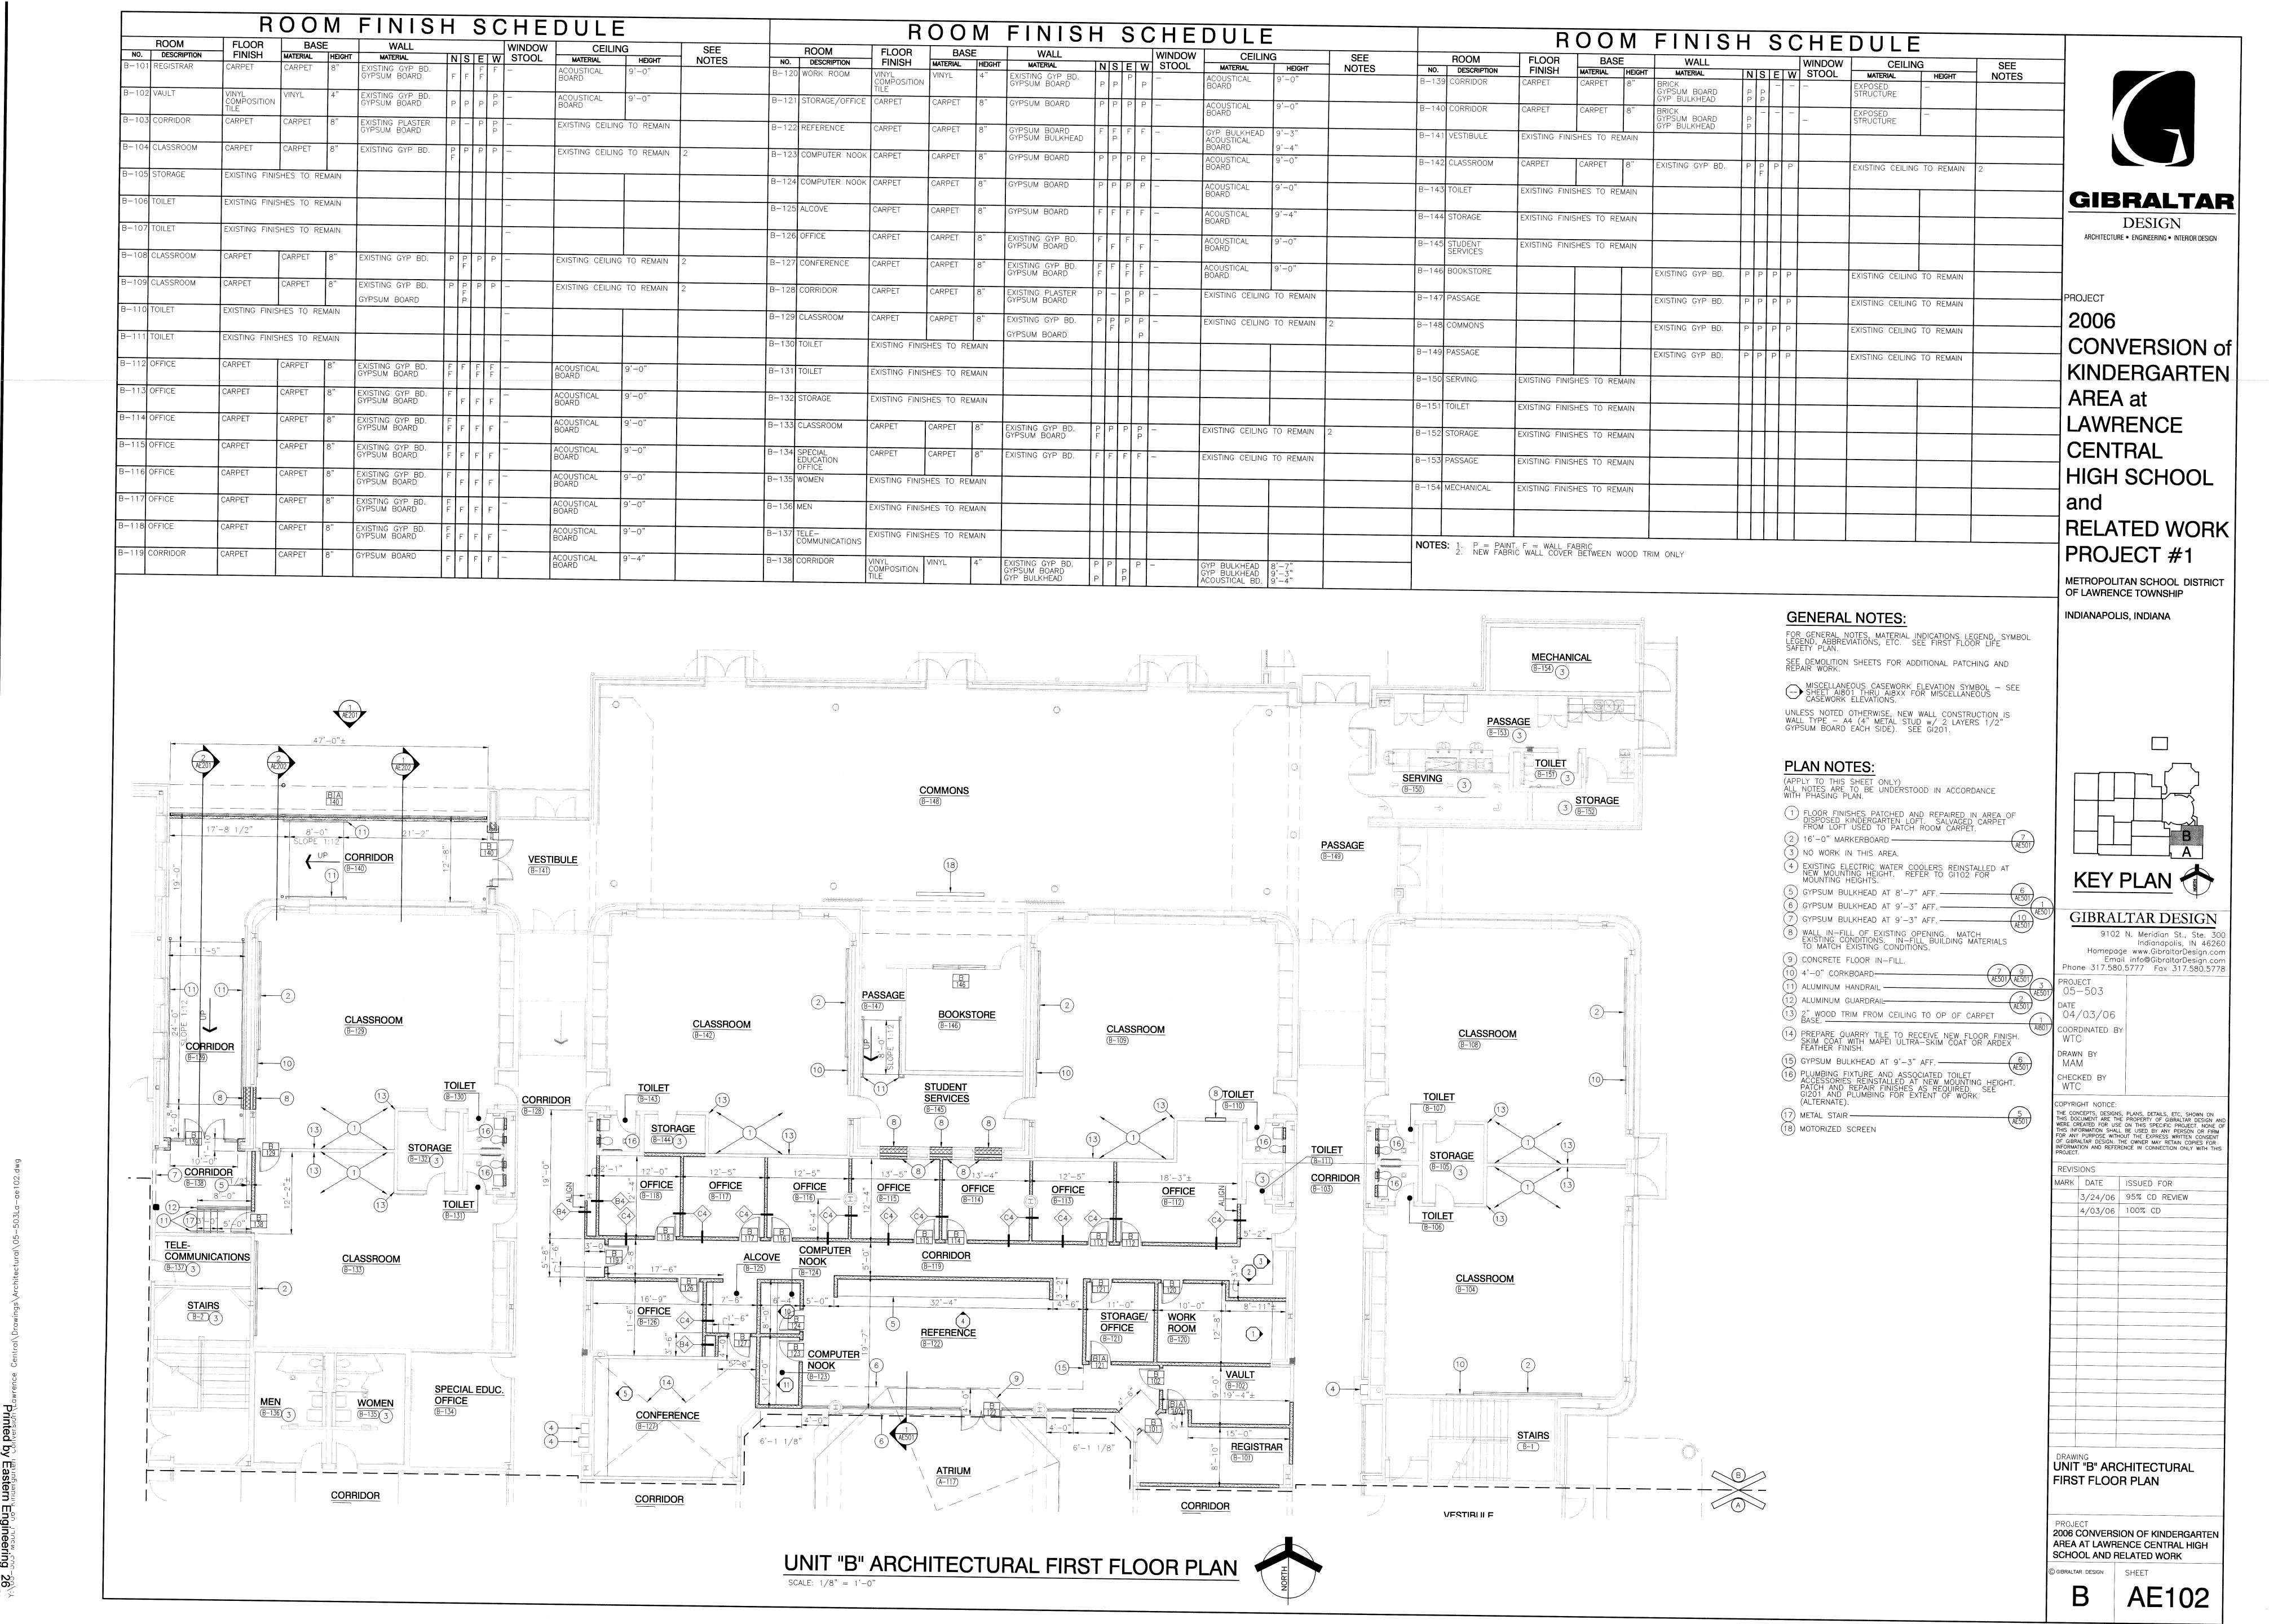

Tue 4/04/2006 - 7.12 am

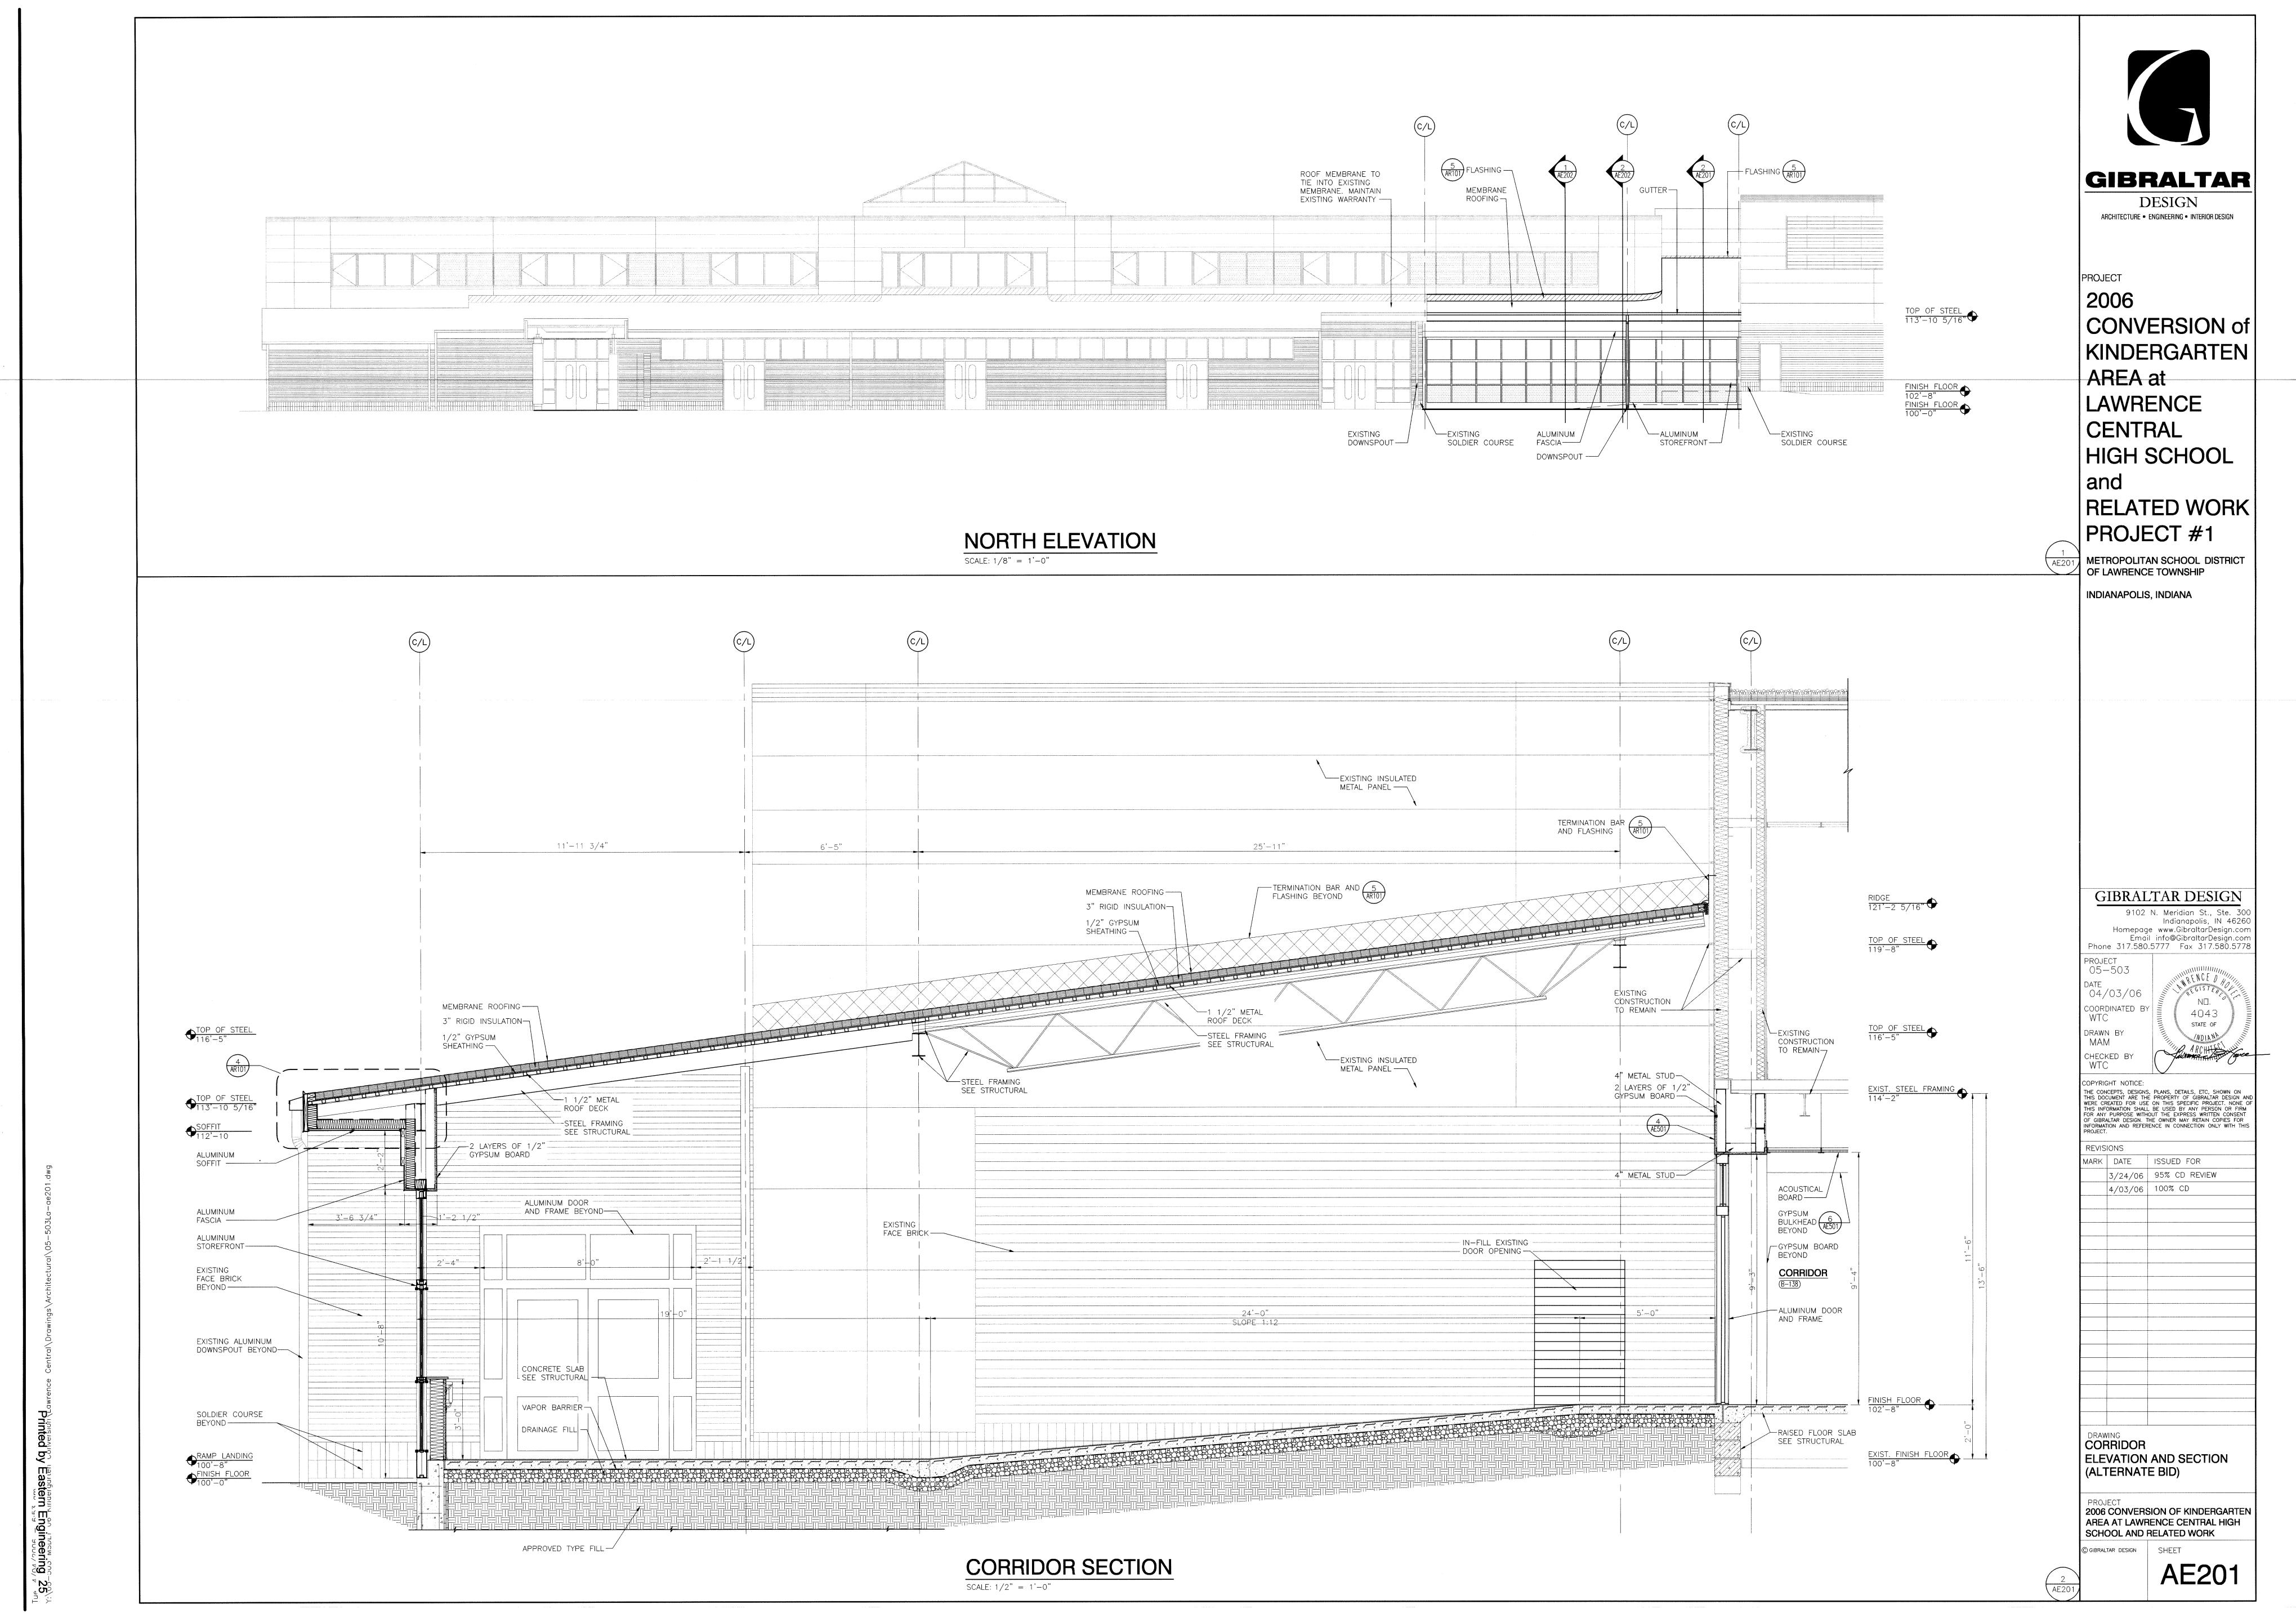



2006
CONVERSION of KINDERGARTEN AREA at LAWRENCE CENTRAL HIGH SCHOOL and RELATED WORK PROJECT #1

METROPOLITAN SCHOOL DISTRICT OF LAWRENCE TOWNSHIP INDIANAPOLIS, INDIANA

GIBRALTAR DESIGN

9102 N. Meridian St., Ste. 300
Indianapolis, IN 46260
Homepage www.GibraltarDesign.com
Email info@GibraltarDesign.com
Phone 317.580.5777 Fax 317.580.5778

PROJECT
05-503

DATE
04/03/06

COORDINATED BY
WTC

DRAWN BY
MAM
CHECKED BY
WTC

COPYRIGHT NOTICE:
THE CONCEPTS, DESIGNS, PLANS, DETAILS, ETC, SHOWN ON THIS DOCUMENT ARE THE PROPERTY OF GIBRALTAR DESIGN AND WERE CREATED FOR USE ON THIS SPECIFIC PROJECT. NONE OF THIS INFORMATION SHALL BE USED BY ANY PERSON OR FIRM FOR ANY PURPOSE WITHOUT THE EXPRESS WRITTEN CONSENT OF GIBRALTAR DESIGN. THE OWNER MAY RETAIN COPIES FOR INFORMATION AND REFERENCE IN CONNECTION ONLY WITH THIS PROJECT.

REVISIONS

MARK DATE ISSUED FOR

MARK DATE ISSUED FOR

3/24/06 95% CD REVIEW


4/03/06 100% CD

CORRIDOR SECTIONS
(ALTERNATE BID)


PROJECT
2006 CONVERSION OF KINDERGARTEN
AREA AT LAWRENCE CENTRAL HIGH
SCHOOL AND RELATED WORK


© GIBRALTAR DESIGN SHEET


AE202

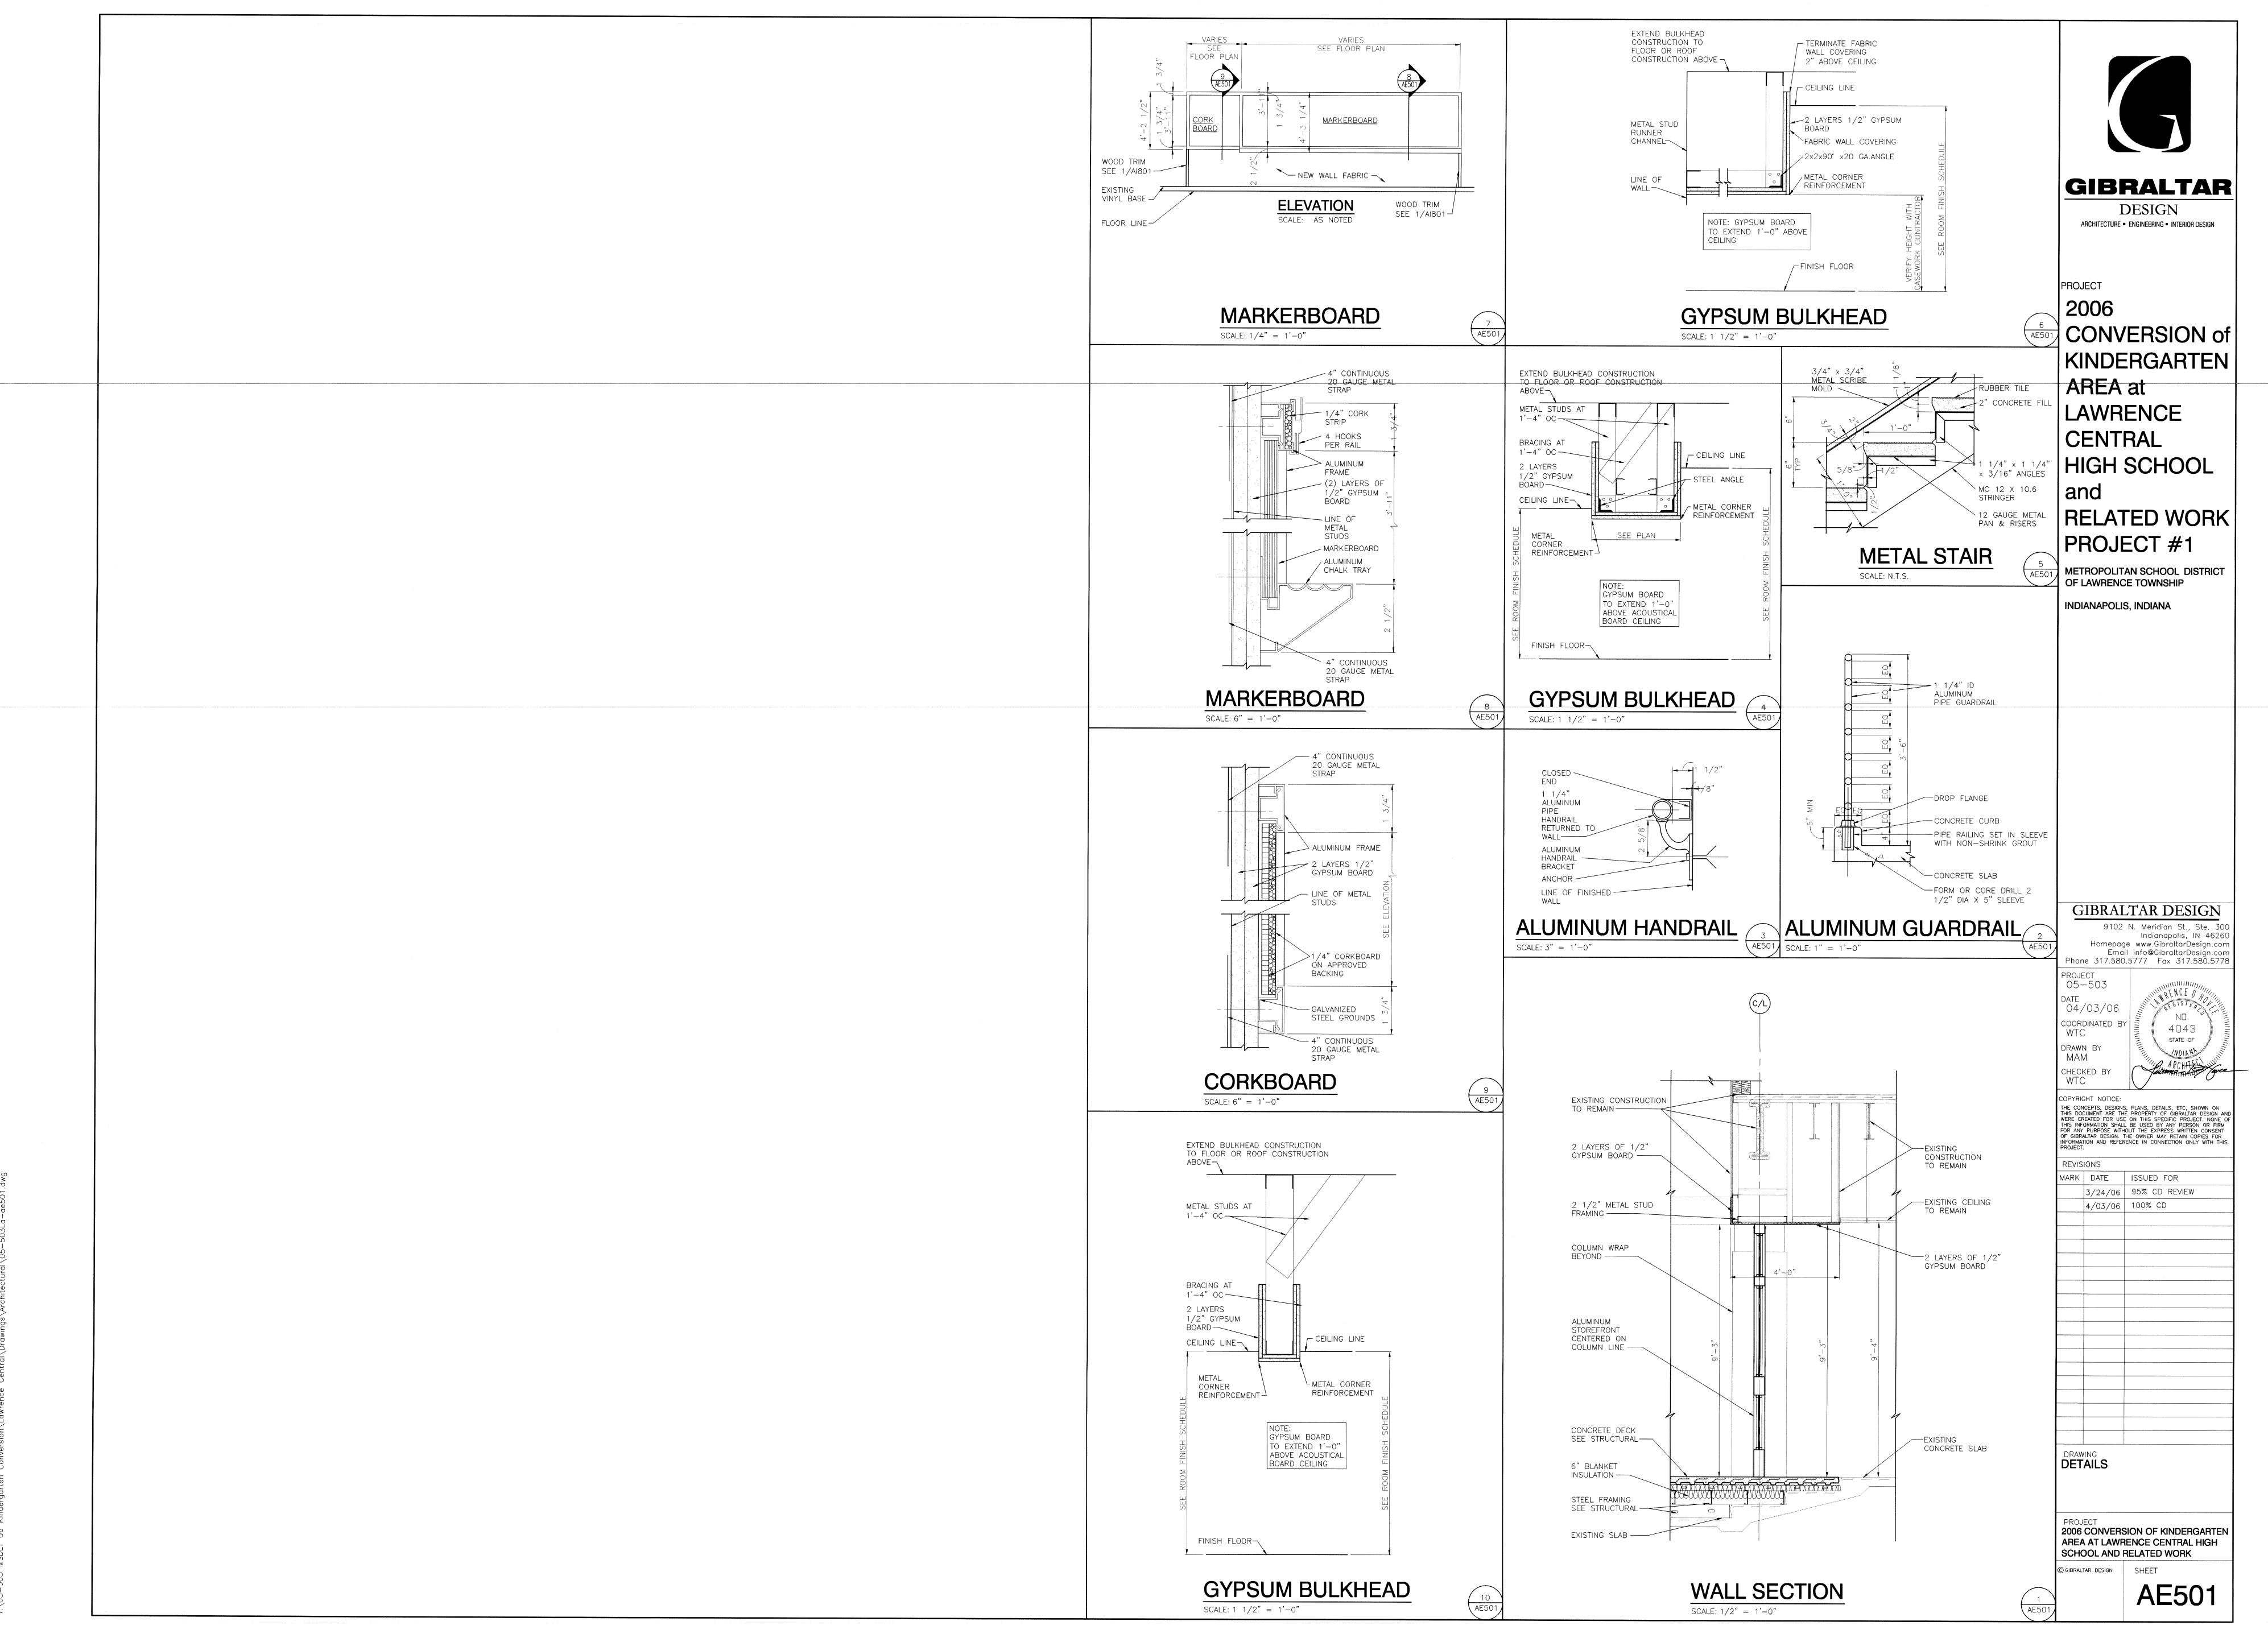

Printed by Eastern E

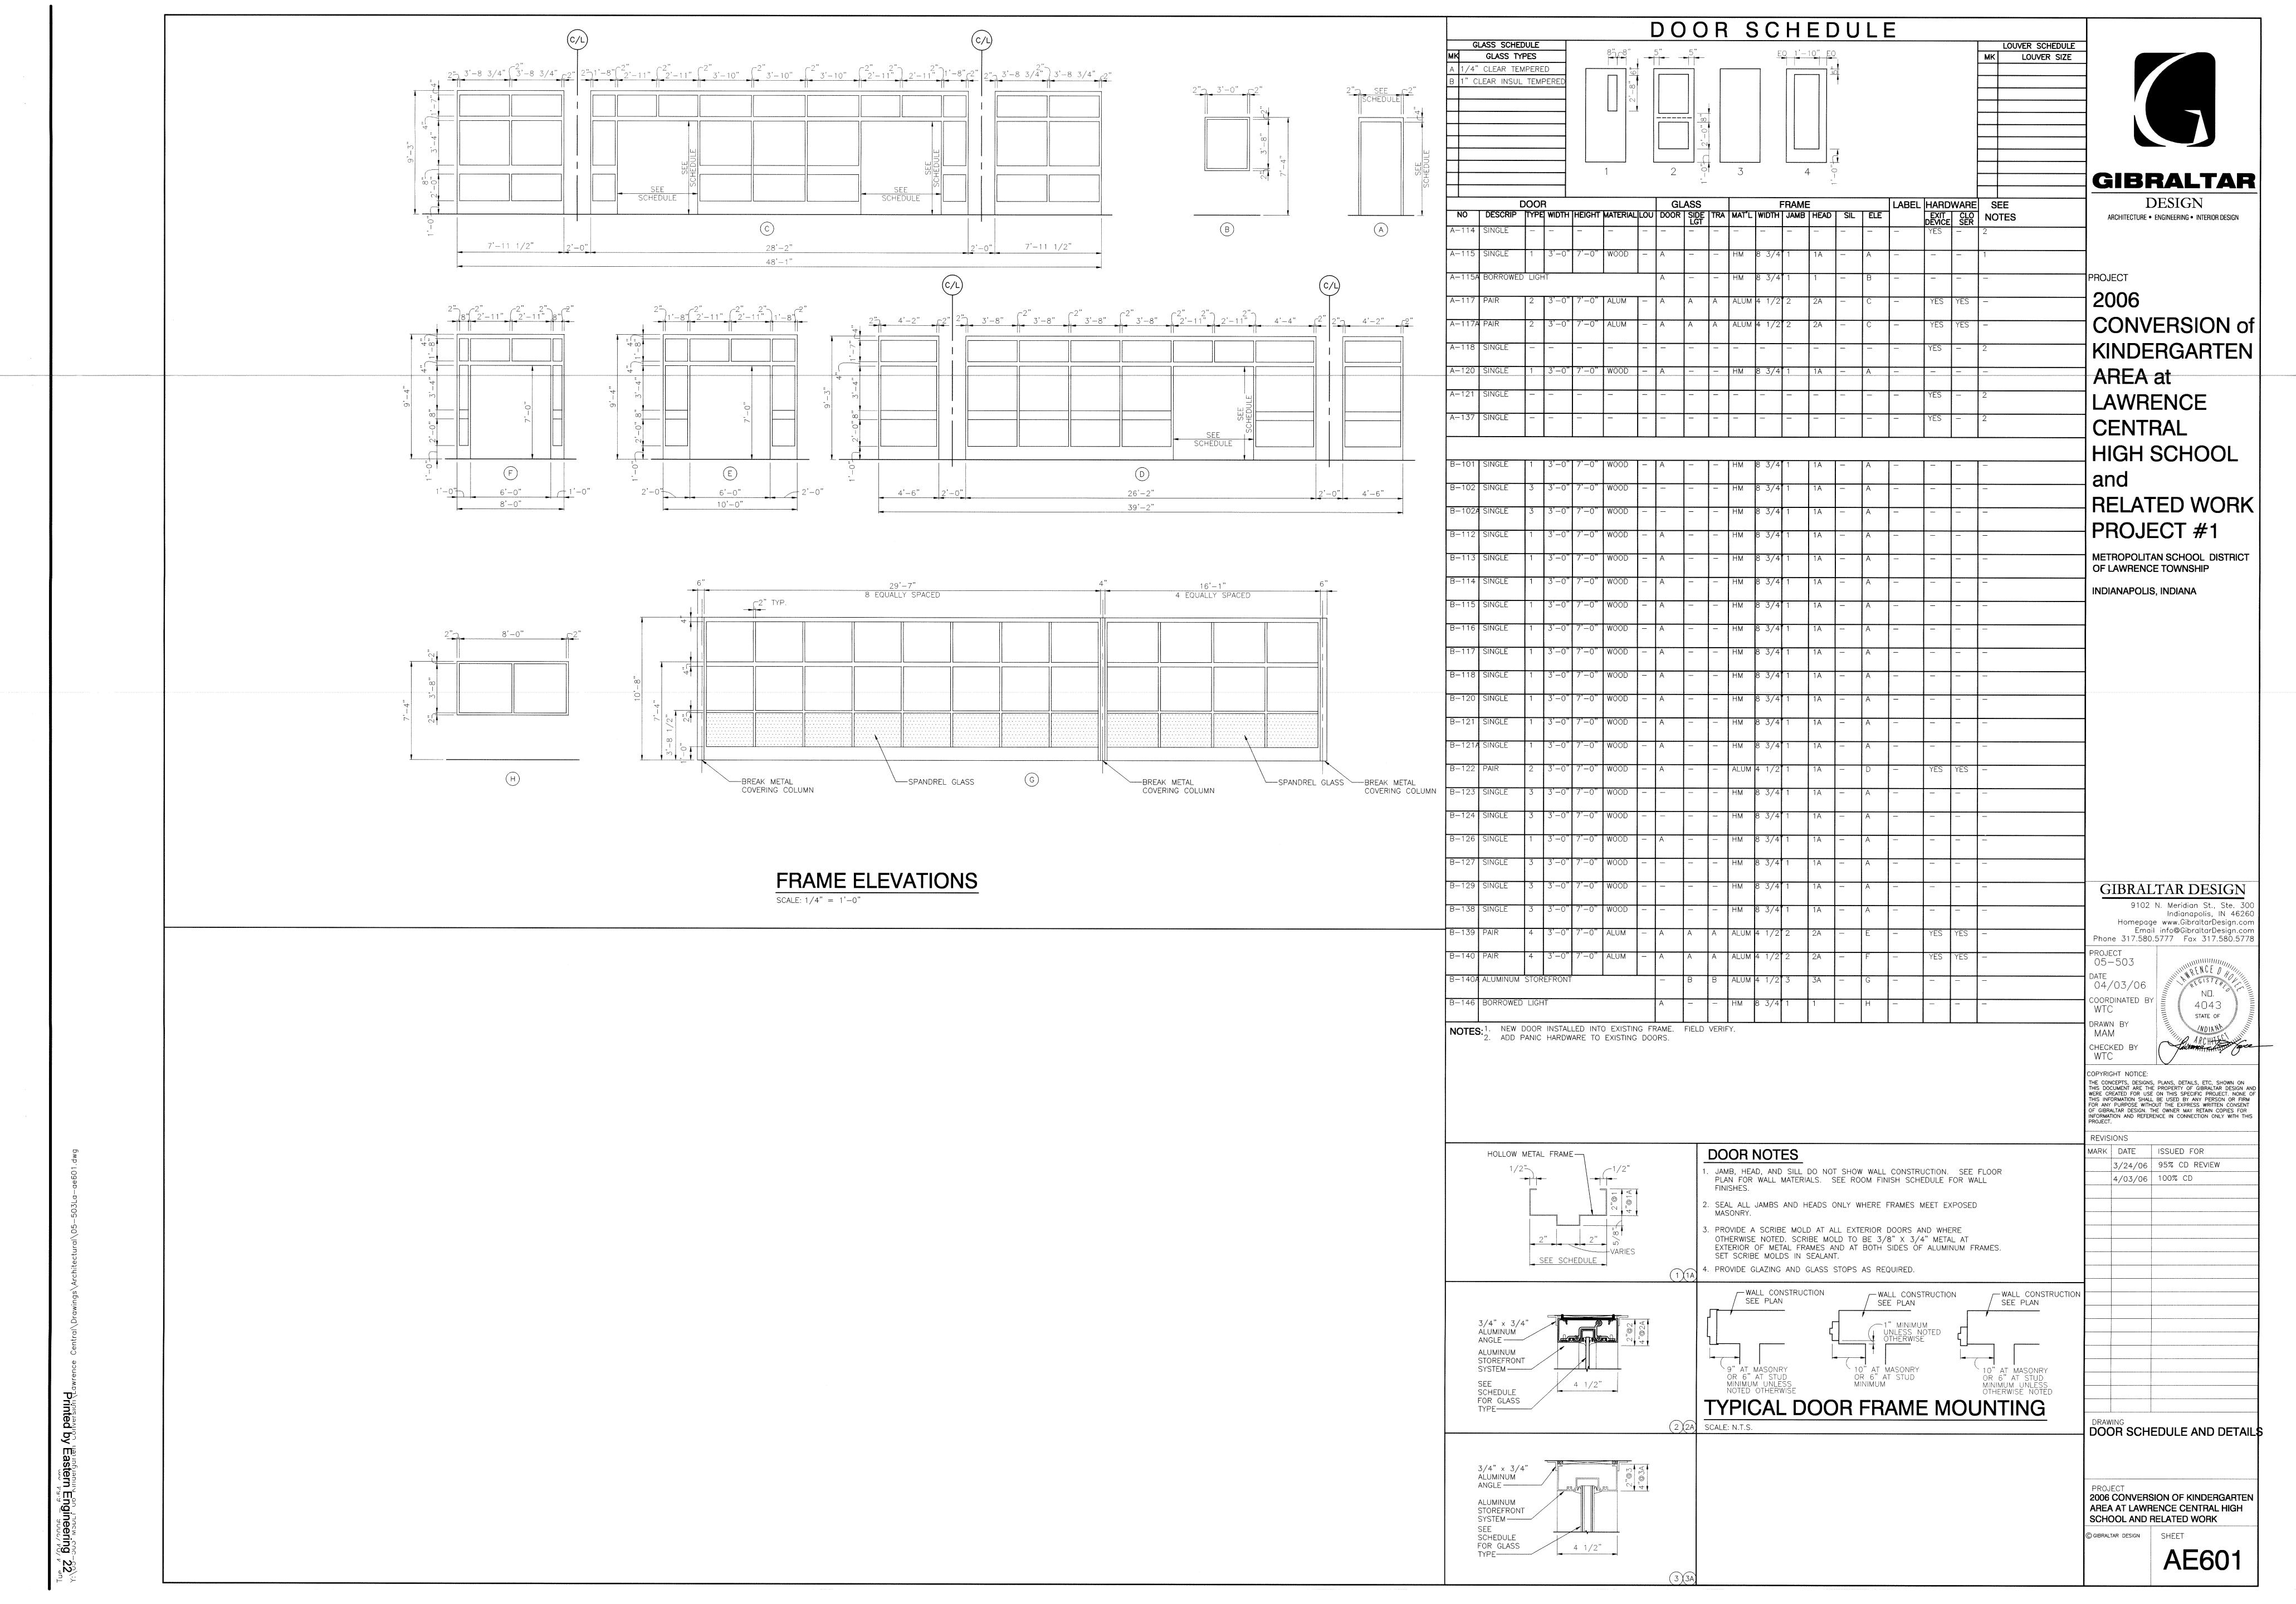

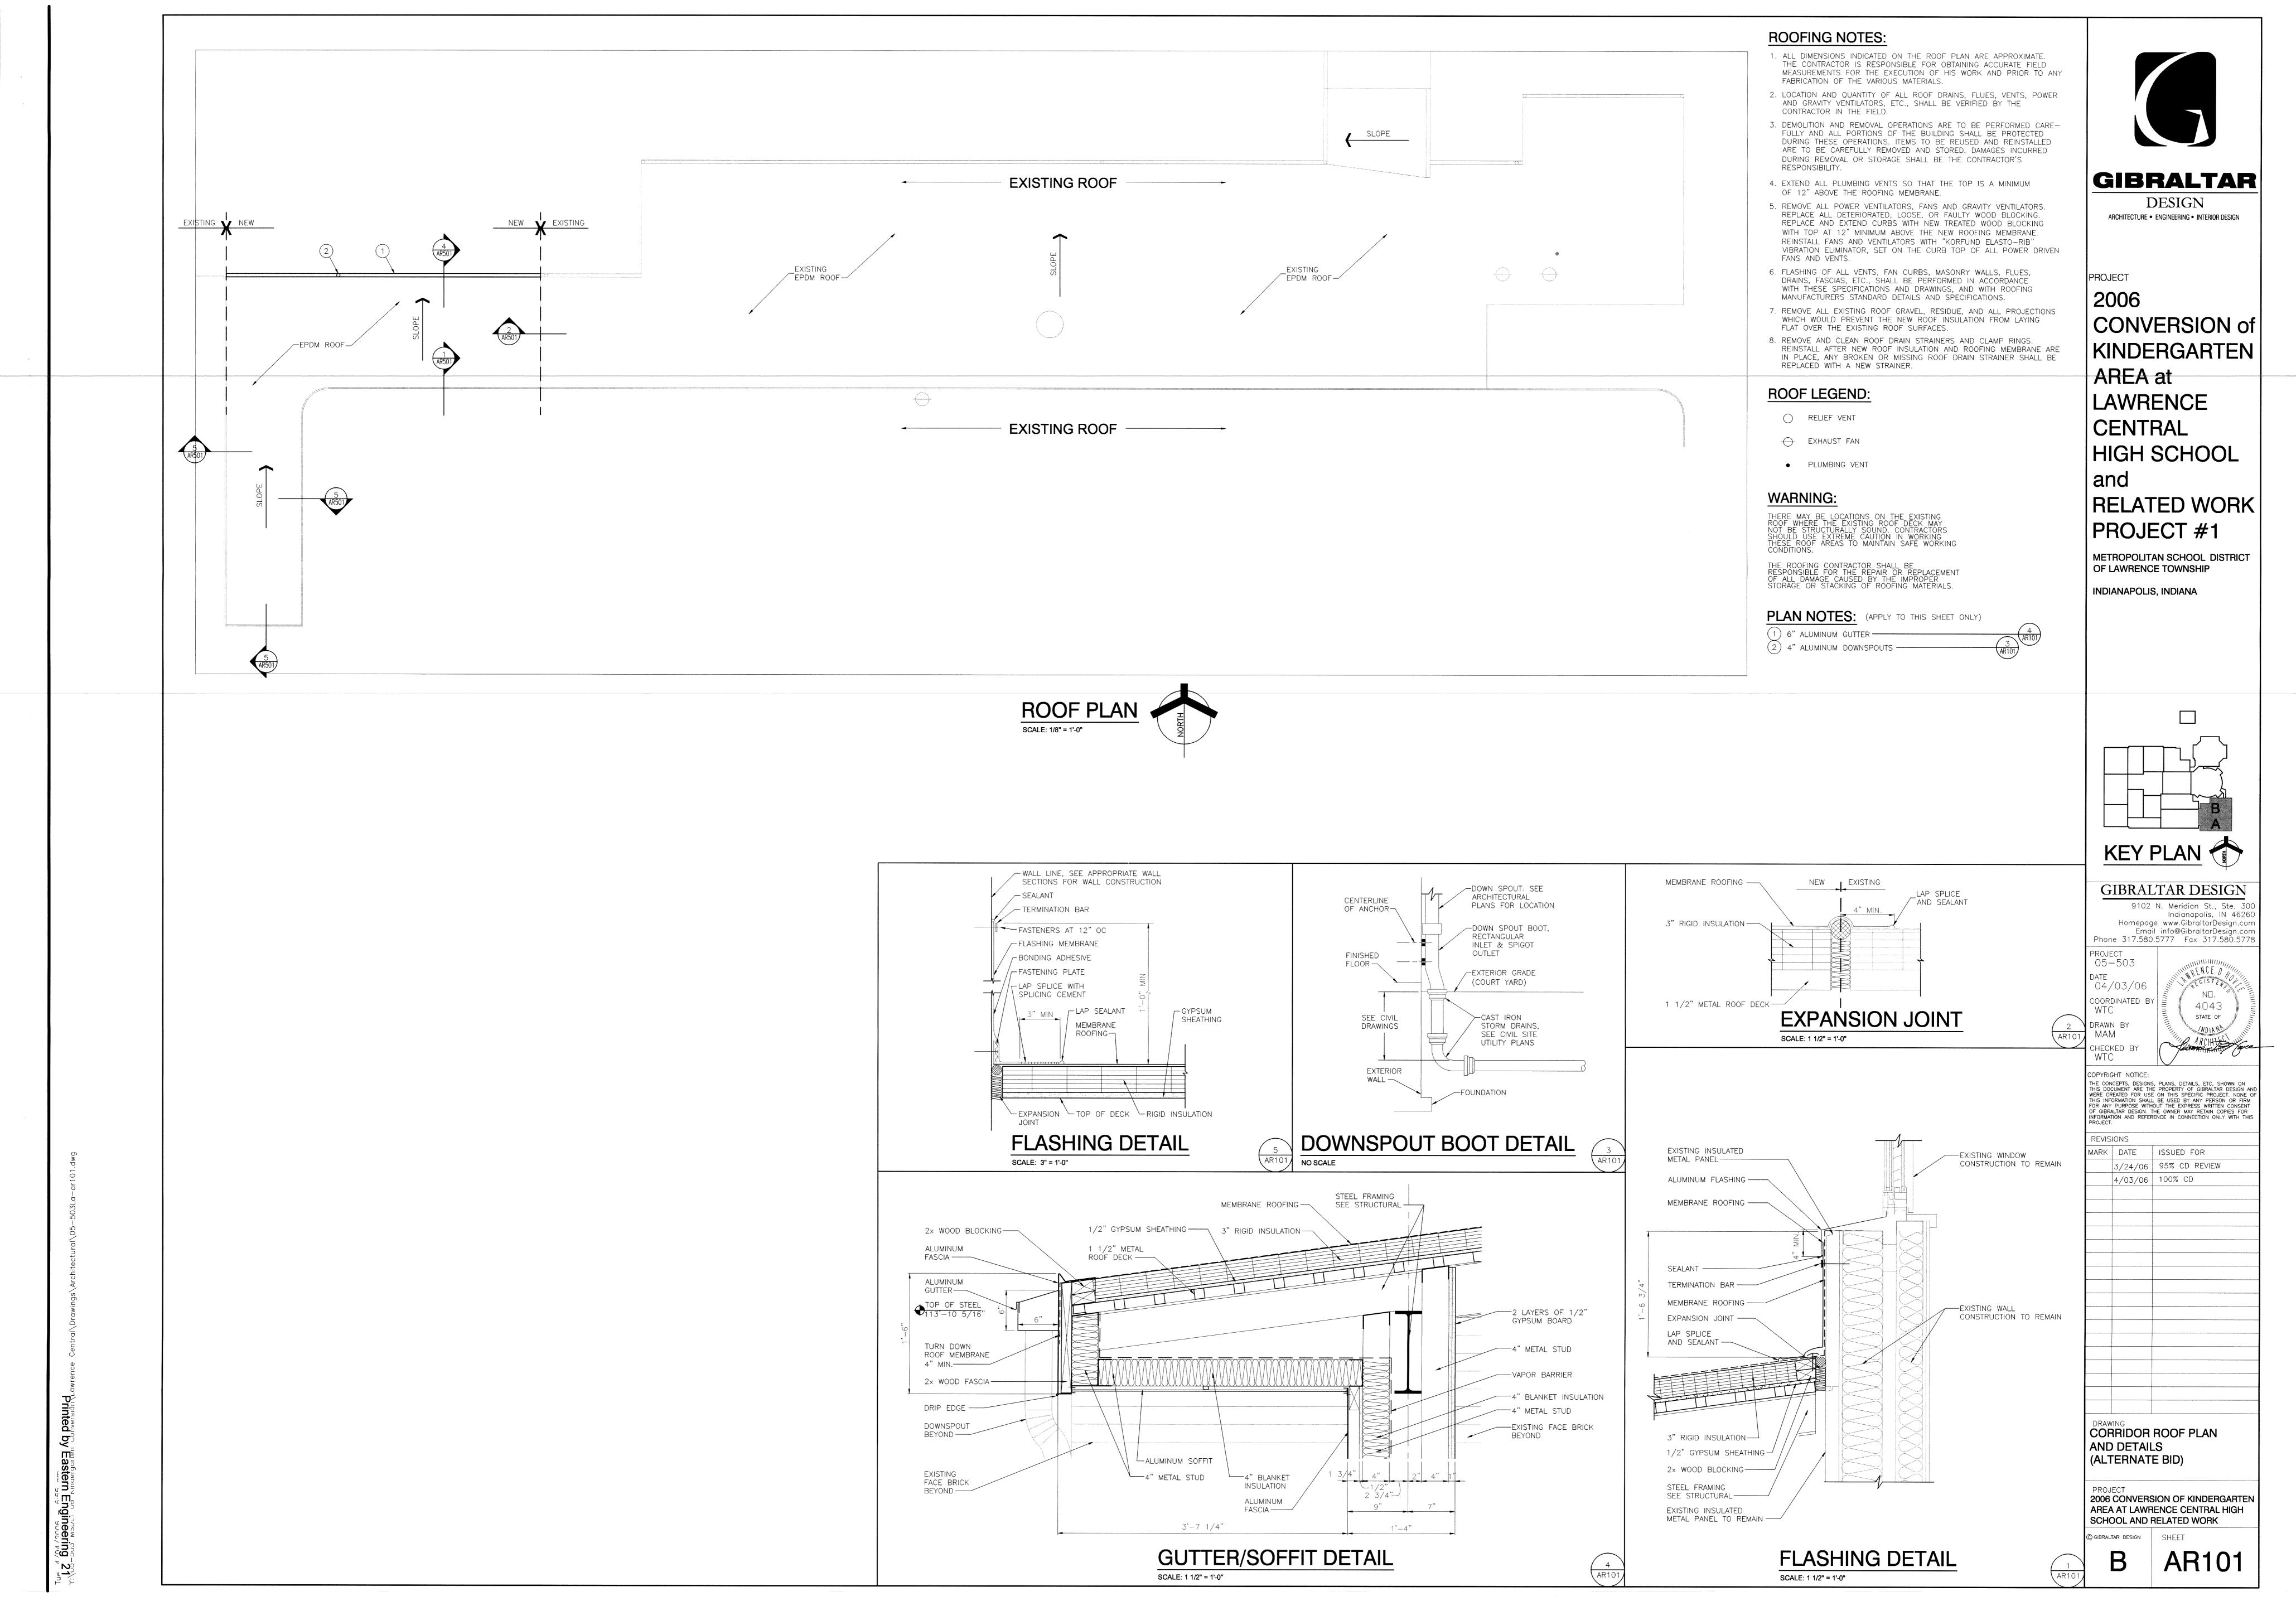

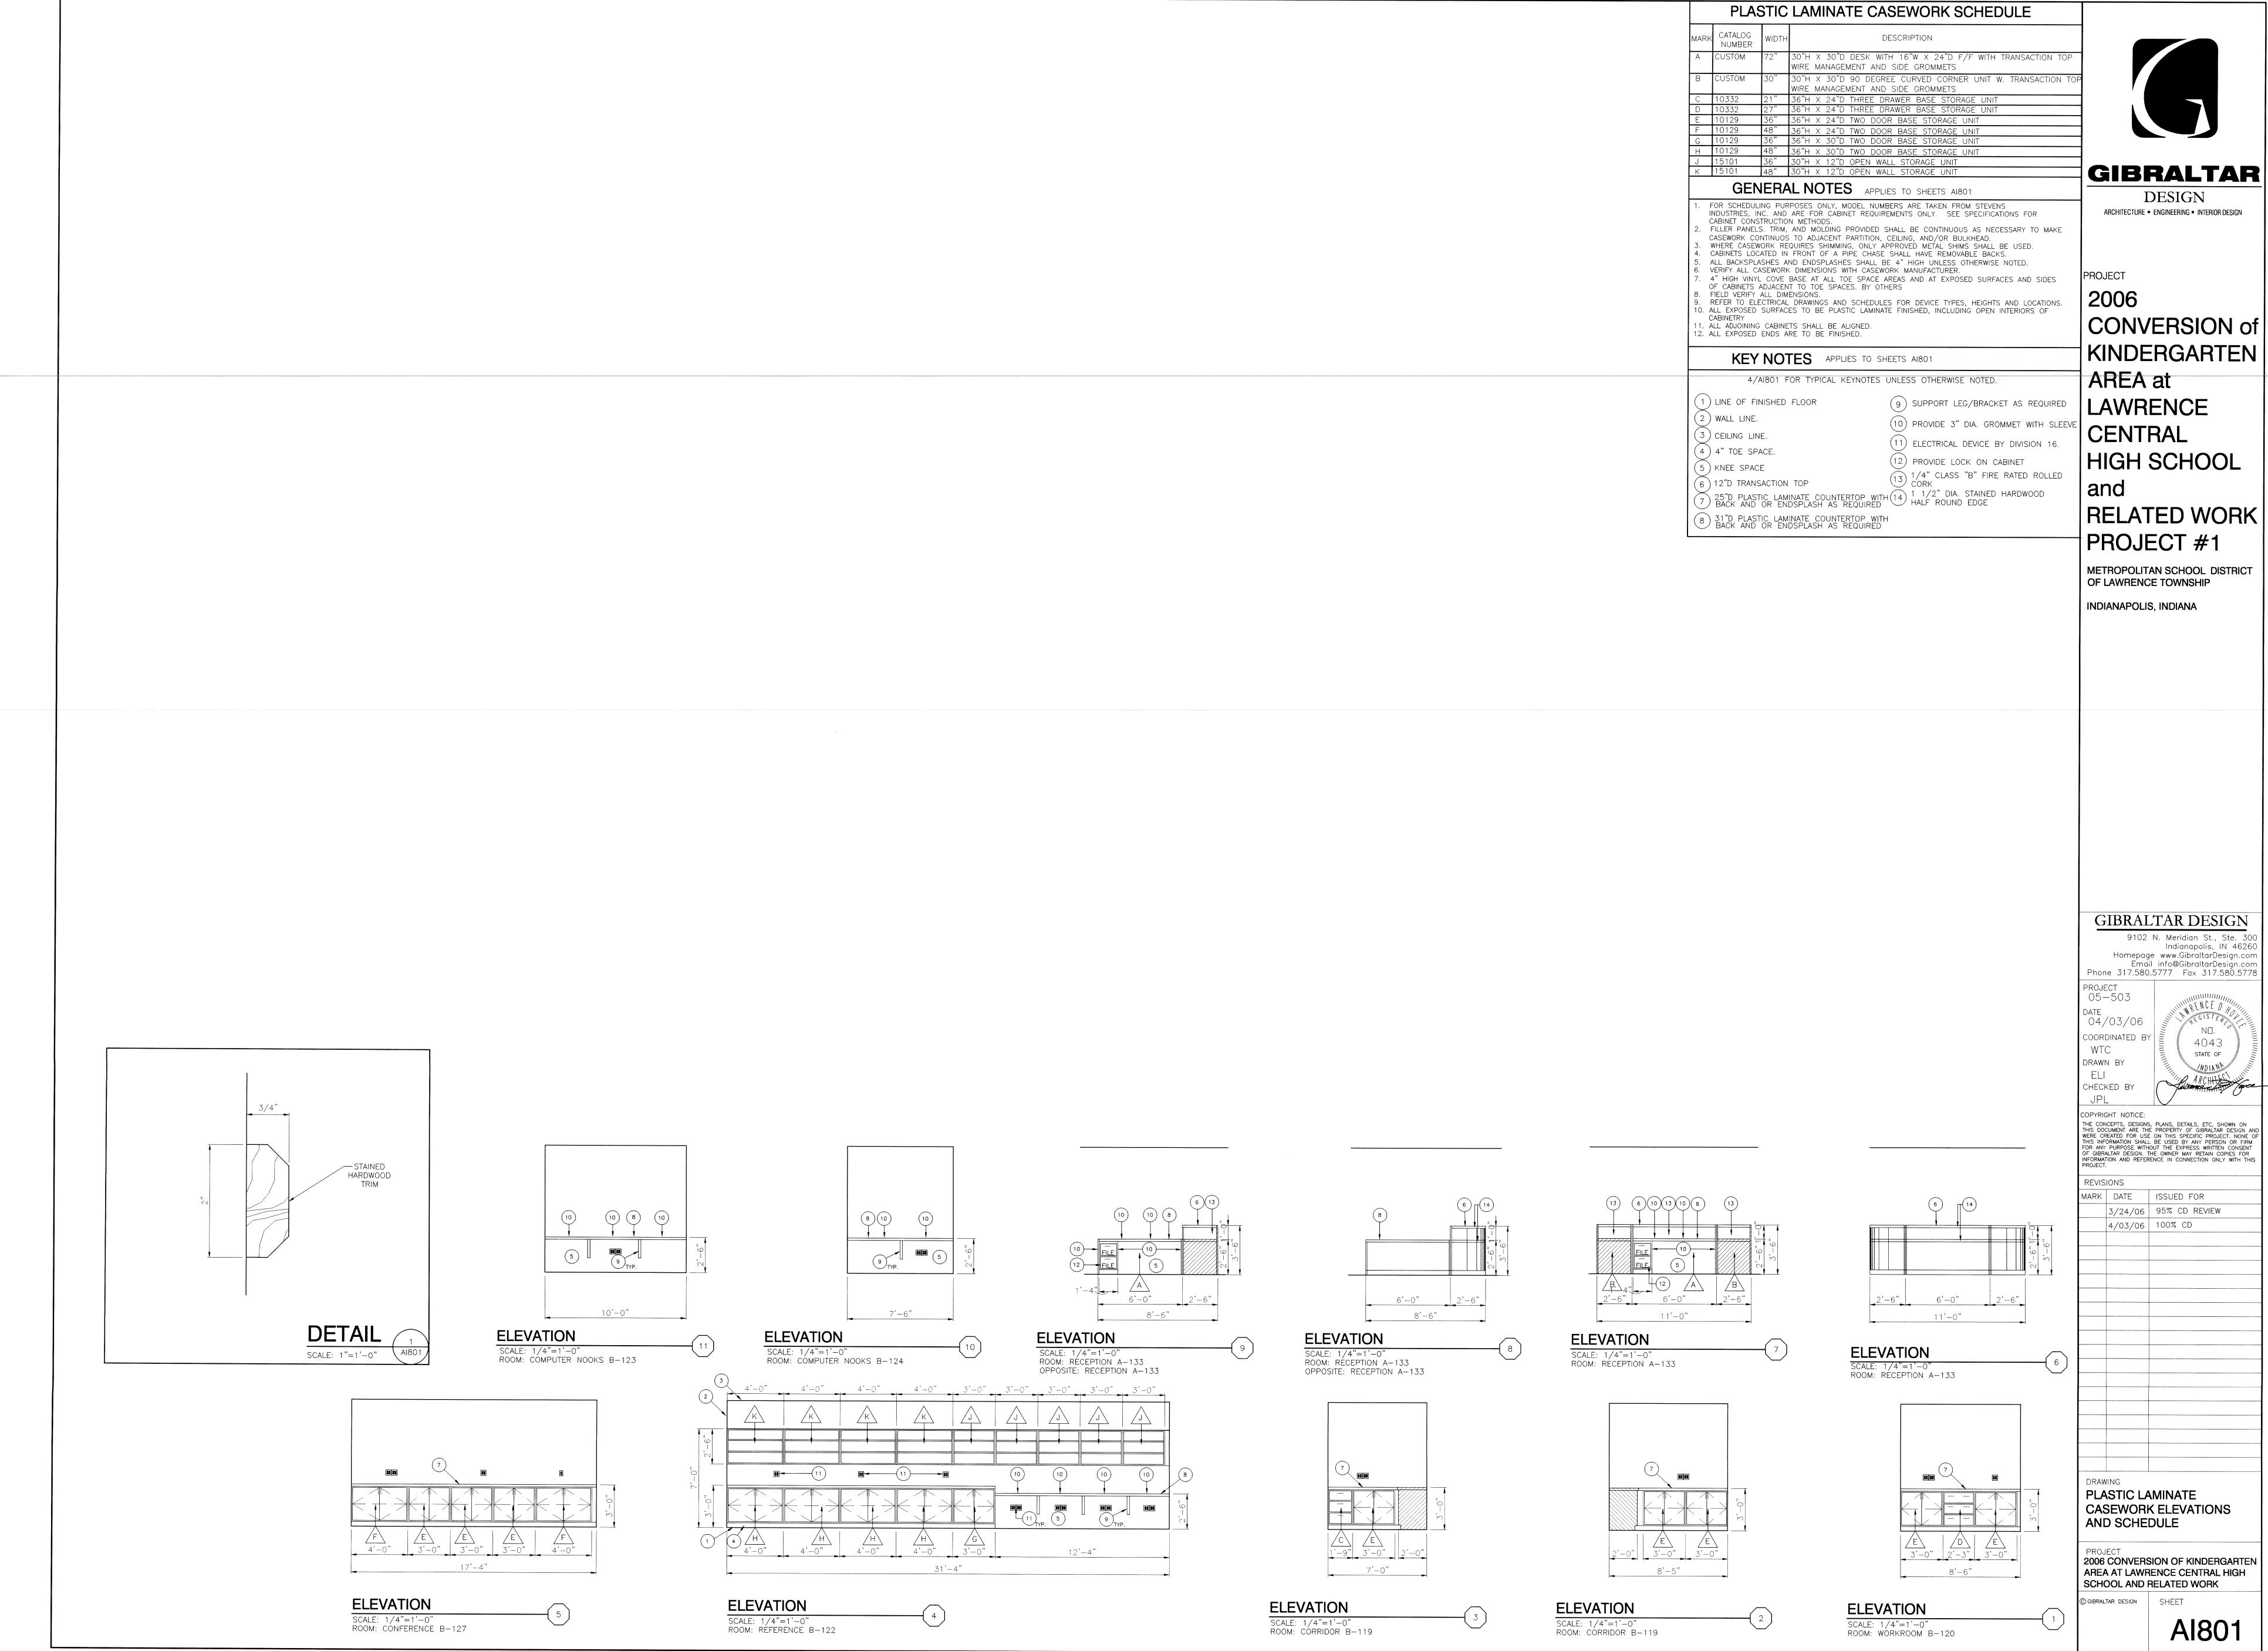

| RELATED WORK |

METROPOLITAN SCHOOL DISTRICT

2006 CONVERSION OF KINDERGARTEN AREA AT LAWRENCE CENTRAL HIGH

- 1. SEE SHEET P-001 FOR PLUMBING LEGEND AND GENERAL NOTES AND SCHEDULES.
- 2. SEE SHEET PD101 THROUGH PD103 FOR DEMOLITION
- 3. SEE SHEET P-501 FOR DETAILS AND ISOMETRICS.

DEMOLITION PLAN NOTES:

- REMOVE EXISTING ELECTRIC WATER COOLER AND STORE FOR REINSTALLATION IN THIS PROJECT. PREPARE SUPPLIES, WASTE AND VENT FOR RECONNECTION.
- 2 REMOVE EXISTING SINK COMPLETE. CAP EXISTING SUPPLIES, VENT AND WASTE BELOW FLOOR.
- REMOVE EXISTING SINK COMPLETE. CAP EXISTING SUPPLIES, AND VENT ABOVE CEILING. CAP WASTE BELOW FLOOR.

GIBRALTA

DESIGN

ARCHITECTURE • ENGINEERING • INTERIOR DESIGN

PROJECT

2006

CON

ROOM NAME SCHEDULE

A-103 WOMEN

A-109 CLASSROOM

A-114 LEARNING CENTER
A-115 ADMINISTRATOR
A-116 CORRIDOR

A-110 FASSAGE
A-119 CORRIODR
A-120 CAREER CLASSROOM

A-121 LEARNING CENTER

A-117 ATRIUM

A-123 TOILET
A-124 TOILET
A-125 STORAGE

A-130 TOILET

A-126 CLASSROOM

A-126 CLASSROOM
A-127 CLASSROOM
A-128 STORAGE
A-129 TOILET

A-131 CLASSROOM
A-132 CUSTODIAN
A-133 ELEVATOR EQUIPMENT


A-134 SCHOOL PSYCHOLOGIST

A-135 STAFF LOUNGE A-136 CORRIDOR

A-118 PASSAGE

CONVERSION of KINDERGARTEN AREA at LAWRENCE CENTRAL HIGH SCHOOL and RELATED WORK PROJECT #1

METROPOLITAN SCHOOL DISTRICT
OF LAWRENCE TOWNSHIP
INDIANAPOLIS, INDIANA

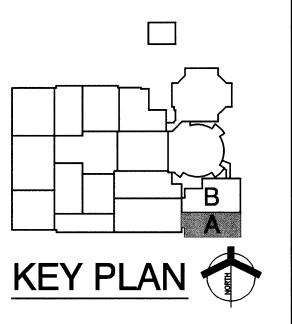

GIBRALTAR DESIGN
9102 N. Meridian St., Ste. 30

Indianapolis, IN 46260
Homepage www.GibraltarDesign.com
Email info@GibraltarDesign.com
Phone 317.580.5777 Fax 317.580.5778

PROJECT
05-503

DATE
04/03/06

COORDINATED BY
MRG

DRAWN BY
WAB

CHECKED B'

COPYRIGHT NOTICE:

THE CONCEPTS, DESIGNS, PLANS, DETAILS, ETC, SHOWN ON THIS DOCUMENT ARE THE PROPERTY OF GIBRALTAR DESIGN AND WERE CREATED FOR USE ON THIS SPECIFIC PROJECT. NONE OF THIS INFORMATION SHALL BE USED BY ANY PERSON OR FIRM FOR ANY PURPOSE WITHOUT THE EXPRESS WRITTEN CONSENT OF GIBRALTAR DESIGN. THE OWNER MAY RETAIN COPIES FOR INFORMATION AND REFERENCE IN CONNECTION ONLY WITH THIS PROJECT.

REVISIONS

MARK DATE ISSUED FOR

3/24/06 95% CD REVIEW

4/03/06 100% CD


4/03/06 100% CD

DRAWING
UNIT "A" PLUMBING
FIRST FLOOR
DEMOLITON PLAN


PROJECT
2006 CONVERSION OF KINDERGARTEN
AREA AT LAWRENCE CENTRAL HIGH
SCHOOL AND RELATED WORK

GIBRALTAR DESIGN SHEET

PD101

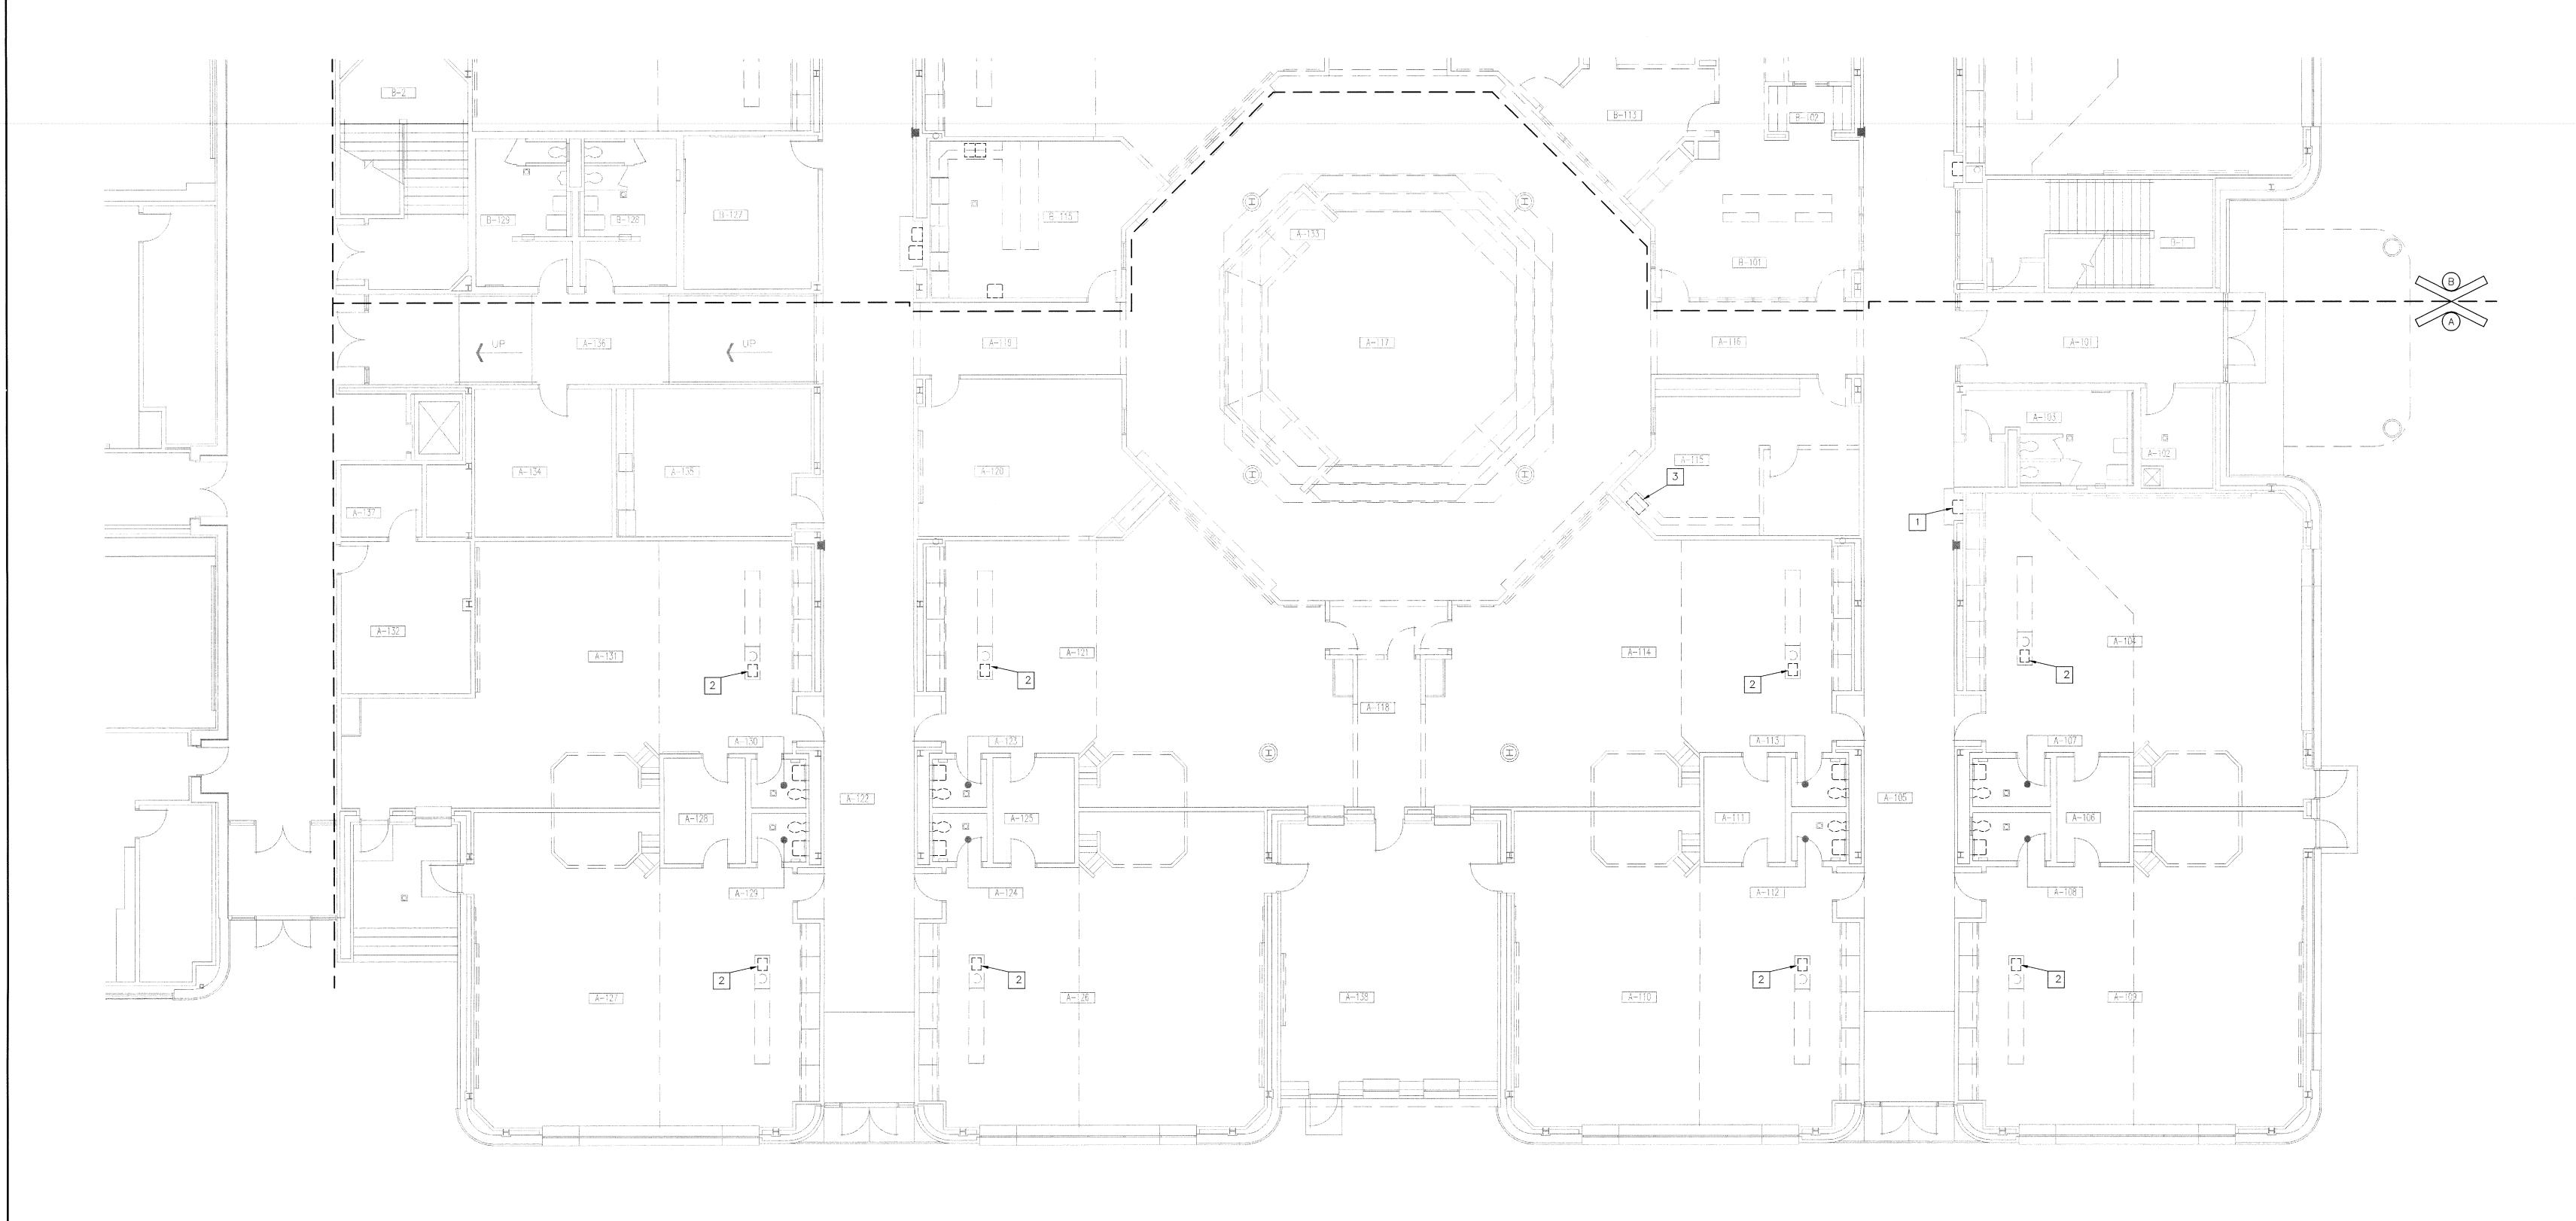

4 **2** − 0 ...

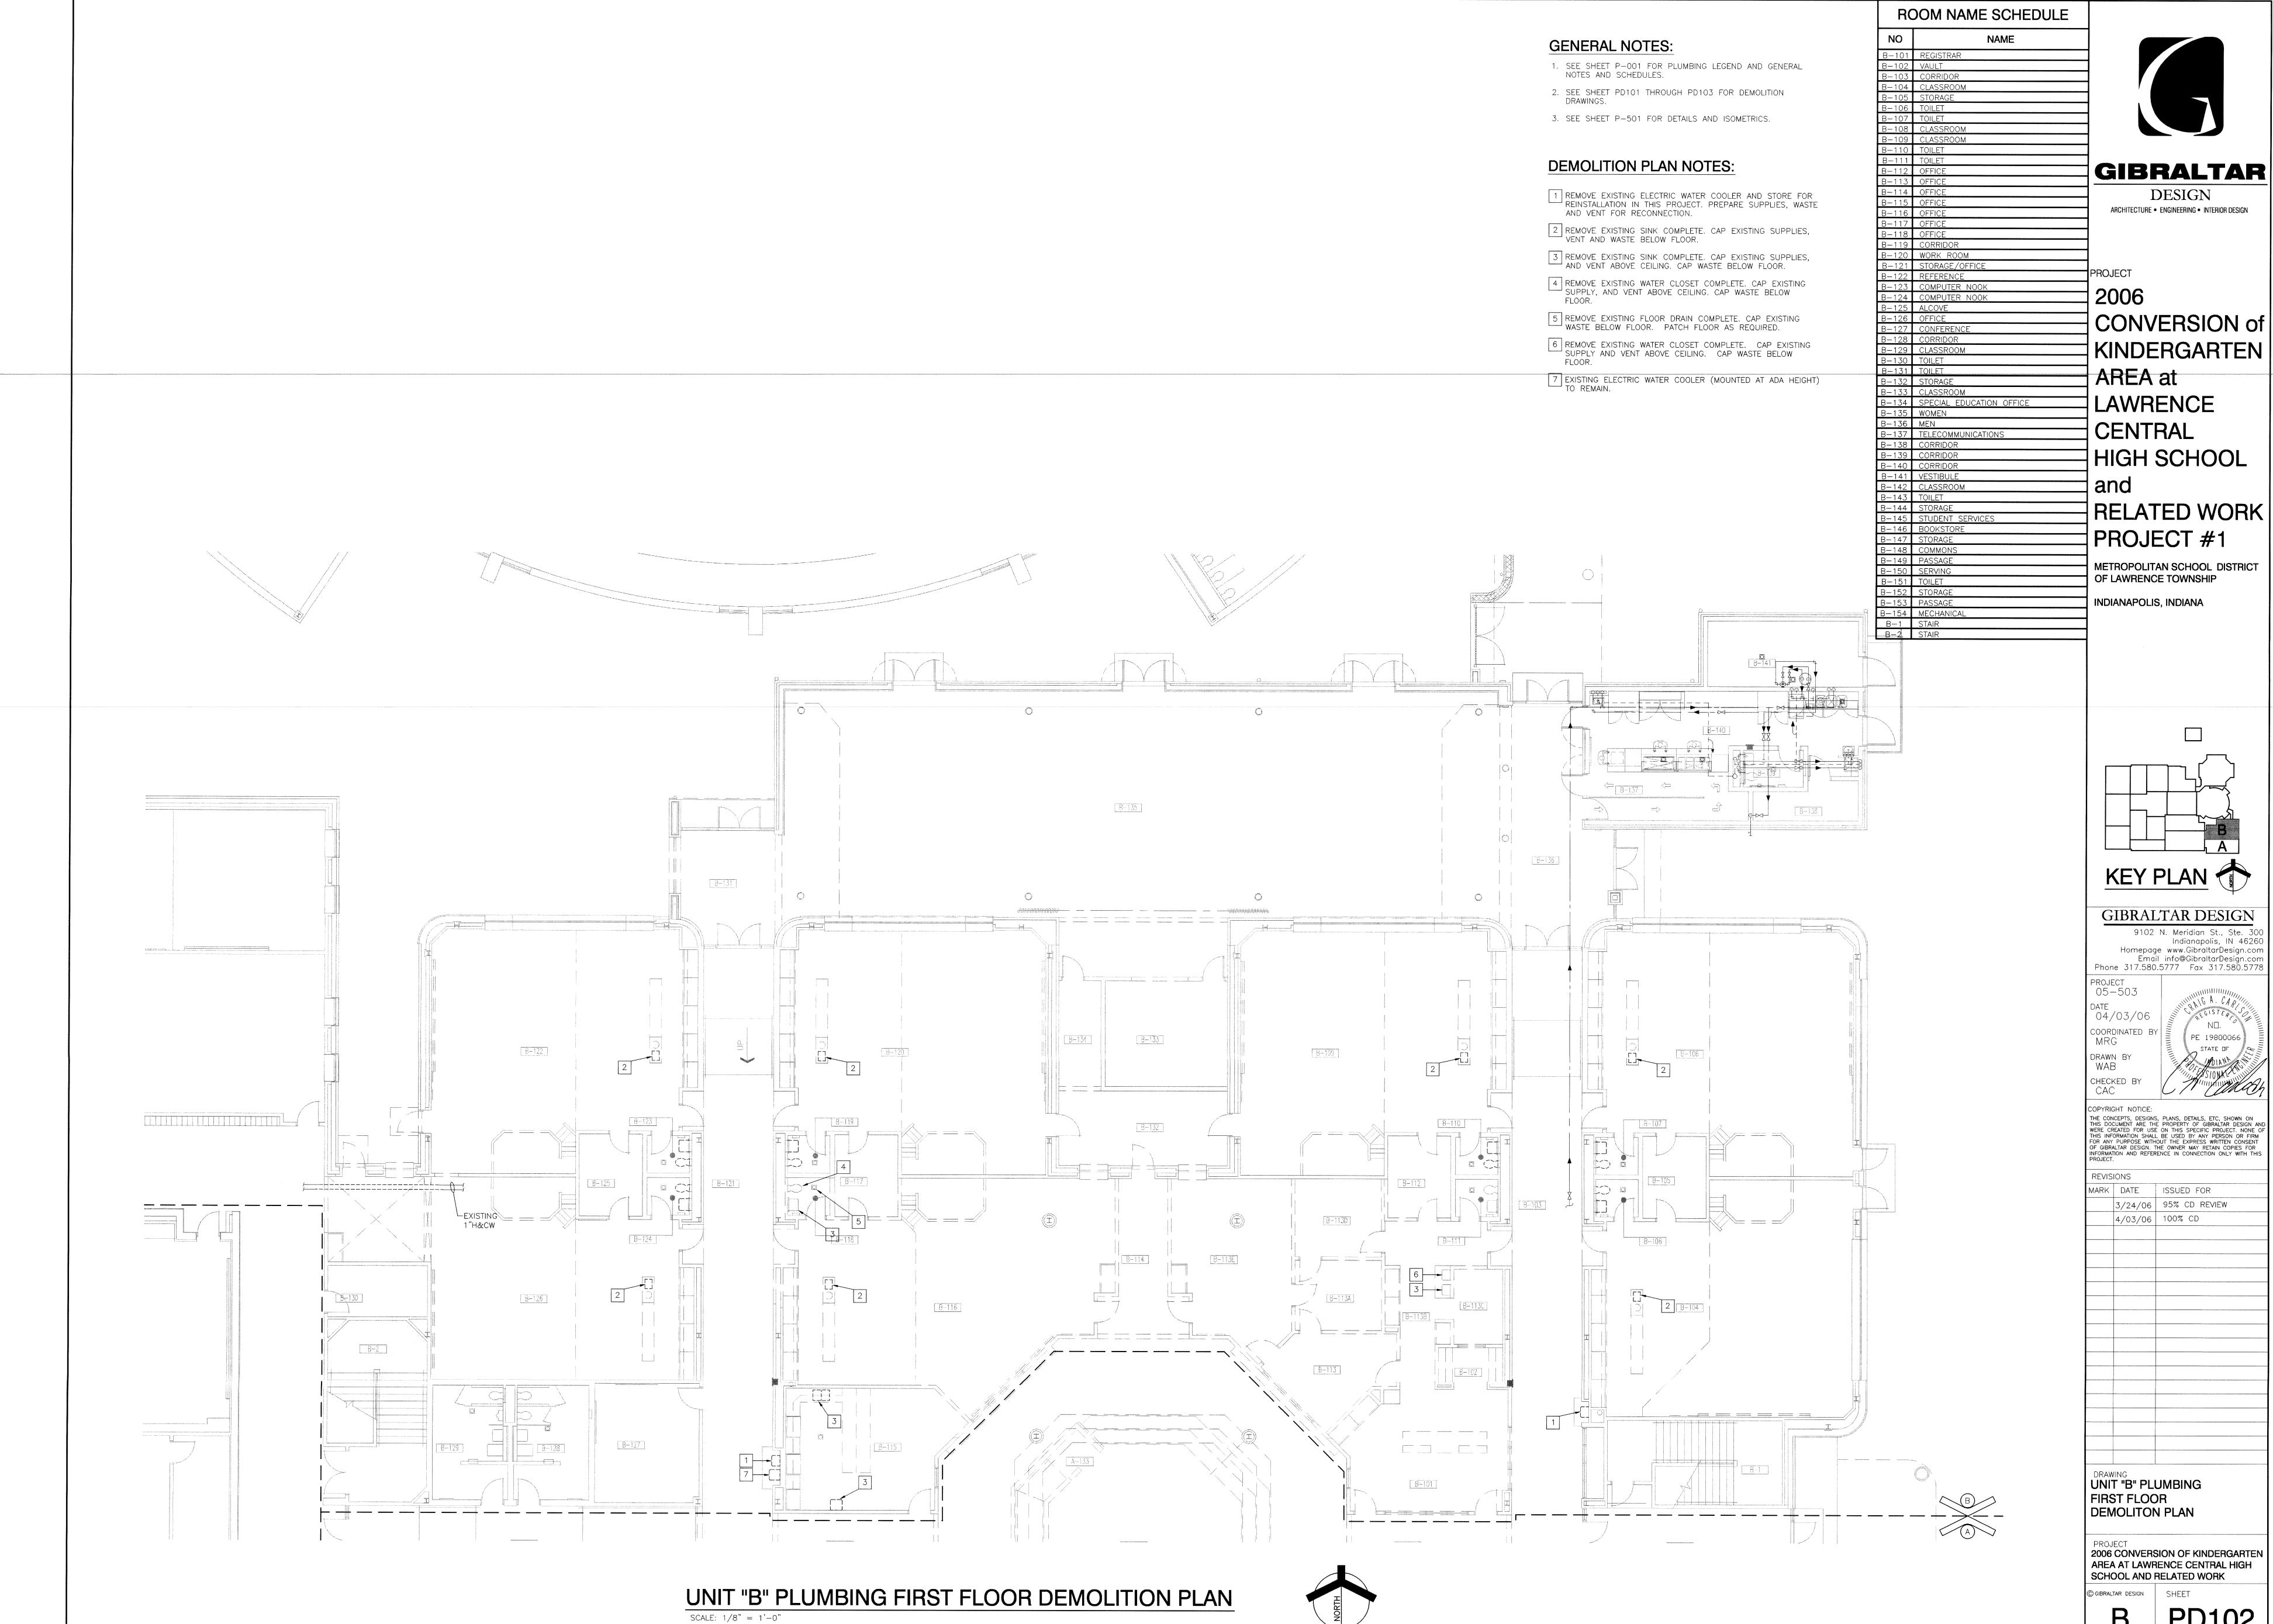

PD102

- SEE SHEET P-001 FOR PLUMBING LEGEND AND GENERAL NOTES AND SCHEDULES.
- SEE SHEET PD101 THROUGH PD113 FOR DEMOLITION DRAWINGS.
- 3. SEE SHEET P-501 FOR DETAILS AND ISOMETRICS.

PLAN NOTES:

1) EXISTING ELECTRIC WATER COOLER MOUNTED AT ADA HEIGHT. EXTEND SUPPLY, WASTE AND VENT AS REQUIRED FOR INSTALLATION.

RC	OOM NAME SCHEDULE	
NO	NAME	
-101	VESTIBULE	
-102	CUSTODIAN	
-103	WOMEN	
-104	CLASSROOM	
-105	CORRIDOR	
-106	STORAGE	
-107	TOILET	
-108	TOILET	
.—109	CLASSROOM	
-110	CLASSROOM	_
<u>-111</u>	STORAGE	
-112	TOILET	GIBRALTAR
-113	TOILET	
-114	LEARNING CENTER	– DESIGN
-115	ADMINISTRATOR	
-116	CORRIDOR	ARCHITECTURE • ENGINEERING • INTERIOR DESIGN
-117	ATRIUM	_
-118	PASSAGE	_
-119	CORRIODR	_
-120	CAREER CLASSROOM	_
-121	LEARNING CENTER	DDO IFOT
100	CODDINAD	ĦPROJECT I

A-125 STORAGE

A-130 TOILET


A-133 ELEVATOR EQUIPMENT
A-134 SCHOOL PSYCHOLOGIST

A-135 STAFF LOUNGE A-136 CORRIDOR

DESIGN ARCHITECTURE • ENGINEERING • INTERIOR DESIGN CONVERSION of KINDERGARTEN **AREA** at

LAWRENCE CENTRAL HIGH SCHOOL and RELATED WORK PROJECT #1

METROPOLITAN SCHOOL DISTRICT OF LAWRENCE TOWNSHIP INDIANAPOLIS, INDIANA

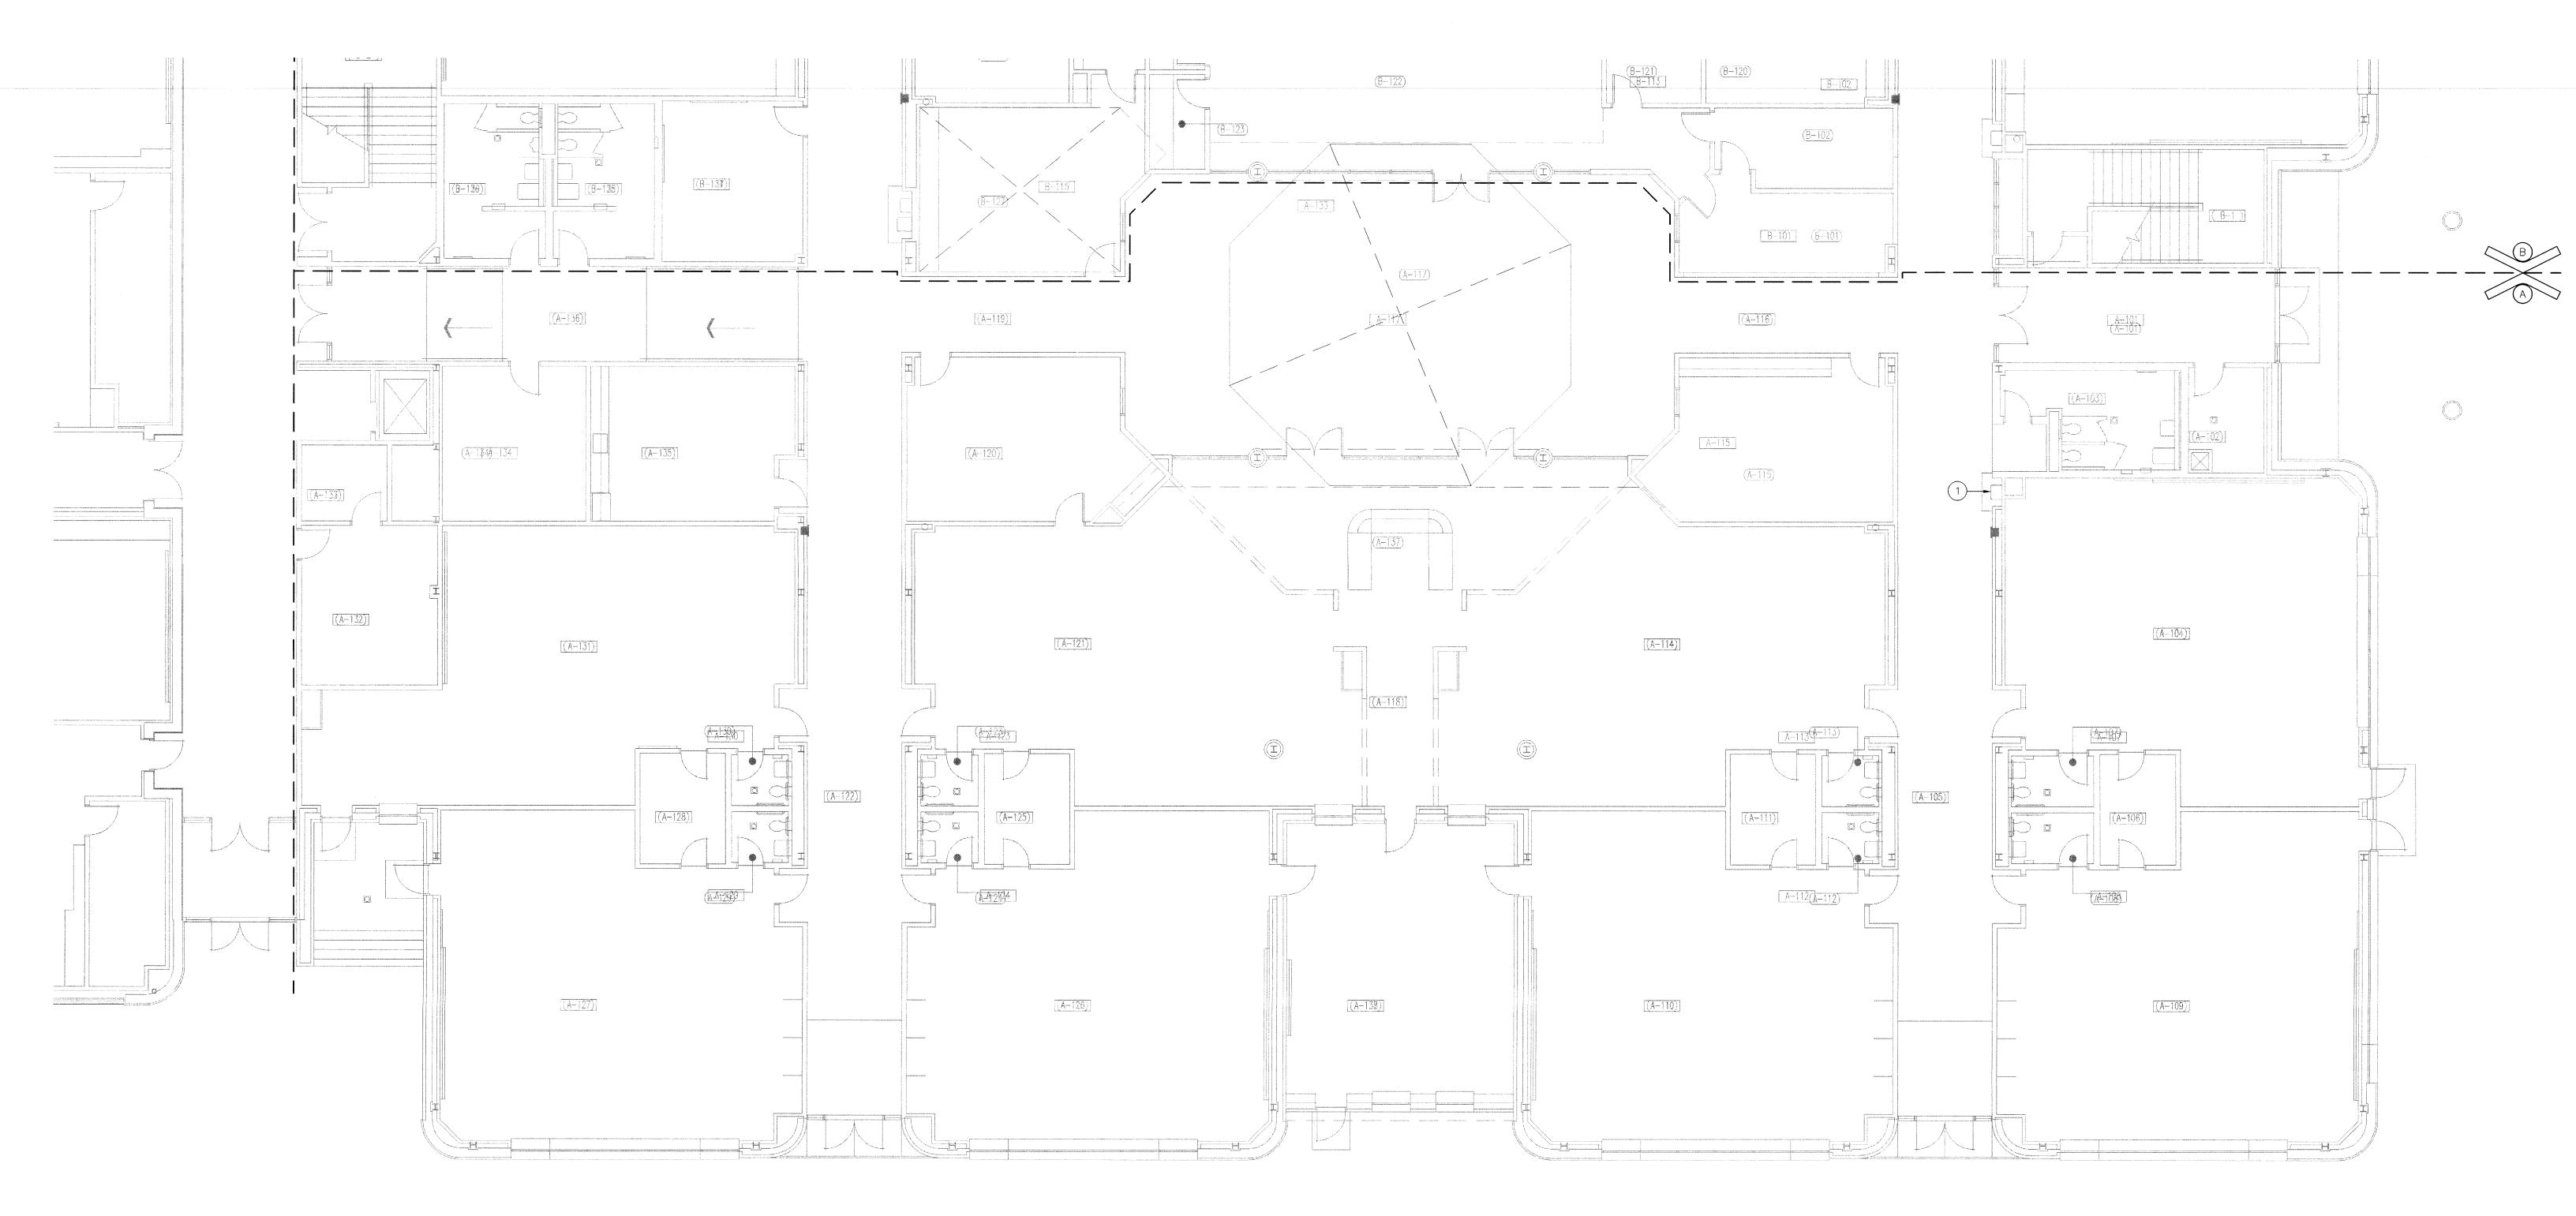

UNIT "A" PLUMBING FIRST FLOOR PLAN SCALE: 1/8" = 1'-0"

CHECKED BY CAC THE CONCEPTS, DESIGNS, PLANS, DETAILS, ETC, SHOWN ON THIS DOCUMENT ARE THE PROPERTY OF GIBRALTAR DESIGN AND WERE CREATED FOR USE ON THIS SPECIFIC PROJECT. NONE OF THIS INFORMATION SHALL BE USED BY ANY PERSON OR FIRM FOR ANY PURPOSE WITHOUT THE EXPRESS WRITTEN CONSENT OF GIBRALTAR DESIGN. THE OWNER MAY RETAIN COPIES FOR INFORMATION AND REFERENCE IN CONNECTION ONLY WITH THIS PROJECT. REVISIONS MARK DATE ISSUED FOR 3/24/06 95% CD REVIEW

KEY PLAN

GIBRALTAR DESIGN

Indianapolis, IN 46260
Homepage www.GibraltarDesign.com
Email info@GibraltarDesign.com
Phone 317.580.5777 Fax 317.580.5778

PROJECT 05-503

04/03/06

COORDINATED BY

DRAWN BY WAB

9102 N. Meridian St., Ste. 30

PE 19800066


4/03/06 100% CD

DRAWING UNIT "A" PLUMBING FIRST FLOOR PLAN

PROJECT
2006 CONVERSION OF KINDERGARTEN AREA AT LAWRENCE CENTRAL HIGH SCHOOL AND RELATED WORK

GIBRALTAR DESIGN SHEET Α

P-101

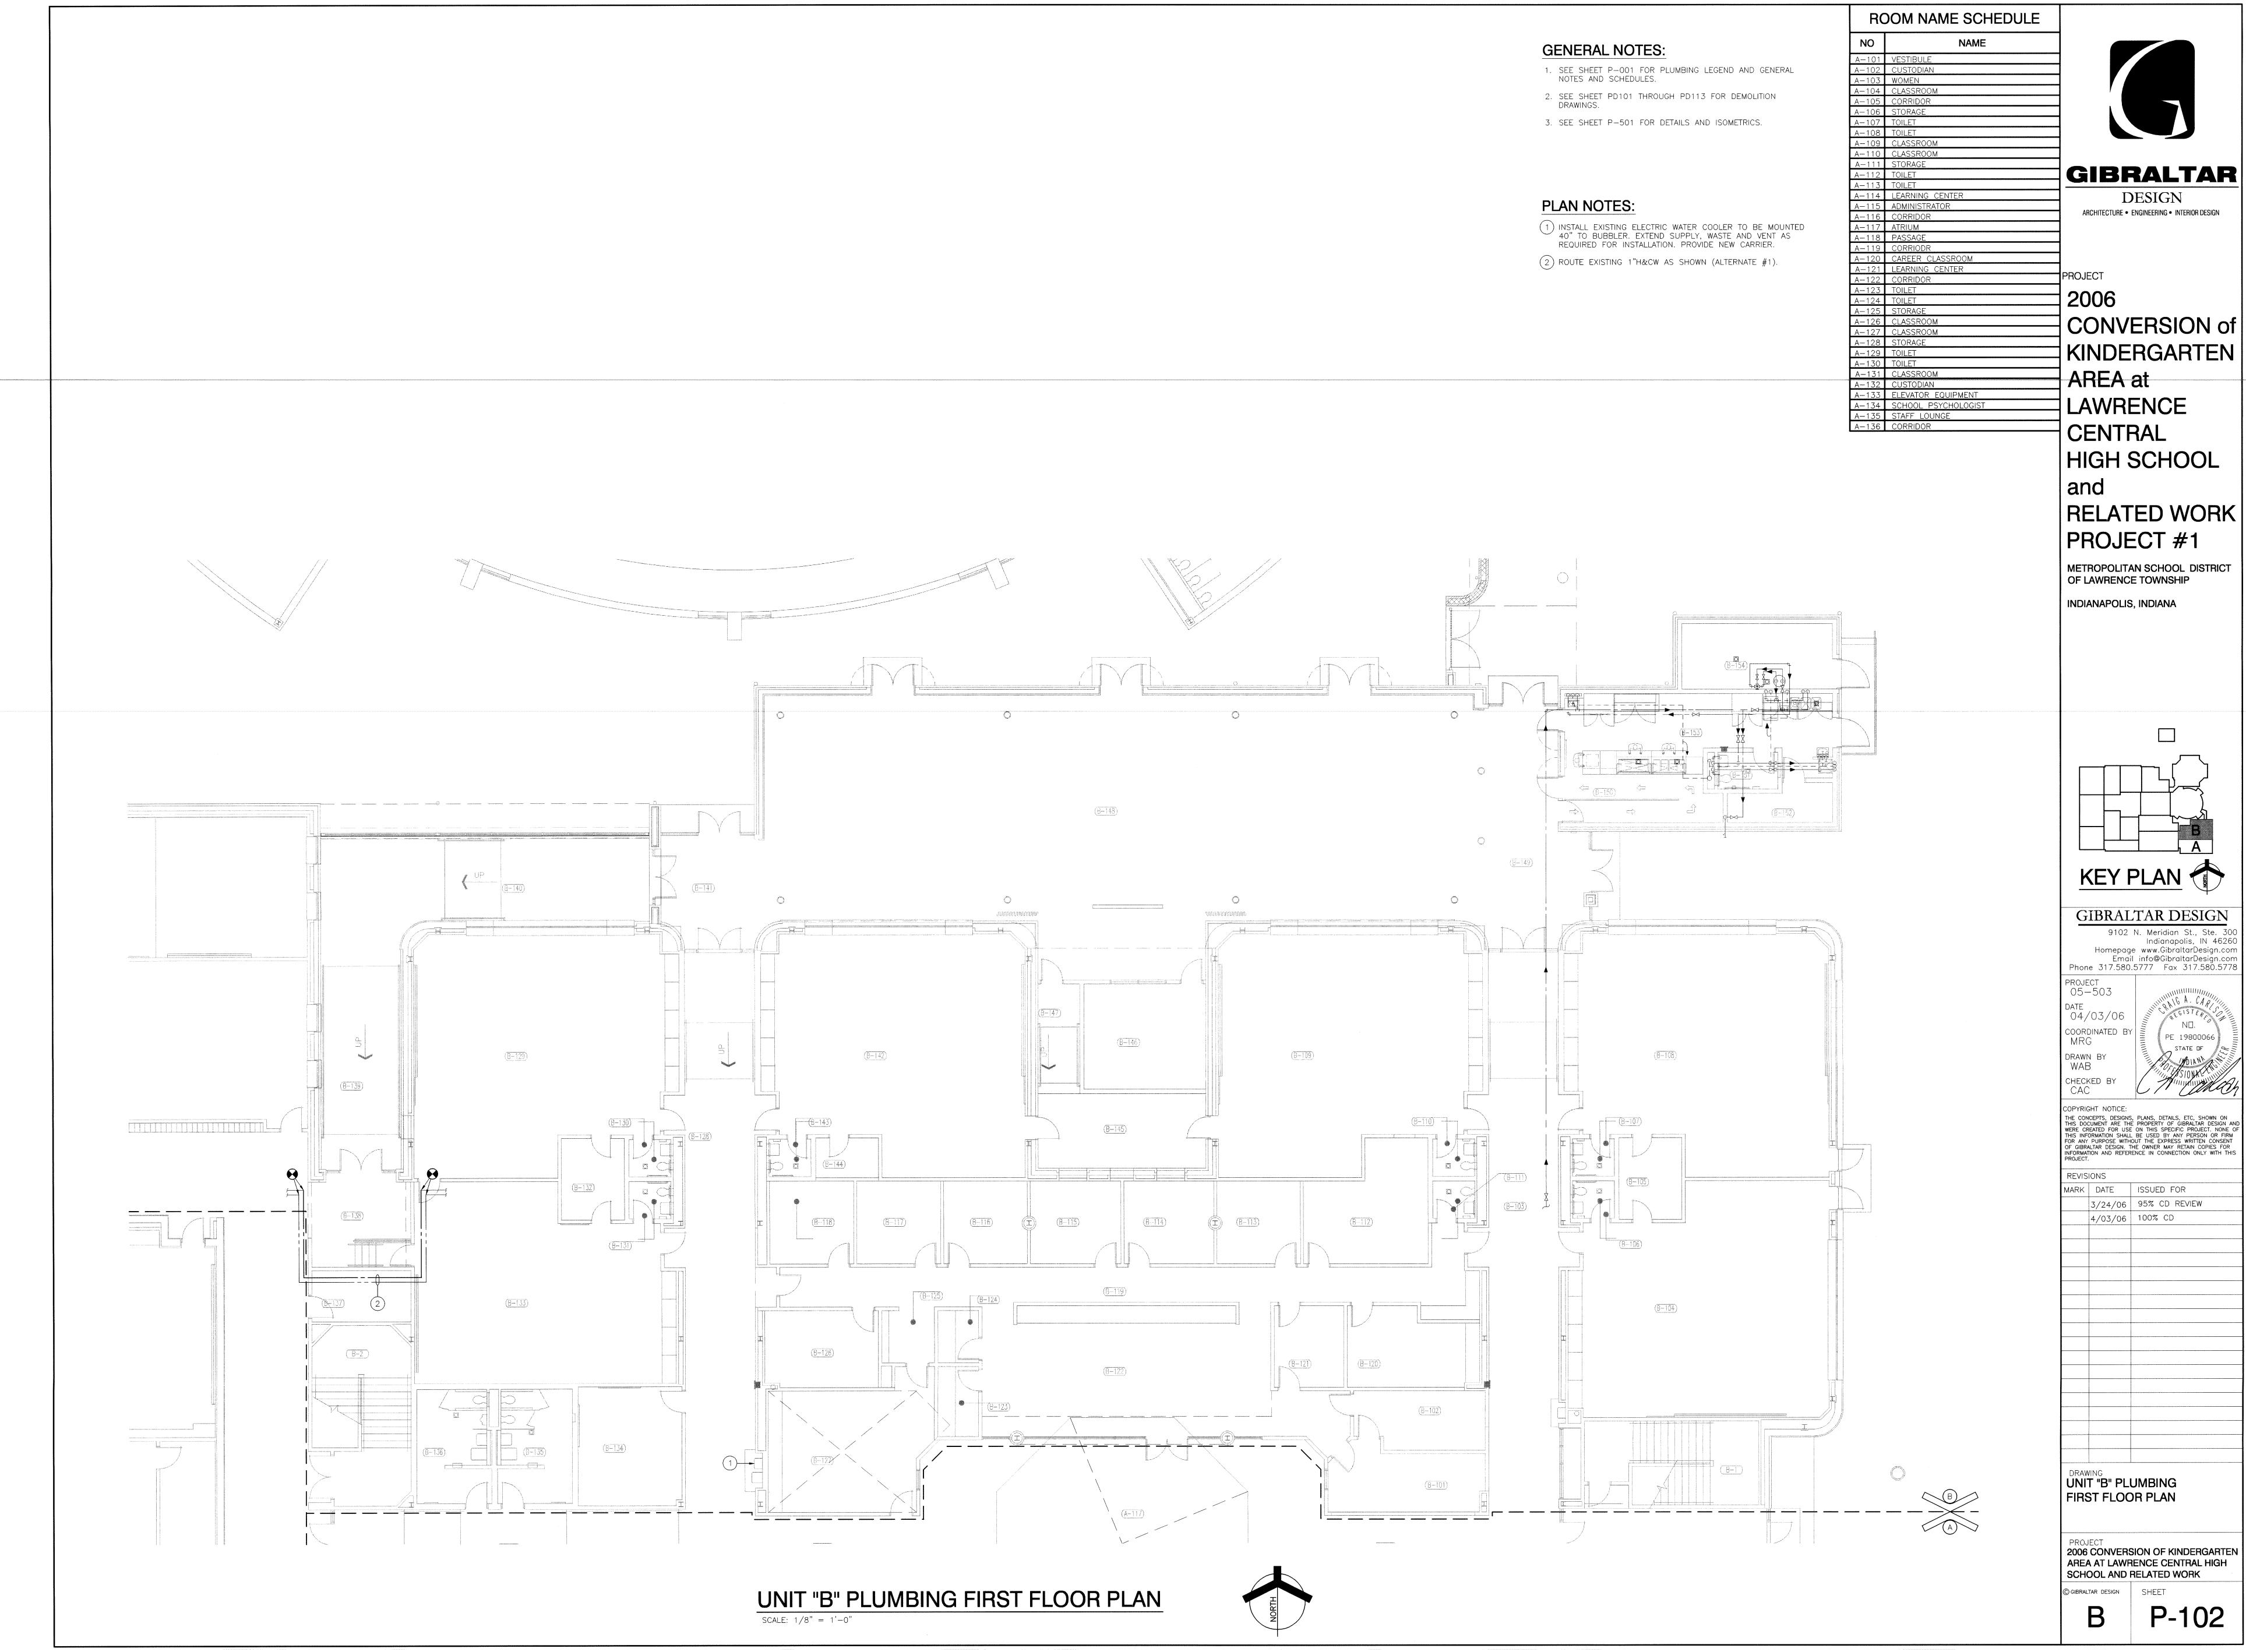


GENERAL NOTES:

- 1. CONTRACTOR SHALL BE RESPONSIBLE FOR DESIGN AND LAYOUT IN ACCORDANCE WITH NFPA 13, STATE, LOCAL FIRE DEPARTMENT, OWNER'S INSURER, AND AS OUTLINED ON THE PLANS AND IN THE SPECIFICATIONS.
- THE SPRINKLER SYSTEM SHALL BE HYDRAULICALLY DESIGNED.
 SPRINKLER CONTRACTOR SHALL OBTAIN FLOW TEST FROM OWNER TO BASE HYDRAULIC DESIGN ON. REFER TO
- SPECIFICATION SECTION 15310.

 4. CONSULT DRAWINGS OF OTHER CONTRACTORS AND COORDINATE SPRINKLER HEADS, PIPING, EQUIPMENT, ETC. WITH LIGHTING, ELECTRICAL, HVAC ITEMS, STRUCTURAL, AND OTHER BUILDING MEMBERS.
- 5. PIPING SHALL BE INSPECTED AND TESTED IN ACCORDANCE WITH NFPA.
- 6. PIPING SHALL BE RUN TO CONSERVE BUILDING SPACE AND SHALL BE CONCEALED IN FINISHED AREAS. PIPING SHOWN IS OFFERED AS A GUIDE ONLY FOR BIDDING PURPOSES.

PLAN NOTES:

- 1 MODIFY EXISTING SPRINKLER LOCATIONS AS REQUIRED IN REMODELED AREAS. VERIFY HEAD LOCATIONS IN FIELD PRIOR TO BIDDING.
- 2) PROVIDE NEW SPRINKLER PIPING AND HEADS AS REQUIRED TO OBTAIN ADEQUATE COVERAGE WITH PENDANT TYPE SPRINKLER HEADS IN CORRIDOR. (ALTERNATE #1)
- 3) ROUTE EXISTING 4" SPRINKLER MAIN PIPING AS REQUIRED. (ALTERNATE #1) VERIFY EXISTING SIZE AND LOCATION.
- 4 REMOVE EXISTING SPRINKLER PIPING AND HEADS BELOW EXISTING KINDERGARTEN LOFT TO BE DEMOLISHED. CAP BRANCH AT MAIN. PATCH WALL AS REQUIRED.

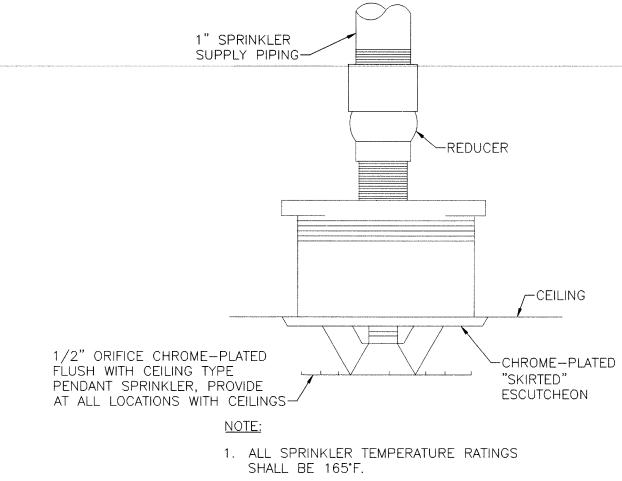

SPRINKLER HEAD DETAIL



GIBRALTAR DESIGN
9102 N. Meridian St., Ste. 300

GIBRALTAR

DESIGN

ARCHITECTURE • ENGINEERING • INTERIOR DESIGN

CONVERSION of

KINDERGARTEN

AREA at

CENTRAL

and

LAWRENCE

HIGH SCHOOL

RELATED WORK

METROPOLITAN SCHOOL DISTRICT

PROJECT #1

OF LAWRENCE TOWNSHIP

INDIANAPOLIS, INDIANA

PROJECT

9102 N. Meridian St., Ste. 300
Indianapolis, IN 46260
Homepage www.GibraltarDesign.com
Email info@GibraltarDesign.com
Phone 317.580.5777 Fax 317.580.5778

PROJECT
05-503
DATE

DRAWN BY
WAB
CHECKED BY
CAC

COPYRIGHT NOTICE:

THE CONCEPTS, DESIGNS, PLANS, DETAILS, ETC, SHOWN ON THIS DOCUMENT ARE THE PROPERTY OF GIBRALTAR DESIGN AND WERE CREATED FOR USE ON THIS SPECIFIC PROJECT. NONE OF THIS INFORMATION SHALL BE USED BY ANY PERSON OR FIRM FOR ANY PURPOSE WITHOUT THE EXPRESS WRITTEN CONSENT OF GIBRALTAR DESIGN. THE OWNER MAY RETAIN COPIES FOR INFORMATION AND REFERENCE IN CONNECTION ONLY WITH THIS PROJECT.

REVISIONS MARK DATE


MARK DATE ISSUED FOR 3/24/06 95% CD REVIEW 4/03/06 100% CD

DRAWING
UNITS "A" & "B"
FIRE PROTECTION PLAN

PROJECT
2006 CONVERSION OF KINDERGARTEN
AREA AT LAWRENCE CENTRAL HIGH

SCHOOL AND RELATED WORK
© GIBRALTAR DESIGN SHEET

A&B FP10

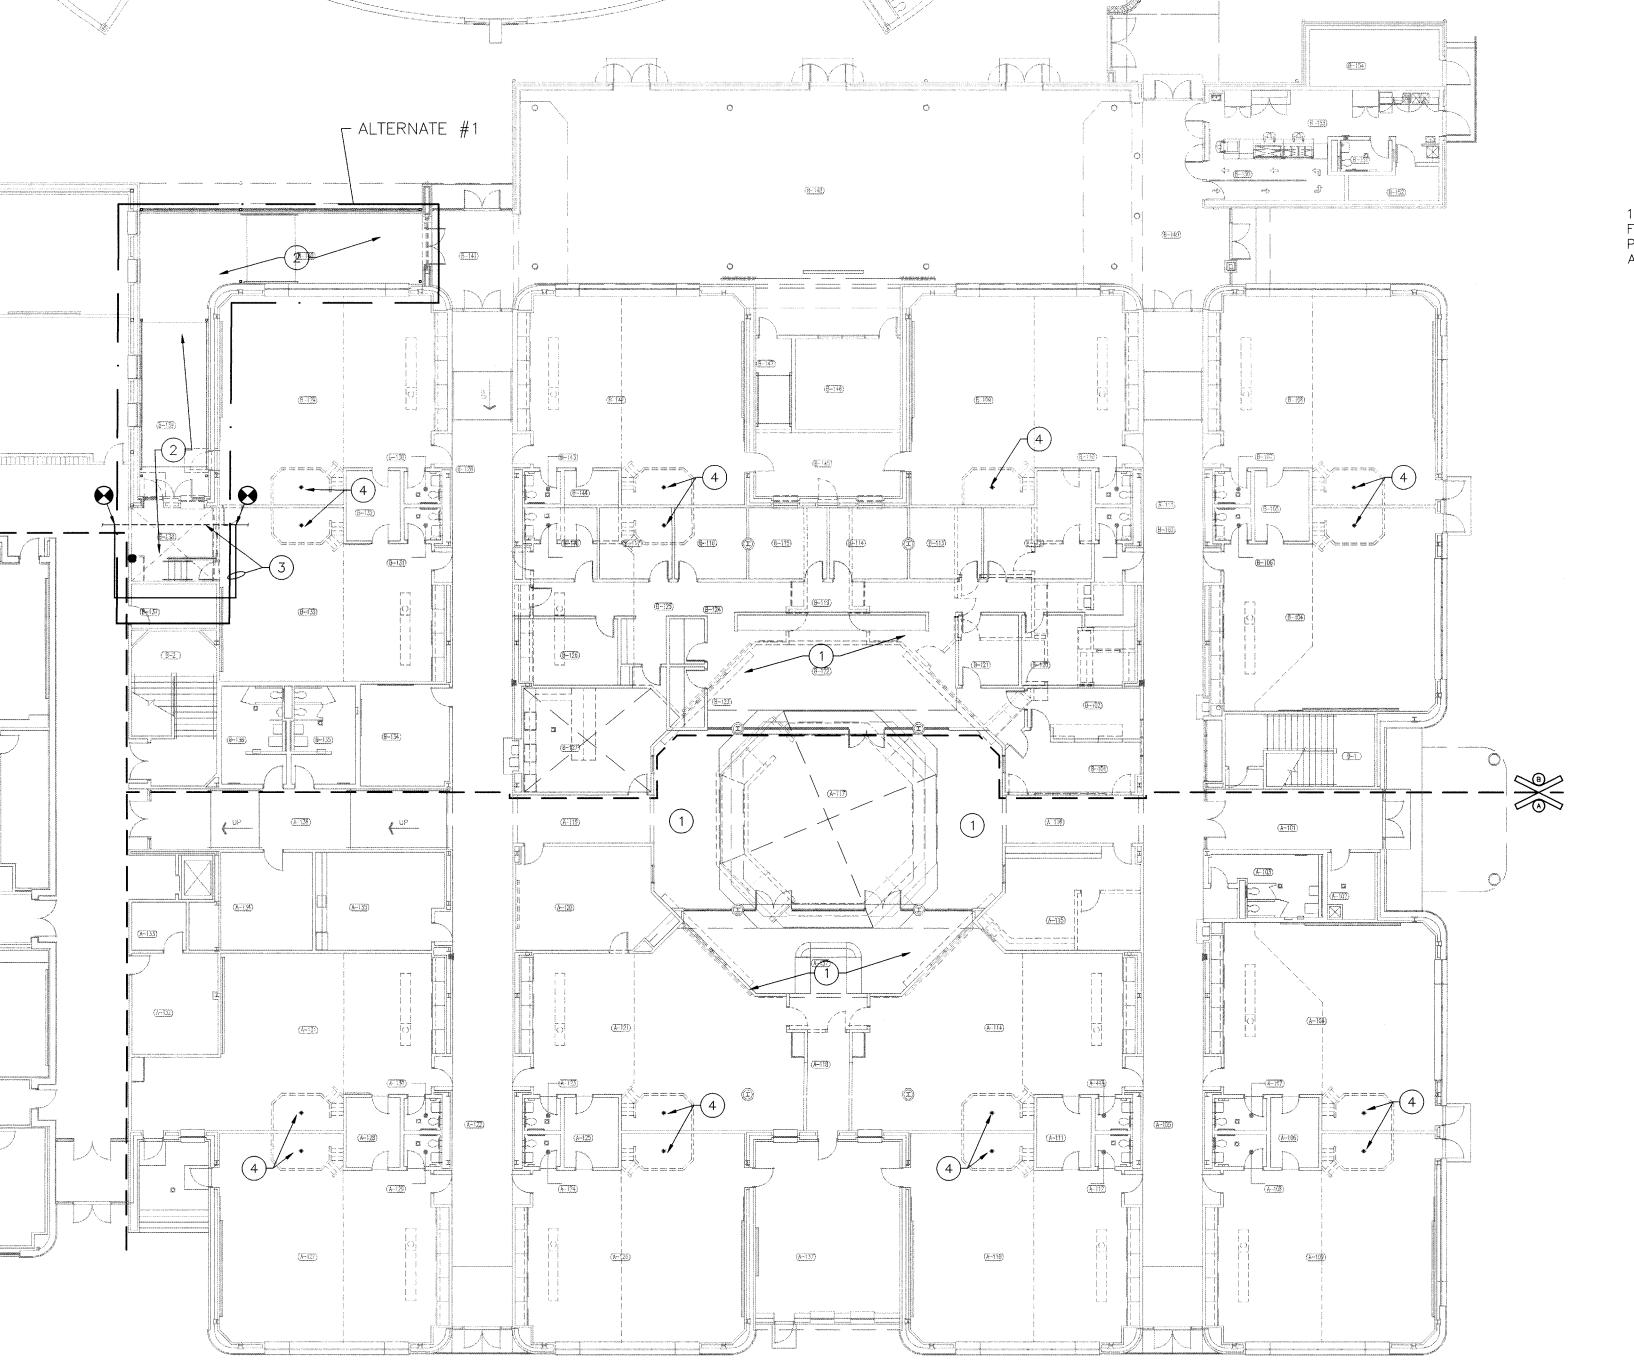

	CAL LEGEN	
NAME	SYMBOL	ABBREVIATION
HEATING SYSTEM WATER BETURN		S
HEATING SYSTEM WATER RETURN CHILLED WATER SUPPLY		R CH
CHILLED WATER SUPPLY CHILLED WATER RETURN	CHR-	CH
CONDENSATE DRAIN	D	D
CONDENSER WATER SUPPLY		СО
CONDENSER WATER RETURN	COR	COR
HIGH PRESSURE STEAM SUPPLY	\\\\\\\\\\\\\\\\\\\\\\\\\\\\\\\\\\\\\	HS
HIGH PRESSURE CONDENSATE RETURN		LS
LOW PRESSURE STEAM SUPPLY LOW PRESSURE CONDENSATE RETURN		CR
CONDENSATE PUMP DISCHARGE	PD	LR PD
RELIEF VENT	V	V
REFRIGERANT LIQUID PIPING	—————————————————————————————————————	RL
REFRIGERANT GAS SUCTION PIPING		RS
REFRIGERANT GAS DISCHARGE PIPING	—————————————————————————————————————	RG
FLOW IN DIRECTION OF ARROW	-	
PITCH DOWN IN DIRECTION OF ARROW		
SHUT-OFF VALVE		
TRIPLE DUTY VALVE		
CHECK VALVE		
TEMPERATURE REGULATING VALVE		
BALANCING VALVE PRESSURE RELIEF VALVE	<u> </u>	
PRESSURE REGULATING VALVE		
UNION		
PIPE ANCHOR	\	
PIPE GUIDE		
PIPING DROP WITH RESPECT TO FLOW		
PIPING RISE WITH RESPECT TO FLOW		
PIPE TEE OUT OF TOP	———	
PIPE TEE OUT OF BOTTOM		
PRESSURE GAUGE	9	
THERMOMETER		
STRAINER		
AUTOMATIC AIR VENT	<u> </u>	
SILL COCK	→ → → <u>SC</u>	SC
HOSE BIBB THERMOSTAT		HB
THERMOSTAT FLEXIBLE DUCT		C=CONCEALED, G=GUARD, N=NI
(SINGLE LINE) SUPPLY SHEET METAL DUCT		
(SINGLE LINE) SUPPLY SHEET METAL DUCT		
(SINGLE LINE) EXHAUST DUCT		
(SINGLE LINE) DUCT TRANSITION—SYMMETRIC REDUCTION		
(SINGLE LINE) DUCT DROP WITH RESPECT TO FLOW		
(SINGLE LINE) DUCT RISE WITH RESPECT TO FLOW		
DUCT SIZE (1ST FIGURE=WIDTH, 2ND FIGURE=DEPTH)	12X10 OR 12X10	
ROUND DUCT SIZE	12"ø OR 12"ø	
DUCT DROP WITH RESPECT TO FLOW	† D - 1 - 7	
DUCT RISE WITH RESPECT TO FLOW	→ R → R	
DUCT SIZE (1ST FIGURE=WIDTH, 2ND FIGURE=DEPTH)	12X10	
ROUND DUCT SIZE	12"ø	
FLAT-OVAL DUCT SIZE	24X12+	
SUPPLY DUCT SECTION		
EXHAUST OR RETURN AIR DUCT SECTION SUPPLY RISER		
EXHAUST RISER		
RELIEF OR RETURN DECK OPENING		
MANUAL VOLUME DAMPER		VD
FIRE DAMPER		FD
BACKDRAFT DAMPER		BDD
MOTORIZED DAMPER		MD
SMOKE DAMPER		SD
COMBINATION FIRE/SMOKE DAMPER		FSD
SMOKE DETECTOR	\$	
EXHAUST GRILLE OR REGISTER		ER,EG
RELIEF GRILLE		RG
RETURN AIR REGISTER OR GRILLE		RAR,RAG
SUPPLY AIR REGISTER OR GRILLE		SAR,SAG
CEILING DIFFUSER, TYPE & CFM LINEAR DIFFUSER, TYPE & CFM		CD-A-
EXHAUST FAN & SCHEDULE DESIGNATION		EF-
ROOF EXHAUST FAN	$\overline{}$	<u>LI</u>
UNIT VENTILATOR & SCHEDULE DESIGNATION		UV-
CABINET HEATER & SCHEDULE DESIGNATION		CH-
CONVECTOR & SCHEDULE DESIGNATION	VIII.	CV-
UNIT HEATER & SCHEDULE DESIGNATION		UH-
AIR HANDLING UNIT & SCHEDULE DESIGNATION		AHU-
AIR COOLED CONDENSING UNIT & SCHEDULE DESIGNATION		ACCU-
FAN COIL UNIT & SCHEDULE DESIGNATION		FCU-
CIRCULATING PUMP & SCHEDULE DESIGNATION		CP-
FIN TUBE RADIATION, TYPE & LENGTH		FT
VARIABLE AIR VOLUME BOX & SCHEDULE DESIGNATION		VAV-
FAN POWERED VAV BOX & SCHEDULE DESIGNATION AIR FLOW MEASUREMENT STATION	[ALIC]	FPB-
WATER FLOW CONTROL REGULATOR	AMS	
PRESSURE/TEMPERATURE TEST PORT		P/T
VARIABLE FREQUENCY DRIVE	VFD	1/1
SPACE PRESSURE SENSOR	(S)	
PRESSURE TRANSMITTER	<u> </u>	
HUMIDITY SENSOR	H	
CO2 SENSOR	<u> </u>	
VENTILATING CONTRACTOR		VC
MECHANICAL CONTRACTOR		MC
WEST WAS A CONTINUE OF A		EC
ELECTRICAL CONTRACTOR		TCC
		IN.
ELECTRICAL CONTRACTOR TEMPERATURE CONTROL CONTRACTOR INVERT		
ELECTRICAL CONTRACTOR TEMPERATURE CONTROL CONTRACTOR INVERT NORTH, SOUTH, EAST, WEST		N., S., E., W.
ELECTRICAL CONTRACTOR TEMPERATURE CONTROL CONTRACTOR INVERT NORTH, SOUTH, EAST, WEST ELEVATION		
ELECTRICAL CONTRACTOR TEMPERATURE CONTROL CONTRACTOR INVERT NORTH, SOUTH, EAST, WEST	•	N., S., E., W.

GENERAL MECHANICAL NOTES (APPLY TO ALL MECHANICAL SHEETS)

- MECHANICAL CONTRACTOR IS RESPONSIBLE FOR ALL NEW WORK SHOWN ON THESE SHEETS UNLESS OTHERWISE NOTED.
- 2. ALL BULKHEADS, CANOPIES AND ROOF OVERHANGS SHOWN WITH THIN DOTTED/DASHED LINES AND IS NOT OTHERWISE NOTED, INDICATE LOCATION
- 3. REFER TO ARCHITECTURAL, STRUCTURAL AND ELECTRICAL SHEETS AND COORDINATE ALL WORK.

PROVIDED BY OTHER CONTRACTORS.

- 4. REFER TO ARCHITECTURAL REFLECTED CEILING PLANS FOR LOCATION OF CEILING DIFFUSERS, RETURN GRILLES, EXHAUST GRILLES, ETC. WITH RESPECT TO CEILING TYPE, CEILING GRID AND LIGHTING FIXTURES.
- 5. ALL PIPING IN PIPE SPACES SHALL BE PLACED AS CLOSE TO WALLS AS POSSIBLE TO ALLOW MAXIMUM ACCESS.
- 6. ALL DUCTWORK AND PIPING ABOVE CEILING SHALL BE PLACED TO AVOID LIGHTING FIXTURES, JOISTS, BEAMS, ETC.
- 7. PROVIDE CEILING ACCESS PANELS FOR ACCESS TO VOLUME DAMPERS, FIRE AND SMOKE DAMPERS, SHUT-OFF VALVES, CONTROL VALVES, DRAIN VALVES, EQUIPMENT, ETC. LOCATED ABOVE NON-ACCESSIBLE CEILINGS. COORDINATE ALL ACCESS PANELS WITH THE ARCHITECT.
- 8. CONTRACTOR SHALL CORE DRILL HOLES THROUGH FLOORS, WALLS, DECKS, ETC. WHERE PASSAGE IS NOT AVAILABLE TO INSTALL NEW PIPING. PROVIDE PIPE SLEEVES AND PROPERLY SEAL ALL PIPE PENETRATIONS AS REQUIRED. REFER TO SPECIFICATIONS.
- 9. ALL HEATING AND CHILLED WATER. BRANCH PIPING SHOWN WITHOUT SIZE INDICATED, SHALL BE A MINIMUM OF 3/4".
- 10. ARROWS ON ALL HEATING AND CHILLED WATER. PIPING MAINS INDICATE DIRECTION
 OF FLOW. PITCH PIPING MAINS UP A MINIMUM OF 1" PER 50'-0" IN DIRECTION
 OF SUPPLY WATER FLOW.
 - 11. ALL FAN COIL UNIT CONDENSATE DRAINS ABOVE GRADE SHALL BE TYPE "L" HARD COPPER TUBING AND SHALL BE SIZED AS FOLLOWS: 1" DRAIN FOR ONE COIL, 1 1/4" DRAIN FOR TWO COILS, 1 1/2" DRAIN FOR THREE COILS, 2" DRAIN FOR FOUR OR MORE COILS. ALL BELOW GRADE DRAINS SHALL BE 2" EXTRA HEAVY CAST IRON SOIL PIPE AND SHALL SLOPE 1/8" PER 1"-0" UNLESS OTHERWISE NOTED.
 - 12. ALL AUTOMATIC TEMPERATURE REGULATING VALVES SHALL BE SIZED FOR 5 PSI MAXIMUM WATER PRESSURE DROP.

13. VALVE ALL HEATING AND CHILLED WATER BRANCHES IN FAN AND MECHANICAL

- ROOMS. CONTRACTOR SHALL ALSO PROVIDE AND INSTALL VALVES IN ALL PIPING AS REQUIRED TO FACILITATE OPERATION OF VARIOUS SYSTEMS DURING CONSTRUCTION.
- 14. HEATING AND CHILLED WATER BRANCHES TO CONVECTORS, VAV RE—HEAT COILS AND FAN COIL UNITS SHALL BE 3/4" FOR UNITS UNDER 3 GPM AND 1" FOR UNITS OVER 3 GPM. 1" SIZE TO ALL FINNED TUBE, CABINET HEATERS AND UNIT HEATERS UNLESS OTHERWISE NOTED.
- LINED UP VERTICALLY WITH LIGHT SWITCHES UNLESS OTHERWISE NOTED OR DIRECTED BY ARCHITECT.

15. ALL THERMOSTATS SHALL BE APPROXIMATELY 4'-6" ABOVE FINISHED FLOOR AND

- 16. ALL THERMOSTATS IN BOILER AND MECHANICAL ROOMS SHALL BE SET AT 60 DEGREES FAHRENHEIT.
- 17. PAINT ALL AREAS ABOVE CEILING THAT ARE VISIBLE THROUGH CEILING RETURN AIR GRILLES A FLAT BLACK.

18. MOUNT ALL VARIABLE AIR VOLUME BOXES AND FAN-POWERED VARIABLE AIR

VOLUME BUXES AT MAXIMUM 12 ABOVE CEILING.

GIBRALTAR
DESIGN
ARCHITECTURE • ENGINEERING • INTERIOR DESIGN

PROJECT

2006
CONVERSION of KINDERGARTEN AREA at LAWRENCE CENTRAL HIGH SCHOOL and RELATED WORK PROJECT #1

METROPOLITAN SCHOOL DISTRICT
OF LAWRENCE TOWNSHIP

INDIANAPOLIS, INDIANA

GIBRALTAR DESIGN
9102 N. Meridian St., Ste. 30

Indianapolis, IN 4626

Homepage www.GibraltarDesign.com
Email info@GibraltarDesign.com
Phone 317.580.5777 Fax 317.580.5778

PROJECT

O5 — 5 0 3

05-503
DATE
04/03/06
COORDINATED BY
MRG
DRAWN BY
WAB

REVISIONS

CHECKED BY

CAC

COPYRIGHT NOTICE:

THE CONCEPTS, DESIGNS, PLANS, DETAILS, ETC, SHOWN ON THIS DOCUMENT ARE THE PROPERTY OF GIBRALTAR DESIGN AND WERE CREATED FOR USE ON THIS SPECIFIC PROJECT. NONE OF THIS INFORMATION SHALL BE USED BY ANY PERSON OR FIRM FOR ANY PURPOSE WITHOUT THE EXPRESS WRITTEN CONSENT OF GIBRALTAR DESIGN. THE OWNER MAY RETAIN COPIES FOR INFORMATION AND REFERENCE IN CONNECTION ONLY WITH THIS PROJECT.

MARK	DATE	ISSUED FOR
	3/24/06	95% CD REVIEW
	4/03/06	100% CD
·		

DRAWING
MECHANICAL LEGEND
AND GENERAL
MECHANICAL NOTES

PROJECT
2006 CONVERSION OF KINDERGARTEN
AREA AT LAWRENCE CENTRAL HIGH
SCHOOL AND RELATED WORK

© GIBRALTAR DESIGN SHEET

M-001

GENERAL NOTES:

1. SEE SHEET M-001 FOR MECHANICAL LEGEND AND GENERAL NOTES.

DEMOLITION PLAN NOTES:

1 DISCONNECT AND REMOVE EXISTING RETURN AIR GRILLE COMPLETE. 2 DISCONNECT AND REMOVE EXISTING SUPPLY AIR DIFFUSER COMPLETE.

3 DISCONNECT AND REMOVE EXISTING EXHAUST REGISTER COMPLETE. 4 DISCONNECT AND REMOVE EXISTING SUPPLY AIR BRANCH DUCT AND ALL ASSOCIATED DAMPERS, SUPPORTS, INSULATION, ETC. BACK TO MAIN DUCT, COMPLETE UNLESS OPENING IS BEING USED IN THIS PROJECT. CAP AND SEAL OPENING IN MAIN DUCT AIR TIGHT.

5 DISCONNECT AND REMOVE EXISTING TRANSFER AIR DUCT AND ALL ASSOCIATED SUPPORTS, INSULATION, ETC. COMPLETE.

6 DISCONNECT AND REMOVE EXISTING SUPPLY AIR DUCT AND ALL ASSOCIATED DAMPERS, SUPPORTS, ETC. FROM DIFFUSERS BACK TO VAV BOX, COMPLETE.

7 DISCONNECT AND REMOVE EXISTING EXHAUST DUCT AND ALL ASSOCIATED DAMPERS, SUPPORTS, INSULATION, ETC. BACK TO MAIN DUCT, COMPLETE UNLESS OPENING IS BEING REUSED IN THIS PROJECT. CAP AND SEAL OPENING IN MAIN DUCT AIR TIGHT.

8 DISCONNECT AND REMOVE EXISTING THERMOSTAT, COMPLETE. 9 DISCONNECT AND REMOVE EXISTING CABINET HEATER AND ALL ASSOCIATED SUPPORTS, PIPING, VALVES, ETC. COMPLETE.

DISCONNECT AND REMOVE EXISTING FAN POWERED VAV BOX AND ALL ASSOCIATED SUPPORTS, CONTROLS, BRANCH PIPING, ETC. COMPLETE. CLEAN, REFURBISH AND STORE UNIT FOR REUSE IN THIS PROJECT.

DISCONNECT AND REMOVE EXISTING MEDIUM PRESSURE SUPPLY AIR BRANCH DUCT AND ALL ASSOCIATED SUPPORTS, INSULATION, ETC. FROM VAV BOX BACK TO MAIN DUCT UNLESS OPENING IS BEING REUSED IN THIS PROJECT, CAP AND SEAL OPENING IN MAIN DUCT

12 DISCONNECT AND REMOVE EXISTING THERMOSTAT AND STORE FOR REINSTALLATION IN THIS PROJECT.

RC	OOM NAME SCHEDULE	
NO	NAME	
-101	VESTIBULE	
-102	CUSTODIAN	
-103	WOMEN	
-104	CLASSROOM	
. 105	CORRIDOR	
-106	STORAGE	
-107	TOILET	
-108	TOILET	
-109	CLASSROOM	
-110	CLASSROOM	
<u> 111</u>	STORAGE	
-112	TOILET	GIBRALTAI
-113	TOILET	
-114	LEARNING CENTER	DESIGN
-115	WORK ROOM	
-116	CORRIDOR	ARCHITECTURE • ENGINEERING • INTERIOR DESIGN
-117	COMMONS	
-118	RESOURCE ROOM	_
-119	CORRIODR	_
-120	CLASSROOM	
<u>-121</u>	CLASSROOM	DDO ICCT
-122	CORRIDOR	PROJECT
-123	TOIL FT	

CONVERSION of KINDERGARTEN

A-111 STORAGE

A-115 WORK ROOM

A-118 RESOURCE ROOM

A-124 TOILET

A-125 STORAGE

A-128 STORAGE

A-129 TOILET A-130 TOILET

A-133 RAMP

A-134 STORAGE
A-135 STAFF LOUNGE
A-136 CORRIDOR

A-137 | ELEVATOR EQUIPMENT A-137 LEARNING CENTER

A-126 CLASSROOM A-127 CLASSROOM

A-116 CORRIDOR A-117 COMMONS

A-112 TOILET A-113 TOILET

A-104 CLASSROOM -105 CORRIDOR

> **AREA** at LAWRENCE **CENTRAL** HIGH SCHOOL and RELATED WORK PROJECT #1

METROPOLITAN SCHOOL DISTRICT OF LAWRENCE TOWNSHIP INDIANAPOLIS, INDIANA

KEY PLAN

GIBRALTAR DESIGN

3/24/06 95% CD REVIEW

4/03/06 100% CD

9102 N. Meridian St., Ste. 3


Indianapolis, IN 46260




DRAWING UNIT "A" MECHANICAL FIRST FLOOR DEMOLITON PLAN

PROJECT
2006 CONVERSION OF KINDERGARTEN AREA AT LAWRENCE CENTRAL HIGH SCHOOL AND RELATED WORK

GIBRALTAR DESIGN SHEET

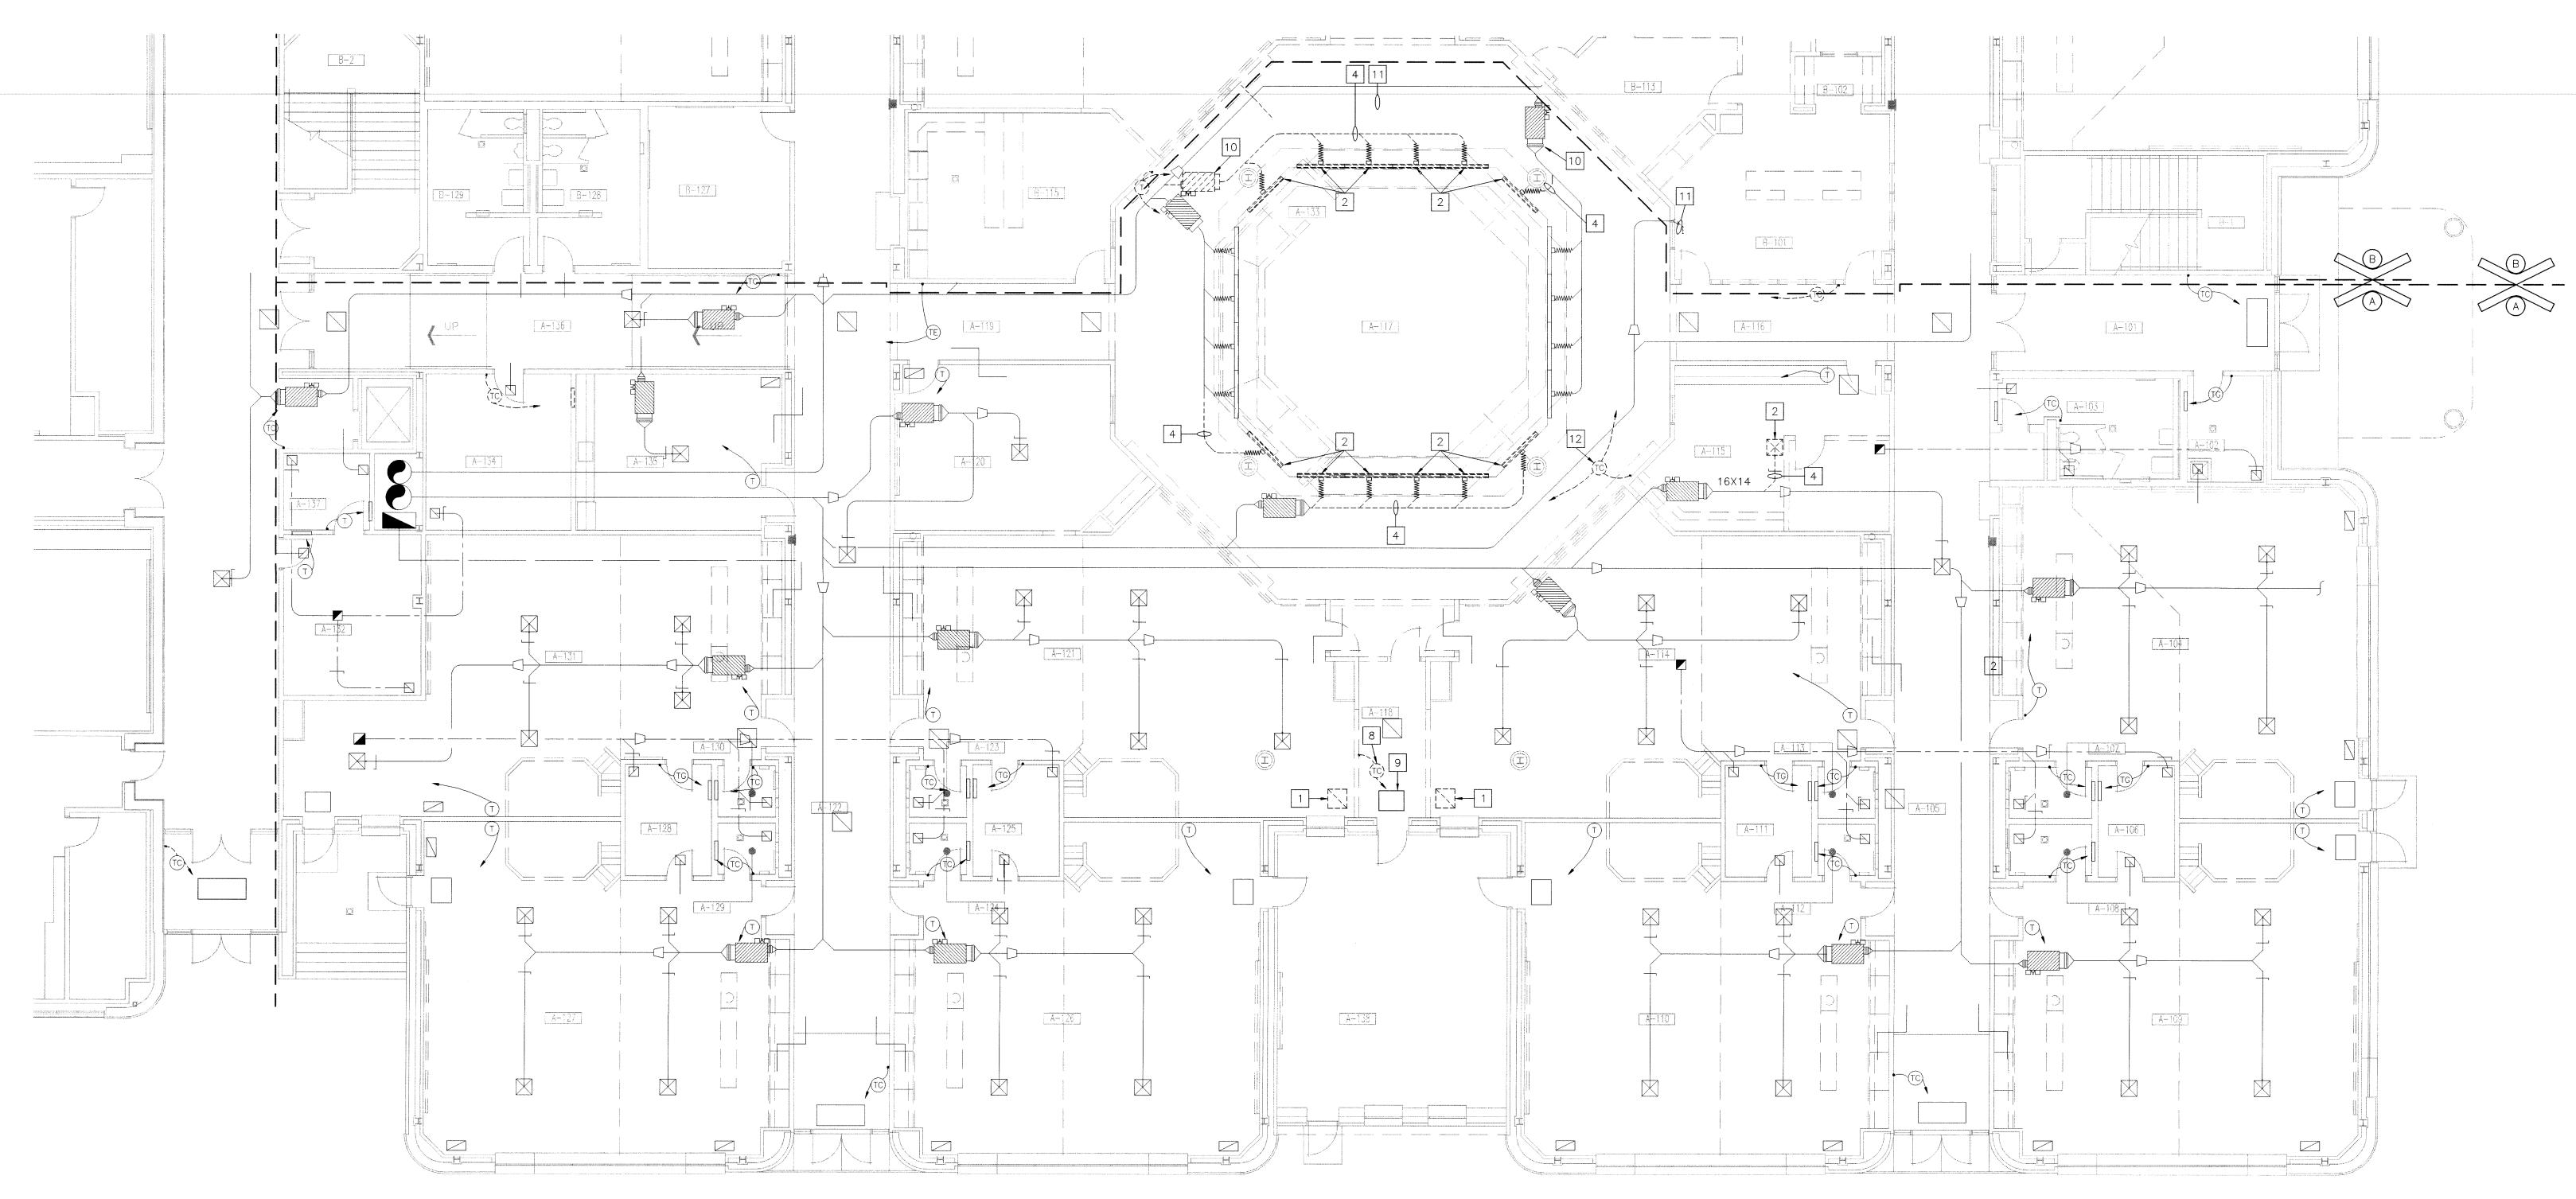

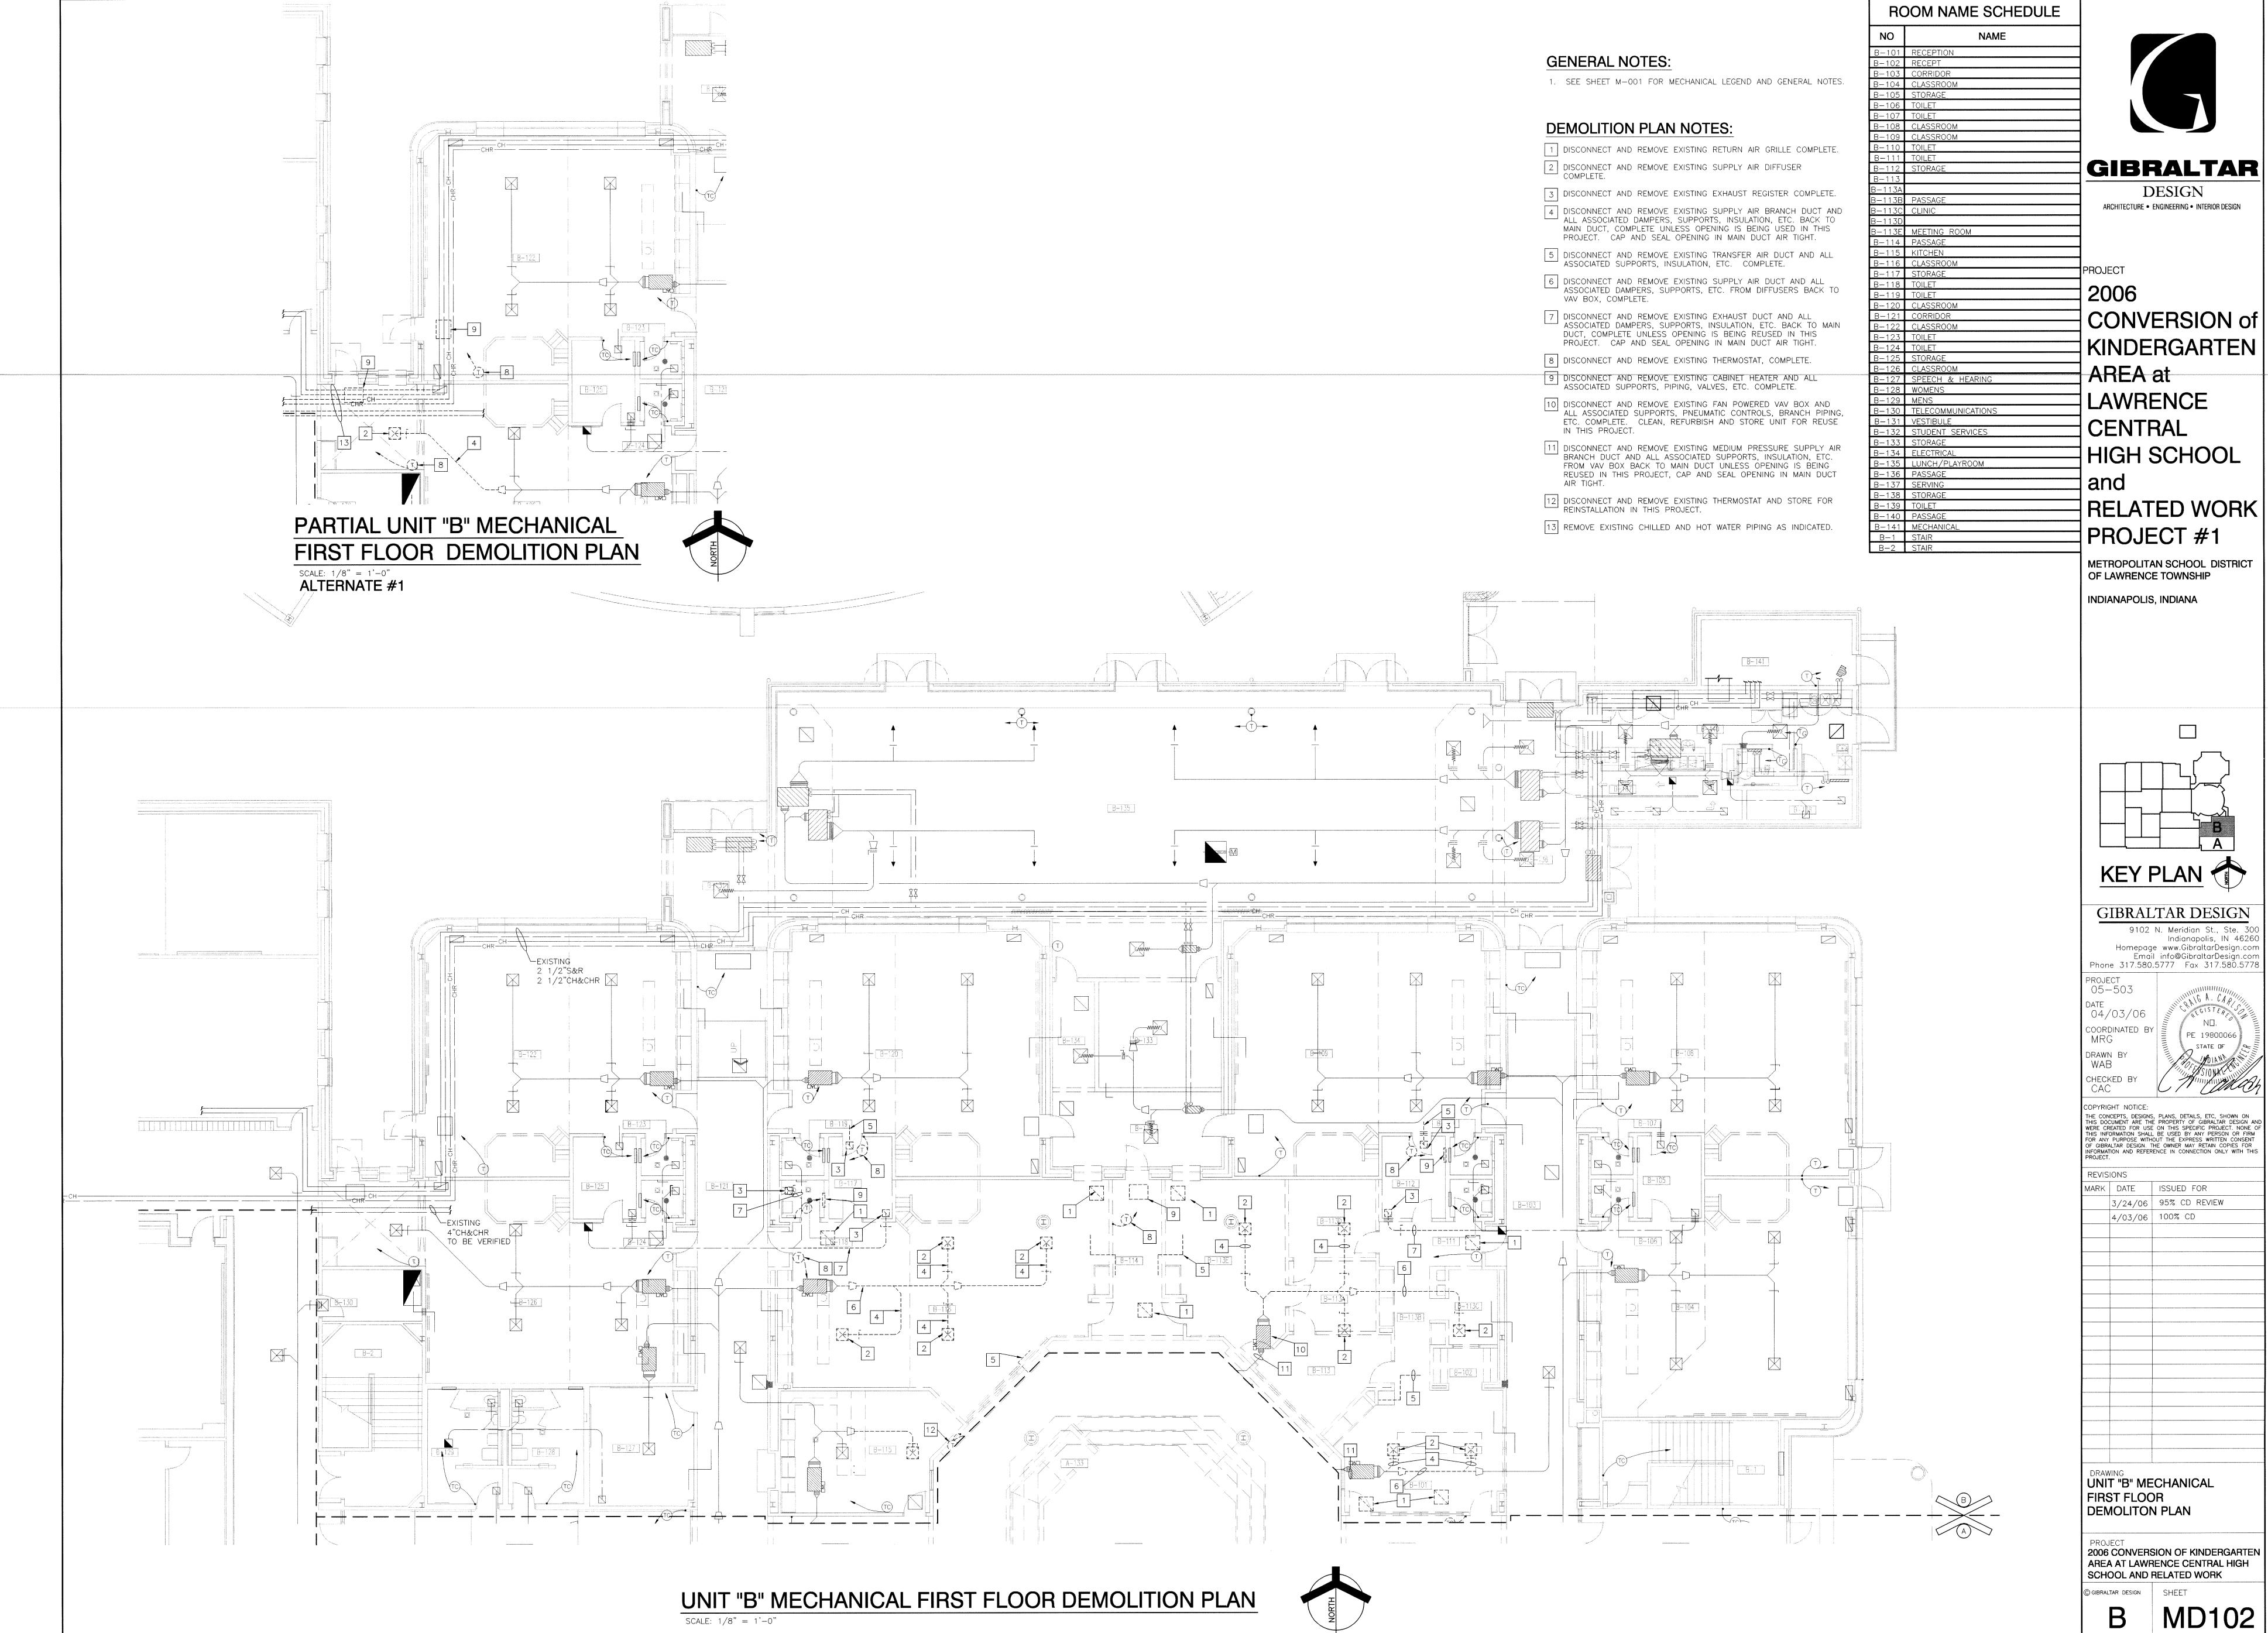

1. SEE SHEET M-001 FOR MECHANICAL LEGEND AND GENERAL NOTES. 2. SEE SHEET M-601 FOR MECHANICAL EQUIPMENT SCHEDULES.

PLAN NOTES:

1) REINSTALL EXISTING THERMOSTAT. EXTEND AS REQUIRED TO EXISTING PNUEMATIC CONTROLLED FAN POWERED VAV UNIT.

2 48"X8" SUPPLY AIR GRILLE MOUNTED IN WALL AT +10'-0" AFF., 812 CFM. PROVIDE 12" DEEP PLENUM CONNECTION.

ROOM NAME SCHEDULE GIBRALTAR **DESIGN**

ARCHITECTURE • ENGINEERING • INTERIOR DESIGN

PROJECT 2006

NO

A-101 VESTIBULE
A-102 CUSTODIAN
A-103 WOMEN

A-104 CLASSICOM
A-105 CORRIDOR
A-106 STORAGE
A-107 TOILET
A-108 TOILET

A-100 CLASSROOM
A-110 CLASSROOM
A-111 STORAGE
A-112 TOILET

A-116 CORRIDOR

A-113 TOILET

A-114 LEARNING CENTER

A-115 ADMINISTRATOR

A-116 CORRIDOR

A-117 ATRIUM

A-118 PASSAGE

A-119 CORRIODR

A-120 CAREER CLASSROOM

A-121 LEARNING CENTER
A-122 CORRIDOR
A-123 TOILET

A-113 TOILET

A-124 TOILET

A-125 STORAGE
A-126 CLASSROOM
A-127 CLASSROOM
A-128 STORAGE

A-129 TOILET
A-130 TOILET
A-131 CLASSROOM
A-132 CUSTODIAN

A-132 CUSTODIAN

A-133 ELEVATOR EQUIPMENT

A-134 SCHOOL PSYCHOLOGIST

A-135 STAFF LOUNGE

A-136 CORRIDOR

A-104 CLASSROOM

NAME

CONVERSION of KINDERGARTEN **AREA** at LAWRENCE **CENTRAL** HIGH SCHOOL and RELATED WORK PROJECT #1

METROPOLITAN SCHOOL DISTRICT OF LAWRENCE TOWNSHIP INDIANAPOLIS, INDIANA

KEY PLAN

GIBRALTAR DESIGN

Indianapolis, IN 46260 Homepage www.GibraltarDesign.com Email info@GibraltarDesign.com Phone 317.580.5777 Fax 317.580.5778

THE CONCEPTS, DESIGNS, PLANS, DETAILS, ETC, SHOWN ON THIS DOCUMENT ARE THE PROPERTY OF GIBRALTAR DESIGN AND WERE CREATED FOR USE ON THIS SPECIFIC PROJECT. NONE OF THIS INFORMATION SHALL BE USED BY ANY PERSON OR FIRM FOR ANY PURPOSE WITHOUT THE EXPRESS WRITTEN CONSENT OF GIBRALTAR DESIGN. THE OWNER MAY RETAIN COPIES FOR INFORMATION AND REFERENCE IN CONNECTION ONLY WITH THIS PROJECT.

3/24/06 95% CD REVIEW

MARK DATE ISSUED FOR

4/03/06 100% CD

PROJECT 05-503


DATE 04/03/06

COORDINATED B

DRAWN BY WAB

CHECKED BY

9102 N. Meridian St., Ste. 3

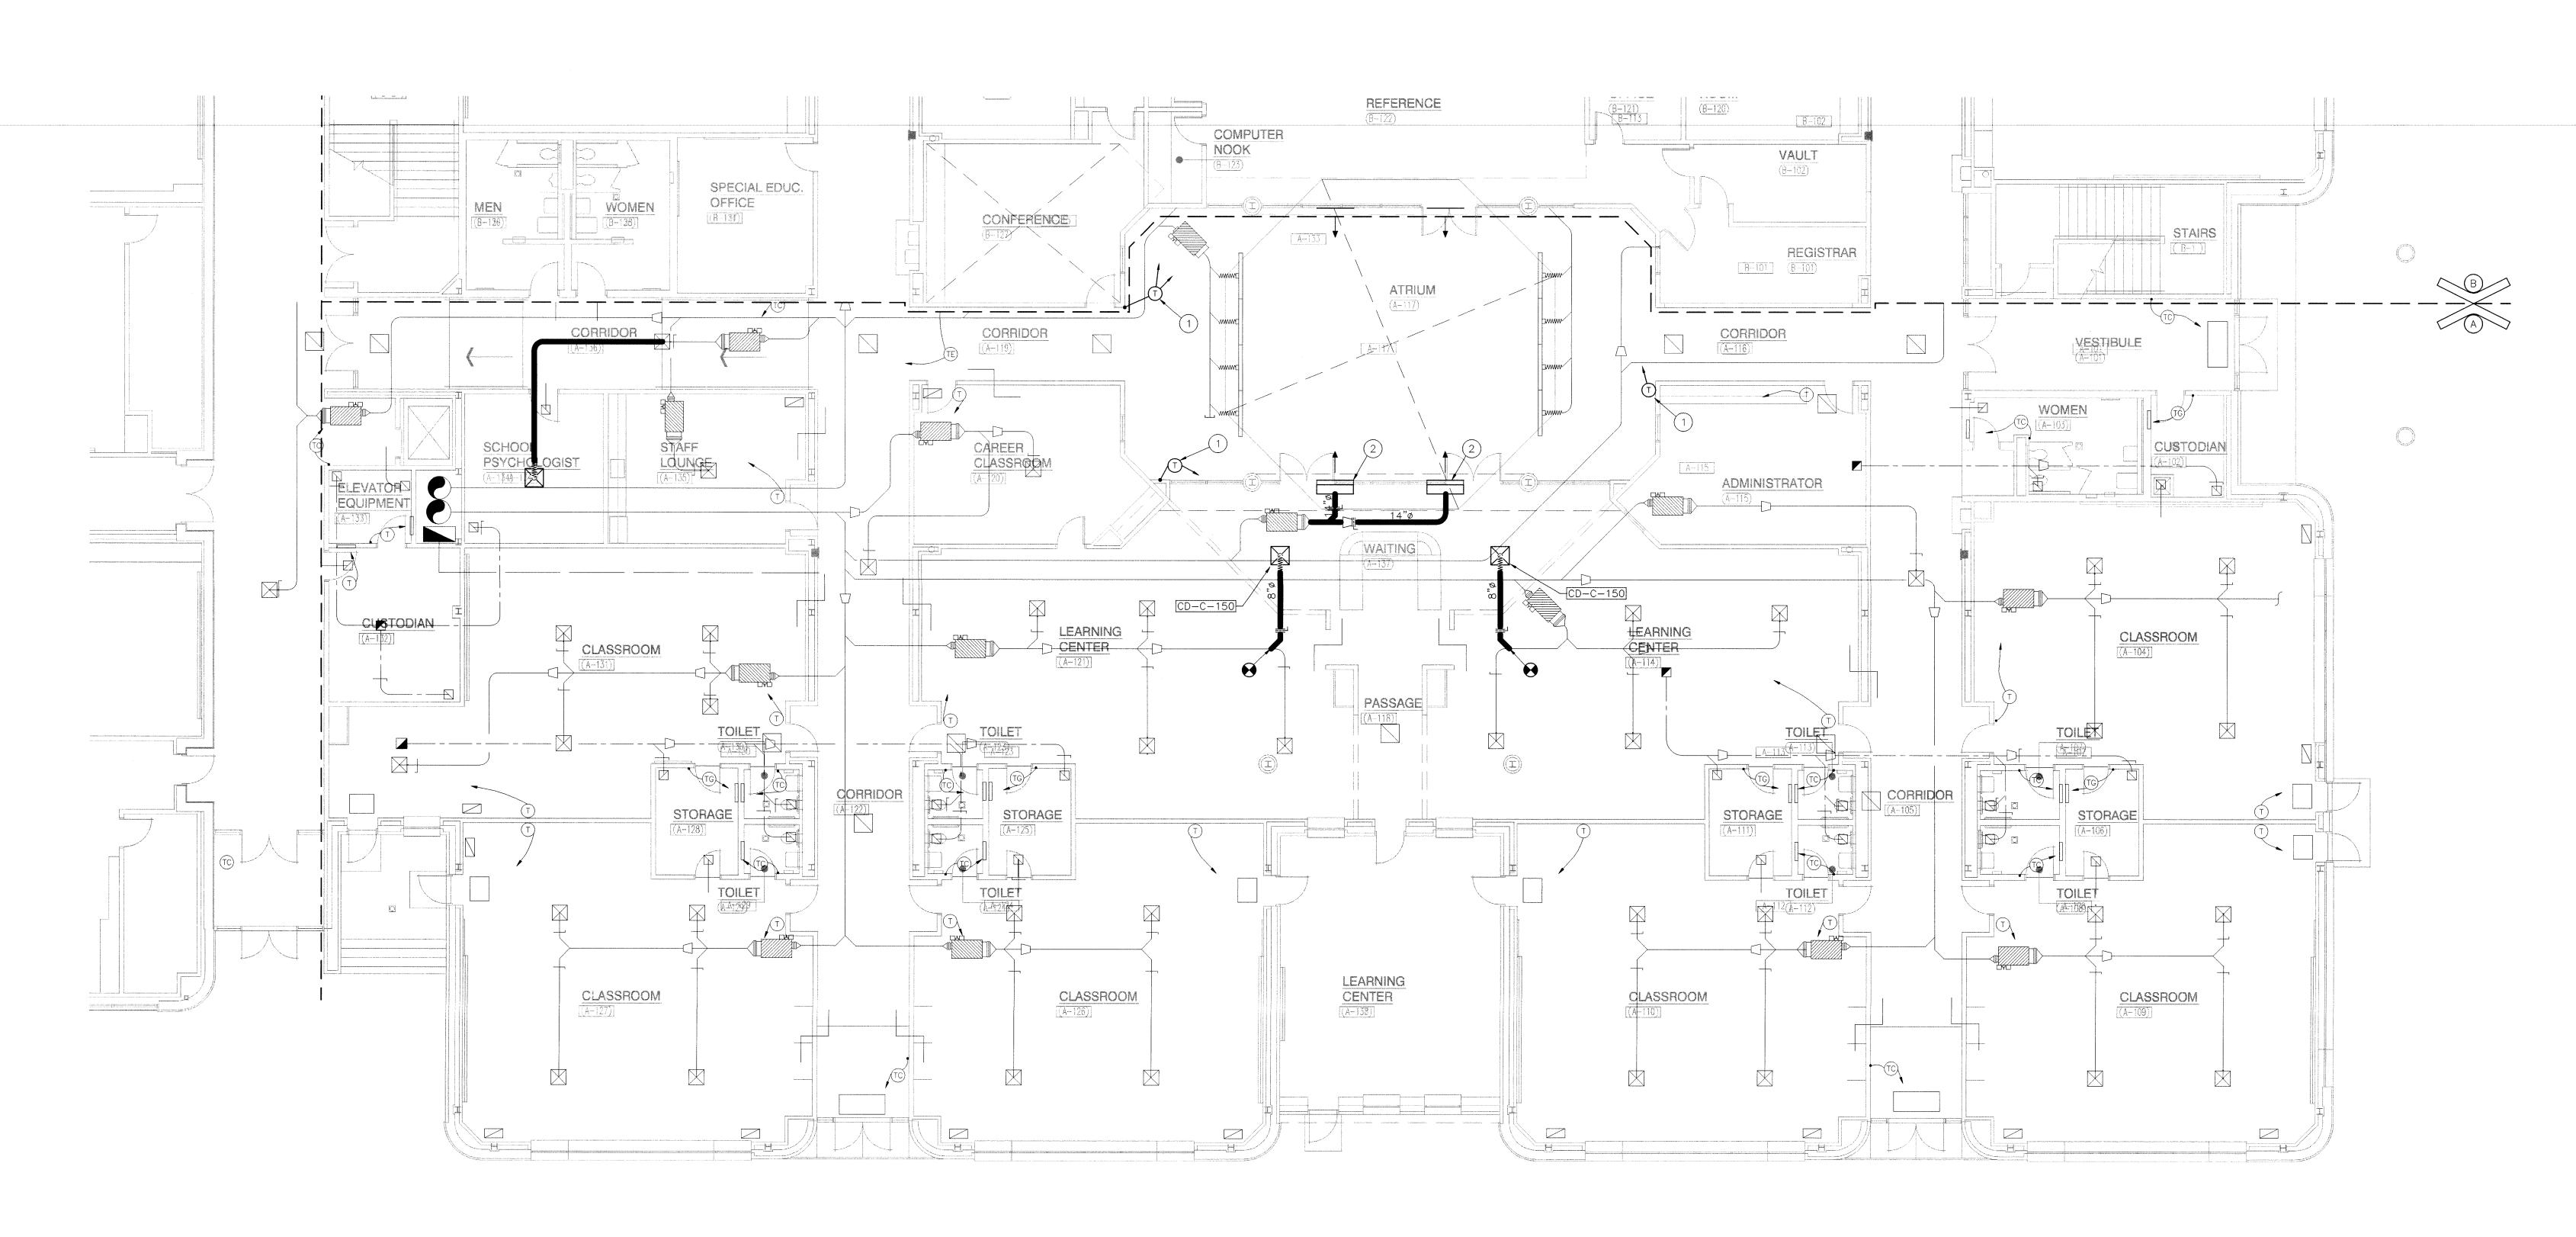


UNIT "A" MECHANICAL FIRST FLOOR PLAN SCALE: 1/8" = 1'-0"


PROJECT
2006 CONVERSION OF KINDERGARTEN AREA AT LAWRENCE CENTRAL HIGH SCHOOL AND RELATED WORK GIBRALTAR DESIGN SHEET

DRAWING UNIT "A" MECHANICAL

FIRST FLOOR PLAN

M-101 Α

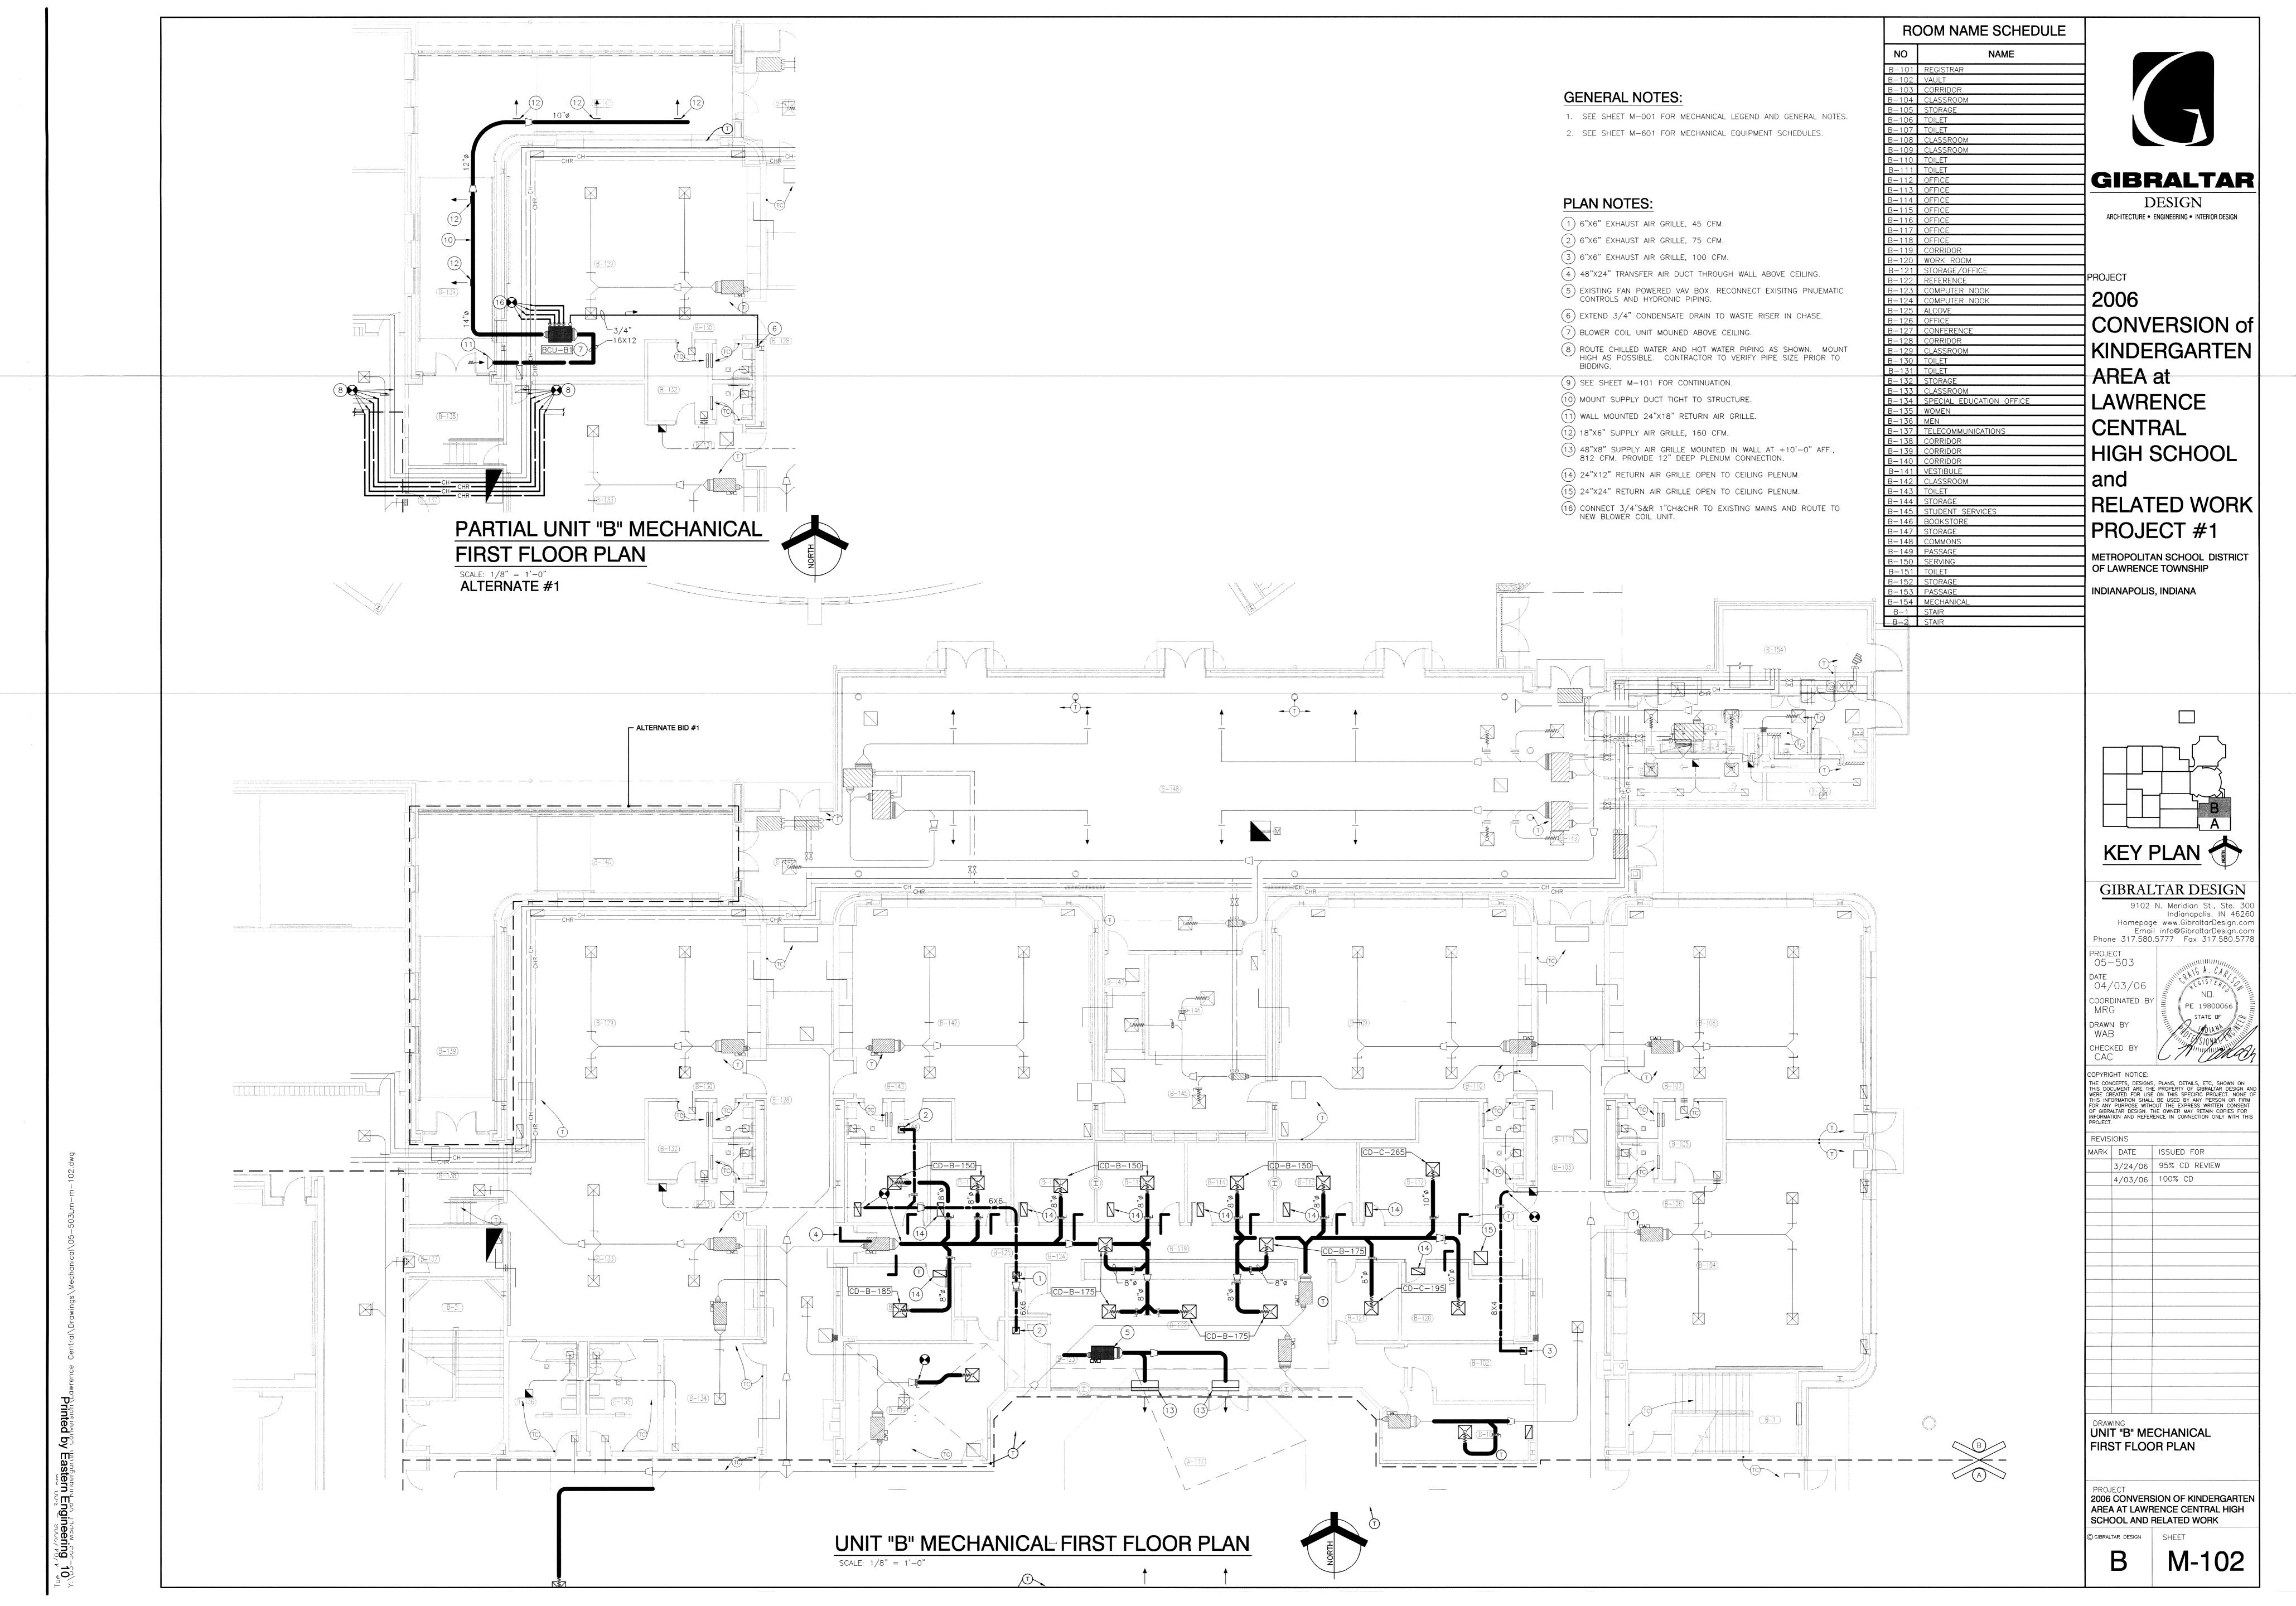

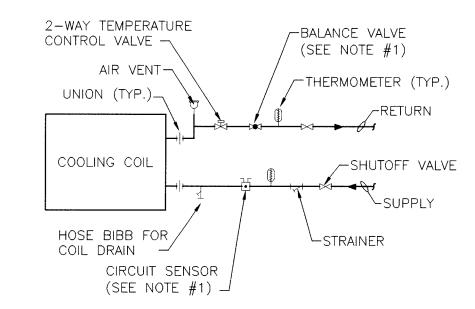


NOTE:

1. REPLACE BALANCE VALVE WITH CIRCUIT SETTER AND DELETE CIRCUIT SENSOR FOR PIPE SIZES 2" AND SMALLER.

CHILLED WATER COOLING COIL PIPING DIAGRAM

SCALE (2-WAY CONTROL VALVE)

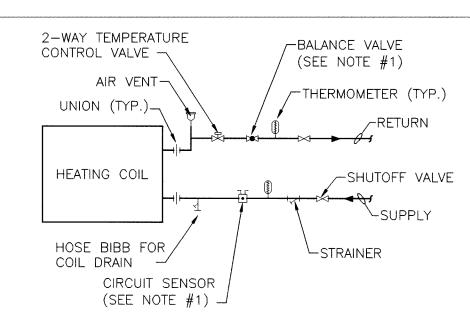

NOTE:

REPLACE BALANCE VALVE WITH CIRCUIT SETTER AND DELETE CIRCUIT SENSOR FOR PIPE SIZES 2" AND SMALLER.

HOT WATER HEATING COIL PIPING DIAGRAM

(2-WAY CONTROL VALVE)

	BLOWE	RC	OIL L	INIT	SCH	IEDU	JLE			
TRANE	TYPE AND	TOTAL	CFM	EXT.	COOLI	NG CAPA	CITIES	HEA	TING	Ι.
MODEL NUMBER	ARRANGEMENT	CFM	OUTDOOR AIR	PRESS.	SENSIBLE MBH	TOTAL MBH	GРM	мвн	GPM	

NOTES:

BCU ROOM NO. SERVED

- 1. COOLING CAPACITIES ARE BASED ON 80°F DB AND 67°F WB ENTERING AIR, 45°F ENTERING WATER, 10°F WATER TEMPERATURE RISE AND 6 ROW
- 2. PROVIDE ALL NECESSARY SUSPENSION ANGLES, HANGER RODS, VIBRATION ISOLATORS, ETC., AS NECESSARY TO SUSPEND UNIT FROM STEEL ROOF FRAMING.
- 3. ELECTRICAL DATA: 115 VOLTS, 1 PHASE, 60 HERTZ.
- 4. FILTER TO BE ACCESSIBLE FROM THE BOTTOM OF UNIT.

CEILING DIFFUSER SCHEDULE					
CD TYPE	KRUEGER MODEL NUMBER	NECK SIZE	PATTERN	PANEL SIZE	SEE NOTE
Α	SERIES 1400	6"ø	4-WAY	24"X24"	1,2,3,4
В	SERIES 1400	8"ø	4-WAY	24"X24"	1,2,3,4
С	SERIES 1400	10"ø	4-WAY	24"X24"	1,2,3,4
D	SERIES 1400	12"ø	4-WAY	24"X24"	1,2,3,4
	SERIES 1400	**************************************	**************************************	24 X24	1,2,3,4
F	SERIES 1400	15"a	4-14/4	24"\24"	1234

NOTES:

- 1. DIFFUSER SHALL BE FULLY ADJUSTABLE.
- 2. NC LEVEL SHALL NOT EXCEED 30 dB.
- 3. FRAME TYPE AS REQUIRED FOR CEILING TYPE, SEE ROOM FINISH SCHEDULE.
- 4. PROVIDE DIFFUSER WITH RADIATION DAMPER AND BLANKET WHERE REQUIRED SEE LIFE SAFETY PLAN.



ARCHITECTURE • ENGINEERING • INTERIOR DESIGN

2006
CONVERSION of KINDERGARTEN AREA at LAWRENCE CENTRAL HIGH SCHOOL and RELATED WORK PROJECT #1

METROPOLITAN SCHOOL DISTRICT OF LAWRENCE TOWNSHIP

INDIANAPOLIS, INDIANA

GIBRALTAR DESIGN

9102 N. Meridian St., Ste. 300 Indianapolis, IN 46260 Homepage www.GibraltarDesign.com Email info@GibraltarDesign.com Phone 317.580.5777 Fax 317.580.5778

PROJECT
05-503

DATE
04/03/06

COORDINATED BY
MRG

DRAWN BY WAB ND.

STATE OF

S

CHECKED BY
CAC

COPYRIGHT NOTICE:

THE CONCEPTS, DESIGNS, PLANS, DETAILS, ETC, SHOWN ON THIS DOCUMENT ARE THE PROPERTY OF GIBRALTAR DESIGN AND WERE CREATED FOR USE ON THIS SPECIFIC PROJECT. NONE OF THIS INFORMATION SHALL BE USED BY ANY PERSON OR FIRM FOR ANY PURPOSE WITHOUT THE EXPRESS WRITTEN CONSENT OF GIBRALTAR DESIGN. THE OWNER MAY RETAIN COPIES FOR INFORMATION AND REFERENCE IN CONNECTION ONLY WITH THIS PROJECT.

MARK DATE ISSUED FOR

3/24/06 95% CD REVIEW

4/03/06 100% CD

DRAWING MECHANICAL SCHEDULES


AND DETAILS

PROJECT
2006 CONVERSION OF KINDERGARTEN
AREA AT LAWRENCE CENTRAL HIGH
SCHOOL AND RELATED WORK

© GIBRALTAR DESIGN SHEET

M-601

). Bujjaanibug ujatseg ka pajujid 22-303. mobiji va kingergarten Conversion\Lawrence Central\Drawings\Mechanical\05-503Lm-m-601.

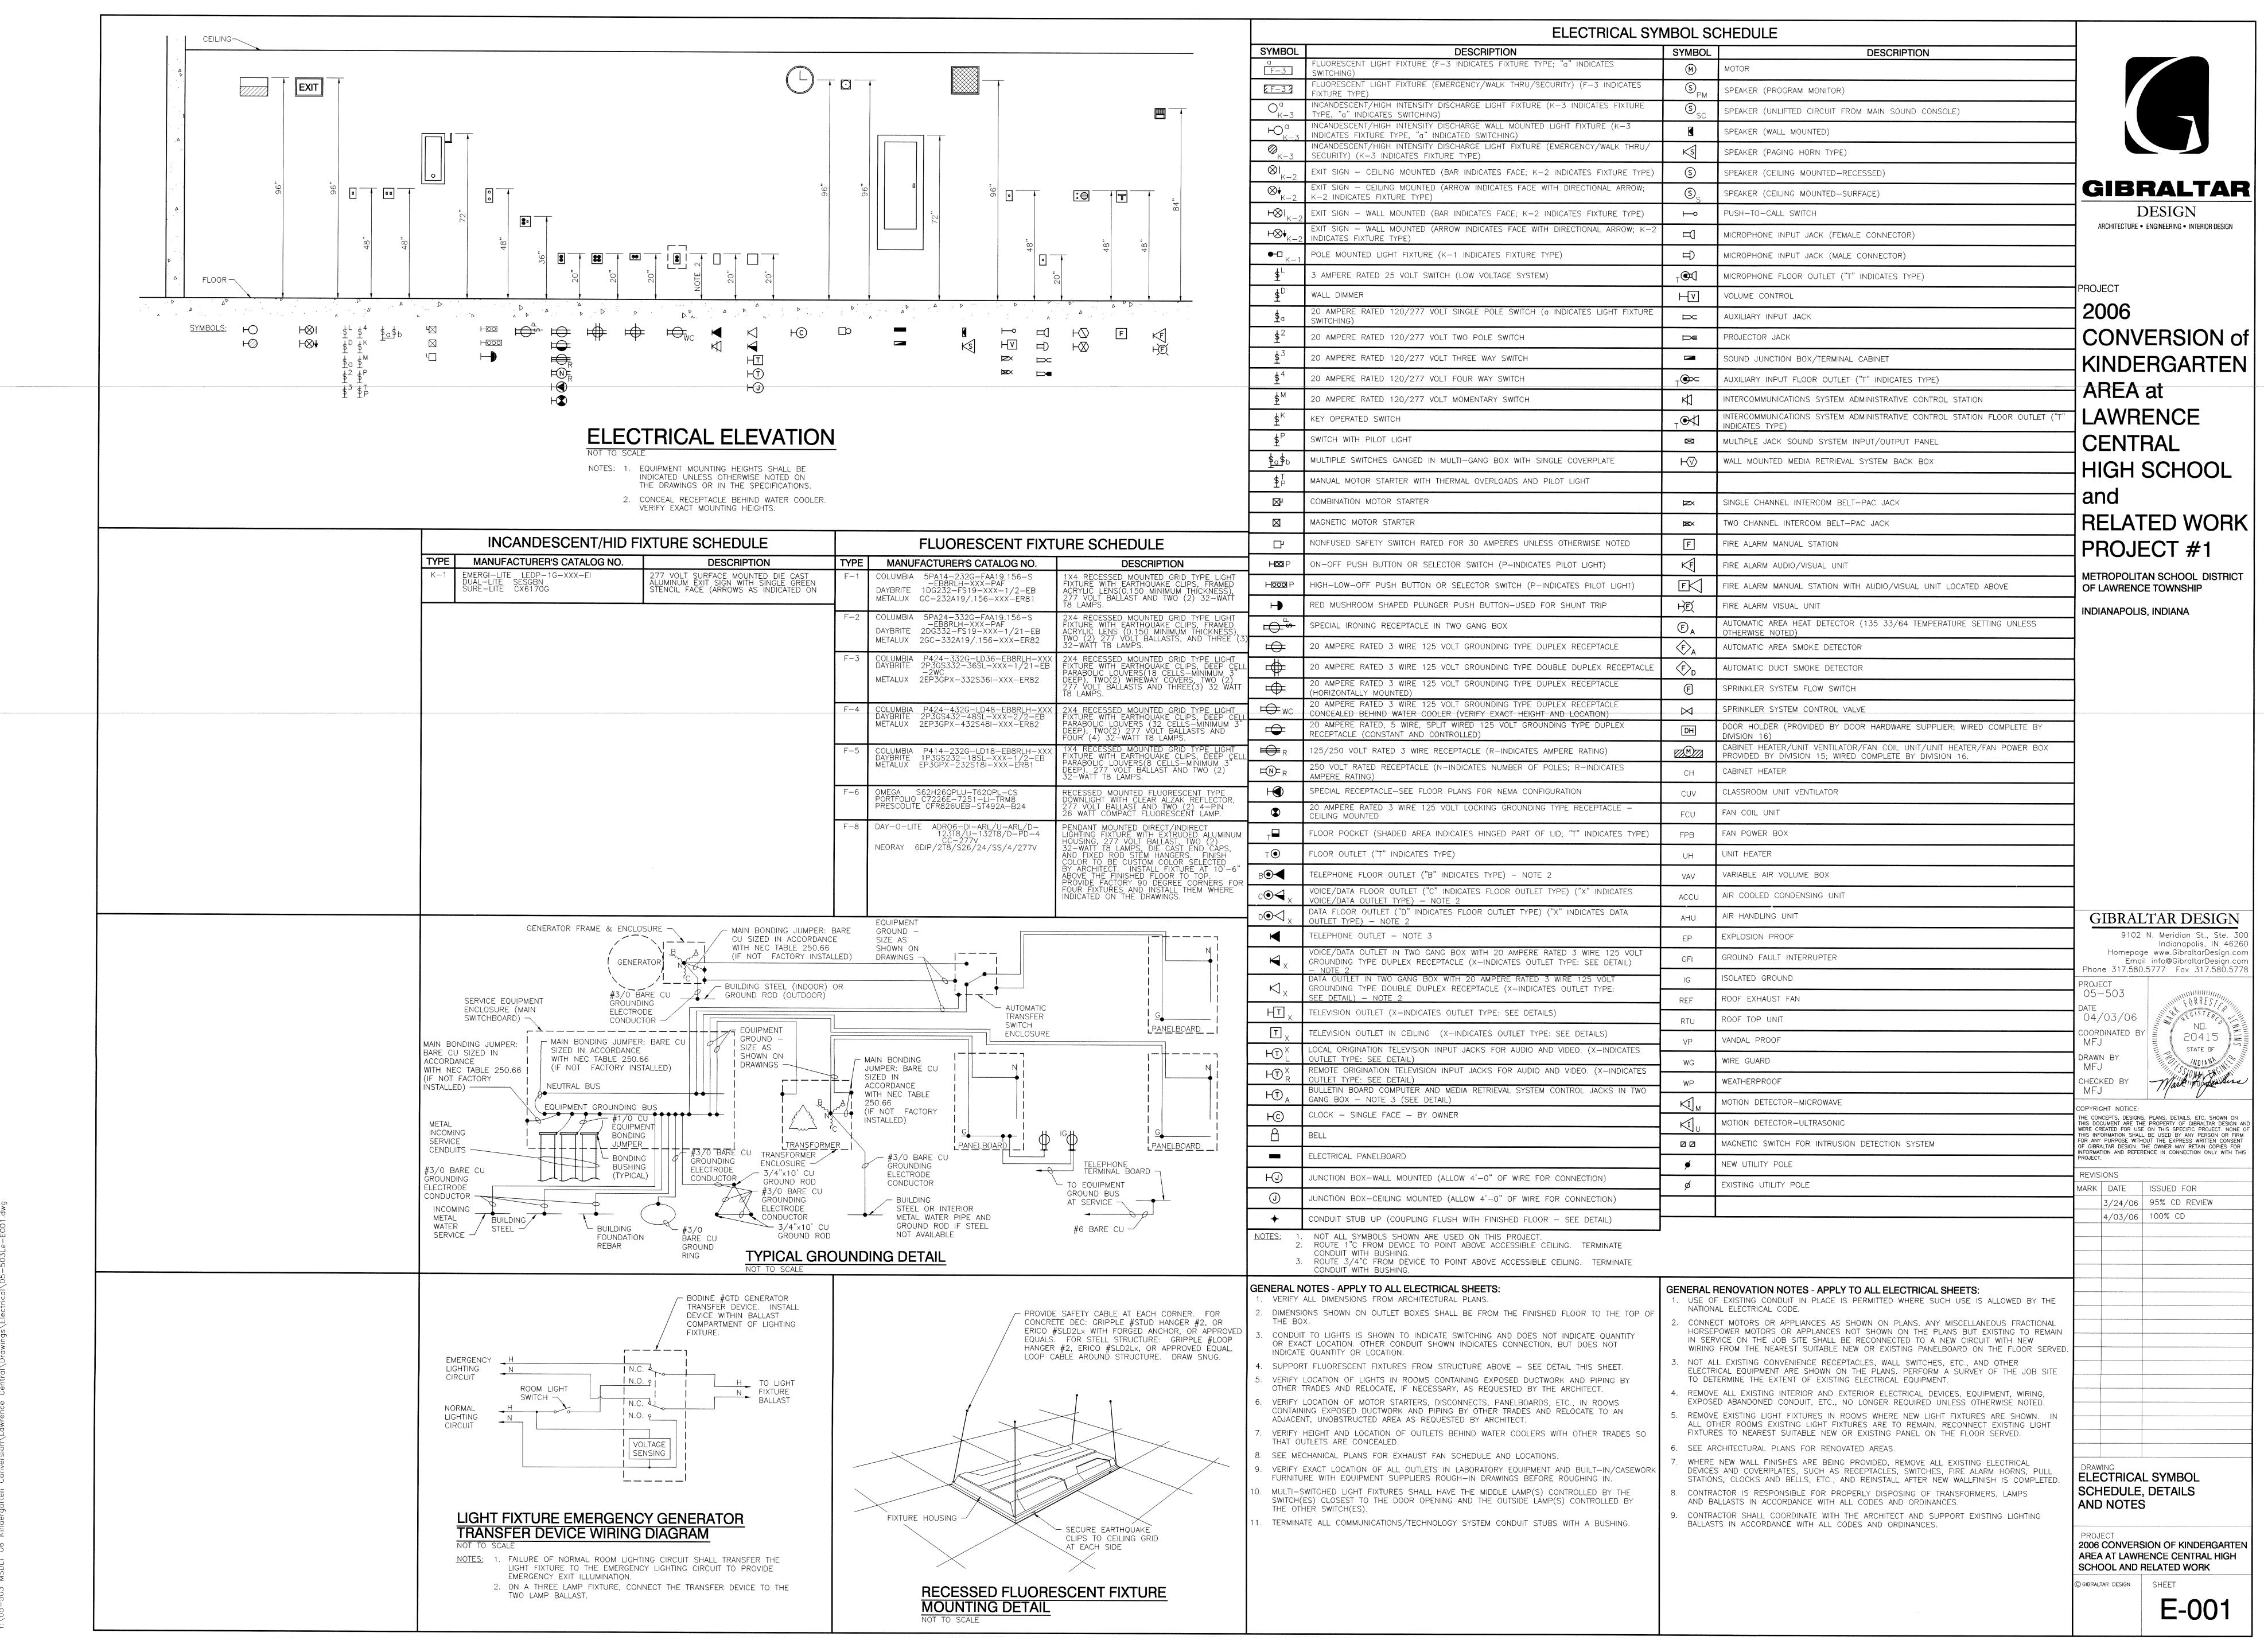

Printed by Eastern Engineering 8

DEMOLITION PLAN NOTES: (THESE NOTES APPLY TO THIS SHEET ONLY) (NOTE ALL NOTES LISTED MAY BE USED)

- ALL EXISTING ELECTRICAL DEVICES (LIGHTING FIXTURES, LIGHT SWITCHES, POWER RECEPTACLES, FIRE ALARM SYSTEM DEVICES, DATA OUTLETS, TELEVISION OUTLETS, TELEPHONE OUTLETS, ETC.) IN THIS ROOM SHALL REMAIN UNLESS OTHERWISE NOTED.
- DISCONNECT AND REMOVE EXISTING CEILING MOUNTED LIGHTING FIXTURES AND ALL ASSOCIATED CONDUIT AND WIRING BACK TO THE SOURCE UNLESS OTHERWISE NOTED.
- 3 DISCONNECT AND REMOVE EXISTING WALL MOUNTED LIGHTING FIXTURE AND ALL ASSOCIATED CONDUIT AND WIRING IN SUCH A MANNER THAT ALL OTHER LIGHTING FIXTURES AND DEVICES CONNECTED TO THIS CIRCUIT SHALL REMAIN IN SERVICE.
- DISCONNECT AND REMOVE EXISTING LIGHTING FIXTURE MOUNTED TO BOTTOM OF LOFT AND ALL ASSOCIATED CONDUIT AND WIRING BACK TO THE SOURCE UNLESS OTHERWISE NOTED.
- 5 RELOCATE EXISTING LIGHTING FIXTURE AS INDICATED ON SHEET EL101.
- DISCONNECT AND REMOVE EXISTING LIGHT SWITCH(ES) AND ALL ASSOCIATED CONDUIT AND WIRING BACK TO THE SOURCE UNLESS OTHERWISE NOTED.
- 7 DISCONNECT AND REMOVE EXISTING LIGHT SWITCH(ES).
 MODIFY WIRING AND PREPARE FOR NEW LIGHT SWITCH(ES) AS
 INDICATED ON SHEET EL101.
- 8 DISCONNECT AND REMOVE EXISTING LIGHT SWITCH(ES) AND ALL ASSOCIATED WIRING BACK TO THE SOURCE UNLESS OTHERWISE NOTED. PROVIDE FINISHED BLANK WALL PLATE.
- 9 DISCONNECT AND REMOVE EXISTING EXIT SIGN AND ALL ASSOCIATED CONDUIT AND WIRING BACK TO THE SOURCE UNLESS OTHERWISE NOTED.
- DISCONNECT AND REMOVE EXISTING ELECTRICAL DEVICE AND ALL ASSOCIATED WIRING BACK TO THE SOURCE UNLESS OTHERWISE NOTED. PROVIDE FINISHED BLANK WALL PLATE WHERE WALL REMAINS. REMOVE OUTLET BOX AND CONDUIT WHERE WALL IS REMOVED.

- DISCONNECT AND REMOVE EXISTING RECEPTACLE MOUNTED IN ISLAND COUNTER AND ALL ASSOCIATED CONDUIT AND WIRE BACK TO THE SOURCE UNLESS OTHERWISE NOTED. REMOVE CONDUIT TO BELOW FINISHED FLOOR AND STUB AND CAP.
- DISCONNECT AND REMOVE ALL EXISTING ELECTRICAL DEVICES (LIGHTING FIXTURES, LIGHT SWITCHES, POWER RECEPTACLES, FIRE ALARM SYSTEM DEVICES, DATA OUTLETS, TELEVISION OUTLETS, TELEPHONE OUTLETS, LOUDSPEAKERS, ETC.) IN THIS ROOM UNLESS OTHERWISE NOTED. DISCONNECT AND REMOVE ALL ASSOCIATED WIRING BACK TO THE SOURCE. PROVIDE FINISHED BLANK WALL PLATE FOR WALL OUTLETS WHERE WALL REMAINS. REMOVE OUTLET BOX AND CONDUIT WHERE WALL IS REMOVED.
- REMOVE EXISTING RECEPTACLE FOR WATER COOLER TO REMAIN. SEE "P" SERIES SHEETS FOR WATER COOLER MOUNTING HEIGHT CHANGE.
- DISCONNECT AND REMOVE EXISTING SCHOOL INTERCOM SYSTEM CALL—IN BUTTON AND ALL ASSOCIATED WIRING. PROVIDE FINISHED BLANK WALL PLATE WHERE WALL REMAINS. REMOVE OUTLET BOX AND CONDUIT WHERE WALL IS REMOVED.
- EXISTING SCHOOL INTERCOM SYSTEM CEILING LOUDSPEAKERS IN THIS ROOM TO REMAIN. CONNECT LOUDSPEAKERS TO EXISTING HIGH SCHOOL PAGING SYSTEM AS INDICATED.
- DISCONNECT AND REMOVE EXISTING SCHOOL INTERCOM SYSTEM CEILING LOUDSPEAKER. CONNECT SPEAKER WIRING TO NEW CEILING LOUDSPEAKER(S) IN THIS AREA AS INDICATED ON SHEET EL101. CONNECT SPEAKER TO EXISTING HIGH SCHOOL PAGING SYSTEM AS INDICATED.

17 DISCONNECT AND REMOVE EXISTING WALL CLOCK, CLOCK

BOX AND CONDUIT WHERE WALL IS REMOVED.

THE SOURCE UNLESS OTHERWISE NOTED. PROVIDE FINISHED BLANK WALL PLATE WHERE WALL REMAINS. REMOVE OUTLET BOX AND CONDUIT WHERE WALL IS REMOVED.

18 DISCONNECT AND REMOVE EXISTING FIRE ALARM SYSTEM DEVICE AND ALL ASSOCIATED WIRING. PROVIDE FINISHED

BLANK WALL PLATE WHERE WALL REMAINS. REMOVE OUTLET

 $^{
m J}$ outlet, and all associated conduit and wire back to

- DISCONNECT AND REMOVE EXISTING WALL MOUNTED
 TELEVISION OUTLET AND ASSOCIATED DUPLEX RECEPTACLE,
 AND WIRING BACK TO THE SOURCE. PROVIDE FINISHED
 BLANK WALL PLATES WHERE WALLS REMAIN. REMOVE OUTLET
 BOXES AND CONDUIT WHERE WALLS ARE REMOVED.
- 20 EXISTING CEILING MOUNTED TELEVISION MONITOR AND MONITOR MOUNT AT THIS LOCATION WILL BE REMOVED BY THE OWNER.
- EXISTING CEILING MOUNTED TELEVISION MONITOR AND MONITOR MOUNT TO BE RELOCATED BY OWNER. RELOCATE ASSOCIATED CEILING MOUNTED POWER RECEPTACLE AND TELEVISION CABLING TO NEW LOCATION INDICATED ON SHEETS EL101 AND EP101.
- DISCONNECT AND REMOVE EXISTING CIRCUIT CONDUIT AND WIRING FOR THE EXISTING HVAC FAN POWER BOX, CABINET HEATER, OR VAV BOX ABOVE THE ROOM CEILING BACK TO THE SOURCE UNLESS OTHERWISE NOTED.
- 23 EXISTING ELETRICAL DEVICE TO REMAIN.
- 24 EXISTING FAN POWERED BOX TO BE RELOCATED. SEE SHEET EP102 FOR NEW LOCATION.

_	GIBRALTAI
	DESIGN
\exists	ARCHITECTURE • ENGINEERING • INTERIOR DESIGN

PROJECT

2006

CONVERSION of KINDERGARTEN

AREA at LAWRENCE CENTRAL

ROOM NAME SCHEDULE

NAME

NO

A-103 WOMEN

-106 STORAGE

A-110 CLASSROOM

A-115 WORK ROOM

A-116 CORRIDOR

A-117 COMMONS

A-119 CORRIODR

A-120 CLASSROOM

A-122 CORRIDOR

A-123 TOILET

A-124 TOILET

A-125 STORAGE

A-128 STORAGE
A-129 TOILET
A-130 TOILET

A-133 RAMP

A-126 CLASSROOM

A-127 CLASSROOM

A-131 CLASSROOM A-132 CUSTODIAN

A-136 CORRIDOR

A-134 STORAGE
A-135 STAFF LOUNGE

A-137 ELEVATOR EQUIPMENT

A-137 LEARNING CENTER

A-107 TOILET

A-108 TOILET

A-111 STORAGE

A-112 TOILET

VESTIBULE


CLASSROOM

A-114 LEARNING CENTER

A-118 RESOURCE ROOM

AREA at
LAWRENCE
CENTRAL
HIGH SCHOOL
and
RELATED WORK
PROJECT #1

METROPOLITAN SCHOOL DISTRICT
OF LAWRENCE TOWNSHIP
INDIANAPOLIS, INDIANA

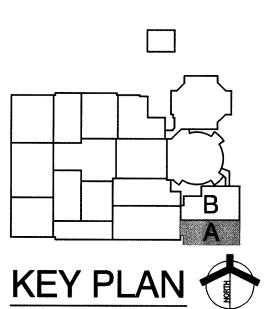

GIBRALTAR DESIGN

9102 N. Meridian St., Ste. 300
Indianapolis, IN 46260
Homepage www.GibraltarDesign.com
Email_info@GibraltarDesign.com

Email info@GibraltarDesign.com
Phone 317.580.5777 Fax 317.580.5777

PROJECT
05-503

DATE
04/03/06

COORDINATED BY
MFJ

DRAWN BY
MFJ

CHECKED BY

COPYRIGHT NOTICE:
THE CONCEPTS, DESIGNS, PLANS, DETAILS, ETC, SHOWN ON THIS DOCUMENT ARE THE PROPERTY OF GIBRALTAR DESIGN AWERE CREATED FOR USE ON THIS SPECIFIC PROJECT. NONE THIS INFORMATION SHALL BE USED BY ANY PERSON OR FIRM FOR ANY PURPOSE WITHOUT THE EXPRESS WRITTEN CONSENT OF GIBRALTAR DESIGN. THE OWNER MAY RETAIN COPIES FOR NEORMATION AND REFERENCE IN CONNECTION ONLY WITH THE

REVISIONS

IARK DATE ISSUED FOR

3/24/06 95% CD REVIEW

4/03/06 100% CD


DRAWING
UNIT "A" ELECTRICAL
FIRST FLOOR
DEMOLITON PLAN


PROJECT
2006 CONVERSION OF KINDERGARTEN
AREA AT LAWRENCE CENTRAL HIGH
SCHOOL AND RELATED WORK

GIBRALTAR DESIGN SHEET

A

ED101

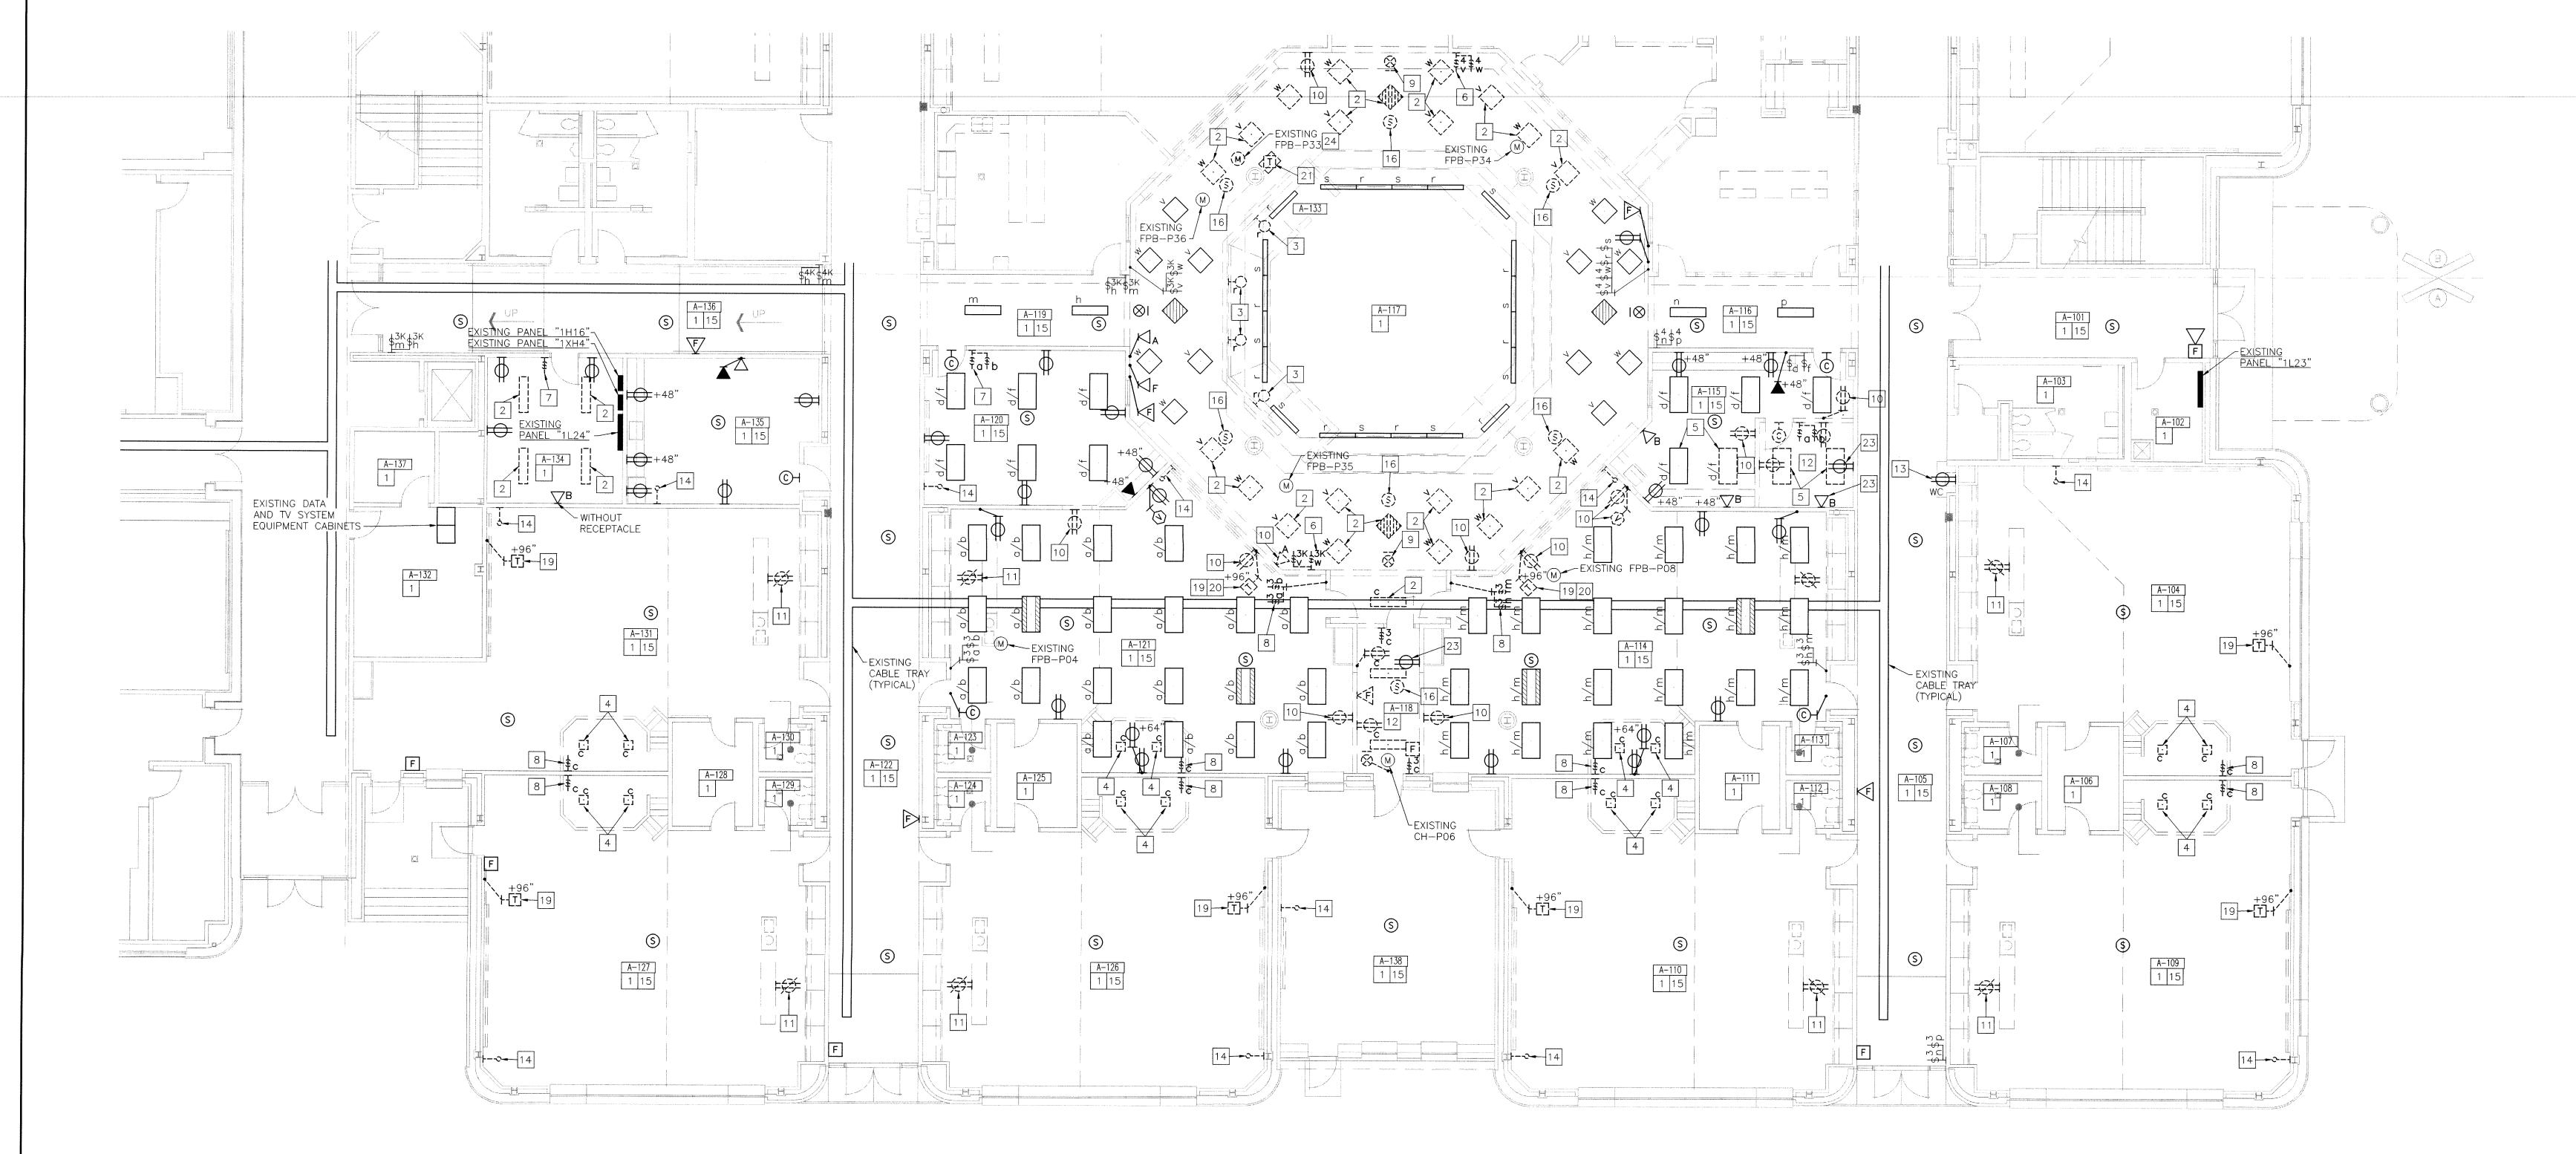

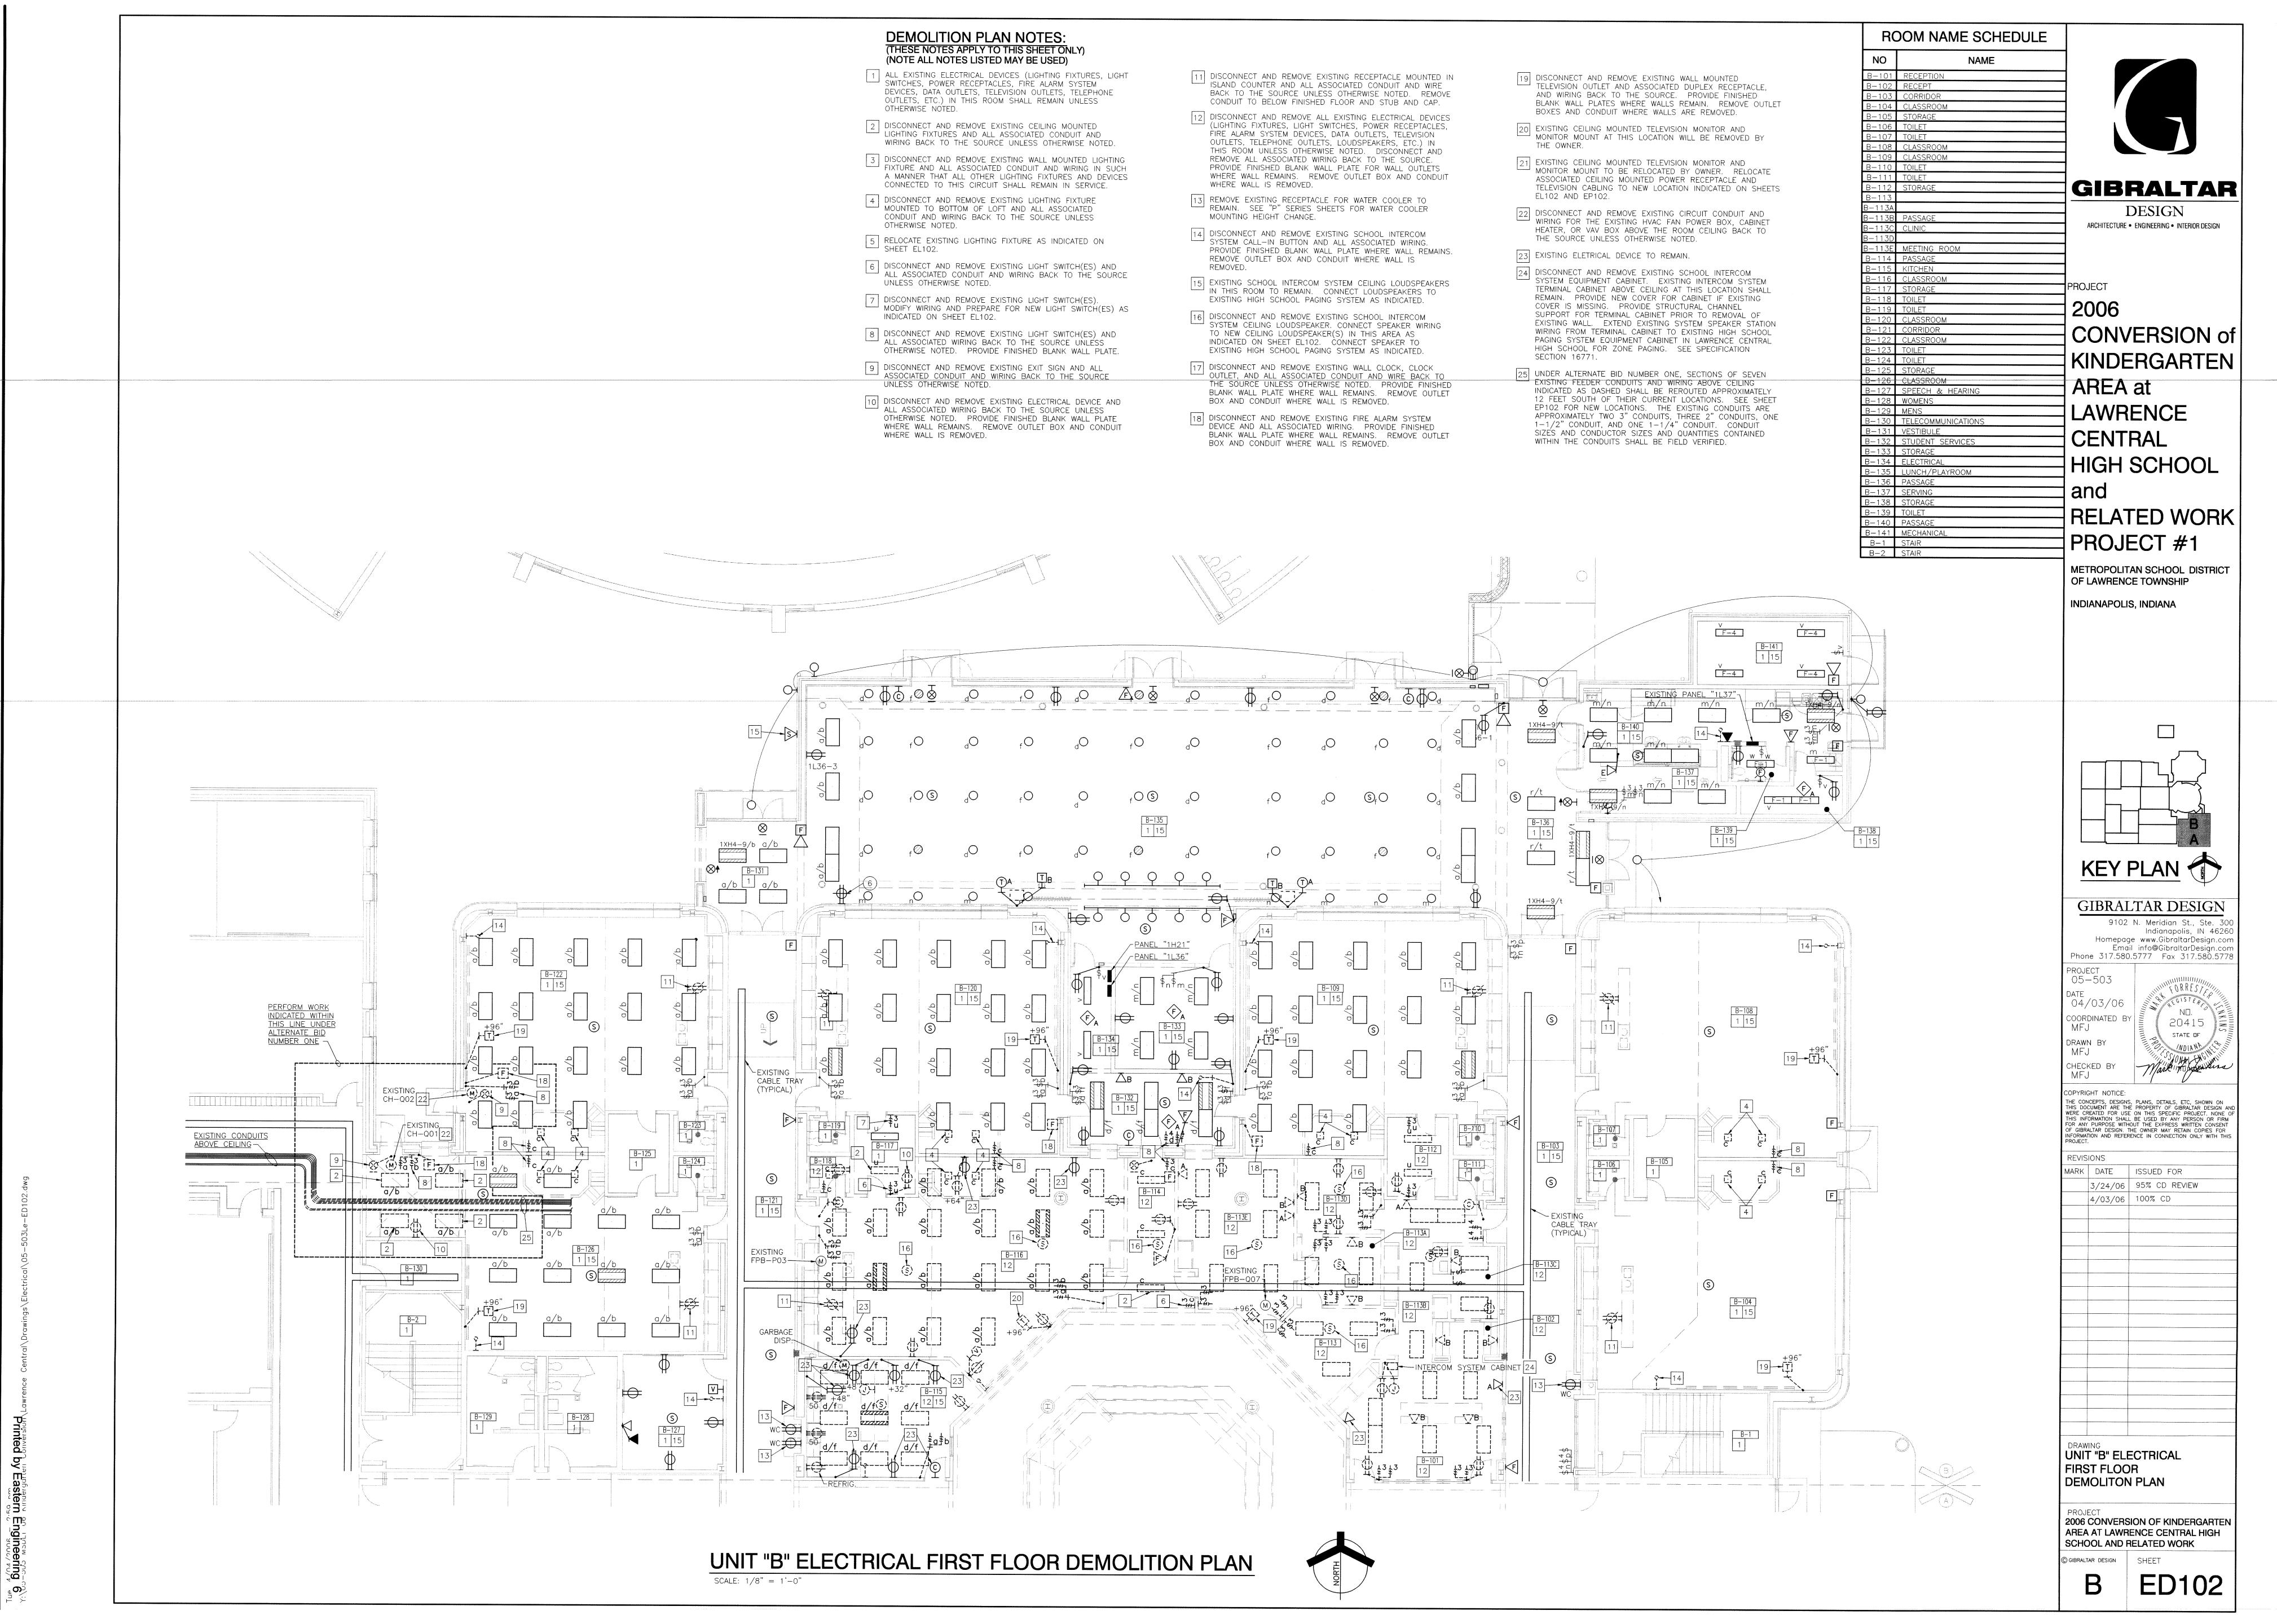

PLAN NOTES:
(THESE NOTES APPLY TO THIS SHEET ONLY)

1 EXISITNG LIGHTING CIRCUIT SERVING THE ATRIUM.

ROOM NAME SCHEDULE NO NAME A-102 CUSTODIAN
A-103 WOMEN
A-104 CLASSROOM
A-105 CORRIDOR
A-106 STORAGE
A-107 TOILET
A-108 TOILET
A-109 CLASSROOM
A-110 CLASSROOM
A-111 STORAGE
A-112 TOILET
A-113 TOILET
A-114 LEARNING CENTER
A-115 ADMINISTRATOR
A-116 CORRIDOR
A-117 ATRIUM
A-118 PASSAGE ARCHITECTURE • ENGINEERING • INTERIOR DESIGN A-117 ATRIUM
A-118 PASSAGE
A-119 CORRIODR
A-120 CAREER CLASSROOM
A-121 LEARNING CENTER
A-122 CORRIDOR
A-123 TOILET
A-124 TOILET
A-125 STORAGE
A-126 CLASSROOM
A-127 CLASSROOM
A-128 STORAGE
A-129 TOILET
A-130 TOILET
A-130 TOILET
A-131 CLASSROOM
A-132 CUSTODIAN
A-133 ELEVATOR EQUIPMENT
A-134 SCHOOL PSYCHOLOGIST
A-135 STAFF LOUNGE
A-136 CORRIDOR


GIBRALTAR **DESIGN**

and

CONVERSION of KINDERGARTEN AREA at LAWRENCE CENTRAL HIGH SCHOOL

RELATED WORK PROJECT #1

METROPOLITAN SCHOOL DISTRICT OF LAWRENCE TOWNSHIP INDIANAPOLIS, INDIANA

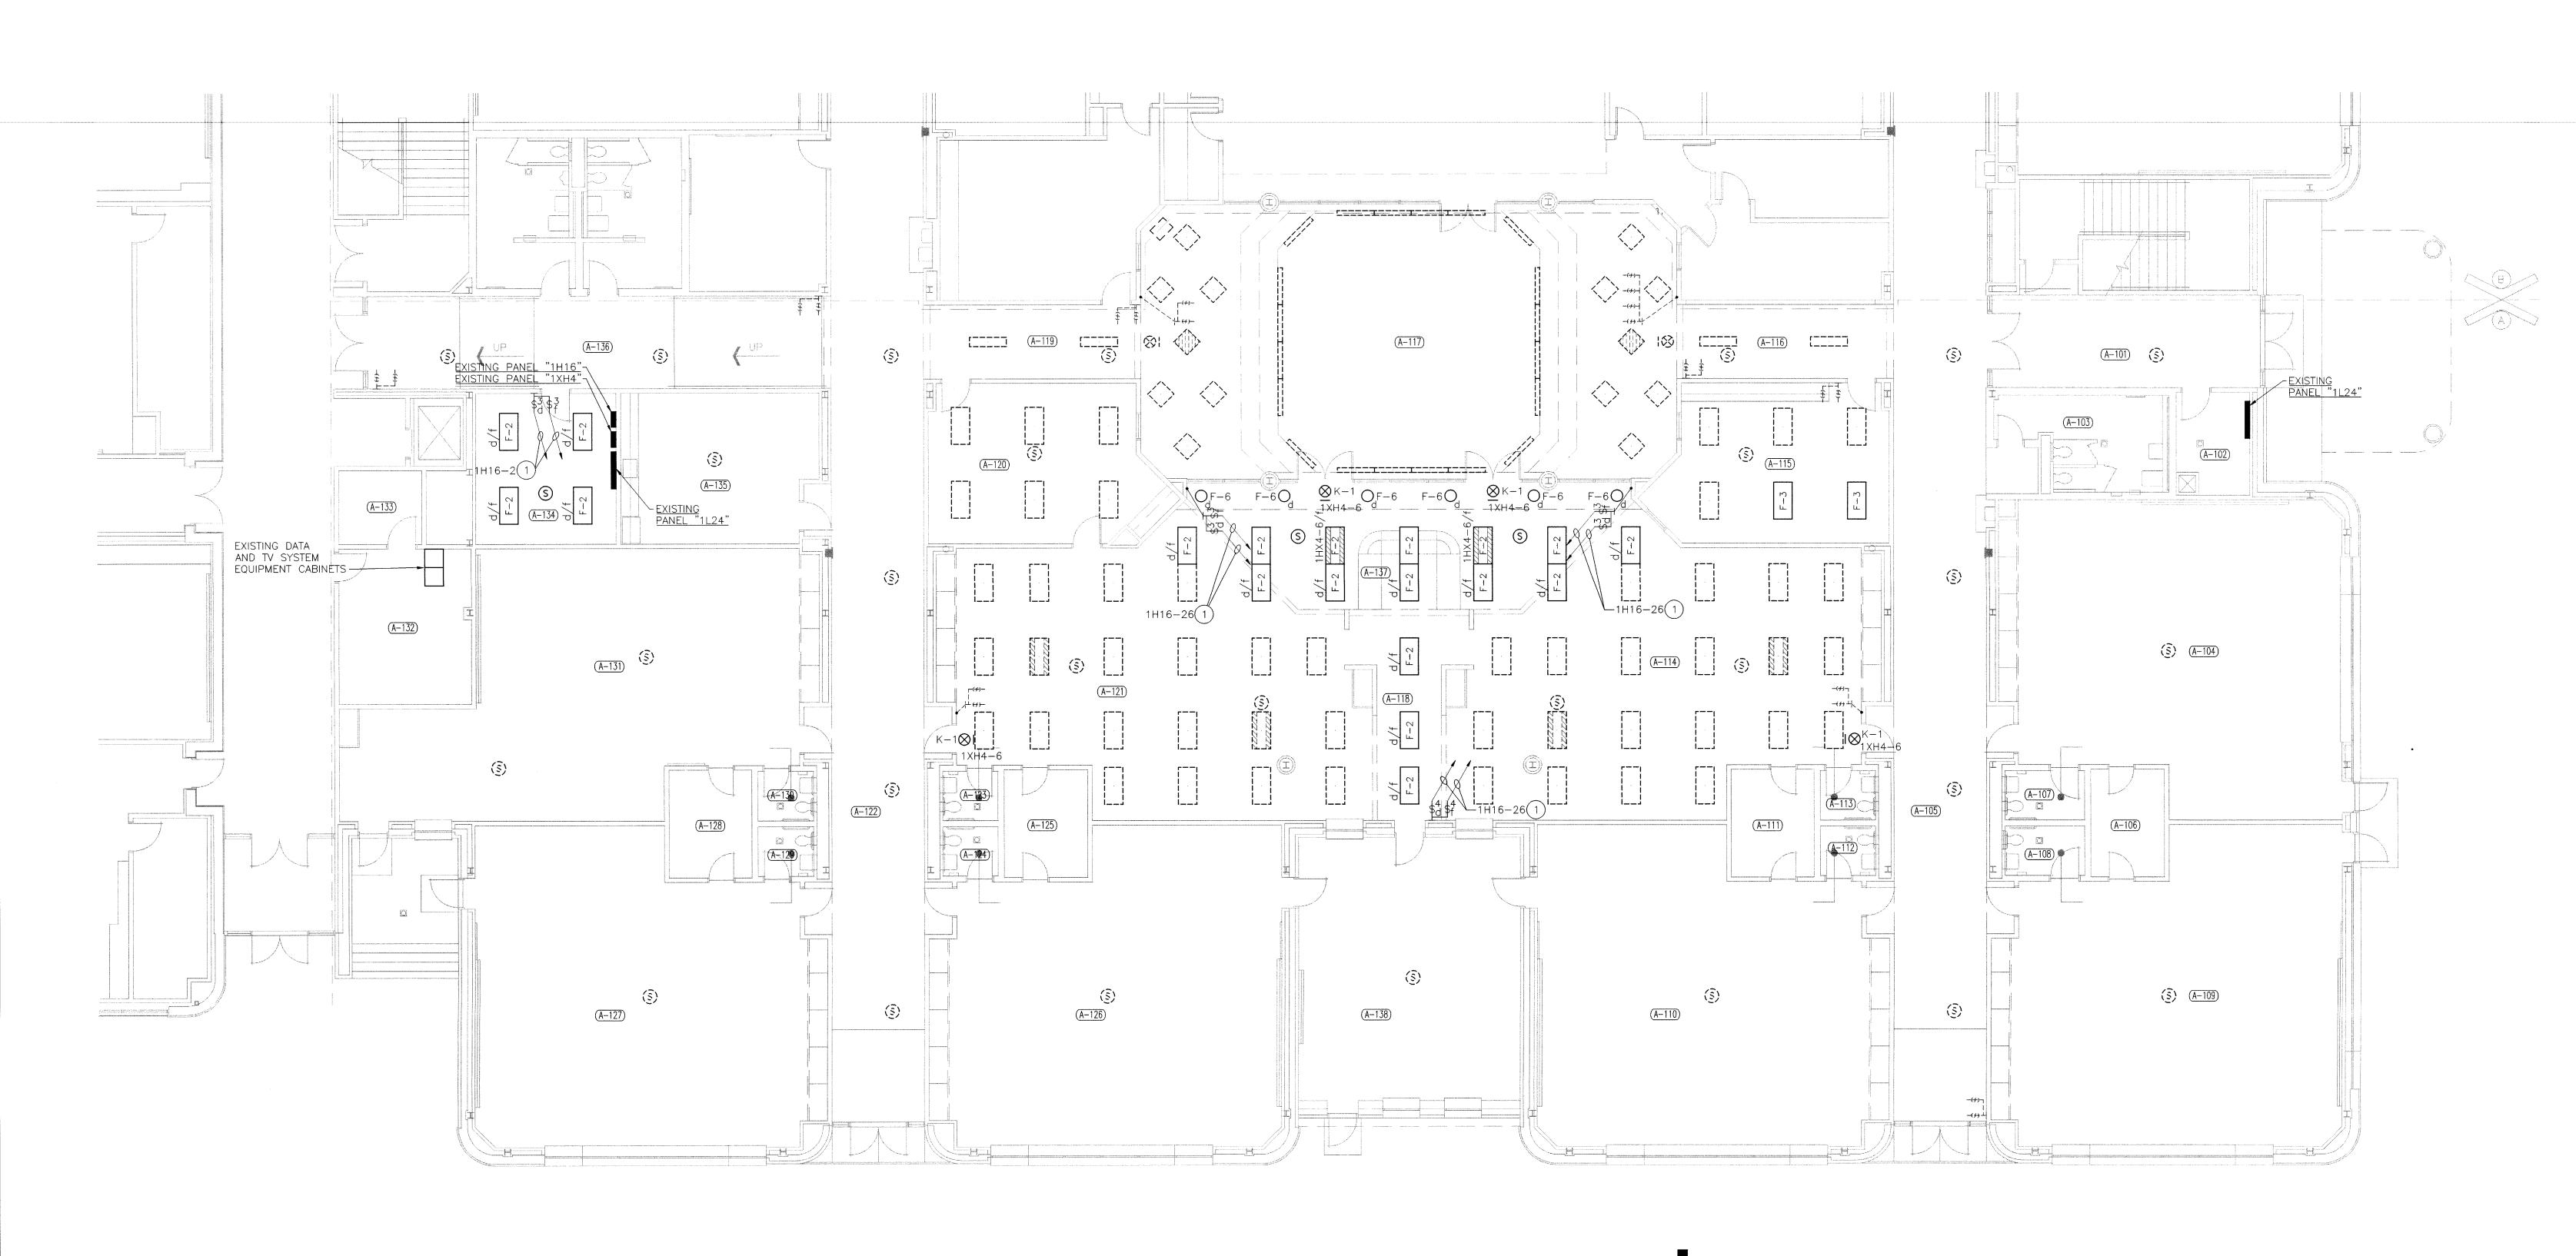

KEY PLAN

GIBRALTAR DESIGN 9102 N. Meridian St., Ste. 3 Indianapolis, IN 46260
Homepage www.GibraltarDesign.com
Email info@GibraltarDesign.com
Phone 317.580.5777 Fax 317.580.5778

PROJECT 05-503 04/03/06 COORDINATED BY MFJ DRAWN BY MFJ

CHECKED BY MFJ THE CONCEPTS, DESIGNS, PLANS, DETAILS, ETC, SHOWN ON THIS DOCUMENT ARE THE PROPERTY OF GIBRALTAR DESIGN AND WERE CREATED FOR USE ON THIS SPECIFIC PROJECT. NONE OF THIS INFORMATION SHALL BE USED BY ANY PERSON OR FIRM FOR ANY PURPOSE WITHOUT THE EXPRESS WRITTEN CONSENT OF GIBRALTAR DESIGN. THE OWNER MAY RETAIN COPIES FOR INFORMATION AND REFERENCE IN CONNECTION ONLY WITH THIS PROJECT.

MARK DATE ISSUED FOR


3/24/06 95% CD REVIEW 4/03/06 | 100% CD

DRAWING
UNIT "A" ELECTRICAL LIGHTING LIGHTING FIRST FLOOR PLAN

2006 CONVERSION OF KINDERGARTEN AREA AT LAWRENCE CENTRAL HIGH SCHOOL AND RELATED WORK

GIBRALTAR DESIGN SHEET

EL101 A

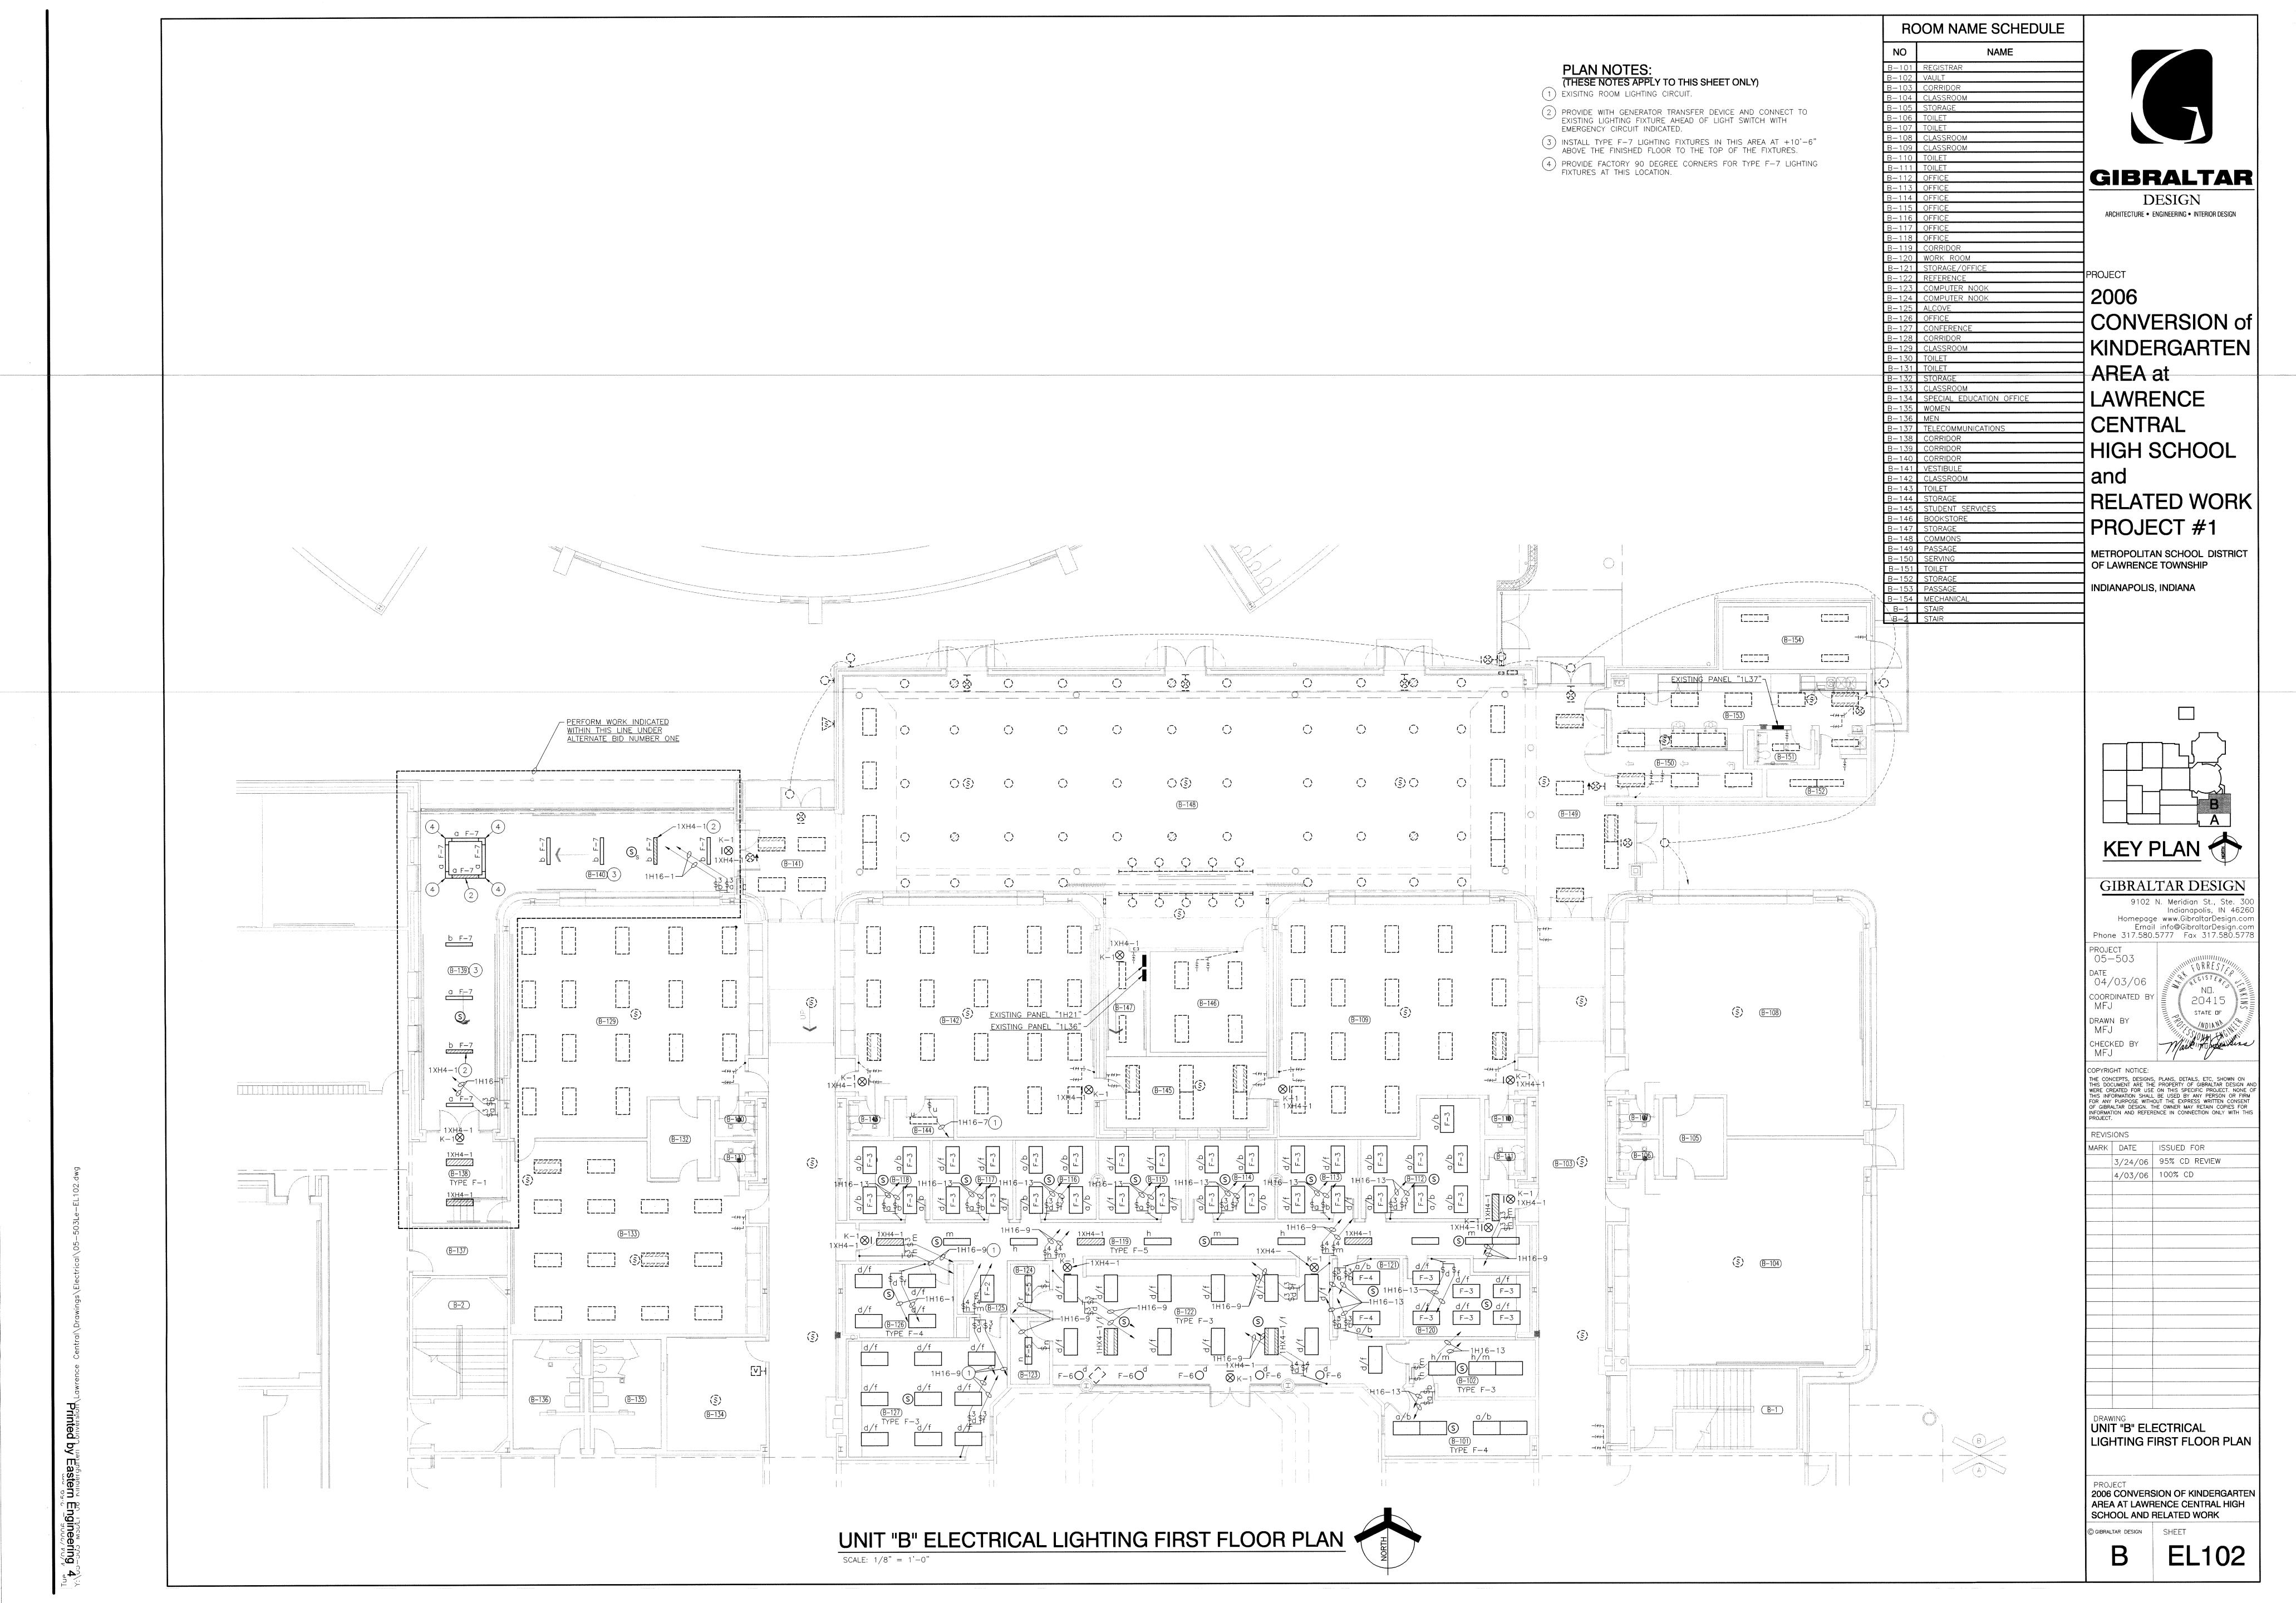

3) CEILING MOUNTED OUTLETS FOR CEILING MOUNTED TELEVISION OUTLET. SEE SPECIFICATION SECTION 16742 AND DETAILS ON SHEET E-601. A-109 CLASSROOM A-110 CLASSROOM
A-111 STORAGE
A-112 TOILET (4) RELOCATED TELEVISION MONITOR AND MOUNT BY OWNER. A-114 LEARNING CENTER
A-115 ADMINISTRATOR
A-116 CORRIDOR A-117 ATRIUM A-118 PASSAGE
A-119 CORRIODR
A-120 CAREER CLASSROOM A-121 LEARNING CENTER -125 STORAGE A-126 CLASSROOM
A-127 CLASSROOM
A-128 STORAGE A-128 STORAGE

A-129 TOILET

A-130 TOILET

A-131 CLASSROOM

A-132 CUSTODIAN

A-133 ELEVATOR EQUIPMENT

A-134 SCHOOL PSYCHOLOGIST

A-135 STAFF LOUNGE

A-136 CORRIDOR EXISTING DATA AND TV SYSTEM EQUIPMENT CABINETS (A-132)(A-104) (A-108)

NAME A-102 CUSTODIAN A-103 WOMEN A-104 CLASSROOM A-106 STORAGE

ROOM NAME SCHEDULE

PLAN NOTES:
(THESE NOTES APPLY TO THIS SHEET ONLY)

1 PROVIDE SURFACE MOUNT STYLE OUTLET BOXES FOR DEVICES.
INSTALL SURFACE MOUNTED BELOW DESK TOP AT +24 INCHES
TO TOP. PROVIDE SURFACE RACEWAY AND CONNECT TO TELE—
POWER POLE.

2 ROUTE POWER AND DATA WIRING DOWN THROUGH TELE-POWER POLE TO FEED OUTLETS IN RECEPTION DESK.

GIBRALTAR DESIGN


ARCHITECTURE • ENGINEERING • INTERIOR DESIGN

CONVERSION of KINDERGARTEN AREA at LAWRENCE CENTRAL HIGH SCHOOL and

PROJECT #1 METROPOLITAN SCHOOL DISTRICT OF LAWRENCE TOWNSHIP

INDIANAPOLIS, INDIANA

RELATED WORK

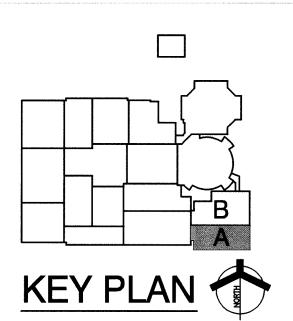

GIBRALTAR DESIGN

9102 N. Meridian St., Ste. 300 Indianapolis, IN 46260 Homepage www.GibraltarDesign.com Email info@GibraltarDesign.com Phone 317.580.5777 Fax 317.580.5778 PROJECT 05-503

04/03/06 COORDINATED E DRAWN BY MFJ CHECKED BY


> COPYRIGHT NOTICE: THE CONCEPTS, DESIGNS, PLANS, DETAILS, ETC, SHOWN ON THIS DOCUMENT ARE THE PROPERTY OF GIBRALTAR DESIGN AND WERE CREATED FOR USE ON THIS SPECIFIC PROJECT. NONE OF THIS INFORMATION SHALL BE USED BY ANY PERSON OR FIRM FOR ANY PURPOSE WITHOUT THE EXPRESS WRITTEN CONSENT OF GIBRALTAR DESIGN. THE OWNER MAY RETAIN COPIES FOR INFORMATION AND REFERENCE IN CONNECTION ONLY WITH THIS PROJECT.

REVISIONS MARK DATE ISSUED FOR

3/24/06 95% CD REVIEW 4/03/06 100% CD

UNIT "A" ELECTRICAL POWER POWER FIRST FLOOR PLAN

2006 CONVERSION OF KINDERGARTEN AREA AT LAWRENCE CENTRAL HIGH SCHOOL AND RELATED WORK

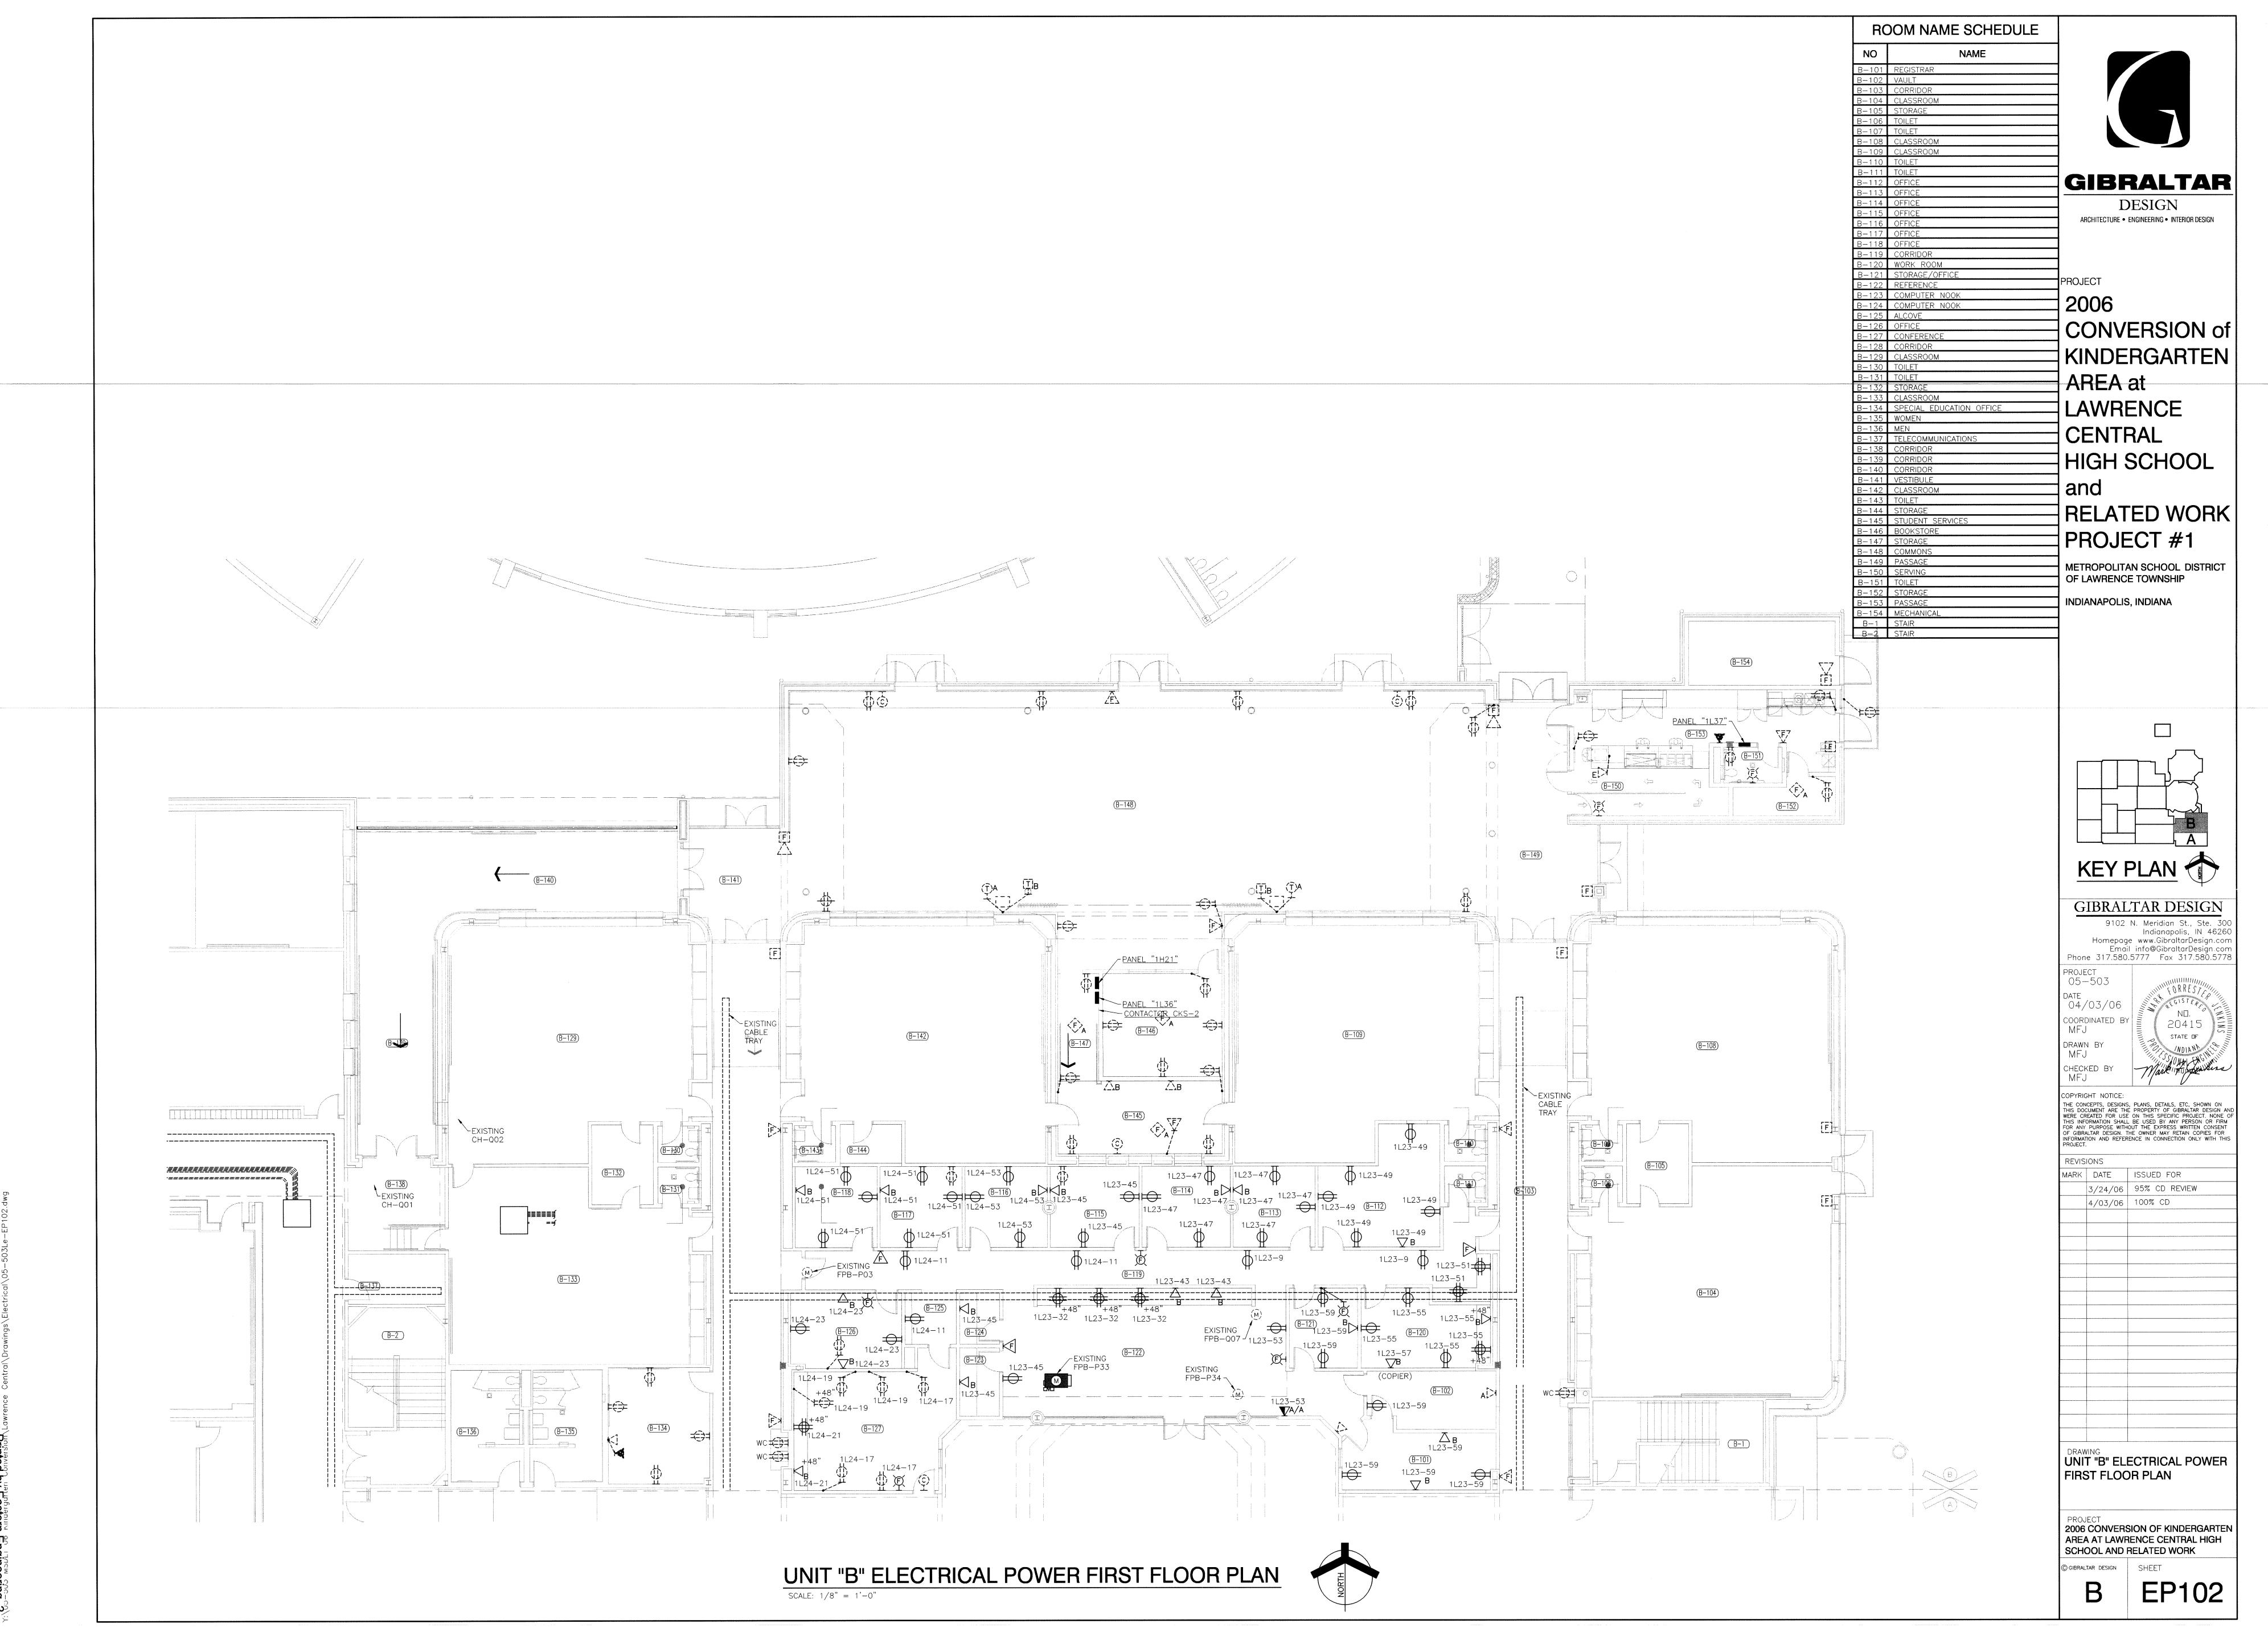

Tillied by Eastern Eligineering

Bunaəuibug usətseg ka pətuild אסיים אוווספרנס אוווספרנסת הייסיים אוויספרנס האסיים אוווספרנס אוווספרנס האסיים אוווספרנסט האסיים אוווספרנסט איס