ADDENDUM NO. 2

October 27, 2022

Carey Ridge Elementary Addition & Renovation 16231 Carey Road Westfield, IN 46074

TO: ALL BIDDERS OF RECORD

This Addendum forms a part of and modifies the Bidding Requirements, Contract Forms, Contract Conditions, the Specifications and the Drawings dated September 30, 2022, by CSO Architects. Acknowledge receipt of the Addendum in the space provided on the Bid Form. Failure to do so may subject the Bidder to disqualification.

This Addendum consists of Page ADD 2-1 through ADD 2-2 and attached Addendum No. 2 from CSO Architects, consisting of two (21) pages, Addendum Drawings: C501, S702, AD203D, A201H, A203H, A210, A403, A405, A407, A409, A410, A411, A412, A420, A421, A601, A611, A800, A801H, A802, MD201D, and M702.

A. SPECIFICATION SECTION 01 12 00 MULTIPLE CONTRACT SUMMARY

1. Paragraph 3.03 Bid Categories

A. Bid Category No. 1 – General Trades

Add the following specification section:

07 21 19 – Spray Foam Insulation

08 91 19 – Fixed Louvers

Revise the following clarification:

16. Provide all exterior wall rigid insulation and foamed-in-place insulation. Bid Category 03 to provide exterior wall rigid insulation for their bid categories scope of work.

Add the following clarification:

18. Include wood trim around the TB-2 modular fabric cork tackable surface.

E. Bid Category No. 5 – Metal Framing, Drywall & Ceilings

Delete the following specification section:

07 21 19 – Spray Foam Insulation

Add the following clarification:

3. Provide flashing between brick and EIFS.

F. Bid Category No. 6 – Floorcovering

Add the following specification section:

03 54 16 – Hydraulic Cement Underlayment

G. Bid Category No. 7 – Casework & Millwork

Add the following clarification:

1. Wood trim around the TB-2 modular fabric cork tackable surface to be provided by Bid Category 01

H. Bid Category No. 8 – Fire Protection, Plumbing & HVAC

Add the following specification section:

07 84 13 – Penetration Firestopping

I. Bid Category No. 9 – Electrical & Technology

Add the following specification section:

07 84 13 – Penetration Firestopping

Add the following clarification:

5. Provide through-penetration firestopping for this categories scope of work.

ADDENDUM



ROBERT

R0090000

ADDENDUM NO: 2

PROJECT: Carey Ridge Elementary School Addition & Renovations

PROJECT NO: 2022020 DATE: 10/27/2022 BY: Brent Hite

This Addendum is issued in accordance with the provisions of "The General Conditions of the Contract for Construction," Article 1, "Contract Documents" and becomes a part of the Contract Documents as provided therein. This Addendum includes:

Addendum Written Explanation Pages:

1 thru 10

Attached Drawing Sheets:

C501, S702, AD203D, A201H, A203H, A210, A403, A405, A407, A409, A410, A411, A412, A420, A421, A601, A611, A800, A801H, A802

PART 2 - GENERAL INFORMATION

2.1 NOT USED

PART 3 - BIDDING REQUIREMENTS

3.1 <u>NOT USED</u>

PART 4 - SPECIFICATIONS

4.1 <u>05 12 00 – STRUCTURAL STEEL FRAMING</u>

- A. Revise the Fabricator qualifications to remove the requirement AISC certification. 1.5, A should be revised to read as follows:
 - The Fabricator shall have 10 years of comparable experience in installations of this type and shall employ labor and supervisory personnel familiar with the type of installation, experienced in fabrication and erection of structural steel for projects of similar size and complexity. The Fabricator's qualifications shall be subject to review by the Architect/Engineer.

4.2 05 45 00 – PREFABRICATED COLD-FORMED METAL TRUSSES

- A. Add the following authorized dealer under 2.1, B:
 - 1. Superior Truss and Panel, Inc.



4.3 <u>06 16 43 – GLASS MAT GYPSUM WALL SHEATHING</u>

- A. Add Part 2.05 ACCESSORIES
 - A. Continuous Aluminum Soffit Vent
 - Basis-of-Design: DRM-625-V-200 by Fry Reglet or a comparable equal approved by the Architect.
 - 2. Clear anodized or mill finish aluminum with louver/slotted style air holes.
 - 3. Sheathing Thickness: Fits over 5/8" thick sheathing.
 - 4. Vent slot width: 2 inches.
 - 5. Face flanges tapered to receive direct applied finish system.

4.4 <u>SECTION 07 21 00 – THERMAL INSULATION</u>

- A. ADD STRONGWELL STRONGIRT TO THE LIST OF ACCEPTABLE MANUFACTURERS FOR THERMALLY BROKEN/ISOLATED COMPOSTE GIRTS.
- 4.5 <u>SECTION 07 21 19 SPRAY FOAM INSULATION</u>
 - A. ADD XCELUS XLS2000 TO THE LIST OF ACCEPTABLE MANUFACTURERS.
- 4.6 <u>SECTION 07 42 43 METAL COMPOSITE PANELS</u>
 - A. ADD ELEMEX ALUMITEX TO THE LIST OF ACCEPTABLE MANUFACTURERS.
- 4.7 <u>SECTION 12 32 16 MANUFACTURED PLASTIC LAMINATE CASEWORK.</u>
 - A. ADD MIDWEST CABINET SOLUTIONS TO THE LIST OF ACCEPTABLE MANUFACTURERS.

PART 5 - DRAWINGS

5.1 <u>KEYNOTE LEGEND</u>

- A. Remove 04 20 00-C, not used.
- B. Remove 04 20 00-E, not used.
- C. Remove 05 40 00-D, not used.
- D. Remove 05 44 00-F, not used.
- E. Remove 05 50 00-B, refer to Keynote 05 12 00-B for steel angle lintels.
- F. Add 06 10 53-G to read 2X10 TREATED WOOD FASCIA.
- G. Remove 07 24 13-B, not used.
- H. Revise 07 62 00-C to read EIFS COMPATIBLE SEALANT.



- I. Remove 07 24 13-H, not used.
- J. Revise 07 31 13-B to read SYNTHETIC UNDERLAYMENT, SEE SPECIFICATIONS.
- K. Revise 07 62 00-B to read ALUMINUM WALL TO ROOF HEADWALL FLASHING, MILL FINISH.
- L. Revise 07 62 00-C to read ALUMINUM EIFS TO BRICK CAP FLASHING w/ SUPPORT CLEAT, MATCH EXISTING FASCIA COLOR.
- M. Add 07 62 00-E to read ALUMINUM STEP FLASHING, MILL FINISH
- N. Revise 07 71 29-A to read ROOF TO ROOF EXPANSION JOINT W/ FLEXIBLE BELLOW MATERIAL.
- O. Add 07 95 00-C to read CEILING EXPANSION JOINT COVER.
- P. Revise 08 41 13-B to read WIDE STILE ALUMINUM ENTRANCE DOOR (NON-THERMAL GLAZING, SEE OPENING SCHEDULE).
- Q. Revise 08 41 13-C to read WIDE STILE ALUMINUM ENTRANCE DOOR (THERMAL GLAZING, SEE OPENING SCHEDULE).
- R. Revise 10 26 00 –A to read "RECESSED CORNER GUARD, SEE EQUIPMENT SCHEDULE.

5.2 <u>C501 – UTILITY PLAN</u>

A. Addition of 120LF of 6" PVC, three (3) terminal cleanouts and three (3) additional downspout connections.

5.3 S702 – SECTIONS AND DETAILS

- A. Section 6/A702
 - 1. Added CFS bent plate to the edge of the overbuild, revised the line of existing structure to be removed, and corrected typographical errors as shown on the attached drawing.

5.4 <u>AD203D – ROOF DEMOLITION PLAN UNIT 'D'</u>

- A. Add Keyed Demolition Notes #25, #26 AND #27.
- B. Revised Keyed Demolition Note #24.

5.5 <u>A201H – FIRST FLOOR PLAN UNIT 'H'</u>

- A. Add Wall Section Tag 3/A411 to Floor Plan
- B. Add Wall Section Tag 5/A412 to Floor Plan
- C. Place additional dimensions on floor plan.



5.6 <u>A202H – ROOF PLAN</u>

A. Add Roof Plan Note #6 to legend.

5.7 <u>A210 – REFLECTED CEILING PLAN UNIT 'H'</u>

A. Add Section Detail Tag 7/A431 to reflected ceiling plan to note soffit expansion joint.

5.8 A403 – PARTIAL BUILDING SECTIONS

- A. Partial Building Section 1/A403
 - 1. Removed keynote adding gypsum sheathing on overbuild end truss.
 - Revised demolition note and linework related to existing hip roof and eave below new overbuild.

5.9 <u>A404 – PARTIAL BUILDING SECTIONS (**DRAWING NOT REISSUED**)</u>

- A. Partial Building Section 2/A404
 - 1. Revise Keynote 05 40 00-D to 05 40 00-N which reads 6" 16GA. GALVANIZED STEEL STUDS @ 16" O.C.

5.10 A405 – PARTIAL BUILDING SECTIONS

A. Revised structure and bulkhead near interior vestibule door to coordinate with structural section drawing in this area.

5.11 A407 – PARTIAL BUILDING SECTIONS

A. Added metal stud framing suspended from roof trusses at midspan of deep soffit framing to reduce free span.

5.12 <u>A408 – WALL SECTIONS (**DRAWING NOT REISSUED**)</u>

- A. Wall Section 1/A408
 - 1. Revise Keynote 09 29 00-D to 09 29 00-B to refer to gypsum board and not sound attenuation batt insulation.

5.13 A409 – WALL SECTIONS

- A. Wall Section 3/A409
 - 1. Removed rake overhang dimension, refer to Section Detail 4/A420 for dimension.
 - 2. Added note to provide sheet metal water diverter at bottom of lower rake wall roof slope to divert water into gutter.



5.14 <u>A410 – WALL SECTIONS</u>

A. Wall Section 1/A410

- Revised existing eave and rake condition shown in background of wall section. Includes new EIFS rake wall and aluminum clad rakeboard. Existing gutter and fascia condition shown.
- 2. Added EIFS reveal elevations for tall Mechanical Room exterior wall.
- 3. Added additional keynotes to specify plywood at louver opening jambs and sill.

B. Wall Section 2/A410

- 1. Revised keynote for end overbuild truss and removed gypsum sheathing.
- 2. Added keynote for ceiling expansion joint cover.
- Revised bulkhead studs connecting them to existing edge beam.
- Added note referring to structural drawings for existing to new slab edge tie-in.

5.15 <u>A411 – WALL SECTIONS</u>

- A. Wall Section 1/A411
 - 1. Revised keynotes and linework for new rake eave condition.
- B. Wall Section 2/A411
 - Revised rake overhang dimension.
- C. Add New Wall Section 3/A411, refer to revised floor plan this addendum for section tag location.

5.16 A412 – VERTICAL CIRCULATION SECTIONS AND DETAILS

A. Add Wall Section 5/A412, refer to revised floor plan this addendum for section tag location.

5.17 A420 – SECTION DETAILS

- A. Section Detail 3/A420
 - 1. Revised dimensions.
- B. Section Detail 3/A420
 - 1. Revised dimensions and keynotes.

5.18 <u>A421 – SECTION DETAILS</u>

- A. Section Detail 1/A421
 - 1. Revised dimensions and keynotes.



- B. Section Detail 2/A421
 - 1. Revised dimensions and keynotes.
- C. Section Detail 3/A421
 - 1. Revised dimensions and keynotes.
- D. Section Detail 4/A421
 - 1. Revised dimensions and keynotes.
- E. Section Detail 5/A421
 - 1. Revised keynotes.
- F. Add New Section Detail 6/A421
- G. Add New Section Detail 7/A421
- H. Add New Section Detail 8/A421

5.19 <u>A601 – INTERIOR ELEVATIONS</u>

- A. 2/1601 CORRIDOR H101 NORTH ELEVATION
 - 1. REVISE TS1 TO **FW1**
- B. 5/A601 FLEX AREA H125 EAST ELEVATION
 - 1. REVISE TS1 TO FW1
 - 2. ADD MISSING WALL HATCH AS SHOWN ON REVISED SHEET.
- C. 6/A601 CORRIDOR H120 EAST ELEVATION
 - 1. REVISE TS1 TO **FW1**

5.20 <u>A611 – CLASSROOM ELEVATIONS / MILLWORK PLANS & DETAILS</u>

- A. ADD MILLWORK FINISH TAG **PL3** TO 11/A611 MILLWORK ELEVATION AS SHOWN ON REVISED SHEET.
- B. Add drawing notes to document existing electrical devices to remain, new raceway and trenching for electrical devices associated with island desk.

5.21 <u>A800 – FINISH LEGEND AND NOTES</u>

A. REVISE C1 MFR: MILLIKEN



COLLECTION: GHOST ARTIST

STYLE: TRACE

COLOR: TO MATCH EXISTING CHICANERY TRC67-108

SIZE: 50CM X 50CM INSTALL: QUARTER TURN

LOCATION: CLASSROOMS, CORRIDORS

B. REVISE LVT1

MFR: MANNINGTON COMMERICAL COLLECTION: COLOR ANCHOR

STYLE: STRIDE GROOVE COLOR: LONDON FOG C119

SIZE: 6" X 36"

INSTALL: ASHLAR, DIRECTION OF INSTLL NOTED BY ARROW

LOCATIONS: CLASSROOM, CONFERENCE

C. REVISE SV1

MFR: MANNINGTON COMMERICAL

COLLECTION: BLOOM

STYLE: WOVEN HETEROGENEOUS SHEET WELLSPRING

COLOR: TBD VIDA B305 SIZE: 9'-0" ROLLED GOOD LOCATION: SECLUSION ROOMS NOTE: WELD ROD TO MATCH

D. REVISE B1

MFR: TO MATCH EXISTING TARKETT

STYLE: RUBBER COVE

COLOR: TO MATCH EXISTING FAWN 80

SIZE: 4"

LOCATION: GENERAL WALL BASE

E. REVISE P1

MFR: TO MATCH EXISTING SHERWIN WILLIAMS

COLOR: TO MATCH EXISTING (CORRIDOR FIELD) **SW7064 PASSIVE**LOCATION: IDF, ELECTRICAL, STORAGE, AND AS INDICATED ON PLAN
NOTE: DRAWDOWN SUBMITTAL TO BE REVIEWED ON SITE FOR APPROVAL

F. REVISE P3 **NOT USED**

MFR: TO MATCH EXISTING COLOR: TO MATCH EXISTING LOCATION: CLASSROOMS

NOTE: DRAWDOWN SUBMITTAL TO BE REVIEWED ON SITE FOR APPROVAL

G. REVISE P4

MFR: TO MATCH EXISTING SHERWIN WILLIAMS
COLOR: TO MATCH EXISTING SW6254 LAZY GRAY



LOCATION: OFFICES

NOTE: DRAWDOWN SUBMITTAL TO BE REVIEWED ON SITE FOR APPROVAL

H. REVISE P5

MFR: TO MATCH EXISTING SHERWIN WILLIAMS

COLOR: TO MATCH EXISTING (CORRIDOR FIELD) SW6474 RAGING SEA

LOCATION: HOLLOW METAL DOORS AND FRAMES

NOTE: DRAWDOWN SUBMITTAL TO BE REVIEWED ON SITE FOR APPROVAL

I. REVISE P7

MFR: TO MATCH EXISTING SHERWIN WILLIAMS

COLOR: TO MATCH EXISTING SW7679 GOLDEN GATE

LOCATION: VESTIBULE CEILING

NOTE: DRAWDOWN SUBMITTAL TO BE REVIEWED ON SITE FOR APPROVAL

J. REVISE EP1

MFR: TO MATCH EXISTING SHERWIN WILLIAMS

COLOR: TO MATCH EXISTING (LIGHT FIELD) SW7064 PASSIVE

LOCATION: CORRIDORS, VESTIBULES

NOTE: DRAWDOWN SUBMITTAL TO BE REVIEWED ON SITE FOR APPROVAL

K. REVISE EP2

MFR: TO MATCH EXISTING SHERWIN WILLIAMS

COLOR: TO MATCH EXISTING (DARK ACCENT) SW7067 CITYSCAPE

LOCATION: CORRIDOR ACCENT, VESTIBULES

NOTE: DRAWDOWN SUBMITTAL TO BE REVIEWED ON SITE FOR APPROVAL

L. REVISE PL1

MFR: - WILSONART

STYLE: - MISTED ZEPHYR 4843-60

FINISH: BUDGET PREMIUM FINISH MATTE

LOCATION: GENERAL COUNTERTOPS

M. REVISE PL2

MFR: - **NEVAMAR**

STYLE: - WHITE KENETIC AW1800T

FINISH: BUDGET PREMIUM FINISH TEXTURED

LOCATION: GENERAL CASEWORK

N. REVISE PL3

MFR: - ARBORITE

STYLE: - RIFT NATURAL OAK

FINISH: BUDGET PREMIUM FINISH EVERGRAIN

LOC



O. ATION: RECEPTION CASEWORK

P. REVISE SS1

MFR: - **CORIAN** STYLE: - **DOVE**

LOCATION: COUNTERTOPS WITH SINKS & WINDOW STOOLS IN H102, H106, H107, & H110

EDGE: MITERED EDGE EASED EDGE

NOTE: BUDGET MID GRADE SOLID SURFACE

Q. REVISE **SS2 NOT USED**

MFR: -STYLE: -

LOCATION: WINDOW STOOLS

EDGE: MITERED EDGE

NOTE: BUDGET MID GRADE SOLID SURFACE

R. REVISE SS3

MFR: - CORIAN

STYLE: - ARTISTA GRAY

LOCATION: RECEPTION COUNTERTOP

EDGE: MITERED EDGE

NOTE: BUDGET MID GRADE SOLID SURFACE

S. REVISE SS4

MFR: - CORIAN

STYLE: - SILVER BIRCH

LOCATION: RECEPTION TRANSACTION TOP

EDGE: MITERED EDGE

NOTE: BUDGET MID GRADE SOLID SURFACE

T. REVISE TS1

MFR: CLARIDGE

STYLE: CORK BULLETIN BOARD

COLOR: 1103 OYSTER

LOCATION: TB-1, TB-3, AND TB-4 AS INDICATED ON A901

U. ADD FW1 FABRIC WRAPPED TACK SURFACE

MFR: CARNEGIE XOREL

STYLE: TBD COLOR: TBD

LOCATION: CORRIDORS, TB-2 AS INDICATED ON A901

- V. REVISE GENERAL FINISH NOTE 26 TO READ "...RUN FULL PANEL WIDTH (4'-0") **AFF**. COLOR..."
- W. REVISE FINISH PLAN NOTE F4 TO READ "...LEVEL LINE. REFERENCE A600S A601 FOR DETAILS."



- X. REVISE FINISH PLAN NOTE F12 TO READ "...INCLUDING PAINT COLOR, QUALITY AND FINISH AND BASE MATCH TO INCLUDE STYLE, HEIGHT AND COLOR. REPLACE BASER FROM NEAREST INSIDE CORNER OR DOOR FRAME TO NEAREST INSIDE CORRE OR DOOR FRAME."
- Y. ADD LEADER LINES TO ELEVATIONS 2/A800 AND 3/A800 AS SHOWN ON REVISED SHEET.

5.22 <u>A801H – FINISH PLAN – UNIT H</u>

- A. REPLACE ALL INSTANCES OF WALL FINISH TAG P3 WITH WALL FINISH TAG P1.
- B. ADD FINISH PLAN TAG **F11** TO CORRIDOR H101 AS SHOWN ON REVISED SHEET.
- C. ADD DIRECTIONAL INSTALL ARROWS TO THE FOLLOWING ROOMS AS SHOWN ON REVISED SHEET: STORAGE H109C, H112, H115C, H122C, H123C, H124C, H125C, H126C, H127C
- D. REVISE DIRECTIONAL INSTALL ARROWS IN VESTIBULE H108 AS SHOWN ON REVISED SHEET.
- E. ADD WALL FINISH TAGS **WT1** AND **WT2** TO TOILET H118.
- 5.23 <u>A802 ENLARGED RESTROOM FINISH PLANS (ALTERNATE)</u>
 - A. ADD FLOOR FINISH TAG **EF2** AND FLOOR FINISH EXTENTS TO EXISTING NURSES RR E111A.

PART 6 - QUESTIONS AND ANSWERS

6.1 NOT USED

END ADDENDUM #1

ADDENDUM 02

October 27, 2022

Westfield-Washington Schools

Carey Ridge Elementary School – Addition and Renovations

Mussett, Nicholas & Associates, Inc. 502 S. West St Indianapolis, IN 46225 MNA Commission No.: 2022095

TO ALL HOLDERS OF PROCUREMENT DOCUMENTS

This Addendum forms a part of the Contract Documents and modifies the original Procurement Documents dated 9/30/2022 and any previously issued Addenda, as noted below. Acknowledge receipt of this Addendum in the space provided on the Bid Form. Failure to do so may subject bidder to disqualification.

RESPONSES TO QUESTIONS RECEIVED

- Item No. 1 e-Quipment Solutions asked if the following equipment vendors would considered as acceptable manufacturers
 - a. VTS AMERICA
 - b. CANARM HVAC
 - c. WARREN TECHNOLOGY
 - 1. ANSWER: MNA is not familiar with these products and will not be consider them as acceptable manufacturers.
- Item No. 2 Specified Lighting Systems of Indiana asked to update fixture types for A3, A4, A3E, A4E, and H2.
 - 1. ANSWER: This is acceptable. See updated light fixture schedule.

CHANGES TO SPECIFICATIONS

Item No. 1 Section 23 73 13.13 – INDOOR, BASIC AIR HANDLING UNITS

Section 2.3 Paragraph A

1. Added acceptable manufacturer: PACE Air Systems

CHANGES TO DRAWINGS

Item No. 1 Sheet M601- MECHANICAL SCHEDULES


- A. Revised Disconnect section of "FAN SCHEDULE" from "Manufacturer" to "DIV 26".
- B. Revised Volts/Hertz/Phase section of "FAN SCHEDULE"

	SPECIFICATION SECTION	-	-	-	-
	CFM	11,000	9,300	900	400
ΙĔ	OUTLET VEL.	2,130	1,770	830	520
\§ ₹	STATIC PRESS	4.0	1.75	1	0.3
FAN OPERATING DATA	RPM	1,770	1,170	1,725	1,550
	ВНР	12.3	6.0	~~~~~~~~~~~~~~~~~~~~~~~~~~~~~~~~~~~~~~	
	VOLTS/HERTZ/PHASE	460/60/3	460/60/3	208/60/1	208/60/1
ي⊵	MOTOR RPM	1,770	1,770	\ \ \ \ \ \ \ \ \ \ \ \ \ \ \ \ \ \ \	~~ ~~~~~~~~~~~~~~~~~~~~~~~~~~~~~~~~~~~
MIS DA:	MOTOR RPM DRIVE ARRGT	DIRECT	DIRECT	DIRECT	DIRECT
	WT. LBS.	725	884	80	195
	FAN EFF	62	62	46	51
~	TYPE	VFD	VFD		
STARTER	MEMA ENCL	-			-
AR	MOUNT	-			-
S	SPECIAL CONTROL	-			-
5	NEMA ENCL.	-	-	-	-
DIS- CONNECT	MOUNT	$\sim\sim\sim\sim$	$\gamma \gamma \gamma \gamma \gamma \gamma$		
[-홍	FURN. BY	DIV 26	DIV 26	MANUFACTURER	MANUFACTURER
OTE	CONTROLS BY SPECIFICATION SECTION	$\overline{\mathcal{L}}$			
CONTE	FURN. BY CONTROLS BY SPECIFICATION SECTION FURNISHED BY	-	-	-	


Item No. 2 Sheet M602 – MECHANICAL SCHEDULES

- A. Revised Volts/Hertz/Phase section of "UNIT HEATER SCHEDULE"
- B. Added remarks to "WATER BOILER SCHEDULE (FUEL-FIRED)" schedule.


	OUTSIDE AIR FLOW (CFM)	0
1	TOTAL AIR FLOW (CFM)	211
z	EXTERNAL STATIC PRESSURE (IN. W.C.)	0.05
	TOTAL STATIC PRESSURE (IN. W.C.)	
FAN	SPEED	980/840/665
1	MOTOR HORSEPOWER	0.03
1 4	MOTOR POLL LOND AMPS	
Ις	MOTOR VOLTZ/HERTZ/PHASE	208/60/1
	FLUID BERCENTAND TYPE	1902 WATER
吊厂	FLUID FLOW RATE (GPM)	0.97
OT WATER SUPPLY	ENTERING FLUID TEMPERATURE (°F)	120
₹§	LEAVING FLUID TEMPERATURE (°F)	105
HOT SUS	MAX FLUID PRESSURE DROP (FT OF WATER)	4.1
	NUMBER OF ROWS	2
z	TYPE	BY MFR.

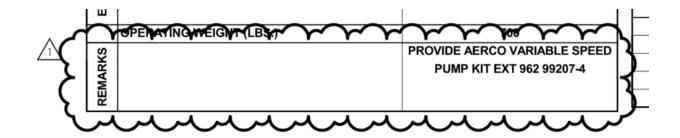


- Item No. 3 Sheet MD201D PARTIAL FLOOR PLAN DEMOLITION MECHANICAL PIPING
 - A. Includes demolition of CUH-4 and associated piping in Vestibule C161.
 - B. Newly issued. Refer to attached drawing.
- Item No. 4 SHEET M702 MECHANICAL P&IDs
 - A. Added sequence of controls. Refer to attached drawing.
- Item No. 5 Sheet E001 EXTERIOR LIGHTING PLAN
 - A. Fixed typo.

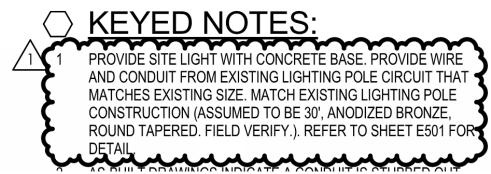


- B. Modified keyed note 1 to match pole type in light fixture schedule.
- Item No. 6 Sheet E101 PARTIAL LIGHTING PLAN UNIT 'H'
 - A. Rotated lights in H109, H115, and H117.

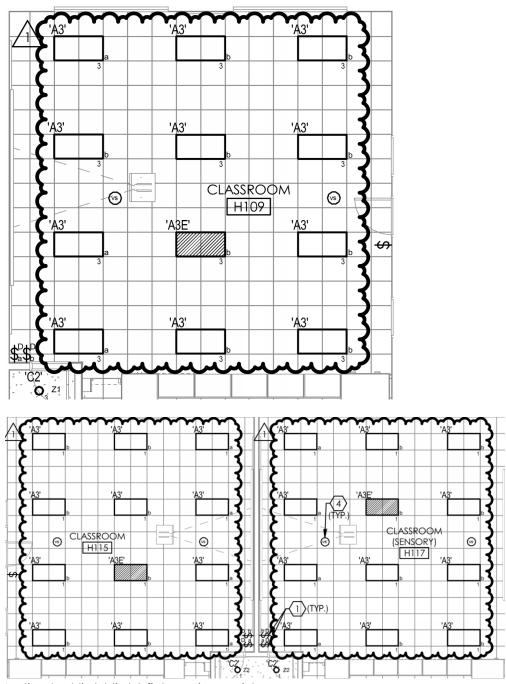

B. Indicated light light fixtures in corridors.

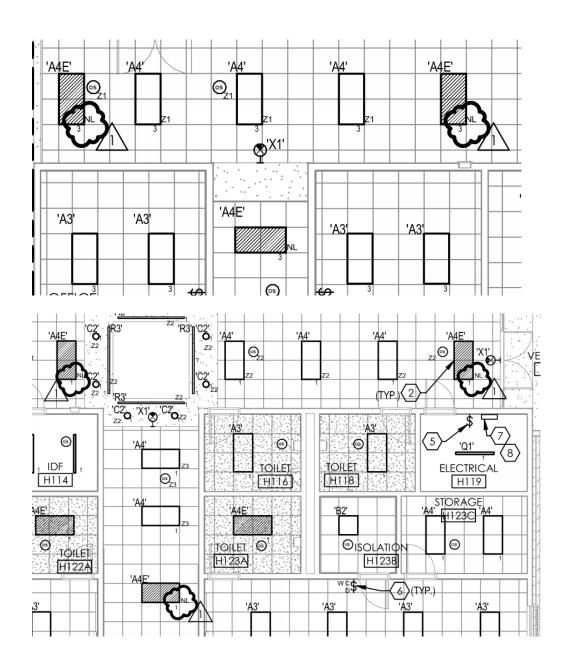


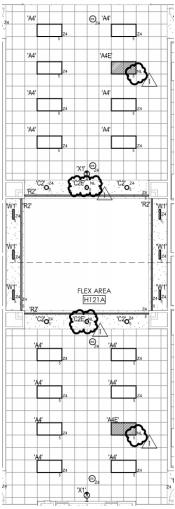


C. Modified lighting layout in Storage H123 to match Storage H122C.

Item No. 7 Sheet E201 – PARTIAL POWER PLAN – UNIT 'H'

A. Indicated mechanical tags for equipment.

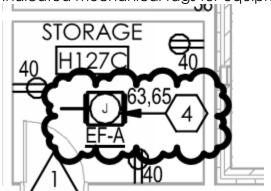

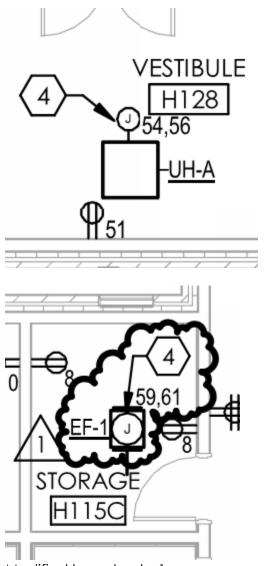


B. Modified keyed note 1.




Item No. 8 Sheet E301 – PARTIAL SIGNAL PLAN – UNIT 'H'

- A. Removed extra leader for keyed note 1.
- B. Moved ceiling camera to correct location.

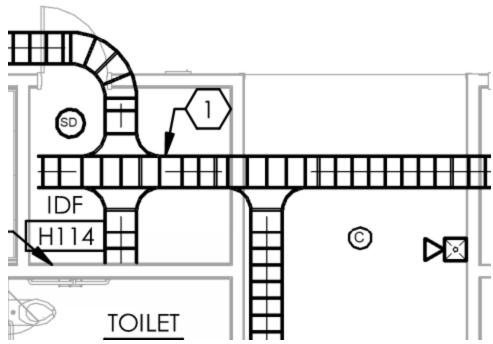


C. Indicated ceiling-mount camera locations in corridors.

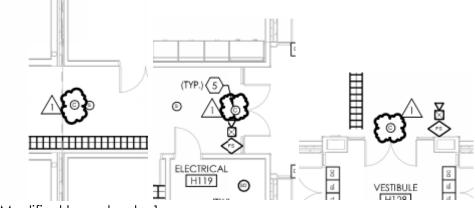

Item No. 9 Sheet E401F - PARTIAL POWER PLAN MECHANICAL ROOM UNIT 'F'

- A. Modified keyed note 1.
- B. Added keyed notes 2, 3, and 4.

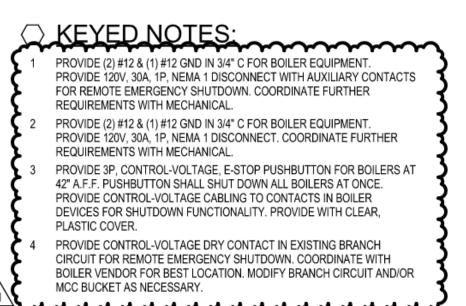

- C. Added disconnects for boiler equipment.
- D. Added emergency stop shutdown button.

E.

Item No. 10 Sheet E601 - ELECTRICAL SCHEDULES

A. Indicated a 250A MCB for 'RPJ'.



B. Modified light fixture types as indicated above from contractor question No. 2.




Item No. 11 Sheet E602 - ELECTRICAL SCHEDULES

A. Updated RPC per E401F.

7	\sim	~~	\sim	~~	44	20/1	M/P VIDEO PROJECTOR
1	1.0	1.0			46	20/1	B−3 —
•			0.7	1.0	48	20/1	HWP−1
•					50	20/1	SPARE
7	_	_			52	20/1	SPARE
Ļ			_	_	54	20/1	SPARE
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ζ	_	_			58	20/1	SPARE
			_	0.2	60	20/1	EXTERIOR DOOR POWER
-					62	20/1	SPARE
1	_	_			64	20/1	SPARE
			_	_	66	20/1	SPARE
					68	20/1	SPARE
7	_	_			70	20/1	SPARE
_			_	_	72	20/1	SPARE
٤	1.	3.3	1	2.2	(115	FLA)	

Item No. 12 Sheet E701 – ELECTRICAL ONE-LINE DIAGRAM


A. Indicated a 250A MCB for 'RPJ'.

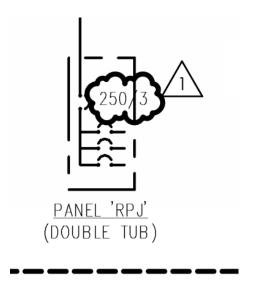

By: _____ David Bailey

Attachments: MD201D, M702

END OF ADDENDUM 2

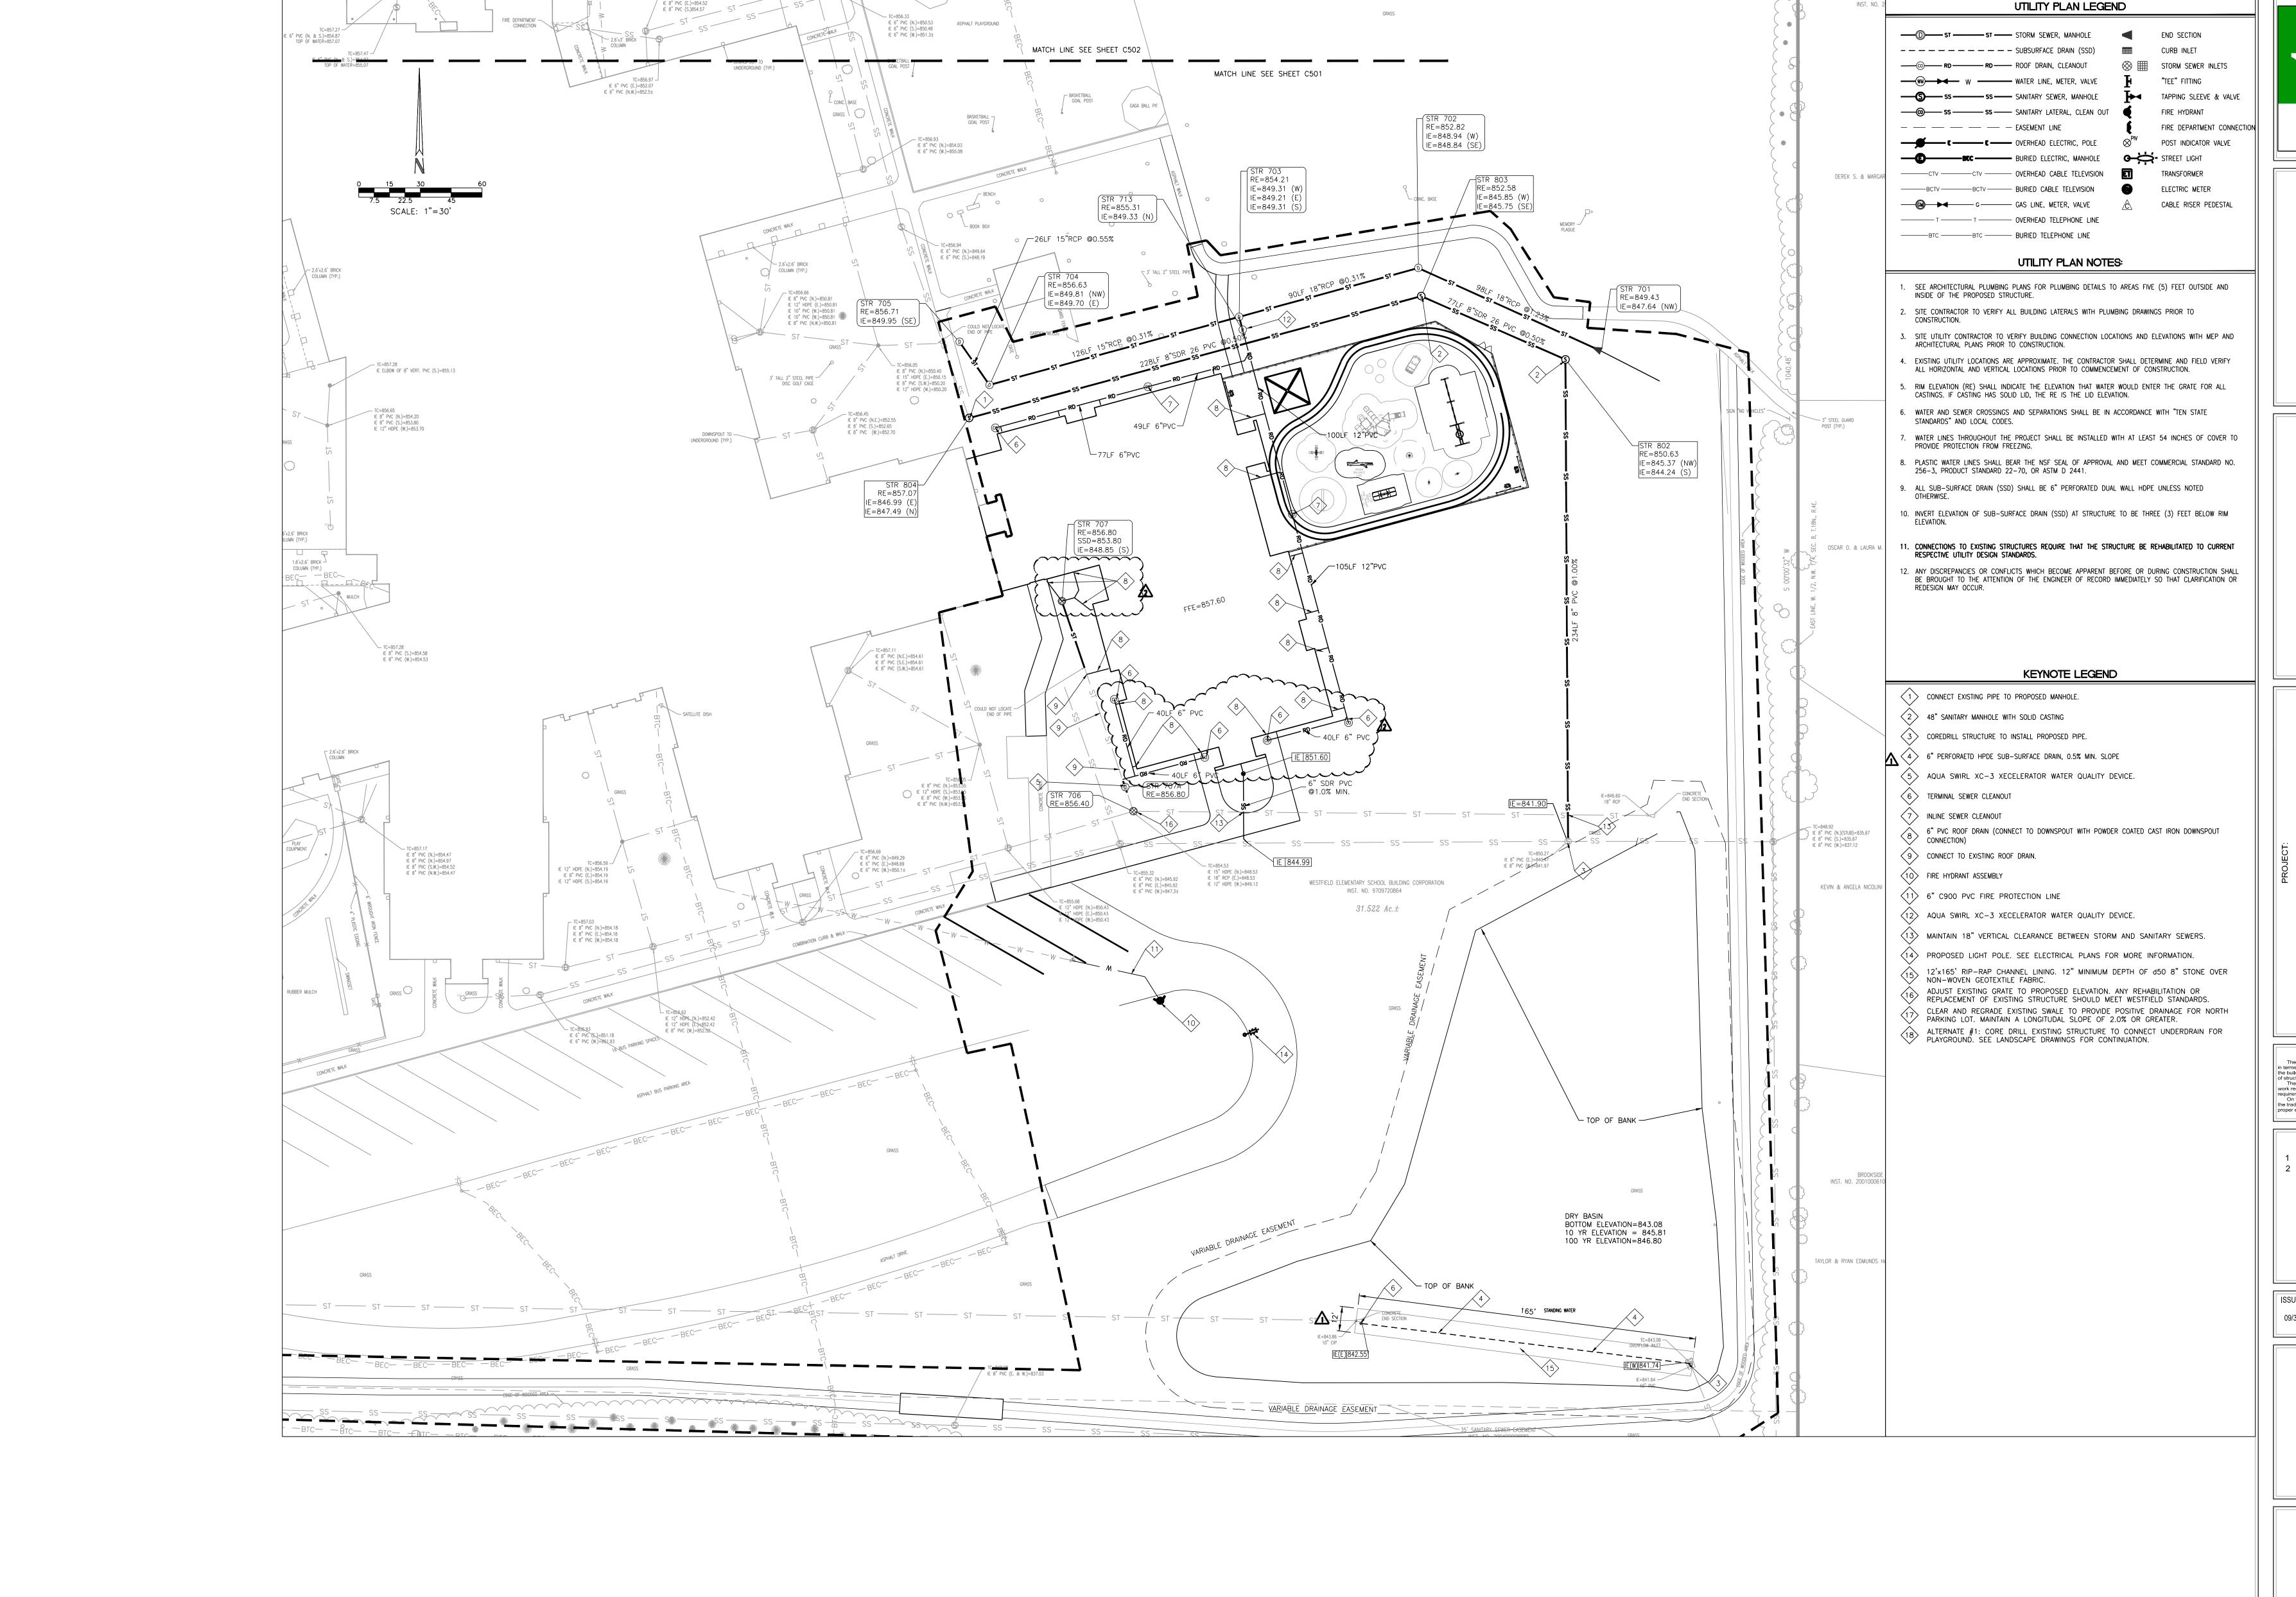



SST Reystone Coosting, historycolds, 11 452

'estfield Washington School Corp.
ADDITION & RENOVATIONS TO
REY RIDGE ELEMENTARY
CAREY ROAD, WESTFIELD, INDIANA 46074

SCOPE DRAWINGS:

These drawings indicate the general scope of the project in terms of architectural design concept, the dimensions of the building, the major architectural elements and the type of structural, mechanical and electrical systems.

The drawings do not necessarily indicate or describe all work required for full performance and completion of the requirements of the Contract.

On the basis of the general scope indicated or described, the trade contractors shall furnish all items required for the proper execution and completion of the work.

ADDENDUM #01 10-14-22 ADDENDUM #02 10-27-22

REVISIONS:

ISSUE DATE DRAWN BY CHECKED BY
09/30/2022 DK, PE SP, PE

UTILITY PLAN

UTILITY PLAN

DRAWING TITLE:

SEV PIER ARTHUM

NO. PE11600721

STATE OF

STATE OF

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NO. PE11600721

STATE OF


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NO. PE11600721

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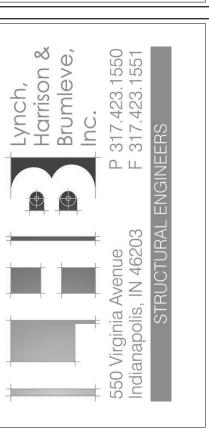
PROJECT NUMBER
2022020

CRIPE No. 220090-20000



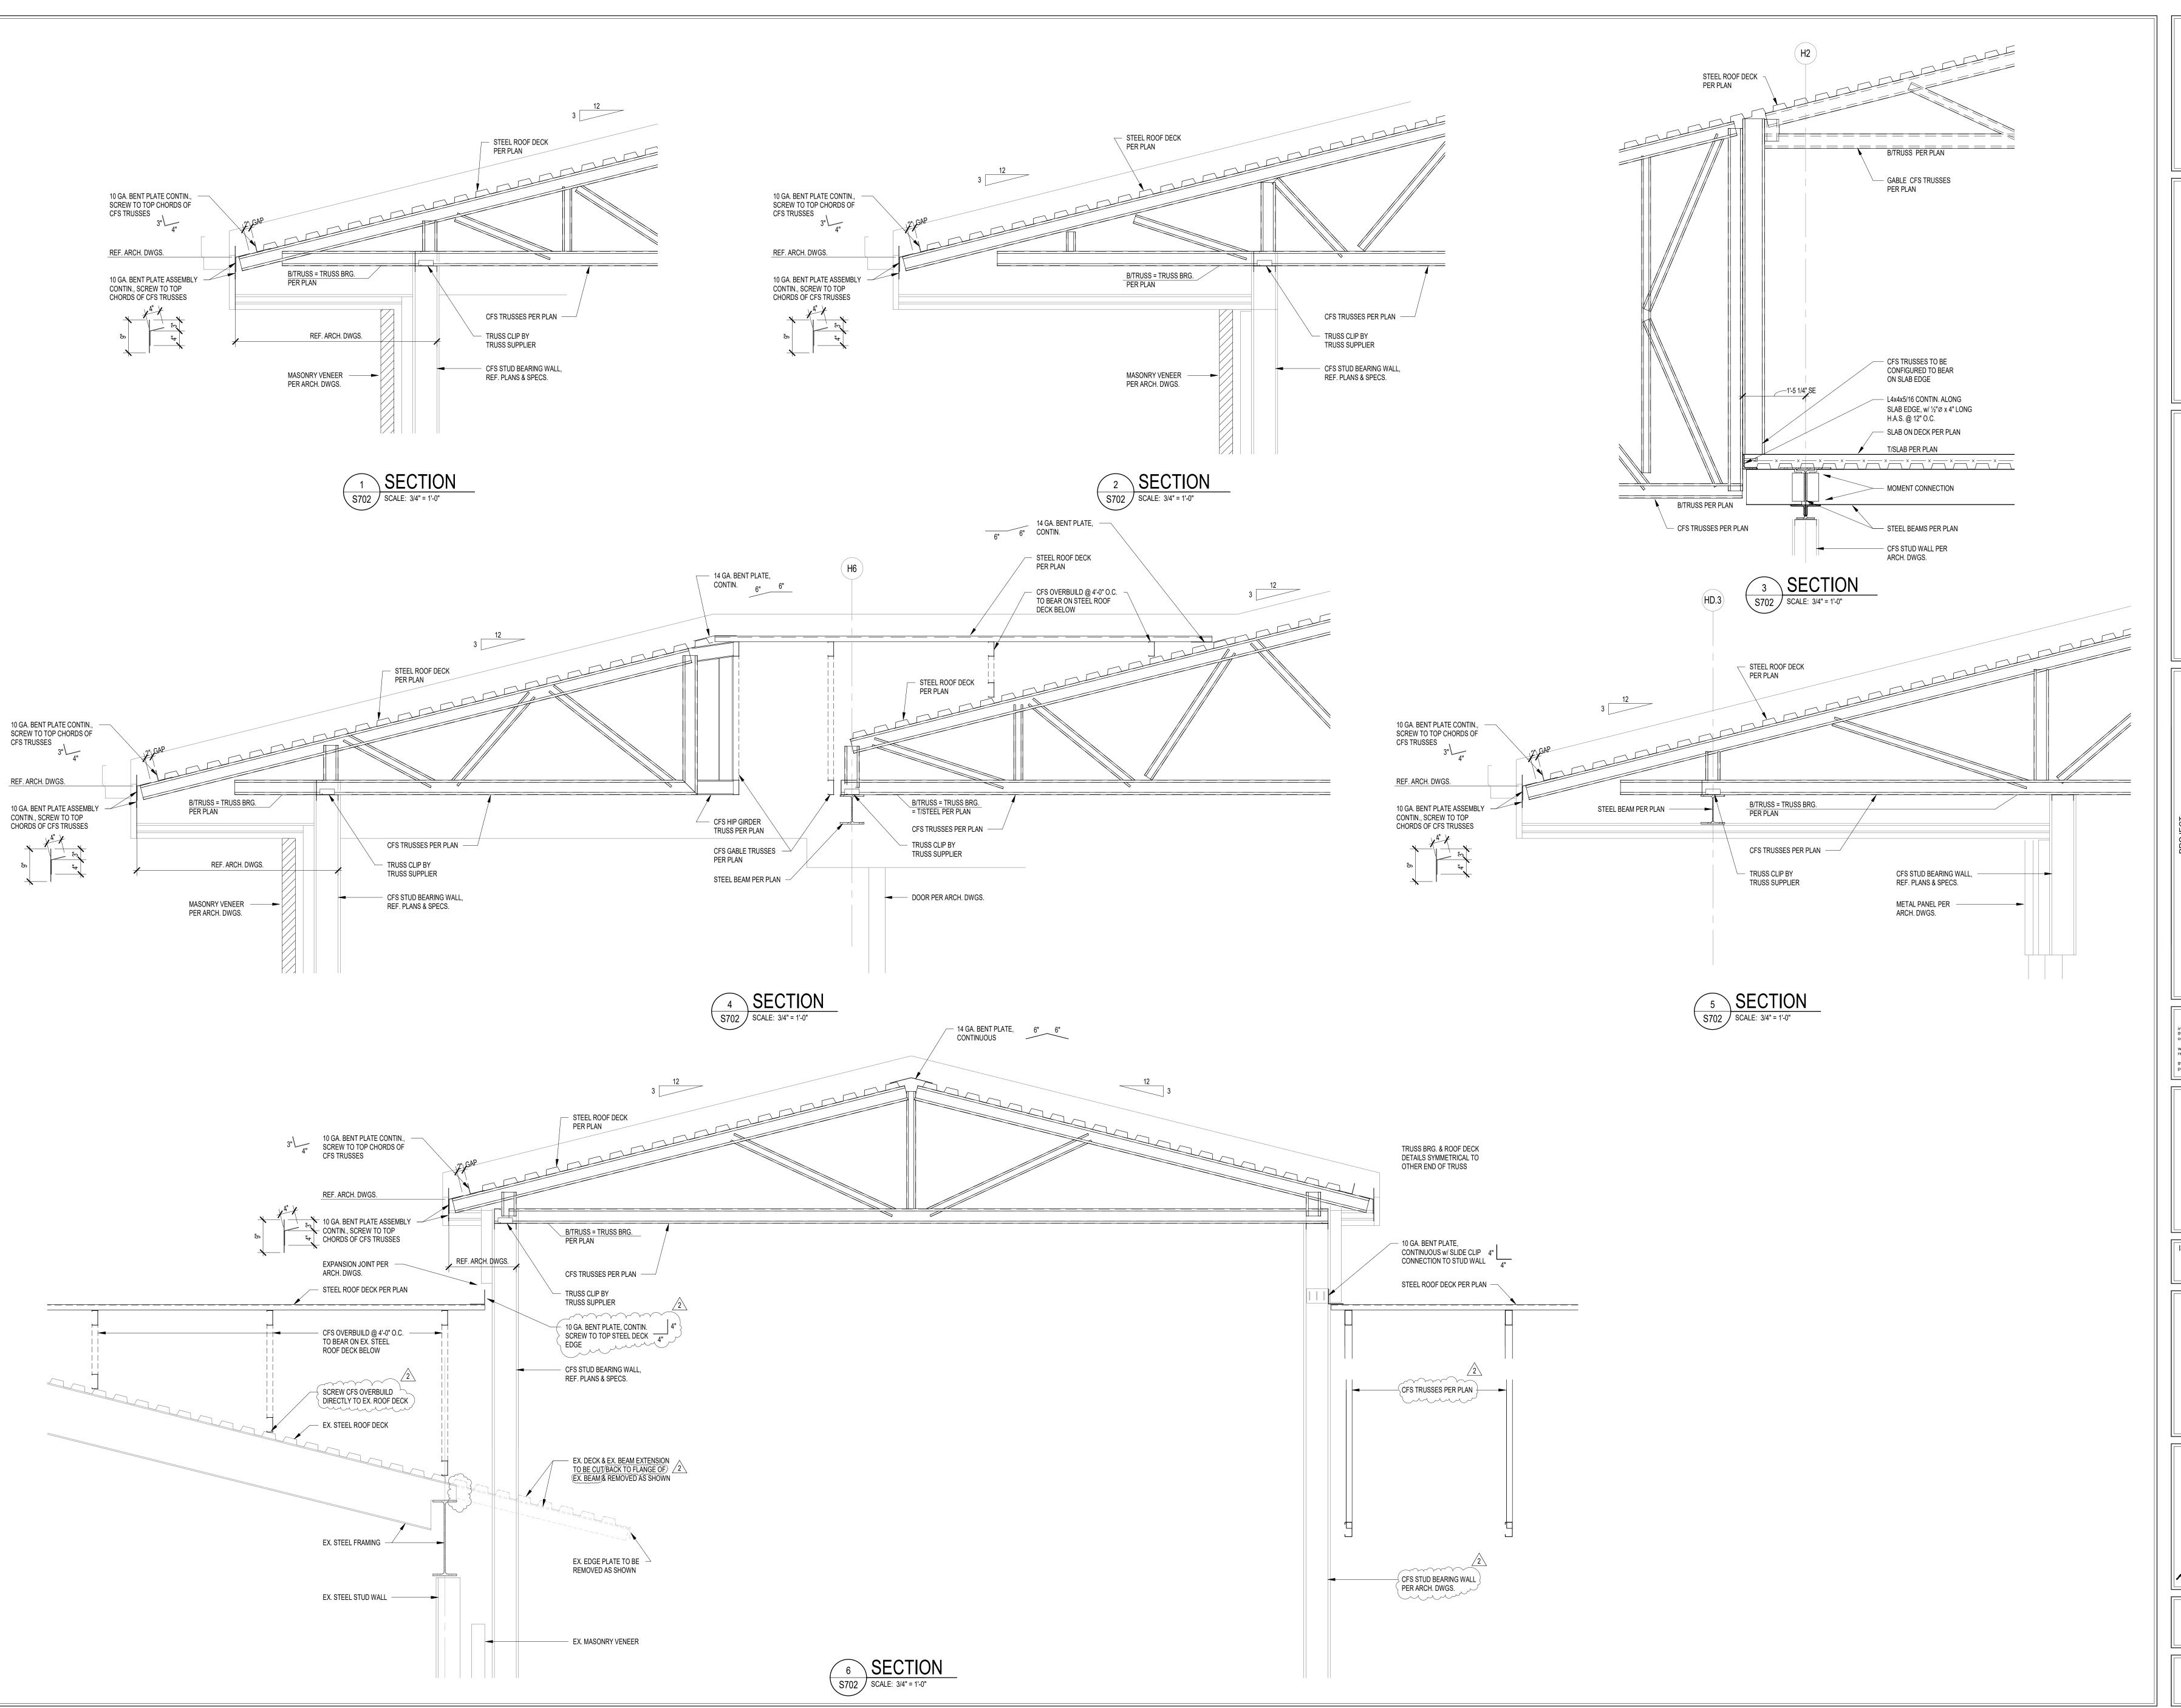

S831 Keystone Crossing, Indianapolis, IN 46240



Westfield Washington Schools
ADDITION & RENOVATION TO
CAREY RIDGE ELEMANTARY
16231 CAREY ROAD, WESTFIELD, INDIANA 46074

SCOPE DRAWINGS:

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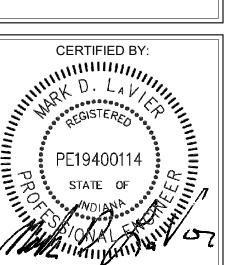
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REVISIONS:
Addendum #2 10/27/2022

ISSUE DATE | DRAWN BY | CHECKED BY | 09/30/2022 | MDL | MDL

DRAWING TITLE:
ECTIONS AND
DETAILS



S702



GENERAL DEMOLITION NOTES

- A. HEAVY DASHED LINES INDICATE STRUCTURE, WALLS AND ITEMS TO BE DEMOLISHED UNLESS NOTED OTHERWISE. B. SOLID LINES INDICATE STRUCTURE, WALLS, & ITEMS TO REMAIN, UNLESS NOTED OTHERWISE. C. PROTECT ALL FINISHES, EQUIPMENT & OTHER ITEMS TO REMAIN. WHERE DAMAGE OCCURS, PATCH AND REPAIR OR OTHERWISE RESTORE TO ITS ORIGINAL CONDITION OR REPLACE. D. CONTRACTOR SHALL FIELD VERIFY ALL EXISTING CONSTRUCTION
- AND RELATED CONDITIONS PRIOR TO STARTUP OF DEMOLITION OR NEW CONSTRUCTION. COORDINATE EXTENTS AND EXACT DIMENSIONS WITH EXTENTS AND EXACT DIMENSIONS OF NEW WORK.
- IMMEDIATE ATTENTION OF THE ARCHITECT AND OWNER. G. REMOVE ALL MISCELLANEOUS EQUIPMENT ATTACHED TO WALLS, FLOORS AND CEILINGS TO BE DEMOLISHED. COORDINATE WITH THE OWNER FOR ITEMS TO BE SALVAGED OR RE-INSTALLED. H. REMOVE ANY ITEMS NOT SPECIFICALLY IDENTIFIED TO BE REMOVED WHICH MUST OBVIOUSLY BE DEMOLISHED TO ACCOMMODATE NEW WORK. VERIFY WITH ARCHITECT. I. ALL OPENINGS, VOIDS, OR DAMAGED SURFACES LEFT BY THE REMOVAL OF EXISTING CONSTRUCTION, EQUIPMENT, PIPING, DUCTS, WINDOWS, ETC., SHALL BE PATCHED & REPAIRED TO

F. ANY AND ALL DISCREPANCIES SHALL BE BROUGHT TO THE

- MATCH SURROUNDING WORK. PREPARE TO RECEIVE NEW FINISHES AS REQUIRED. REMOVE ALL MASTIC, ADHESIVES, FASTENERS AND OTHER MATERIALS WHERE FINISHES (SUCH AS FLOORING, BASE) AND EQUIPMENT (SUCH AS CASEWORK, TACKBOARDS, MARKERBOARDS, MECHANICAL ITEMS, ETC.) HAVE BEEN REMOVED AT EXISTING SURFACES TO REMAIN.
- START OF WORK. L. SEE SPECIFICATIONS FOR ASSIGNMENT OF RESPONSIBILITIES PERTAINING TO PATCHING AND REPAIR WORK REQUIRED OF EACH

K. CONSTRUCT DUST AND SOUND CONTROL BARRIERS PRIOR TO THE

- M. DEMOLITION WORK TO BE COMPLETED BY MECHANICAL/PLUMBING, ELECTRICAL TRADES IS SHOWN ON OTHER SHEETS IN THIS SET OF CONTRACT DOCUMENTS. THIS CONTRACTOR SHALL REVIEW THE DEMOLITION WORK OF OTHER TRADES TO DETERMINE WHERE SUCH WORK COULD AFFECT HIS WORK AND SHALL COORDINATE HIS WORK WITH THE WORK OF ALL OTHER TRADES.
- N. AT NEW OPENINGS IN EXISTING BRICK MASONRY WALLS, TOOTH IN BRICK TO MATCH EXISTING. AT NEW OPENINGS IN EXISTING CONCRETE MASONRY WALLS,
- TOOTH IN NEW CMU TO MATCH EXISTING. P. WHERE EXISTING SURFACE MOUNTED VISUAL DISPLAY BOARDS (MARKER, CHALK, TACK BOARDS) ARE BEING REMOVED FROM WALLS, WALL SURFACE BEHIND BOARD IS TO BE PREPARED TO MATCH TEXTURE OF SURROUNDING SURFACES. PROVIDE BLOCK FILLER AS REQUIRED AND PATCH MOUNTING HOLES COMPLETE. REMOVE PAINT BUILD UP AT BOARD EDGES.
- Q. CONTRACTOR IS RESPONSIBLE FOR PREP WORK REQUIRED FOR FLOOR SLAB TO RECEIVE NEW FINISHES. PREP WORK TO INCLUDE: PATCH FLOOR SLAB AT AREAS THAT WILL BE CUT TO ACCOMMODATE NEW PLUMBING LINES OR WHERE CAPPING OF EXISTING LINES BELOW THE SLAB IS REQUIRED AND FILLING IN HOLES IN SLAB WHERE EXISTING MEP HAS BEEN ABANDONED.

KEYED DEMOLITION NOTES

- REMOVE EXISTING STOREFRONT IN ITS ENTIRETY, COORDINATE SALVAGE OF DOOR HARDWARE ITEMS WITH DOOR SCHEDULE AND ELECTRICAL/TELECOM
- REMOVE EXISTING MASONRY WALL TO THE EXTERIOR FACE OF THE REMAINING BUILDING. REMOVE WALL FOUNDATIONS IN THEIR ENTIRETY. PATCH AND REPAIR FOR NEW CONSTRUCTION
- REMOVE EXISTING ACOUSTICAL CEILING GRID IN ITS ENTIRETY. REFER TO REFLECTED CEILING PLANS AND COORDINATE WITH MECHANICAL AND ELECTRICAL
- REMOVE EXISTING SOFFIT IN ITS ENTIRETY REMOVE EXISTING EAVE AND ROOF AS NEEDED TO ACCEPT THE NEW CONSTRUCTION OF UNIT H
- REMOVE EXISTING BATHROOM PARTITION IN ITS ENTIRETY, PREPARE WALL AND FLOOR FOR ACCEPTANCE OF NEW PARTITIONS REMOVE EXISTING GRAB BARS. INSTALL NEW IN-WALL BLOCKING REQUIRED AS REQUIRED FOR NEW GRAB BAR MOUNTING. PATCH/REPAIR WALL TO RECEIVE NEW
- REMOVE EXISTING LAVATORY, PREPARE WALL AND PLUMBING FOR ACCEPTANCE OF NEW FIXTURE
- 10 EXISTING PLUMBING FIXTURES TO REMAIN.
- REMOVE EXISTING FLOOR FINISHES AND ASSOCIATED WALL BASES, PREPARE FOR NEW FINISHES 2 REMOVE EXISTING WALL TILE. PREPARE WALL, INCLUDING PATCHING OR REPLACEMENT OF DRYWALL DAMAGED DURING TILE REMOVAL, TO RECEIVE NEW
- TILE PER THE FINISH DRAWINGS 13 EXISTING GYP. BOARD CEILING TO REMAIN. PREP FOR NEW PAINT. 14 REMOVE ADA SHOWER IN ITS ENTIRETY; PREPARE WALLS AND PLUMBING FOR
- ACCEPTANCE OF NEW ADA SHOWER 15 REMOVE EXISTING WATER COOLER; PREPARE FOR NEW FIXTURE
- 16 REMOVE ACOUSTICAL TILE CEILING AND GRID TO COMPLETE MECHANICAL PIPING WORK. INSTALL NEW LAY-IN ACOUSTICAL TILE CEILING TO MATCH EXISTING
- 7 REWORK ACOUSTICAL TILE CEILING AS REQUIRED TO COMPLETE NEW MECHANICAL PIPING WORK.
- 18 PROTECT AND PRESERVE EXISTING BULKHEAD DURING NEW MECHANICAL PIPING WORK. BULKHEADS DRAWN FOR REFERENCE ONLY. 19 REMOVE EXISTING STRUCTURAL COLUMN & BEAM FRAMING ASSOCIATED WITH THE
- 20 REMOVE EXISTING RESTROOMS ACCESSORIES, INCLUDING, BUT NOT LIJMITED TO, MIRRORS, TOILET PAPER DISPENSERS, PAPER TOWEL DISPENSERS, SOAP
- DISPENSERS, ETC. PATCH/PREP WALL TO RECEIVE NEW FINISHES. REFERE TO NEW WORK PLANS FOR NEW ACCESSORIES.
- 1 REMOVE EXISTING PAPER TOWEL WASTE RECEPTACLES. INFILL W/ GLASS MAT TILE BACKER BOARD AND STUDS AS REQUIRED TO PROVIDE A FLUSH SURFACE
- READY TO RECEIVE NEW WALL TILE. 22 EXTENT OF SHINGLE REMOVAL AND REPLACEMENT TERMINATES AT EXISTING

23 REMOVE EXISTING SHINGLES & UNDERLAYMENT. PROVIDE AN ALLOWANCE TO REPLACE WATER DAMAGED SHEATHING VENTED NAKBASE PAWELS AS REQUIRED.

- 24 REMOVE EXISTING ROOFING, NAILBASE PANELS, CORRUGATED METAL DECKING AND SLOPED VESTIBULE HIP FRAMING FROM THIS AREA. COORDINATE STRUCTURAL FRAMING REMOVAL AND INFILL WITH STRUCTURAL DWGS.
- 5 IN ADDITION TO SHINGLES AND UNDERLAYMENT, REMOVE EXISTING NAILBASE FROM THIS ROOF FACE UP TO THE HIP LINES. TEMPORARILY DRY-IN THIS DECKING TO PREVENT WATER INFILTRATION UNTIL THE PERMANENT OVERBUILD ROOF IS IN 26 REMOVE EXISTING ROOFING COVERINGS. NAILBASE PANELS. CORRUGATED METAL
- DECKING AND EAVE OVERHANG FRAMING FROM THIS AREA TO APPROXIMATELY THE EXISTING EDGE BEAM. COORDINATE STRUCTURAL FRAMING REMOVAL AND INFILL WITH STRUCTURAL DWGS.
- 7 EXISTING 3:12 SLOPED ROOF FRAMING TO REMAIN. INFLL WITH NEW METAL DECKING TO THE EXISTING EDGE BEAM ON THE COLUMN LINE TO ALLOW FOR NEW OVERBUILD TRUSSES.



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SCOPE DRAWINGS: These drawings indicate the general scope of the project in terms of architectural design concept, the dimensions of the building, the major architectural elements and the type of structural, mechanical and electrical systems.


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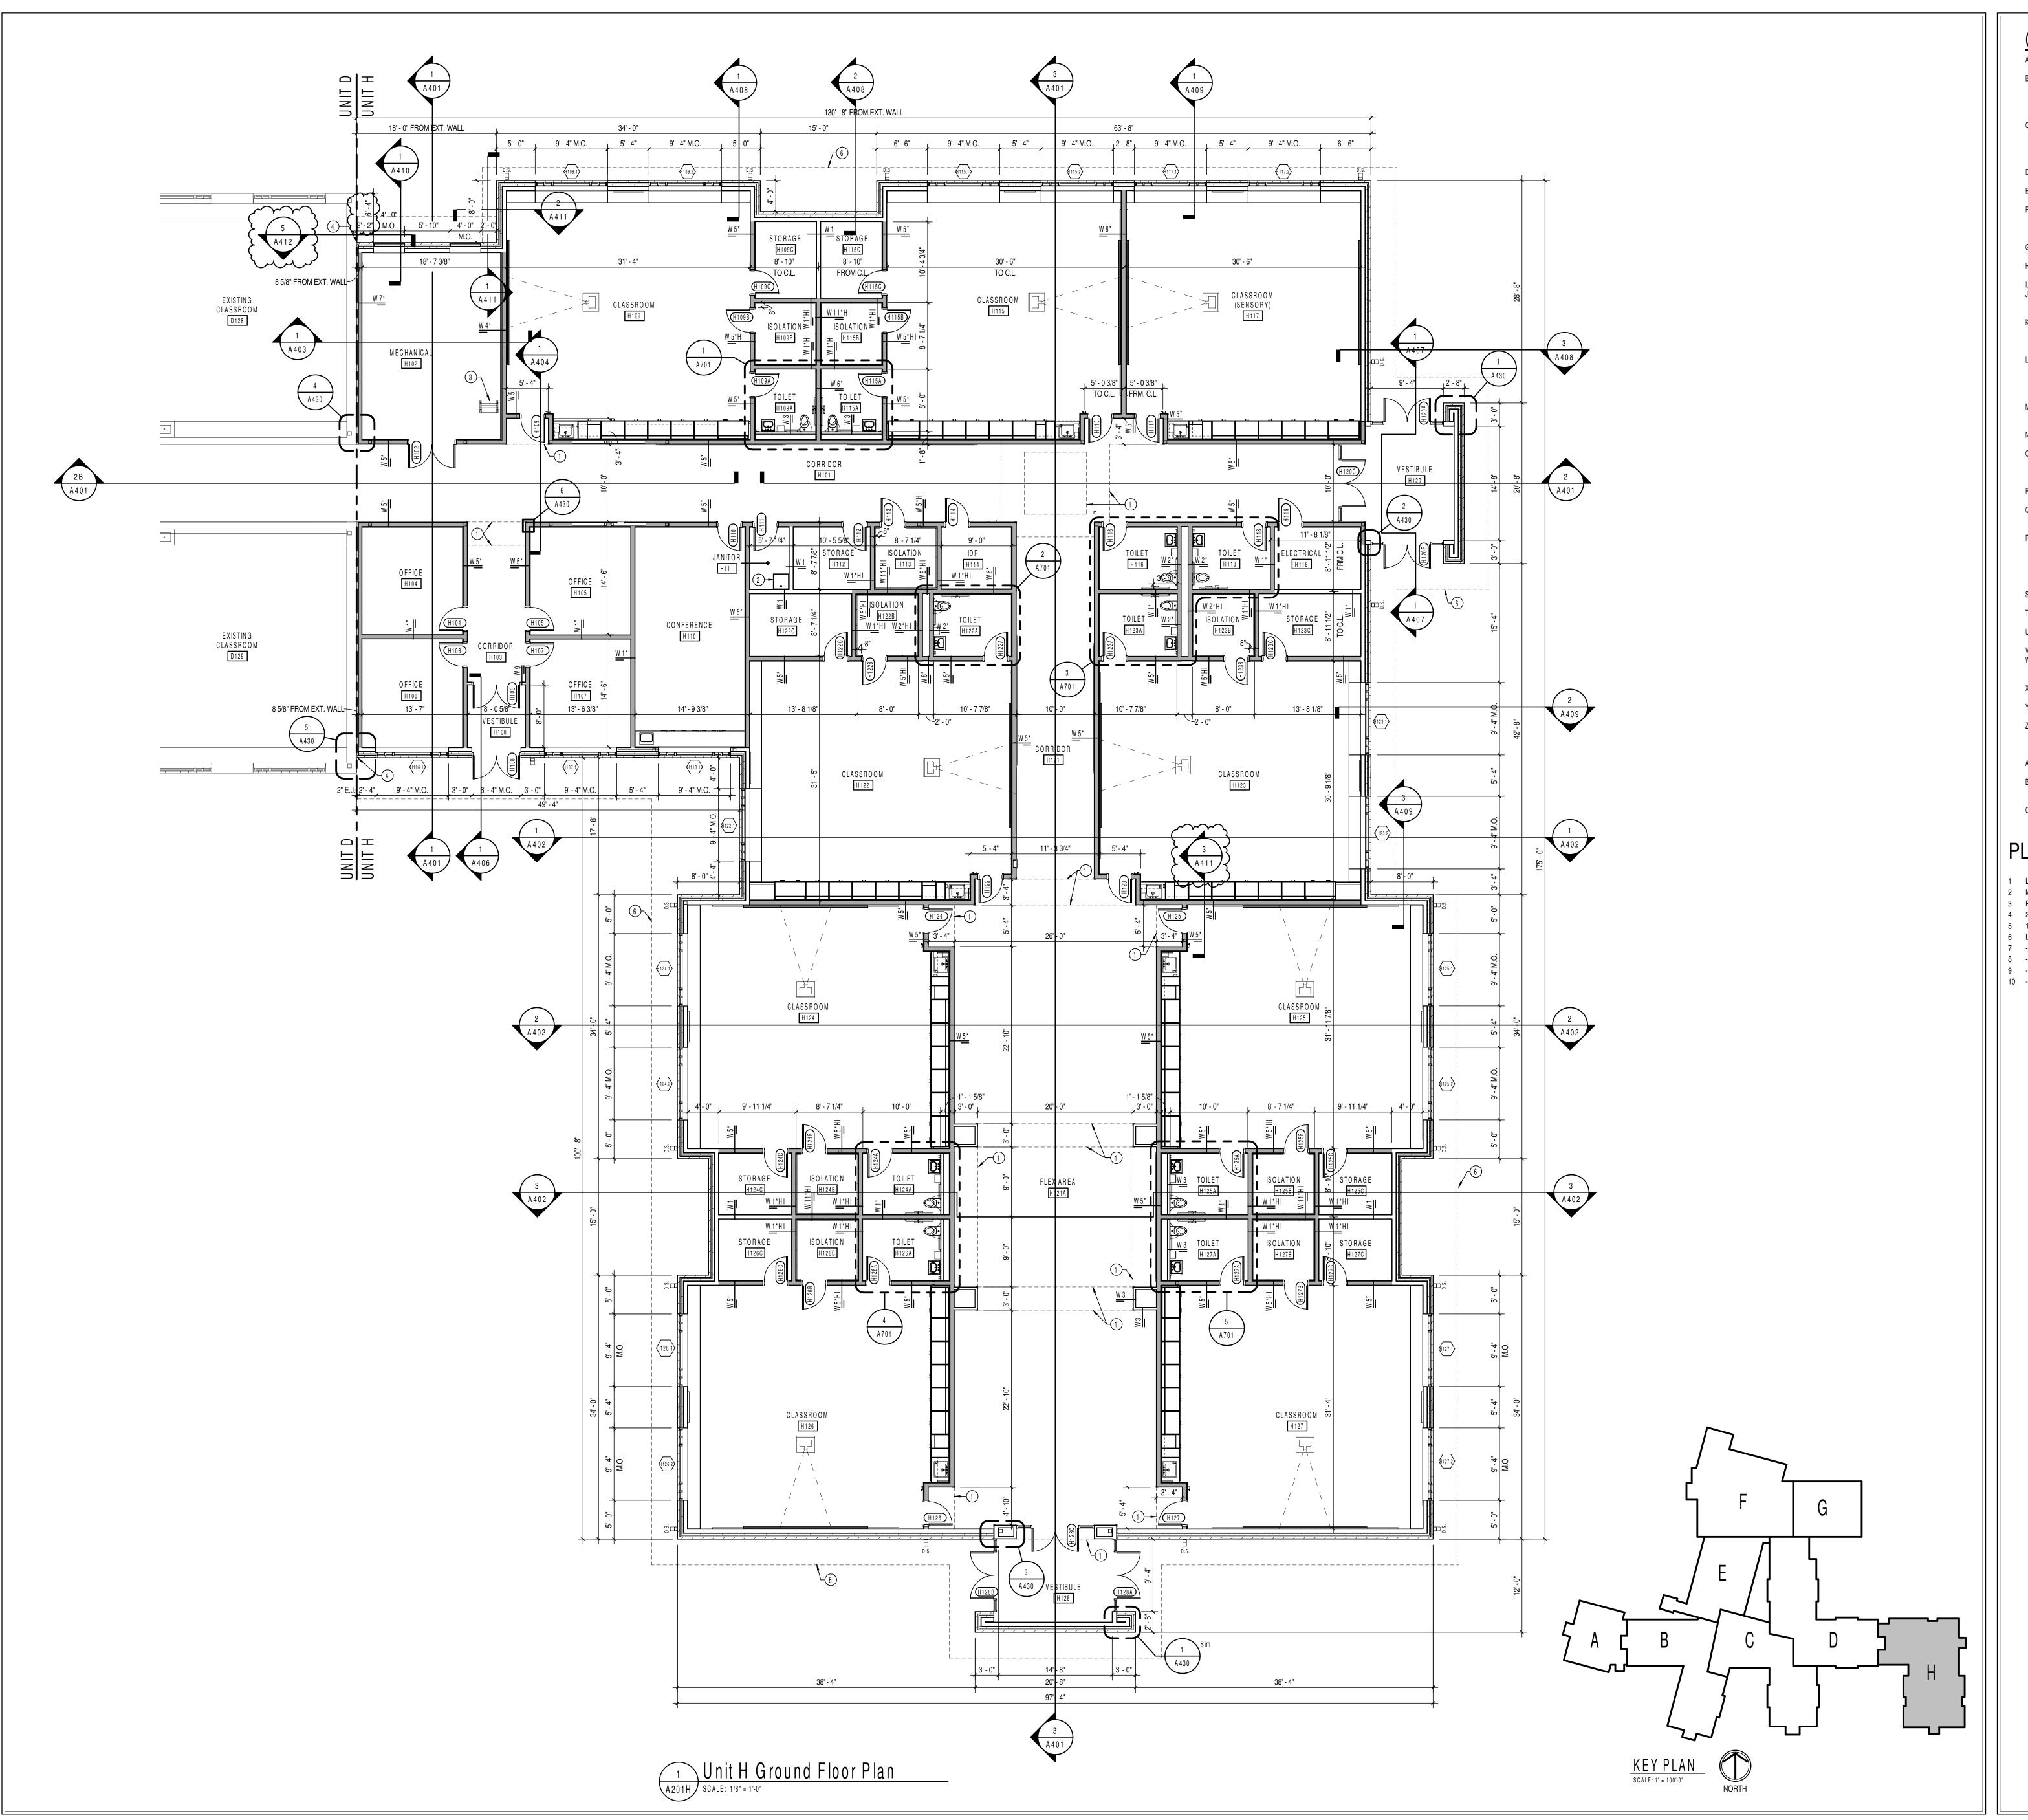
> REVISIONS: ADDENDUM #2 10-27-22

ISSUE DATE | DRAWN BY | CHECKED BY 09/30/22 Author

DRAWING TITLE: PLAN - UNIT D



DRAWING NUMBER

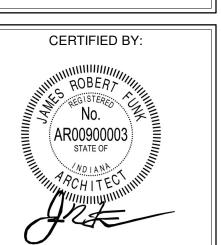

GENERAL NOTES

- A. COORDINATE THE WORK OF EACH TRADE WITH THE WORK OF OTHER TRADES. B. ALL WORK IS TO BE COMPLETED IN STRICT ACCORDANCE WITH ALL APPLICABLE CODES, ORDINANCES, RULES, REGULATIONS AND STANDARDS INCLUDING, BUT NOT LIMITED TO THOSE LISTED ON THE
- COVER SHEET. ALL APPLICABLE RULES & REGULATIONS ARE TO BE THE MOST CURRENT ADOPTED EDITIONS. C. FIELD VERIFY EXISTING CONDITIONS AND DIMENSIONS PRIOR TO THE COMMENCEMENT OF WORK. DISCREPANCIES BETWEEN THE DOCUMENTS AND THE ACTUAL CONDITIONS SHALL BE BROUGHT TO
- D. ALL DIMENSIONS ARE FROM CENTERLINE OF STRUCTURE, FINISH FACE OF WALL, FACE OF MASONRY, OR FACE OF EXISTING.
- ANY DIMENSIONS NOT SHOWN OR DEEMED QUESTIONABLE ARE TO BE VERIFIED BY ARCHITECT. DO NOT SCALE DRAWINGS. REFER TO WALL TYPE SCHEDULE, SHEET A200, TO DETERMINE WHICH WALLS EXTEND TO DECK. SEE STRUCTURAL FOR TOP SUPPORT DETAIL. WHERE METAL STUDS EXTEND TO DECK, PROVIDE
- SLIP CONNECTIONS FOR ROOF/FLOOR DEFLECTION. G. ALL STEEL STUDS ARE TO BE BRACED ACCORDING TO MANUFACTURER LIMIT HEIGHT (L/240). H. WHERE INSULATED OR SOUND WALL'S EXTEND TO DECK, FILL DECK FLUTES WITH INSULATION/SOUND ATTENUATION. REFER TO PLUMBING PLANS FOR LOCATION OF FLOOR DRAINS.

THE ATTENTION OF THE ARCHITECT PRIOR TO THE COMMENCEMENT

- WHERE ACCESS PANELS ARE SHOWN IN TOILET ROOM CHASES, FINAL LOCATION SHALL BE COORDINATED WITH OTHER TRADES PRIOR TO INSTALLATION. K. ALL CONCRETE MASONRY UNITS (CMU) SHALL BE LAID RUNNING BOND U.N.O. CMU WALLS THAT DO NOT LAY OUT IN FULL OR HALF
- LESS THAN 4" IN SIZE EXPOSED TO VIEW. ALL INTERIOR MASONRY WALLS THAT RUN TO UNDERSIDE OF DECK ABOVE SHALL HAVE A 2" JOINT (U.N.O.) AT THE DECK TO BE FILLED WITH FIRE STOPPING AT RATED WALLS PER PROJECT MANUAL, AND MINERAL WOOL AT THE NON-RATED WALLS TO ALLOW FOR
- M. THERE SHALL BE PERIMETER INSULATION CONTINUOUS AROUND THE ENTIRE PERIMETER OF THE BUILDING EXTENDING 2'-0" MINIMUM (R-15 MIN.) HORIZONTAL.

LENGTHS SHOULD BE BALANCED SO AS NOT TO HAVE ANY PIECES

- N. PROVIDE MISCELLANEOUS SUPPORT FOR ALL CEILING SUSPENDED O. DOOR AND FRAME NUMBERS CORRESPOND TO ROOM NUMBERS. WHERE MORE THAN ONE DOOR OCCURS IN A ROOM, A SUFFIX HAS BEEN ADDED (E.G. A100-1). SEE A500 SERIES DRAWINGS FOR DOOR
- SCHEDULE AND DETAILS. P. ALL DOOR FRAMES SHALL BE LOCATED 4" OFF FINISH WALLS OR 4" OFF MASONRY WALLS UNLESS NOTED OTHERWISE. ALL GLASS AT INTERIOR DOOR FRAMES, DOOR LITES AND WINDOW FRAMES IS TO BE 1/4" CLEAR TEMPERED GLASS UNLESS NOTED
- R. AT BUILDING EXPANSION JOINTS, ALL PARTITIONS, CEILINGS, FLOORS AND ALL WALL, FLOOR OR CEILNG MOUNTED ITEMS SHALL BE ANCHORED TO THE BUILDING STRUCTURE ON ONLY ONE SIDE OF THE EXPANSIONS JOINTS. CONTRACTOR SHALL COORDINATE CONSTRUCTION OR INSTALLATION OF ALL ITEMS NOTED TO ASSURE THAT NO SUCH ITEMS BRIDGE ACCROSS THE EXPANSION JOINT.
- S. ALL SLAB-ON-GRADE CONTROL JOINTS TO BE CLEANED AND CAULKED PRIOR TO PLACEMENT OF FLOOR FINISH. SEE REFLECTED CEILING PLANS FOR BULKHEAD LOCATIONS AND
- U. REFER TO MECHANICAL DRAWINGS FOR WALL LOUVER LOCATIONS, SIZES AND QUANTITIES.
- V. SEE A800 SERIES DRAWINGS FOR FINISH SCHEDULE AND PLANS. W. SEE A900 SERIES DRAWINGS FOR EQUIPMENT SCHEDULE AND PLANS. PROVIDE BLOCKING IN STUD WALLS AND/OR GROUTED
- MASONRY CORES AS REQUIRED TO SUPPORT EQUIPMENT. X. PROVIDE FIRE RESISTANT TREATED WOOD BLOCKING SUPPORTS AS REQUIRED FOR ALL SURFACE MOUNTED ITEMS. WHERE DISIMILAR FLOOR MATERIALS MEET, THEY SHALL DO SO
- UNDER THE CENTERLINE OF THE DOOR UNLESS NOTED OTHERWISE. APPLY SEALANT AT ALL JUNCTURES BETWEEN DIFFERENT MATERIALS (E.G. MASONRY TO GYPSUM WALL BOARD) UTILIZING THE APPROPRIATE TYPE PER SPECIFICATIONS. COLOR TO BE SELECTED
- AA. APPLY SEALANT AT ALL COUNTERTOPS AND BLACKSPLASHES AT JUNCTURE WITH WALL.
- BB. ALL DOORS MUST BE INSTALLED WITH AT LEAST THE MINIMUM MANEUVERING CLEARANCE AT THE DOOR APPROACH PER THE MOST CURRENT AMERICANS WITH DISABILITIES ACT.
- CC. BASE FLOOR ELEVATION INDICATED FOR THIS PROJECT IS 100'-0". REFER TO SITE PLAN FOR CORRELATION TO USGS DATUM.

PLAN NOTES

LINE OF BULKHEAD ABOVE MOP SINK

3 PRE-MANUFACTURED ALUMINUM SHIPS LADDER; SEE A409 FOR DETAILS 4 2" PRE-COMPRESSED SILICONE FACED EXTERIOR EXPANSION JOINT (07 95 00) 5 1 1/4" DIA. (NOM.) PAINTED GALVANIZED STEEL GUARDRAIL. SEE A412 FOR DETAILS.

6 LINE OF SOFFIT ABOVE



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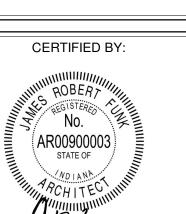
SCOPE DRAWINGS: the trade contractors shall furnish all items required for the proper execution and completion of the work.

> REVISIONS: ADDENDUM #2 10-27-22


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09/30/22 JBW

DRAWING TITLE: FIRST FLOOR PLAN - UNIT H



DRAWING NUMBER A201H

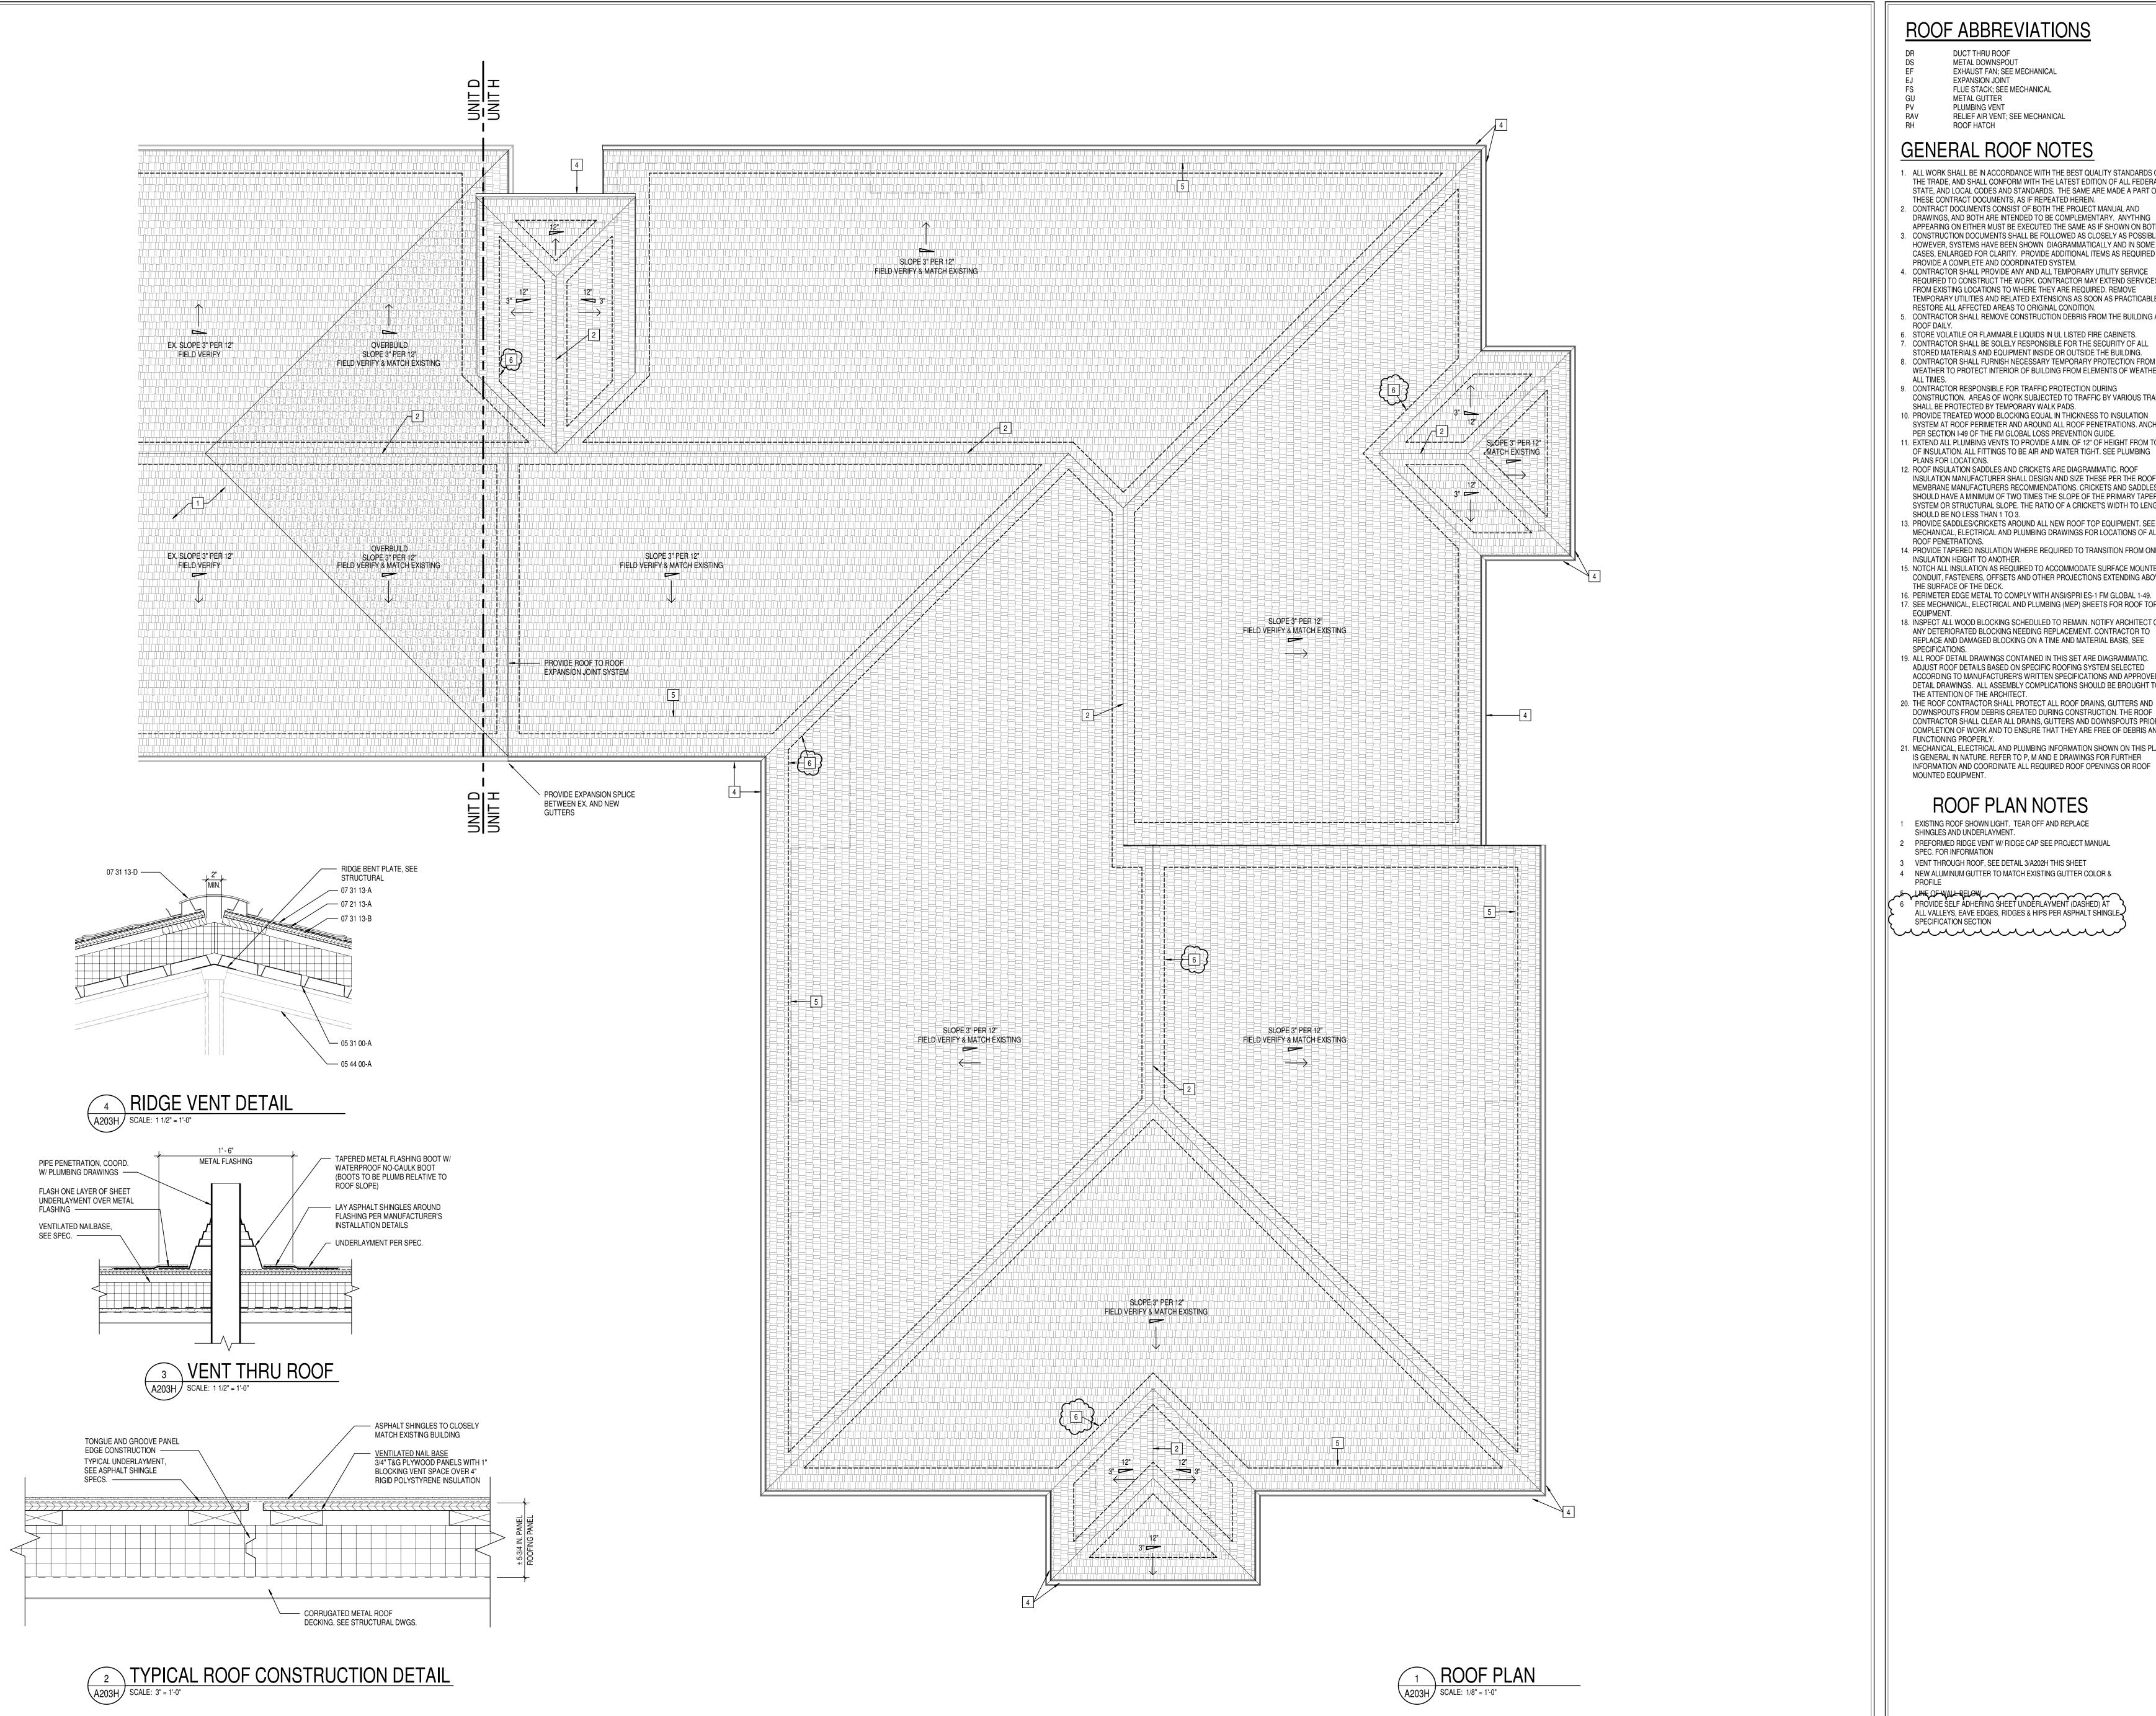

ROOF ABBREVIATIONS

DUCT THRU ROOF METAL DOWNSPOUT EXHAUST FAN; SEE MECHANICAL

EXPANSION JOINT FLUE STACK; SEE MECHANICAL METAL GUTTER

PLUMBING VENT RELIEF AIR VENT; SEE MECHANICAL ROOF HATCH

GENERAL ROOF NOTES

- . ALL WORK SHALL BE IN ACCORDANCE WITH THE BEST QUALITY STANDARDS OF THE TRADE, AND SHALL CONFORM WITH THE LATEST EDITION OF ALL FEDERAL,
- STATE, AND LOCAL CODES AND STANDARDS. THE SAME ARE MADE A PART OF THESE CONTRACT DOCUMENTS, AS IF REPEATED HEREIN. 2. CONTRACT DOCUMENTS CONSIST OF BOTH THE PROJECT MANUAL AND
- DRAWINGS, AND BOTH ARE INTENDED TO BE COMPLEMENTARY. ANYTHING APPEARING ON EITHER MUST BE EXECUTED THE SAME AS IF SHOWN ON BOTH. 3. CONSTRUCTION DOCUMENTS SHALL BE FOLLOWED AS CLOSELY AS POSSIBLE. HOWEVER, SYSTEMS HAVE BEEN SHOWN DIAGRAMMATICALLY AND IN SOME CASES, ENLARGED FOR CLARITY. PROVIDE ADDITIONAL ITEMS AS REQUIRED TO
- 4. CONTRACTOR SHALL PROVIDE ANY AND ALL TEMPORARY UTILITY SERVICE REQUIRED TO CONSTRUCT THE WORK. CONTRACTOR MAY EXTEND SERVICES FROM EXISTING LOCATIONS TO WHERE THEY ARE REQUIRED. REMOVE TEMPORARY UTILITIES AND RELATED EXTENSIONS AS SOON AS PRACTICABLE.
- RESTORE ALL AFFECTED AREAS TO ORIGINAL CONDITION. 5. CONTRACTOR SHALL REMOVE CONSTRUCTION DEBRIS FROM THE BUILDING AND ROOF DAILY.
- 6. STORE VOLATILE OR FLAMMABLE LIQUIDS IN UL LISTED FIRE CABINETS. 7. CONTRACTOR SHALL BE SOLELY RESPONSIBLE FOR THE SECURITY OF ALL
- STORED MATERIALS AND EQUIPMENT INSIDE OR OUTSIDE THE BUILDING. 8. CONTRACTOR SHALL FURNISH NECESSARY TEMPORARY PROTECTION FROM
- WEATHER TO PROTECT INTERIOR OF BUILDING FROM ELEMENTS OF WEATHER AT ALL TIMES. 9. CONTRACTOR RESPONSIBLE FOR TRAFFIC PROTECTION DURING
- CONSTRUCTION. AREAS OF WORK SUBJECTED TO TRAFFIC BY VARIOUS TRADES SHALL BE PROTECTED BY TEMPORARY WALK PADS. 10. PROVIDE TREATED WOOD BLOCKING EQUAL IN THICKNESS TO INSULATION SYSTEM AT ROOF PERIMETER AND AROUND ALL ROOF PENETRATIONS. ANCHOR
- PER SECTION I-49 OF THE FM GLOBAL LOSS PREVENTION GUIDE. 11. EXTEND ALL PLUMBING VENTS TO PROVIDE A MIN. OF 12" OF HEIGHT FROM TOP OF INSULATION. ALL FITTINGS TO BE AIR AND WATER TIGHT. SEE PLUMBING PLANS FOR LOCATIONS.
- INSULATION MANUFACTURER SHALL DESIGN AND SIZE THESE PER THE ROOF MEMBRANE MANUFACTURERS RECOMMENDATIONS. CRICKETS AND SADDLES SHOULD HAVE A MINIMUM OF TWO TIMES THE SLOPE OF THE PRIMARY TAPERED SYSTEM OR STRUCTURAL SLOPE. THE RATIO OF A CRICKET'S WIDTH TO LENGTH SHOULD BE NO LESS THAN 1 TO 3.
- 13. PROVIDE SADDLES/CRICKETS AROUND ALL NEW ROOF TOP EQUIPMENT. SEE MECHANICAL, ELECTRICAL AND PLUMBING DRAWINGS FOR LOCATIONS OF ALL ROOF PENETRATIONS.
- 14. PROVIDE TAPERED INSULATION WHERE REQUIRED TO TRANSITION FROM ONE INSULATION HEIGHT TO ANOTHER. 15. NOTCH ALL INSULATION AS REQUIRED TO ACCOMMODATE SURFACE MOUNTED CONDUIT, FASTENERS, OFFSETS AND OTHER PROJECTIONS EXTENDING ABOVE THE SURFACE OF THE DECK.
- 17. SEE MECHANICAL, ELECTRICAL AND PLUMBING (MEP) SHEETS FOR ROOF TOP FOUIPMENT 18. INSPECT ALL WOOD BLOCKING SCHEDULED TO REMAIN, NOTIFY ARCHITECT OF ANY DETERIORATED BLOCKING NEEDING REPLACEMENT. CONTRACTOR TO REPLACE AND DAMAGED BLOCKING ON A TIME AND MATERIAL BASIS, SEE
- SPECIFICATIONS. 19. ALL ROOF DETAIL DRAWINGS CONTAINED IN THIS SET ARE DIAGRAMMATIC. ADJUST ROOF DETAILS BASED ON SPECIFIC ROOFING SYSTEM SELECTED ACCORDING TO MANUFACTURER'S WRITTEN SPECIFICATIONS AND APPROVED DETAIL DRAWINGS. ALL ASSEMBLY COMPLICATIONS SHOULD BE BROUGHT TO THE ATTENTION OF THE ARCHITECT.
- DOWNSPOUTS FROM DEBRIS CREATED DURING CONSTRUCTION. THE ROOF CONTRACTOR SHALL CLEAR ALL DRAINS, GUTTERS AND DOWNSPOUTS PRIOR TO COMPLETION OF WORK AND TO ENSURE THAT THEY ARE FREE OF DEBRIS AND FUNCTIONING PROPERLY. 21. MECHANICAL, ELECTRICAL AND PLUMBING INFORMATION SHOWN ON THIS PLAN IS GENERAL IN NATURE. REFER TO P, M AND E DRAWINGS FOR FURTHER INFORMATION AND COORDINATE ALL REQUIRED ROOF OPENINGS OR ROOF MOUNTED EQUIPMENT.

ROOF PLAN NOTES

- EXISTING ROOF SHOWN LIGHT. TEAR OFF AND REPLACE SHINGLES AND UNDERLAYMENT.
- PREFORMED RIDGE VENT W/ RIDGE CAP SEE PROJECT MANUAL SPEC. FOR INFORMATION
- 3 VENT THROUGH ROOF, SEE DETAIL 3/A202H THIS SHEET
- 4 NEW ALUMINUM GUTTER TO MATCH EXISTING GUTTER COLOR &

6 PROVIDE SELF ADHERING SHEET UNDERLAYMENT (DASHED) AT ALL VALLEYS, EAVE EDGES, RIDGES & HIPS PER ASPHALT SHINGLE SPECIFICATION SECTION mmmmm

SCOPE DRAWINGS: of structural, mechanical and electrical systems.

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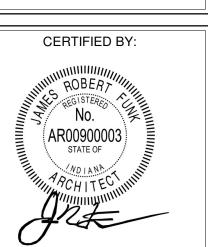
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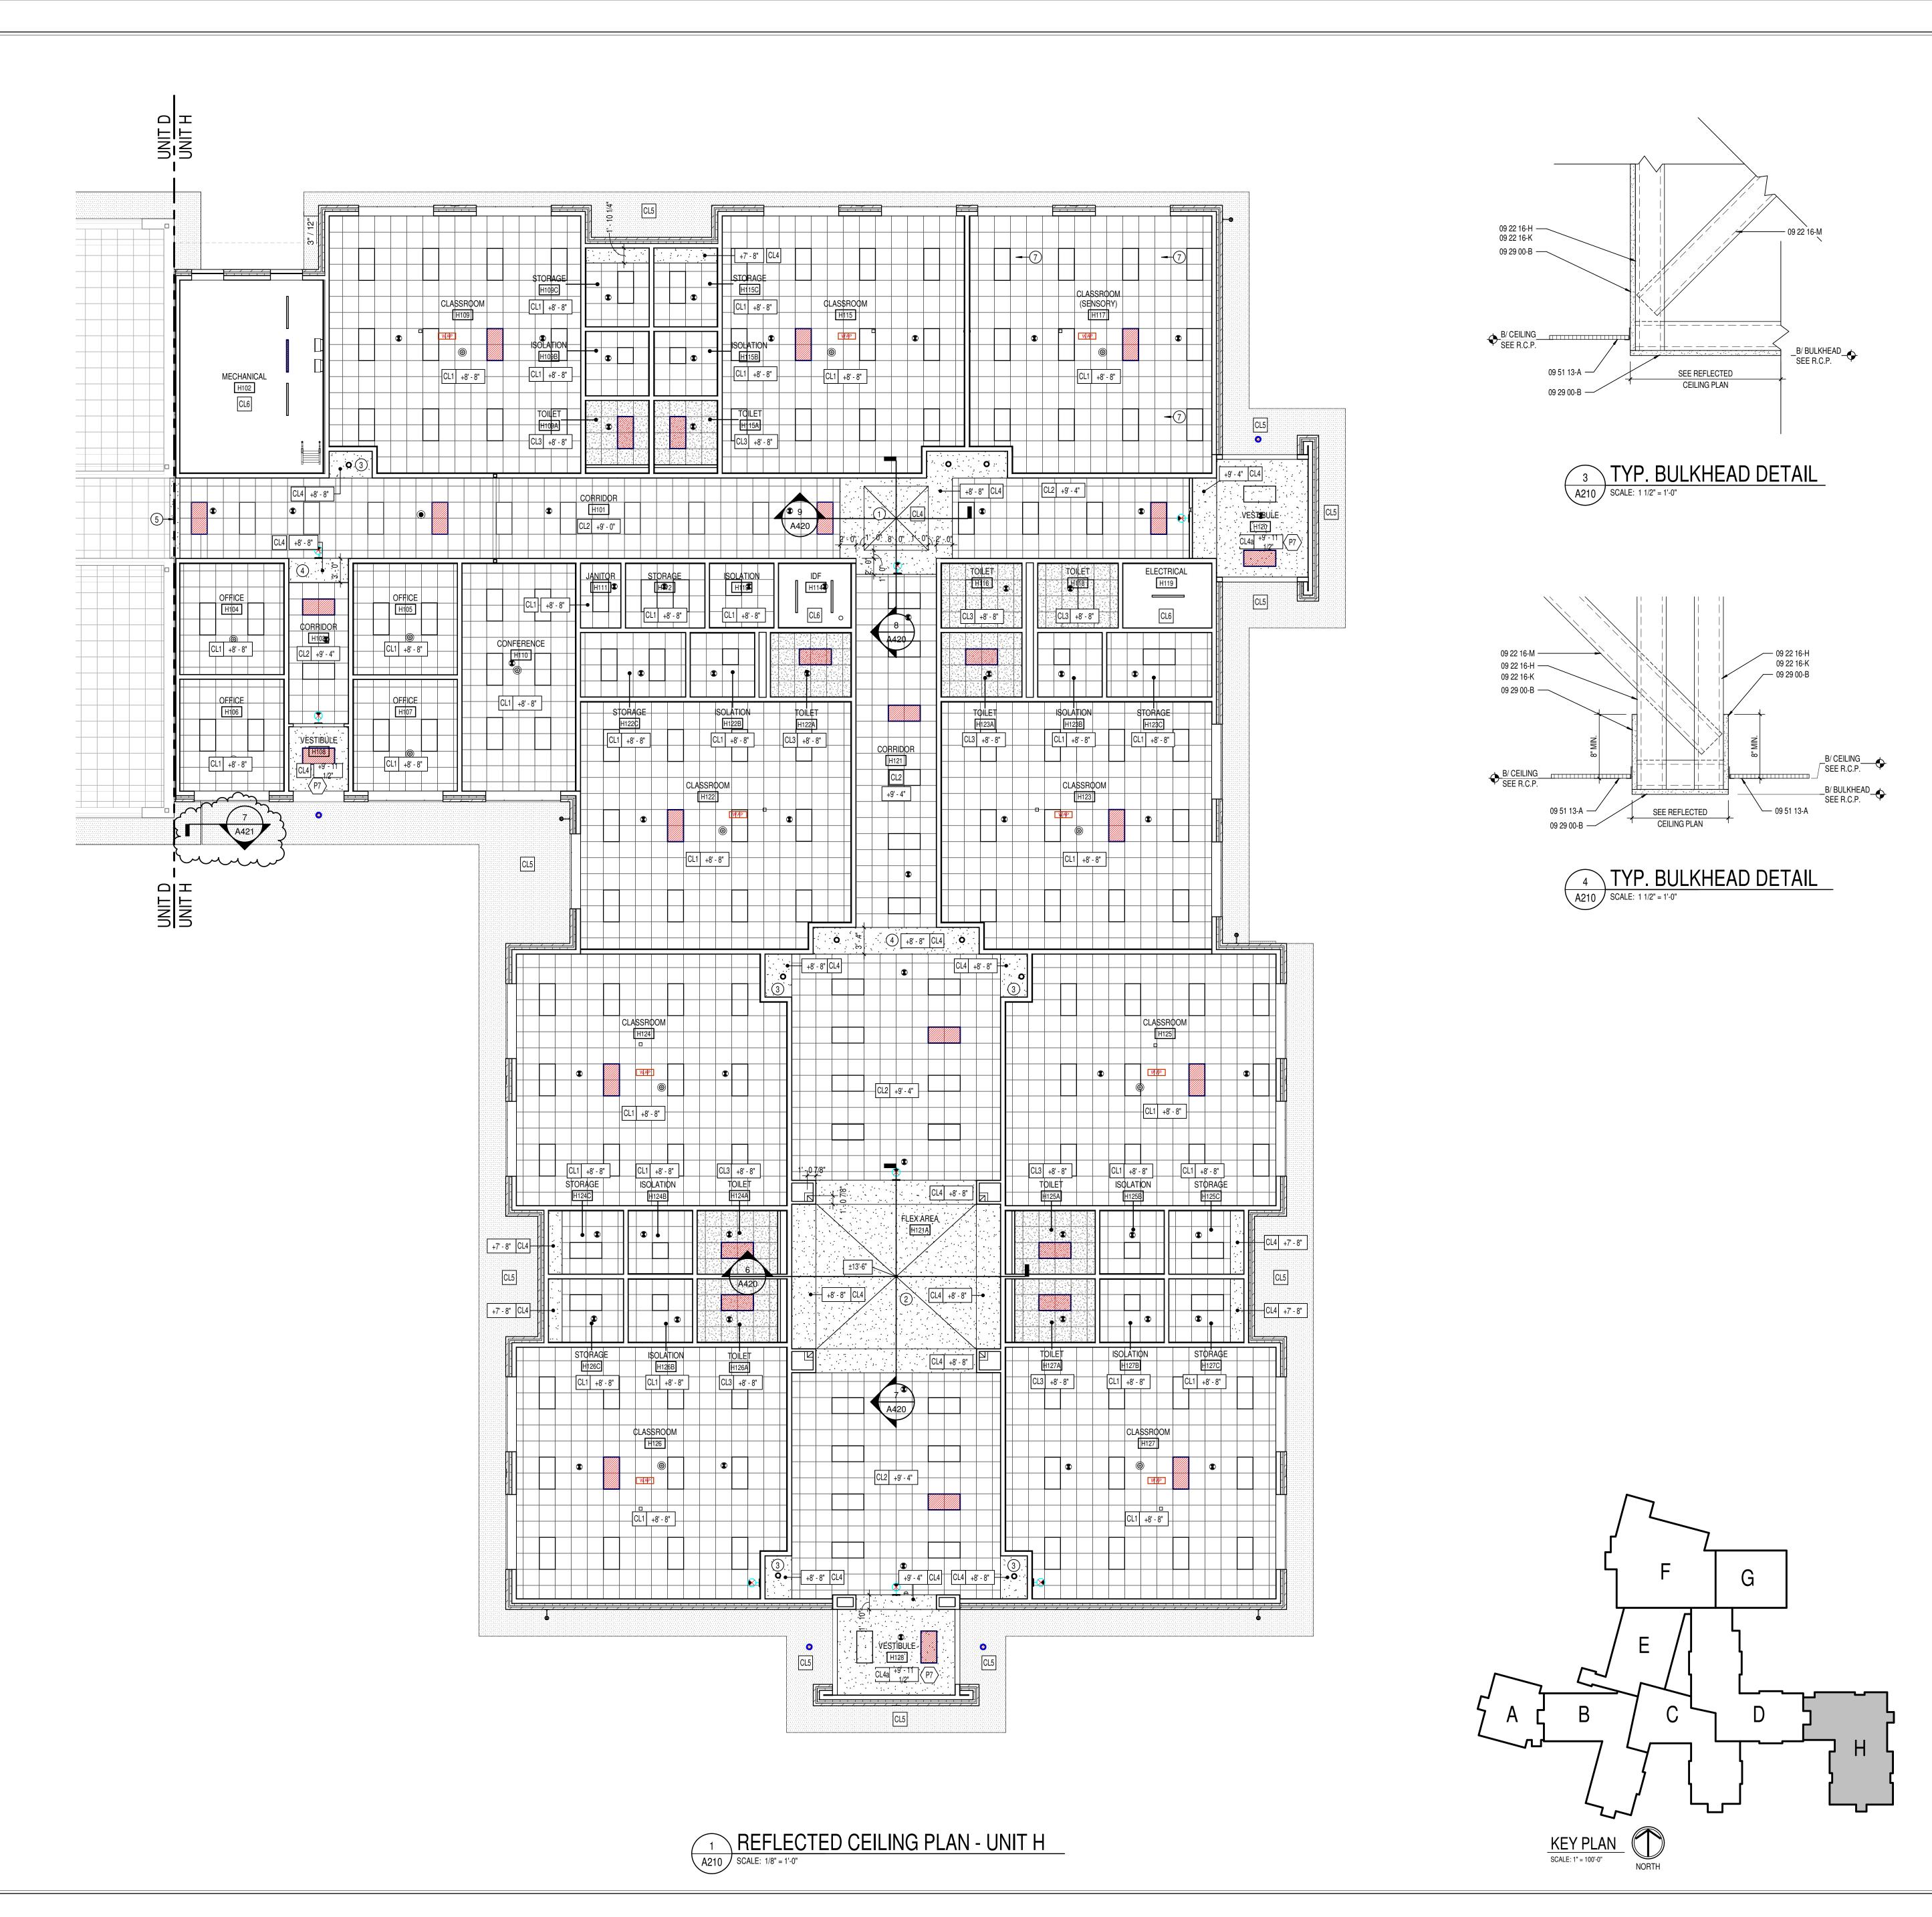
JBW

09/30/22

DRAWING TITLE: **ROOF PLAN**



DRAWING NUMBER



GENERAL REFLECTED CEILING PLAN NOTES

SEE THE ELECTRICAL DRAWINGS FOR SIZES, TYPES, AND QUANTITIES OF LIGHT FIXTURES, SPEAKERS, SMOKE DETECTORS, AND OTHER CEILING MOUNTED ELECTRICAL DEVICES.

 SEE THE MECHANICAL DRAWINGS FOR SIZES, TYPES, AND QUANTITIES OF DIFFUSERS, GRILLES, AND OTHER MECHANICAL

B. SEE THE MECHANICAL DRAWINGS FOR SIZES, TYPES, AND QUANTITIES OF DIFFUSERS, GRILLES, AND OTHER MECHANICAL CEILING MOUNTED DEVICES.
 C. PROVIDE, FIELD LOCATE AND INSTALL 16"x16" FLUSH ACCESS PANELS AT ALL MECHANICAL AND PLUMBING PIPING VALVE

PANELS AT ALL MECHANICAL AND PLUMBING PIPING VALVE
LOCATIONS ABOVE SUSPENDED GYPSUM BOARD CEILINGS. SEE THE
MECHANICAL, AND PLUMBING DRAWINGS FOR LOCATIONS.

D. SEE THE STRUCTURAL DRAWINGS FOR MASONRY WALLS USED FOR
SHEAR WALLS THAT ARE REQUIRED TO EXTEND TO
DECK/STRUCTURE ABOVE. PROVIDE BRACING FOR ALL MASONRY
WALLS NOT EXTENDING TO THE DECK/STRUCTURE AS DETAILED ON
STRUCTURAL DRAWINGS.

E. METAL STUDS WALLS SHALL BE ATTACHED TO THE STRUCTURE ABOVE WITH SLIP CONNECTORS. STUD WALLS NOT EXTENDING TO THE STRUCTURE/DECK ABOVE SHALL RECEIVE DIAGONAL METAL STUD BRACING AT MAXIMUM 4'-0" O.C.

F. THE SUSPENDED ACOUSTICAL TILE CEILING GRID AS SHOWN ON

H. SEE MECHANICAL, PLUMBING AND ELECTRICAL DOCUMENTS FOR

ADDITIONAL CEILING WORK REQUIRED BY NEW MEP WORK.

THESE DRAWINGS IS REPRESENTATIONAL. THE CEILING GRID IS TO BROKEN AS REQUIRED AT LIGHT FIXTURES, PROJECTION SCREENS, ETC.

G. ALL EXISTING GYPSUM OR PLASTER CEILINGS AND BULKHEADS TO REMAIN ARE TO BE PAINTED P-- CEILING BRIGHT WHITE UNLESS NOTED OTHERWISE (SEE A800 SERIES DRAWINGS).

REFLECTED CEILING LEGEND

FLUORESCENT LIGHT FIXTURES, RECESSED OR
SURFACED MOUNTED, SEE ELECTRICAL DRAWINGS
DOWNLIGHT/HIGH BAY LIGHT FIXTURE; SEE ELECTRICAL
DRAWINGS
CEILING MOUNTED PROJECTOR, SEE TECHNOLOGY DRAWINGS

RETURN/EXHAUST GRILL; SEE MECHANICAL DRAWINGS
SUPPLY AIR GRILL; SEE MECHANICAL DRAWINGS

LINEAR SLOT SUPPLY AIR GRILL; SEE MECHANICAL DRAWINGS

SUSPENDED ACOUSTICAL LAY-IN CEILING
MFG: ARMSTRONG MODEL #1713

STYLE: SCHOOL ZONE HIGH CAC, HIGH NRC DESCRIPTION: SQUARE EDGE COLOR: WHITE SIZE: 24" x 24" x 3/4" LOCATION: CLASSROOMS

SUSPENDED ACOUSTICAL LAY-IN CEILING MFG: ARMSTRONG MODEL #465
STYLE: SCHOOL ZONE HIGH DURABILITY DESCRIPTION: SQUARE EDGE COLOR: WHITE SIZE: 24" x 24" x 5/8"

SUSPENDED ACOUSTICAL LAY-IN CEILING
MFG: ARMSTRONG MODEL #1935
STYLE: ULTIMA HEALTH ZONE
DESCRIPTION: SQUARE EDGE
COLOR: WHITE SIZE: 2' x 2' x 3/4"
LOCATION: RESTROOMS/KITCHENS

LOCATION: CORRIDORS

CL4 (CL4a DESIGNATES DRYWALL SUSPENSION SYSTEM)
PAINT: SEE A800 SERIES FINISH PLANS.

DIRECT APPLIED FINISH SYSTEM SOFFIT TO MATCH
EXISTING SOFFIT TEXTURE AND COLOR; SEE WALL

GYPSUM WALLBOARD STICK FRAMED SOFFIT

SECTIONS FOR ASSSEMBLY INFORMATION

CL6 EXPOSED STRUCTURE - PAINTED SEE FINISH PLANS

CL7 EXISTING GYP BOARD TO REMAIN - PREP & PAINTED PER THE FINISH PLANS

ETR EXISTING ACOUSTIC LAY-IN CEILING TO REMAIN

CEILING ELEVATION MARK ABOVE FINISHED FLOOR (AT THAT LOCATION IF MULTIPLE FLOOR LEVELS ARE PRESENT)

REFLECTED CEILING PLAN NOTES

1 PYRAMIDAL VAULT; SEE DETAIL 4/A410
2 PYRAMIDAL VAULT: SEE DETAIL 6/A410

PYRAMIDAL VAULT; SEE DETAIL 6/A410
GYPSUM BOARD AND METAL STUD FRAMED BULKHEAD ABOVE. SEE DETAIL 3/A210.
GYPSUM BOARD AND METAL STUD FRAMED BULKHEAD ABOVE. SEE DETAIL 4/A210.

2" CEILING EXPANSION JOINT
VERIFY EXISTING CEILING IN FIELD, REPLACE WITH CL3 IF ACOUSTICAL AND PAINT PER FINISH PLANS IF GYPSUM BOARD.
SENSORY SWING SUPPORT, COORDINATE WITH STRUCTURAL DRAWINGS.

7 SENSORY SWING SUPPORT. COORDINATE WITH STRUCTURAL DRAWINGS.
3 REFER TO ELECTRICAL LIGHTING PLANS FOR FIXTURE QUANTITY AND LAYOUT

one Crossing, Indianapolis, IN 46240

Westfield Washington Schools
ADDITION & RENOVATION TO
CAREY RIDGE ELEMENTARY
16231 CAREY ROAD, WESTFIELD, INDIANA 46074

SCOPE DRAWINGS:

These drawings indicate the general scope of the project in terms of architectural design concept, the dimensions of the building, the major architectural elements and the type of structural, mechanical and electrical systems.

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REVISIONS:
ADDENDUM #2 10-27-22

ISSUE DATE | DRAWN BY | CHECKED BY


JBW

09/30/22


DRAWING TITLE:

REFLECTED

CEILING PLAN -

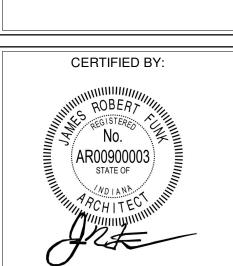

A210

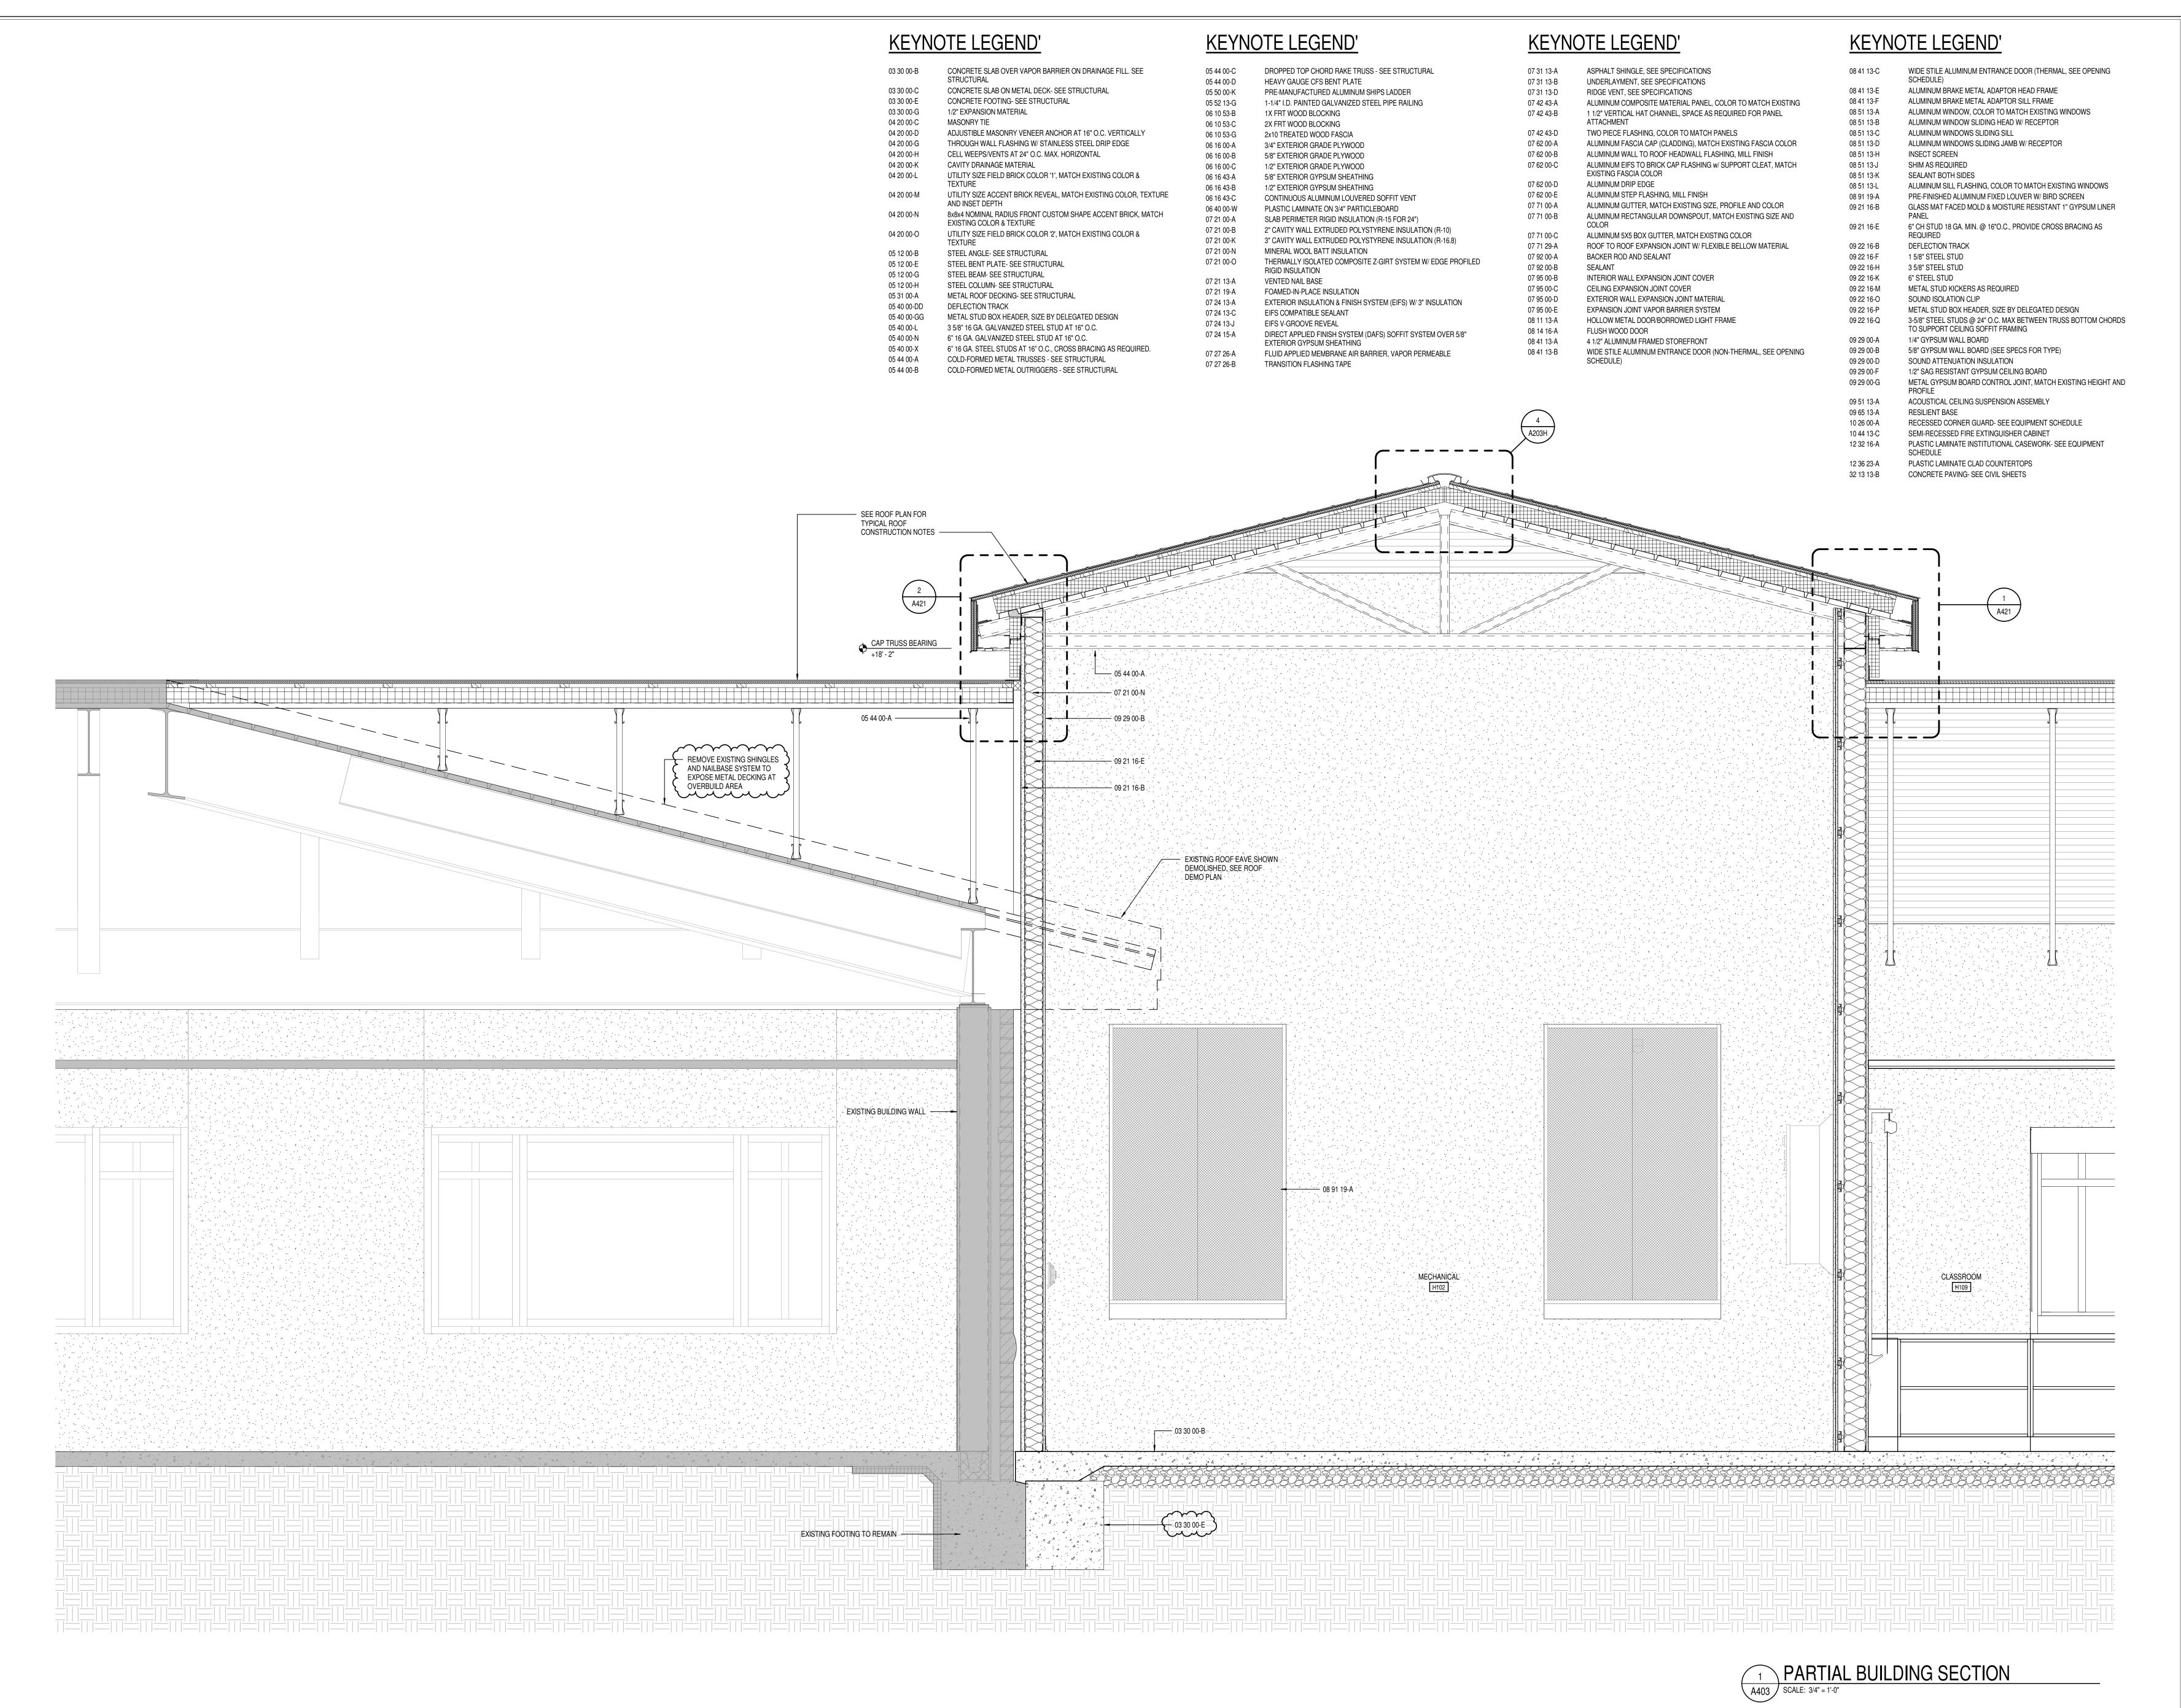

831 Keystone Crossing, Indianapolis, IN 46240

Westfield Washington Schools ADDITION & RENOVATION TO REY RIDGE ELEMENTARY 1 CAREY ROAD, WESTFIELD, INDIANA 46074

SCOPE DRAWINGS:
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REVISIONS: ADDENDUM #2 10-27-22

ISSUE DATE | DRAWN BY | CHECKED BY

09/30/22 JBW BH

DRAWING TITLE:

PARTIAL BUILDING SECTIONS

CERTIFIED BY:

ROBERT

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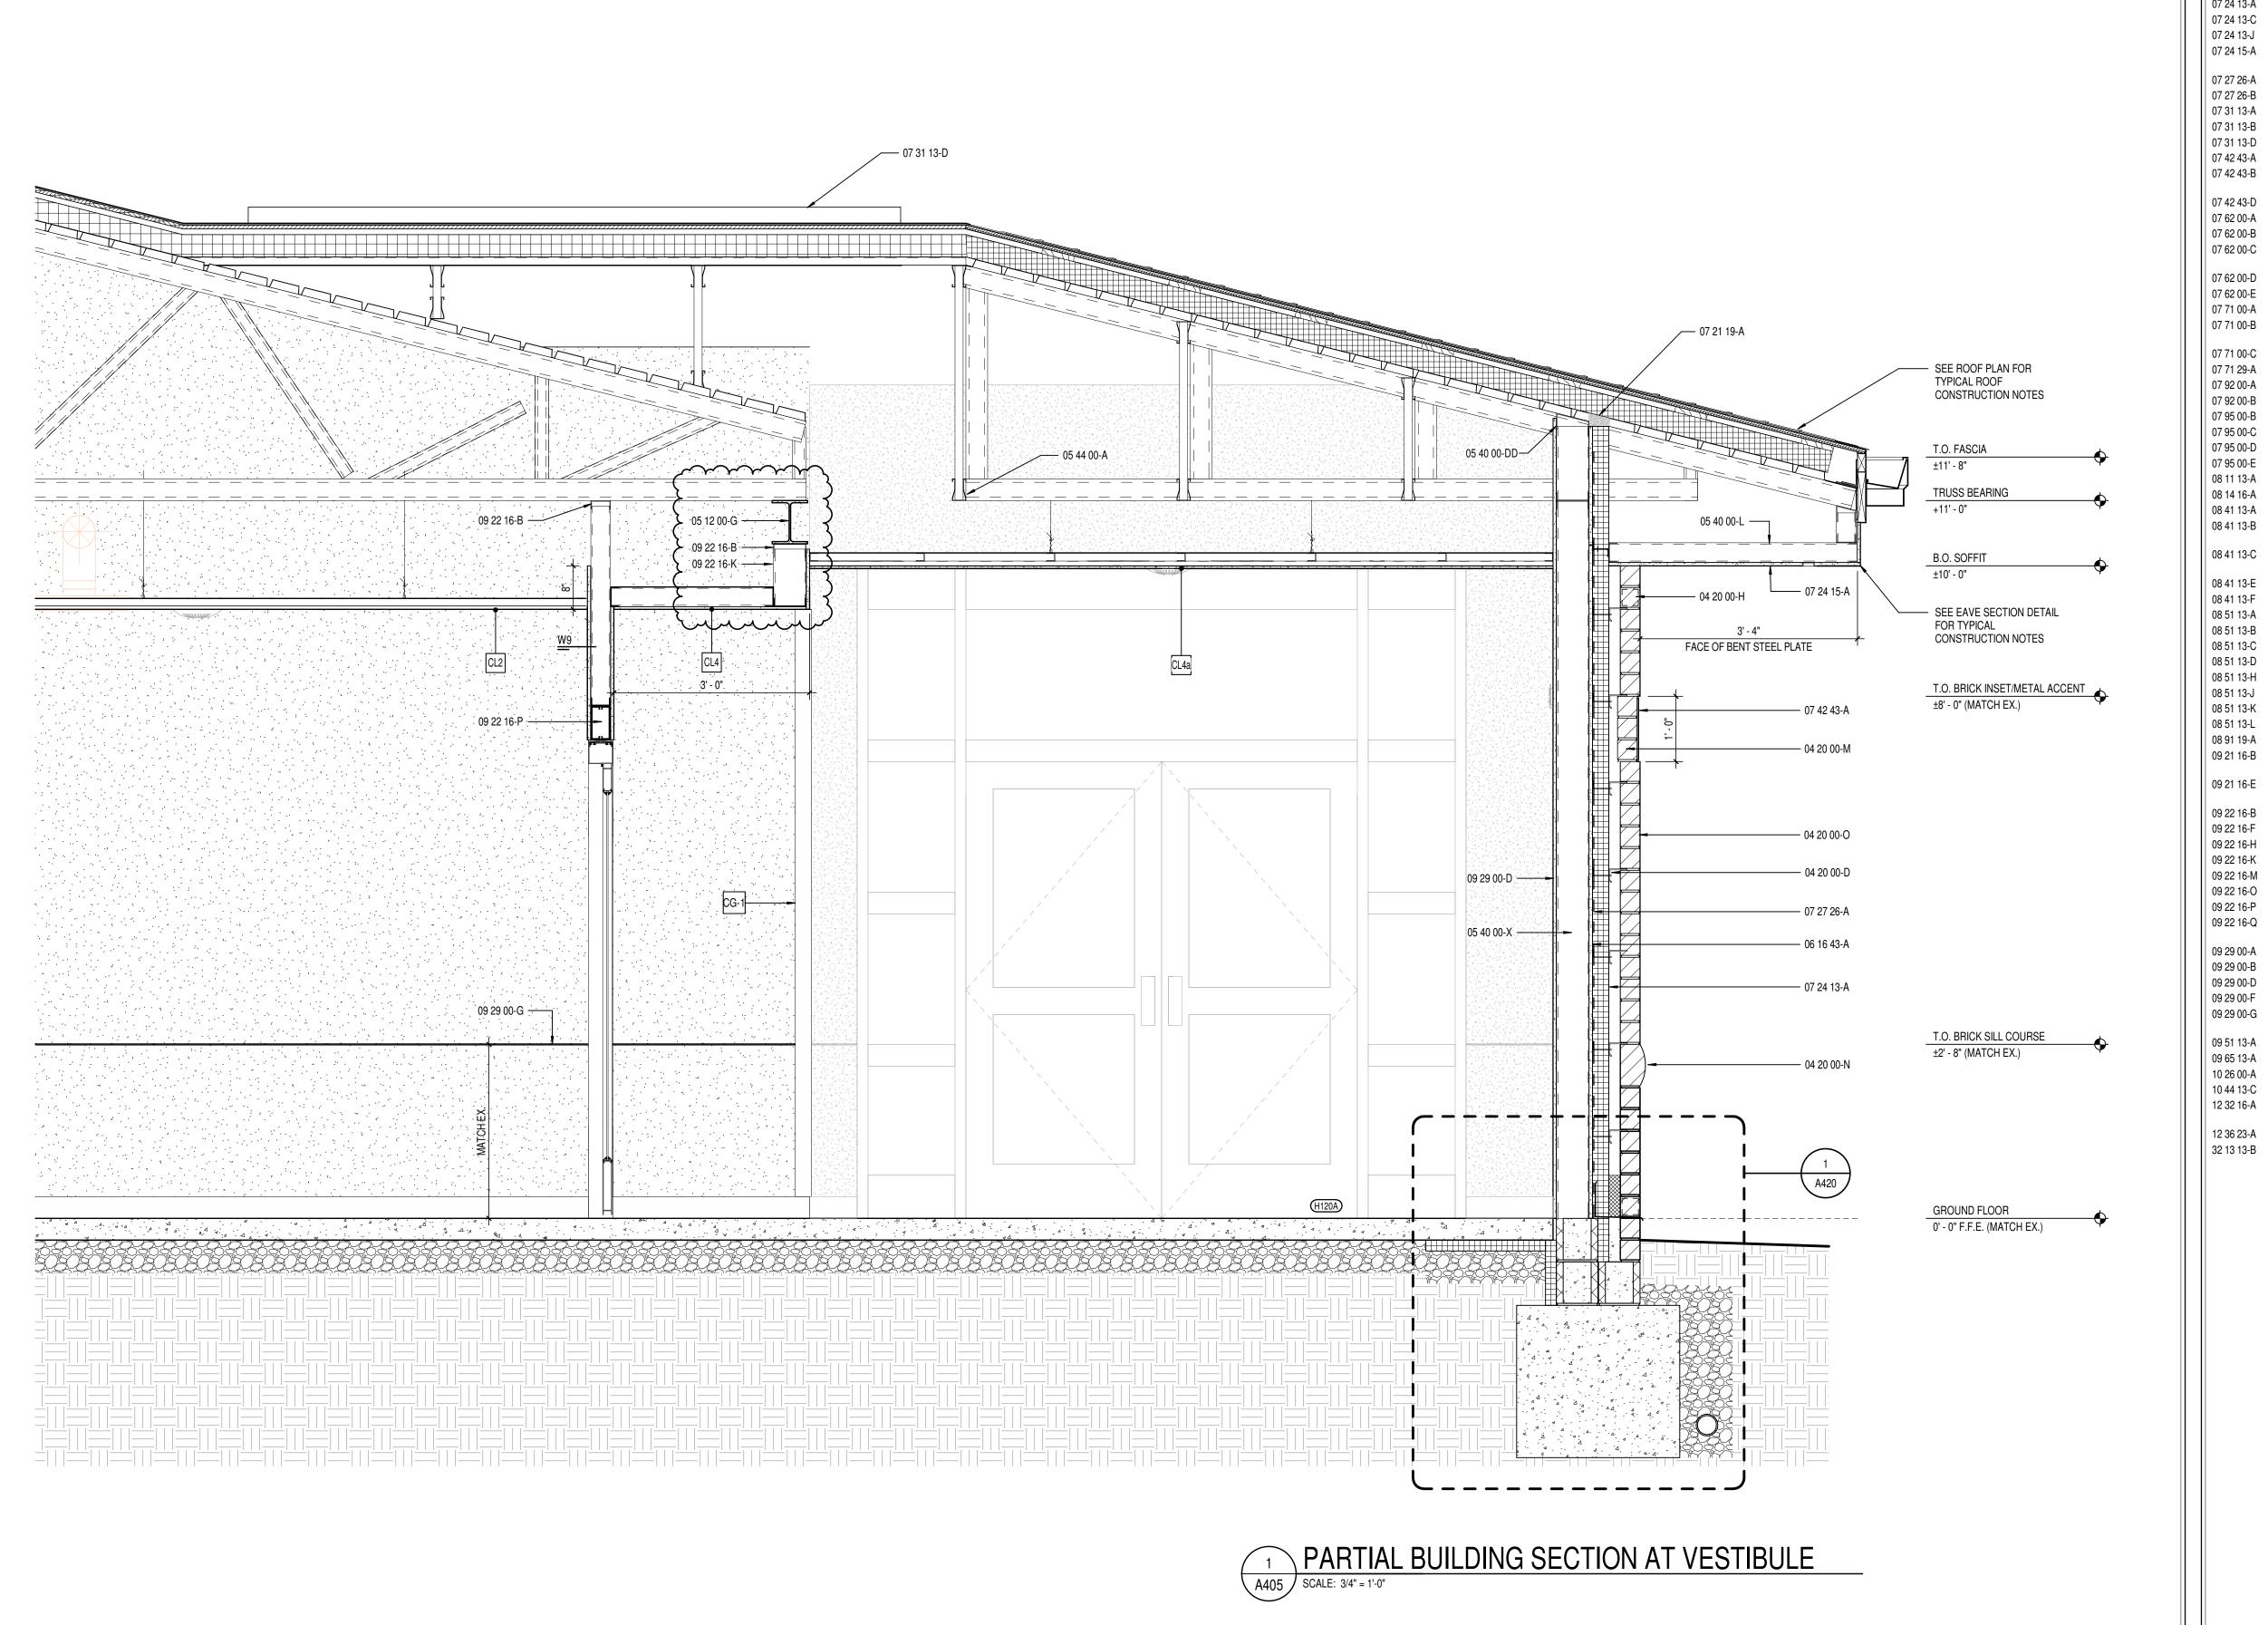
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ARCHITECTURE

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A403



KEYN	OTE LEGEND
03 30 00-B	CONCRETE SLAB OVER VAPOR BARRIER ON DRAINAGE FILL. SEE STRUCTURAL
3 30 00-C	CONCRETE SLAB ON METAL DECK- SEE STRUCTURAL
3 30 00-E	CONCRETE FOOTING- SEE STRUCTURAL
3 30 00-G	1/2" EXPANSION MATERIAL
)4 20 00-C	MASONRY TIE
)4 20 00-D	ADJUSTIBLE MASONRY VENEER ANCHOR AT 16" O.C. VERTICALLY
)4 20 00-G	THROUGH WALL FLASHING W/ STAINLESS STEEL DRIP EDGE
)4 20 00-H)4 20 00-K	CELL WEEPS/VENTS AT 24" O.C. MAX. HORIZONTAL CAVITY DRAINAGE MATERIAL
04 20 00-K	UTILITY SIZE FIELD BRICK COLOR '1', MATCH EXISTING COLOR & TEXTURE
04 20 00-M	UTILITY SIZE ACCENT BRICK REVEAL, MATCH EXISTING COLOR, TEX AND INSET DEPTH
04 20 00-N	8x8x4 NOMINAL RADIUS FRONT CUSTOM SHAPE ACCENT BRICK, MATERISTING COLOR & TEXTURE
04 20 00-O 05 12 00-B	UTILITY SIZE FIELD BRICK COLOR '2', MATCH EXISTING COLOR & TEXTURE STEEL ANGLE- SEE STRUCTURAL
05 12 00 B	STEEL BENT PLATE- SEE STRUCTURAL
5 12 00-G	STEEL BEAM- SEE STRUCTURAL
5 12 00-H	STEEL COLUMN- SEE STRUCTURAL
5 31 00-A	METAL ROOF DECKING- SEE STRUCTURAL
05 40 00-DD	DEFLECTION TRACK
05 40 00-GG 05 40 00-L	METAL STUD BOX HEADER, SIZE BY DELEGATED DESIGN 3 5/8" 16 GA. GALVANIZED STEEL STUD AT 16" O.C.
05 40 00-L 05 40 00-N	6" 16 GA. GALVANIZED STEEL STUD AT 16" O.C.
05 40 00 N	6" 16 GA. STEEL STUDS AT 16" O.C., CROSS BRACING AS REQUIRED.
5 44 00-A	COLD-FORMED METAL TRUSSES - SEE STRUCTURAL
5 44 00-B	COLD-FORMED METAL OUTRIGGERS - SEE STRUCTURAL
5 44 00-C	DROPPED TOP CHORD RAKE TRUSS - SEE STRUCTURAL
05 44 00-D	HEAVY GAUGE CFS BENT PLATE
15 50 00-K 15 52 13-G	PRE-MANUFACTURED ALUMINUM SHIPS LADDER 1-1/4" I.D. PAINTED GALVANIZED STEEL PIPE RAILING
16 10 53-B	1X FRT WOOD BLOCKING
6 10 53-C	2X FRT WOOD BLOCKING
06 10 53-G	2x10 TREATED WOOD FASCIA
06 16 00-A	3/4" EXTERIOR GRADE PLYWOOD
06 16 00-B	5/8" EXTERIOR GRADE PLYWOOD
06 16 00-C	1/2" EXTERIOR GRADE PLYWOOD
06 16 43-A 06 16 43-B	5/8" EXTERIOR GYPSUM SHEATHING 1/2" EXTERIOR GYPSUM SHEATHING
06 16 43-D	CONTINUOUS ALUMINUM LOUVERED SOFFIT VENT
6 40 00-W	PLASTIC LAMINATE ON 3/4" PARTICLEBOARD
7 21 00-A	SLAB PERIMETER RIGID INSULATION (R-15 FOR 24")
7 21 00-B	2" CAVITY WALL EXTRUDED POLYSTYRENE INSULATION (R-10)
7 21 00-K	3" CAVITY WALL EXTRUDED POLYSTYRENE INSULATION (R-16.8)
07 21 00-N 07 21 00-O	MINERAL WOOL BATT INSULATION THERMALLY ISOLATED COMPOSITE Z-GIRT SYSTEM W/ EDGE PROFIL RIGID INSULATION
7 21 13-A	VENTED NAIL BASE
7 21 19-A	FOAMED-IN-PLACE INSULATION
7 24 13-A	EXTERIOR INSULATION & FINISH SYSTEM (EIFS) W/3" INSULATION
7 24 13-C	EIFS COMPATIBLE SEALANT
17 24 13-J 17 24 15-A	EIFS V-GROOVE REVEAL DIRECT APPLIED FINISH SYSTEM (DAFS) SOFFIT SYSTEM OVER 5/8" EXTERIOR GYPSUM SHEATHING
7 27 26-A	FLUID APPLIED MEMBRANE AIR BARRIER, VAPOR PERMEABLE
7 27 26-B	TRANSITION FLASHING TAPE
7 31 13-A	ASPHALT SHINGLE, SEE SPECIFICATIONS
7 31 13-B	UNDERLAYMENT, SEE SPECIFICATIONS
7 31 13-D	RIDGE VENT, SEE SPECIFICATIONS
07 42 43-A 07 42 43-B	ALUMINUM COMPOSITE MATERIAL PANEL, COLOR TO MATCH EXISTI

1 1/2" VERTICAL HAT CHANNEL, SPACE AS REQUIRED FOR PANEL

ALUMINUM WALL TO ROOF HEADWALL FLASHING, MILL FINISH

ALUMINUM FASCIA CAP (CLADDING), MATCH EXISTING FASCIA COLOR

ALUMINUM EIFS TO BRICK CAP FLASHING w/ SUPPORT CLEAT, MATCH

ALUMINUM GUTTER, MATCH EXISTING SIZE, PROFILE AND COLOR

ALUMINUM 5X5 BOX GUTTER, MATCH EXISTING COLOR

ALUMINUM RECTANGULAR DOWNSPOUT, MATCH EXISTING SIZE AND

ROOF TO ROOF EXPANSION JOINT W/ FLEXIBLE BELLOW MATERIAL

WIDE STILE ALUMINUM ENTRANCE DOOR (NON-THERMAL, SEE OPENING

WIDE STILE ALUMINUM ENTRANCE DOOR (THERMAL, SEE OPENING

ALUMINUM SILL FLASHING, COLOR TO MATCH EXISTING WINDOWS

GLASS MAT FACED MOLD & MOISTURE RESISTANT 1" GYPSUM LINER

6" CH STUD 18 GA. MIN. @ 16"O.C., PROVIDE CROSS BRACING AS

PRE-FINISHED ALUMINUM FIXED LOUVER W/ BIRD SCREEN

METAL STUD BOX HEADER, SIZE BY DELEGATED DESIGN

3-5/8" STEEL STUDS @ 24" O.C. MAX BETWEEN TRUSS BOTTOM CHORDS

METAL GYPSUM BOARD CONTROL JOINT, MATCH EXISTING HEIGHT AND

TWO PIECE FLASHING, COLOR TO MATCH PANELS

ATTACHMENT

EXISTING FASCIA COLOR

BACKER ROD AND SEALANT

FLUSH WOOD DOOR

SCHEDULE)

SCHEDULE)

INSECT SCREEN

REQUIRED DEFLECTION TRACK

1 5/8" STEEL STUD

3 5/8" STEEL STUD

SOUND ISOLATION CLIP

1/4" GYPSUM WALL BOARD

RESILIENT BASE

SCHEDULE

SOUND ATTENUATION INSULATION

METAL STUD KICKERS AS REQUIRED

TO SUPPORT CEILING SOFFIT FRAMING

5/8" GYPSUM WALL BOARD (SEE SPECS FOR TYPE)

1/2" SAG RESISTANT GYPSUM CEILING BOARD

ACOUSTICAL CEILING SUSPENSION ASSEMBLY

SEMI-RECESSED FIRE EXTINGUISHER CABINET

PLASTIC LAMINATE CLAD COUNTERTOPS

CONCRETE PAVING- SEE CIVIL SHEETS

RECESSED CORNER GUARD- SEE EQUIPMENT SCHEDULE

PLASTIC LAMINATE INSTITUTIONAL CASEWORK- SEE EQUIPMENT

6" STEEL STUD

SHIM AS REQUIRED

SEALANT BOTH SIDES

ALUMINUM STEP FLASHING, MILL FINISH

INTERIOR WALL EXPANSION JOINT COVER

EXTERIOR WALL EXPANSION JOINT MATERIAL

EXPANSION JOINT VAPOR BARRIER SYSTEM

4 1/2" ALUMINUM FRAMED STOREFRONT

HOLLOW METAL DOOR/BORROWED LIGHT FRAME

ALUMINUM BRAKE METAL ADAPTOR HEAD FRAME

ALUMINUM BRAKE METAL ADAPTOR SILL FRAME

ALUMINUM WINDOW SLIDING HEAD W/ RECEPTOR

ALUMINUM WINDOWS SLIDING JAMB W/ RECEPTOR

ALUMINUM WINDOWS SLIDING SILL

ALUMINUM WINDOW, COLOR TO MATCH EXISTING WINDOWS

CEILING EXPANSION JOINT COVER

ALUMINUM DRIP EDGE

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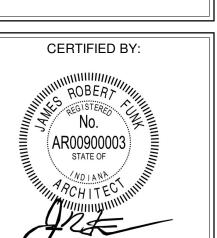
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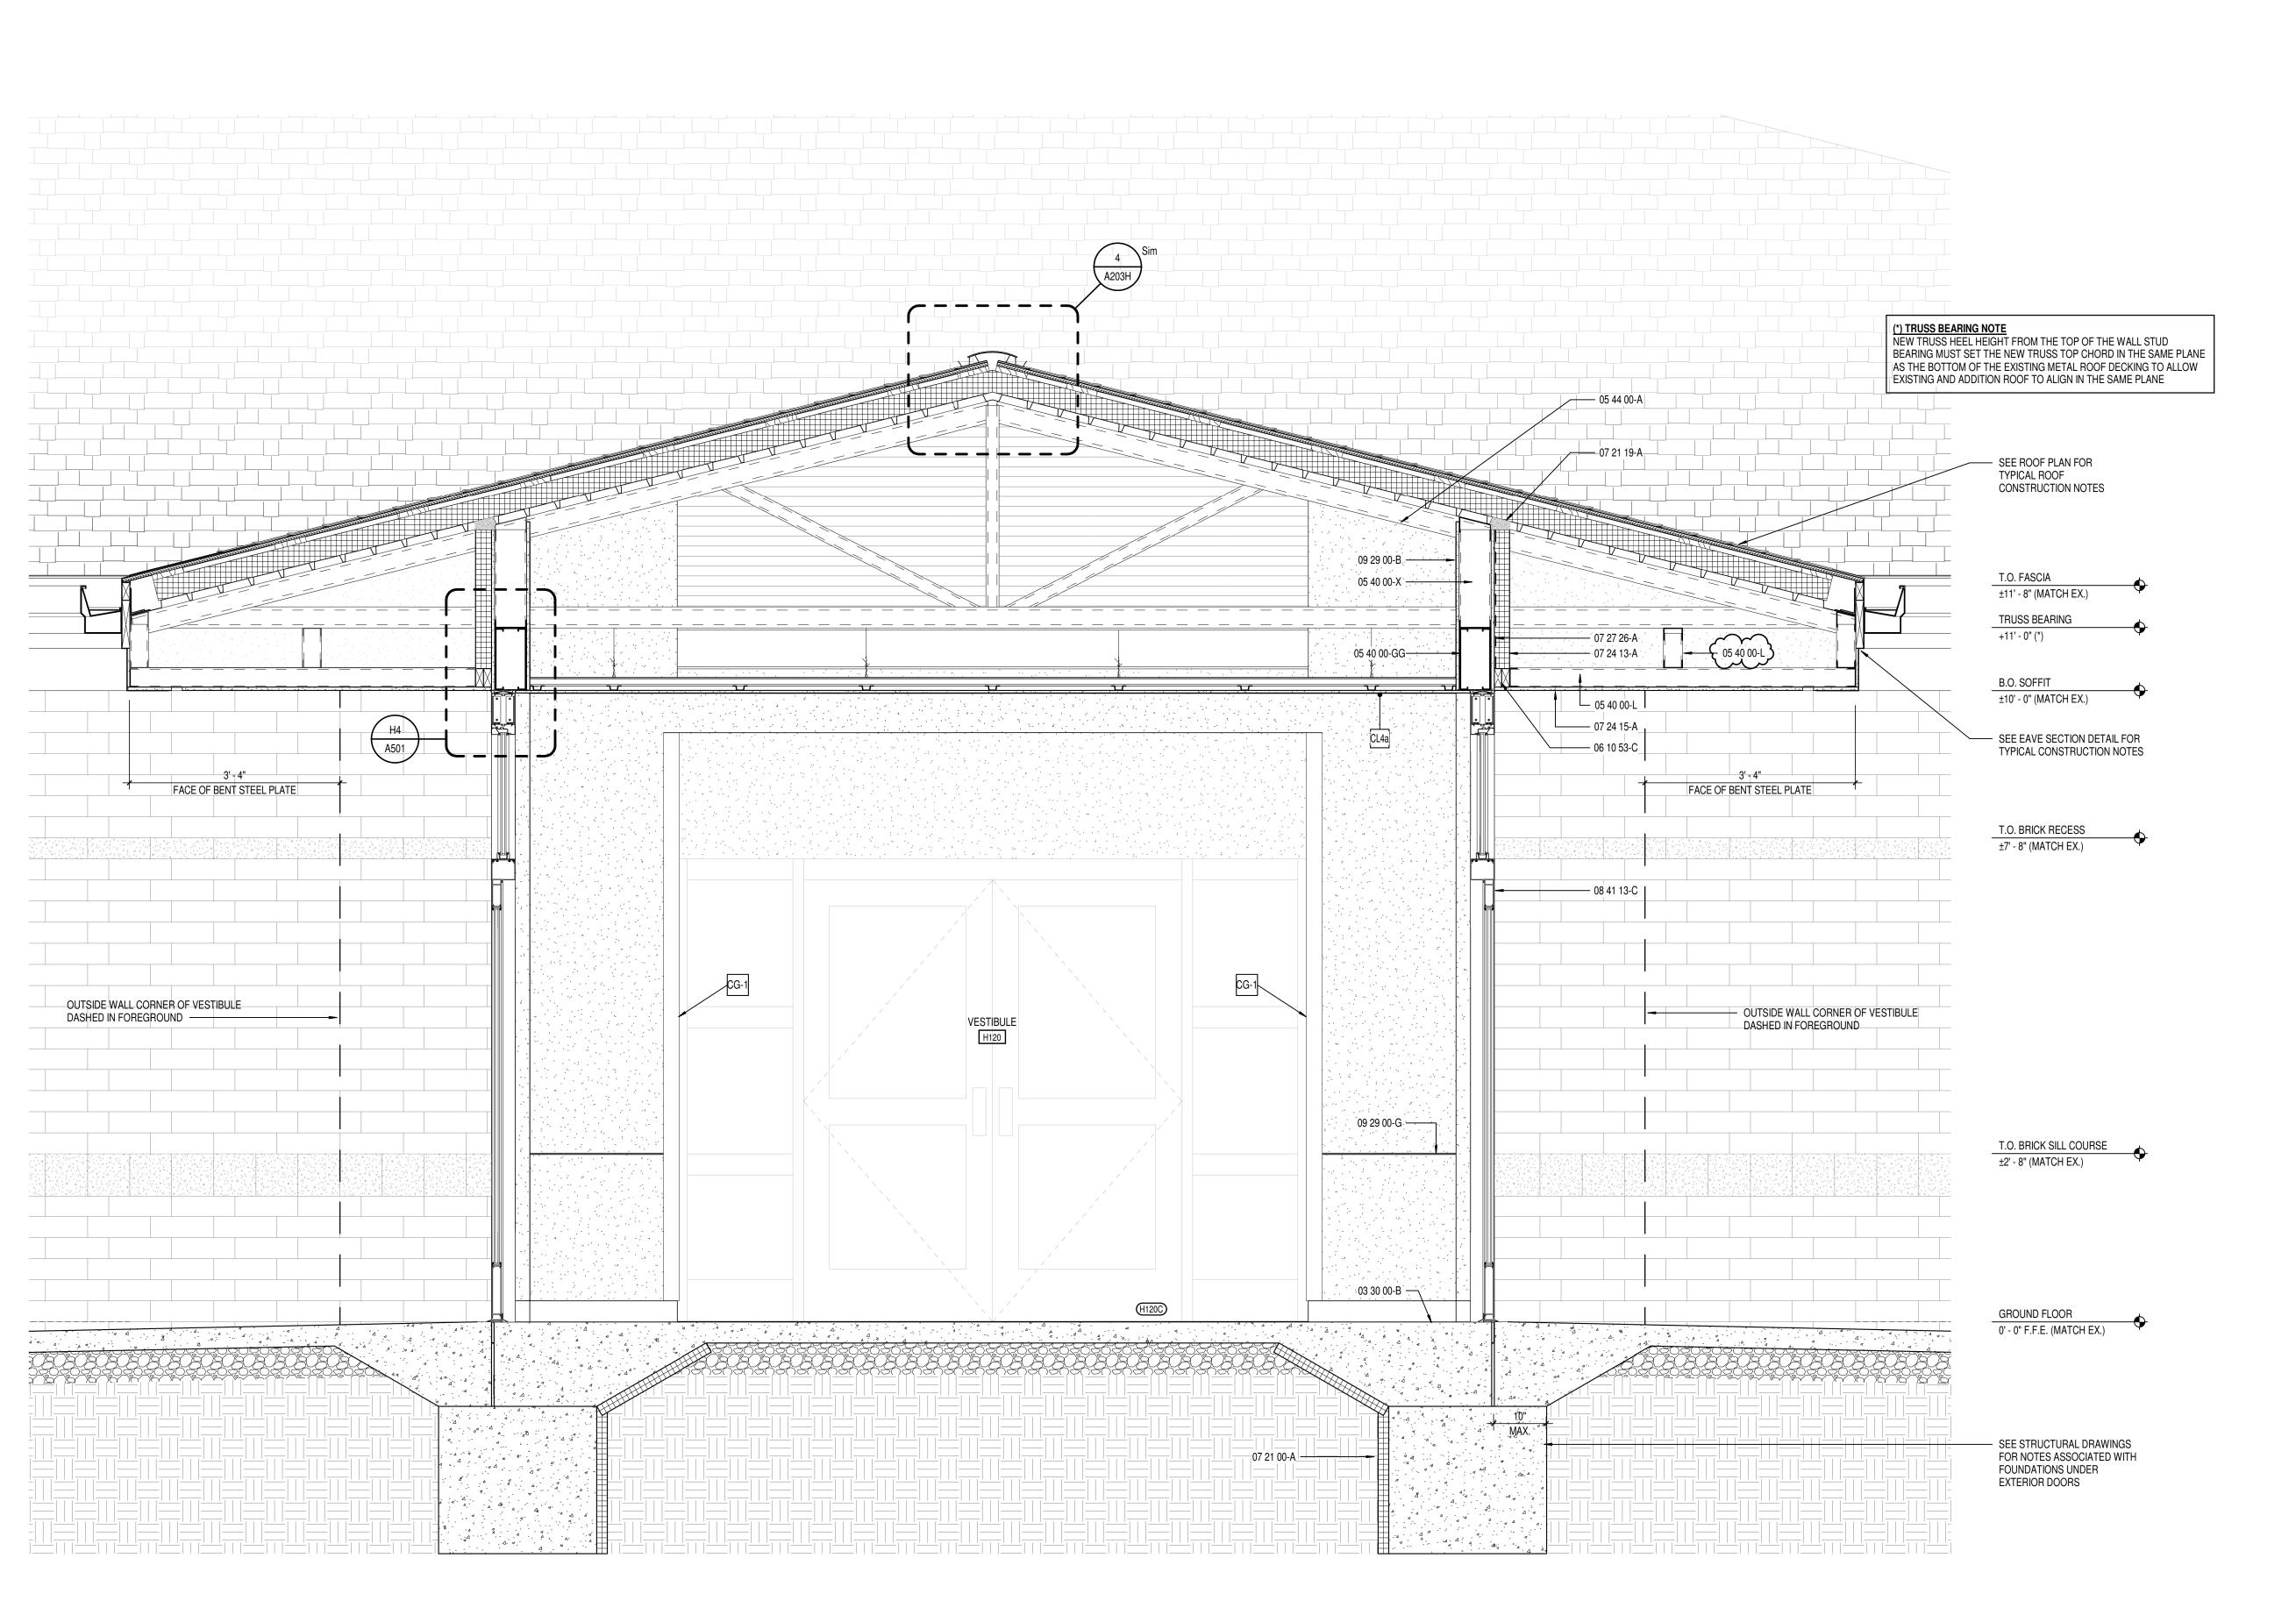
ISSUE DATE | DRAWN BY | CHECKED BY

09/30/22 JBW

DRAWING TITLE:



DRAWING NUMBER A405





1	<u> </u>
03 30 00-B	CONCRETE SLAB OVER VAPOR BARRIER ON DRAINAGE FILL. SEE STRUCTURAL
03 30 00-C	CONCRETE SLAB ON METAL DECK- SEE STRUCTURAL
03 30 00-E	CONCRETE FOOTING- SEE STRUCTURAL
03 30 00-G	1/2" EXPANSION MATERIAL
04 20 00-C	MASONRY TIE
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04 20 00-K	CAVITY DRAINAGE MATERIAL
04 20 00-L	UTILITY SIZE FIELD BRICK COLOR '1', MATCH EXISTING COLOR & TEXTURE
04 20 00-M	UTILITY SIZE ACCENT BRICK REVEAL, MATCH EXISTING COLOR, TEXTURE AND INSET DEPTH
04 20 00-N	8x8x4 NOMINAL RADIUS FRONT CUSTOM SHAPE ACCENT BRICK, MATCH EXISTING COLOR & TEXTURE
04 20 00-O	UTILITY SIZE FIELD BRICK COLOR '2', MATCH EXISTING COLOR & TEXTURE
05 12 00-B	STEEL ANGLE- SEE STRUCTURAL
05 12 00 E	CTEEL DENT DI ATE, CEE CTDI (CTI IDAI

05 12 00-E STEEL BENT PLATE- SEE STRUCTURAL 05 12 00-G STEEL BEAM- SEE STRUCTURAL 05 12 00-H STEEL COLUMN- SEE STRUCTURAL 05 31 00-A METAL ROOF DECKING- SEE STRUCTURAL 05 40 00-DD DEFLECTION TRACK 05 40 00-GG METAL STUD BOX HEADER, SIZE BY DELEGATED DESIGN 05 40 00-L 3 5/8" 16 GA. GALVANIZED STEEL STUD AT 16" O.C. 05 40 00-N 6" 16 GA. GALVANIZED STEEL STUD AT 16" O.C. 6" 16 GA. STEEL STUDS AT 16" O.C., CROSS BRACING AS REQUIRED. COLD-FORMED METAL TRUSSES - SEE STRUCTURAL

05 40 00-X
05 44 00-A
05 44 00-B
05 44 00-B
05 44 00-C
DROPPED TOP CHORD RAKE TRUSS - SEE STRUCTURAL
05 44 00-D
HEAVY GAUGE CFS BENT PLATE
05 50 00-K
PRE-MANUFACTURED ALUMINUM SHIPS LADDER
05 52 13-G
1-1/4" I.D. PAINTED GALVANIZED STEEL PIPE RAILING
06 10 53-B
1 7 16 GA. STEEL STUDS AT 16" O.C., CROSS BRACING AS REC
COLD-FORMED METAL TRUSS - SEE STRUCTURAL
DROPPED TOP CHORD RAKE TRUSS -

05 50 00-K PRE-MANUFACTURED ALUMINUM SHIPS LADDER
05 52 13-G 1-1/4" I.D. PAINTED GALVANIZED STEEL PIPE RAILIN
06 10 53-B 1X FRT WOOD BLOCKING
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06 16 00-A 3/4" EXTERIOR GRADE PLYWOOD
06 16 00-B 5/8" EXTERIOR GRADE PLYWOOD
06 16 00-C 1/2" EXTERIOR GRADE PLYWOOD

5/8" EXTERIOR GYPSUM SHEATHING

RIGID INSULATION

07 21 13-A VENTED NAIL BASE

07 21 19-A FOAMED-IN-PLACE INSULATION

07 24 13-A EXTERIOR INSULATION & FINISH SYSTEM (EIFS) W/ 3" INSULATION

06 16 43-A

07 24 13-C EIFS COMPATIBLE SEALANT
07 24 13-J EIFS V-GROOVE REVEAL
07 24 15-A DIRECT APPLIED FINISH SYSTEM (DAFS) SOFFIT SYSTEM OVER 5/8"
EXTERIOR GYPSUM SHEATHING
07 27 26-A FLUID APPLIED MEMBRANE AIR BARRIER, VAPOR PERMEABLE

07 27 26-B TRANSITION FLASHING TAPE
07 31 13-A ASPHALT SHINGLE, SEE SPECIFICATIONS
07 31 13-B UNDERLAYMENT, SEE SPECIFICATIONS
07 31 13-D RIDGE VENT, SEE SPECIFICATIONS
07 42 43-A ALUMINUM COMPOSITE MATERIAL PANEL, COLOR TO MATCH EXISTING
07 42 43-B 1 1/2" VERTICAL HAT CHANNEL, SPACE AS REQUIRED FOR PANEL
ATTACHMENT

07 62 00-A ALUMINUM FASCIA CAP (CLADDING), MATCH EXISTING FASCIA COLOR
07 62 00-B ALUMINUM WALL TO ROOF HEADWALL FLASHING, MILL FINISH
07 62 00-C ALUMINUM EIFS TO BRICK CAP FLASHING W/ SUPPORT CLEAT, MATCH
EXISTING FASCIA COLOR
07 62 00-D ALUMINUM DRIP EDGE

07 62 00-E ALUMINUM STEP FLASHING, MILL FINISH
07 71 00-A ALUMINUM GUTTER, MATCH EXISTING SIZE, PROFILE AND COLOR
07 71 00-B ALUMINUM RECTANGULAR DOWNSPOUT, MATCH EXISTING SIZE AND COLOR
07 71 00-C ALUMINUM 5X5 BOX GUTTER, MATCH EXISTING COLOR

TWO PIECE FLASHING, COLOR TO MATCH PANELS

07 71 00-C ALUMINUM 5X5 BOX GUTTER, MATCH EXISTING COLOR
07 71 29-A ROOF TO ROOF EXPANSION JOINT W/ FLEXIBLE BELLOW MATERIAL
07 92 00-A BACKER ROD AND SEALANT
07 92 00-B SEALANT
07 95 00-B INTERIOR WALL EXPANSION JOINT COVER

07 95 00-B INTERIOR WALL EXPANSION JOINT COVER
07 95 00-C CEILING EXPANSION JOINT COVER
07 95 00-D EXTERIOR WALL EXPANSION JOINT MATERIAL
07 95 00-E EXPANSION JOINT VAPOR BARRIER SYSTEM
08 11 13-A HOLLOW METAL DOOR/BORROWED LIGHT FRAME
08 14 16-A FLUSH WOOD DOOR

08 41 13-A 4 1/2" ALUMINUM FRAMED STOREFRONT
08 41 13-B WIDE STILE ALUMINUM ENTRANCE DOOR (NON-THERMAL, SEE OPENING SCHEDULE)
08 41 13-C WIDE STILE ALUMINUM ENTRANCE DOOR (THERMAL, SEE OPENING SCHEDULE)
08 41 13-E ALUMINUM BRAKE METAL ADAPTOR HEAD FRAME

08 41 13-F ALUMINUM BRAKE METAL ADAPTOR SILL FRAME
08 51 13-A ALUMINUM WINDOW, COLOR TO MATCH EXISTING WINDOWS
08 51 13-B ALUMINUM WINDOW SLIDING HEAD W/ RECEPTOR
08 51 13-C ALUMINUM WINDOWS SLIDING SILL
08 51 13-D ALUMINUM WINDOWS SLIDING JAMB W/ RECEPTOR
08 51 13-H INSECT SCREEN

08 51 13-J SHIM AS REQUIRED
08 51 13-K SEALANT BOTH SIDES
08 51 13-L ALUMINUM SILL FLASHING, COLOR TO MATCH EXISTING WINDOWS
08 91 19-A PRE-FINISHED ALUMINUM FIXED LOUVER W/ BIRD SCREEN
09 21 16-B GLASS MAT FACED MOLD & MOISTURE RESISTANT 1" GYPSUM LINER PANEL

PANEL
09 21 16-E
6" CH STUD 18 GA. MIN. @ 16"O.C., PROVIDE CROSS BRACING AS REQUIRED
09 22 16-B
DEFLECTION TRACK
09 22 16-F
1 5/8" STEEL STUD
09 22 16-H
3 5/8" STEEL STUD

09 22 16-K
6" STEEL STUD
09 22 16-M
METAL STUD KICKERS AS REQUIRED
09 22 16-O
SOUND ISOLATION CLIP
09 22 16-P
METAL STUD BOX HEADER, SIZE BY DELEGATED DESIGN
09 22 16-Q
3-5/8" STEEL STUDS @ 24" O.C. MAX BETWEEN TRUSS BOTTOM CHORDS
TO SUPPORT CEILING SOFFIT FRAMING

09 51 13-A ACOUSTICAL CEILING SUSPENSION ASSEMBLY
09 65 13-A RESILIENT BASE
10 26 00-A RECESSED CORNER GUARD- SEE EQUIPMENT SCHEDULE
10 44 13-C SEMI-RECESSED FIRE EXTINGUISHER CABINET
12 32 16-A PLASTIC LAMINATE INSTITUTIONAL CASEWORK- SEE EQUIPMENT SCHEDULE

CONCRETE PAVING- SEE CIVIL SHEETS

8831 Keystone Crossing, Indianapolis, IN 46240

Westfield Washington Schools
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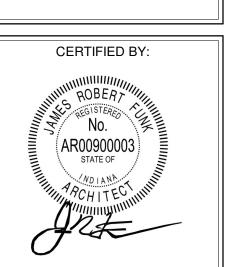
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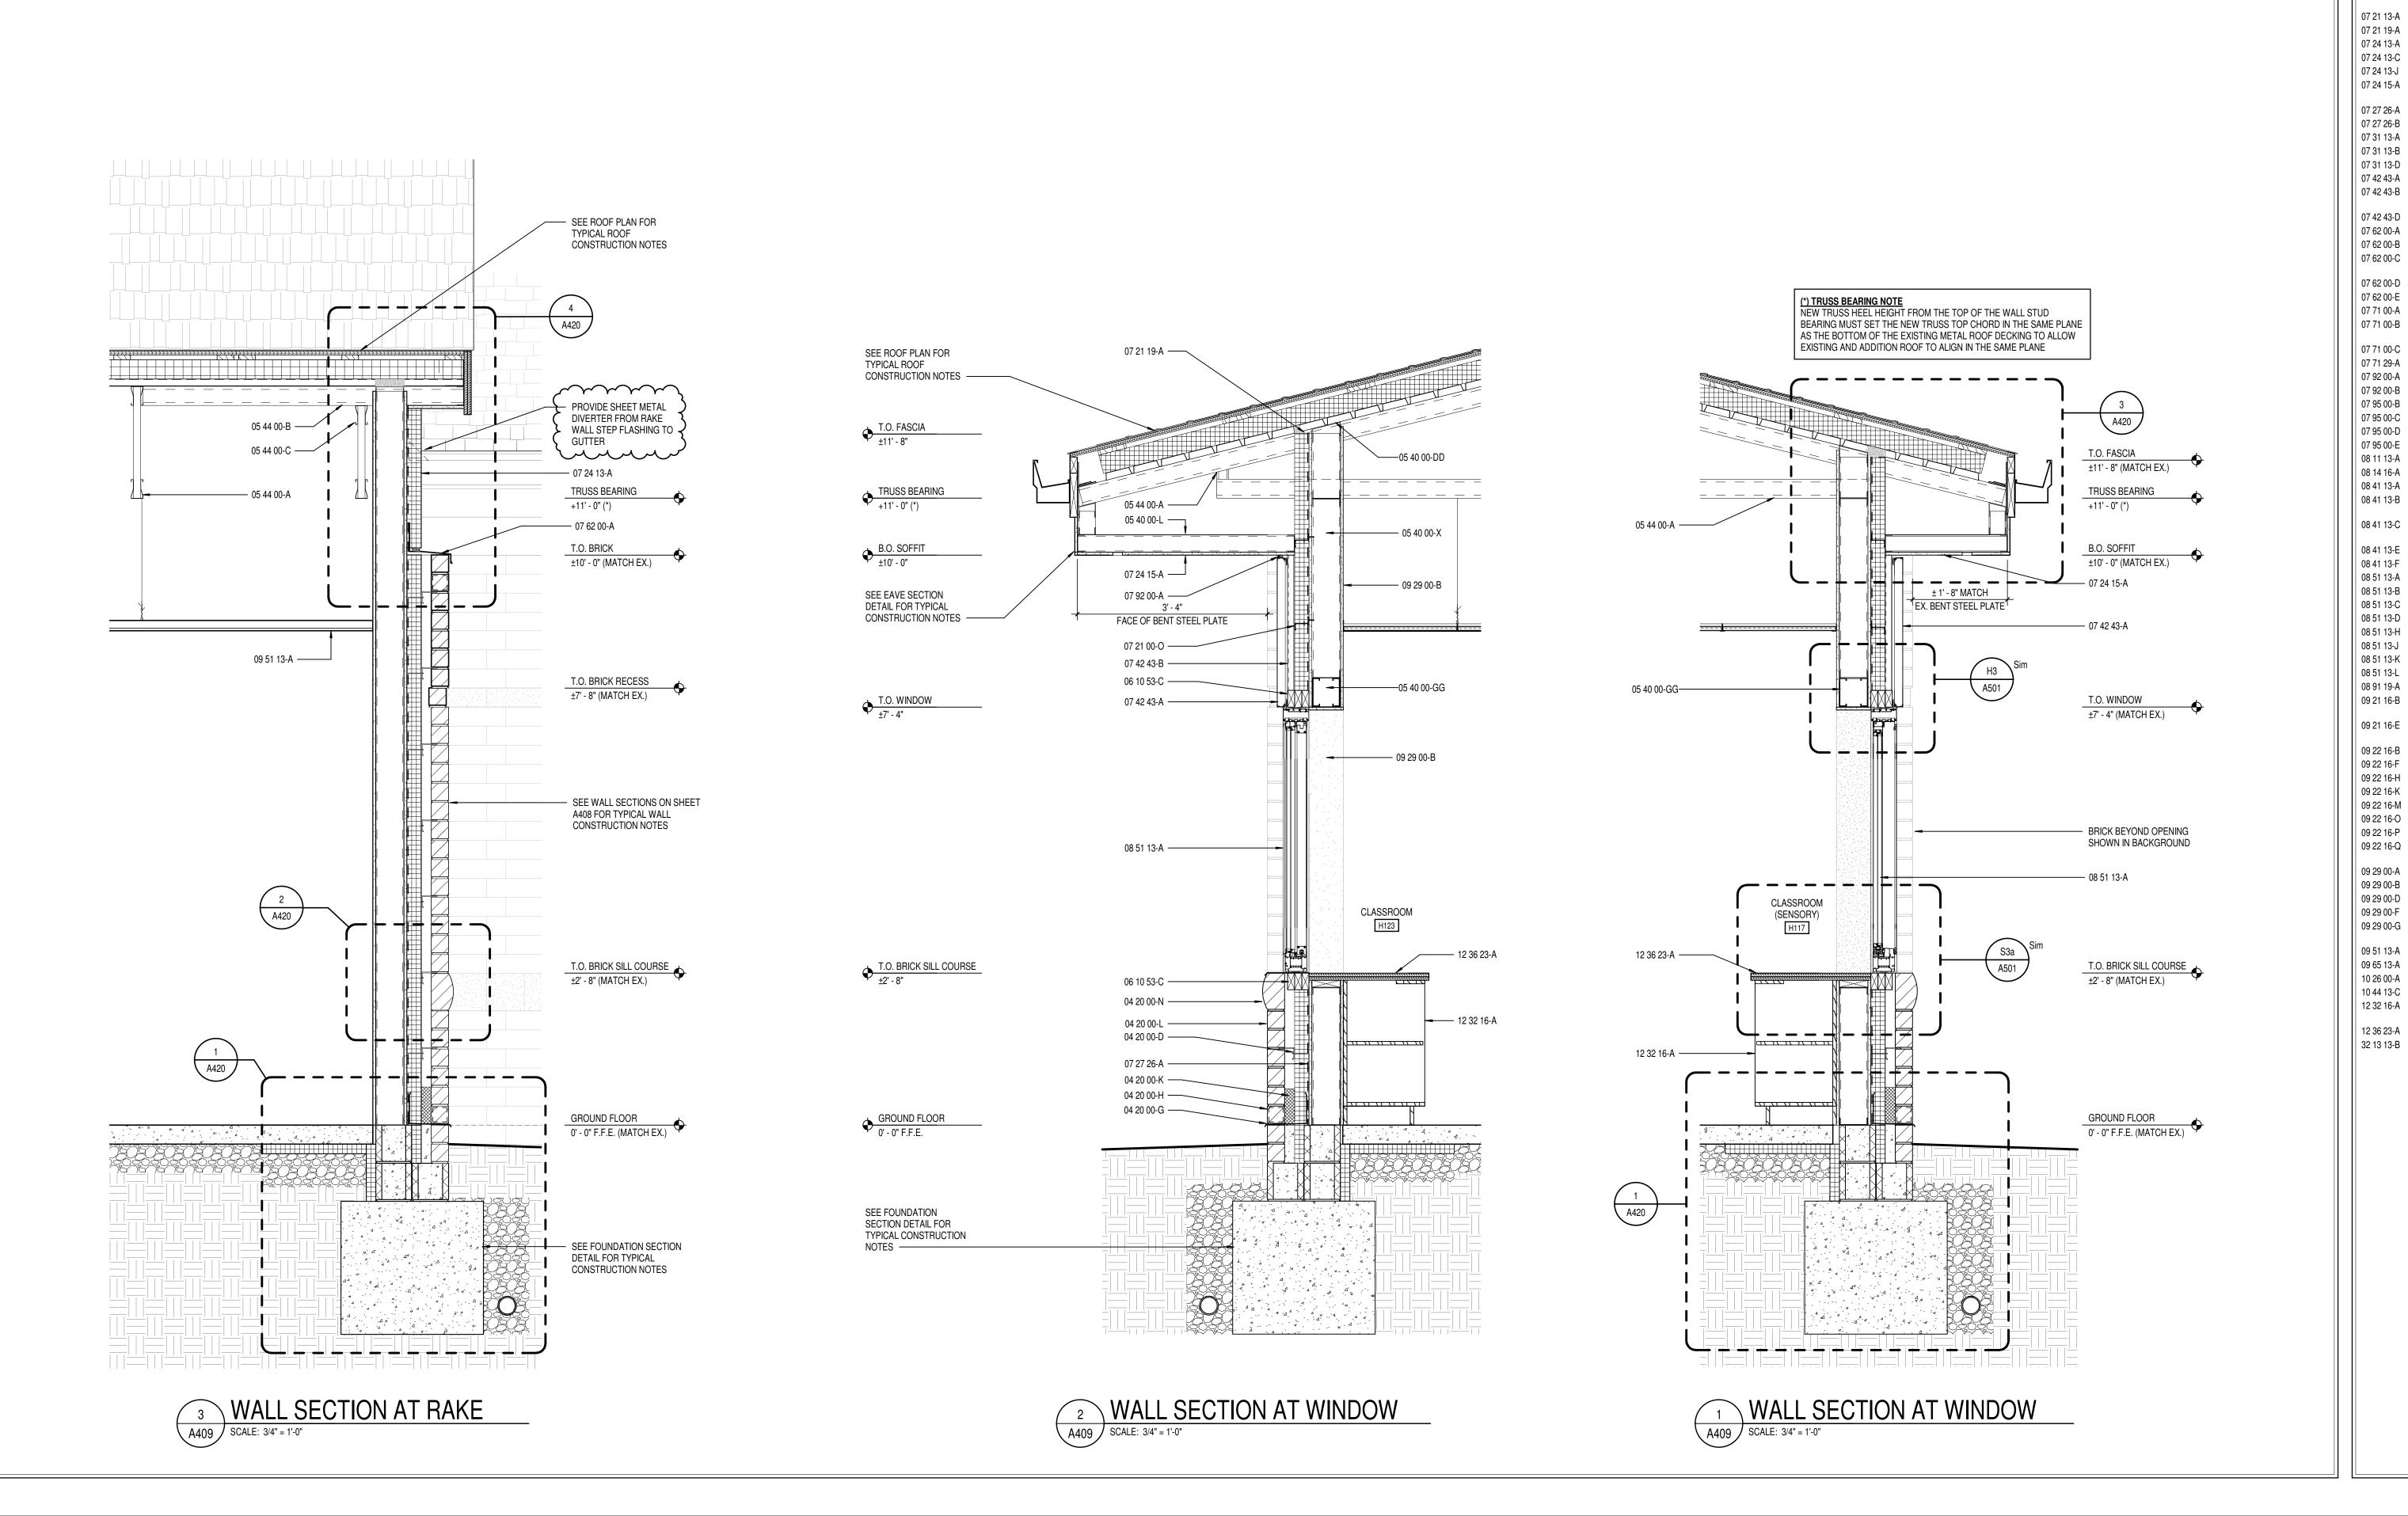
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DRAWING TITLE:

PARTIAL BUILDING SECTIONS



A407



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08 51 13-A ALUMINUM WINDOW, COLOR TO MATCH EXISTING WINDOWS 08 51 13-B ALUMINUM WINDOWS SLIDING HEAD W/ RECEPTOR 08 51 13-C ALUMINUM WINDOWS SLIDING SILL 08 51 13-D ALUMINUM WINDOWS SLIDING JAMB W/ RECEPTOR 08 51 13-H INSECT SCREEN 08 51 13-J SHIM AS REQUIRED 08 51 13-J SHIM AS REQUIRED 08 51 13-L ALUMINUM SILL FLASHING, COLOR TO MATCH EXISTING WINDOWS 08 51 13-L ALUMINUM SILL FLASHING, COLOR TO MATCH EXISTING WINDOWS 08 51 13-L ALUMINUM SILL FLASHING, COLOR TO MATCH EXISTING WINDOWS 08 51 13-L ORDON SEALANT BOTH SIDES 09 21 16-B GLASS MAT FACED MOLD & MOISTURE RESISTANT 1" GYPSUM LINER PANEL 09 22 16-B DEFLECTION TRACK 09 22 16-F 15 /6" STEEL STUD 09 22 16-K 6" STEEL STUD 09 22 16-K 6" STEEL STUD 09 22 16-C OSOUND ISOLATION CLIP 09 22 16-C OSOUND ISOLATION CLIP 09 22 16-C OSOUND SOLATION CLIP 09 29 00-A 1/4" GYPSUM WALL BOARD 09 29 00-B 5/8" GYPSUM WALL BOARD 09 29 00-F 1/2" SAG RESISTANT GYPSUM CELLING BOARD 09 29 00-G METAL GYPSUM BOARD CONTROL JOINT, MATCH EXISTING HEIGHT AND	07 31 13-D 07 42 43-A 07 42 43-B 07 42 43-D 07 62 00-A 07 62 00-B 07 62 00-C 07 62 00-E 07 71 00-A 07 71 00-B 07 71 00-C 07 71 29-A 07 92 00-B 07 95 00-B 07 95 00-C 07 95 00-D 07 95 00-C 08 11 13-A 08 41 13-B 08 41 13-C	RIDGE VENT, SEE SPECIFICATIONS ALUMINUM COMPOSITE MATERIAL PANEL, COLOR TO MATCH EXISTING 1 1/2" VERTICAL HAT CHANNEL, SPACE AS REQUIRED FOR PANEL ATTACHMENT TWO PIECE FLASHING, COLOR TO MATCH PANELS ALUMINUM FASCIA CAP (CLADDING), MATCH EXISTING FASCIA COLOR ALUMINUM WALL TO ROOF HEADWALL FLASHING, MILL FINISH ALUMINUM EIFS TO BRICK CAP FLASHING w/ SUPPORT CLEAT, MATCH EXISTING FASCIA COLOR ALUMINUM DRIP EDGE ALUMINUM STEP FLASHING, MILL FINISH ALUMINUM GUTTER, MATCH EXISTING SIZE, PROFILE AND COLOR ALUMINUM RECTANGULAR DOWNSPOUT, MATCH EXISTING SIZE AND COLOR ALUMINUM 5X5 BOX GUTTER, MATCH EXISTING COLOR ROOF TO ROOF EXPANSION JOINT W/ FLEXIBLE BELLOW MATERIAL BACKER ROD AND SEALANT SEALANT INTERIOR WALL EXPANSION JOINT COVER CEILING EXPANSION JOINT COVER EXTERIOR WALL EXPANSION JOINT MATERIAL EXPANSION JOINT VAPOR BARRIER SYSTEM HOLLOW METAL DOOR/BORROWED LIGHT FRAME FLUSH WOOD DOOR 4 1/2" ALUMINUM FRAMED STOREFRONT WIDE STILE ALUMINUM ENTRANCE DOOR (THERMAL, SEE OPENING SCHEDULE) WIDE STILE ALUMINUM ENTRANCE DOOR (THERMAL, SEE OPENING SCHEDULE)	Westfield Washington Scho ADDITION & RENOVATION AREY RIDGE ELEMEN 31 CAREY ROAD, WESTFIELD, INDIA
08 51 13-B ALUMINUM WINDOW SLIDING HEAD W/ RECEPTOR 08 51 13-C ALUMINUM WINDOWS SLIDING SILL 08 51 13-C ALUMINUM WINDOWS SLIDING SILL 08 51 13-D ALUMINUM WINDOWS SLIDING SILL 08 51 13-D ALUMINUM WINDOWS SLIDING JAMB W/ RECEPTOR 18 51 13-H INSECT SCREEN 18 51 13-H INSECT SCREEN 18 51 13-L SEALANT BOTH SIDES 18 51 13-L ALUMINUM SILL FLASHING, COLOR TO MATCH EXISTING WINDOWS 18 91 19-A PRE-FINISHED ALUMINUM FIXED LOUVER W BIRD SCREEN 19 21 16-B GLASS MAT FACED MOLD & MOISTURE RESISTANT 1" GYPSUM LINER PANEL 09 22 16-B DEFLECTION TRACK 19 22 16-B DEFLECTION TRACK 19 22 16-C SOUND ISOLATION CLIP 09 22 16-C SOUND ISOLATION CLIP 09 22 16-C SOUND SCHEEN STUD SØ 24" O.C. MAX BETWEEN TRUSS BOTTOM CHORDS TO SUPPORT CEILING SOFFIT FRAMING 19 29 00-A 1/4" GYPSUM WALL BOARD 1/2" SAG RESISTANT GYPSUM CEILING BOARD 19 29 00-G METAL GYPSUM BOARD CONTROL JOINT, MATCH EXISTING HEIGHT AND	07 31 13-D 07 42 43-A 07 42 43-B 07 42 43-D 07 62 00-A 07 62 00-B 07 62 00-C 07 62 00-E 07 71 00-B 07 71 00-C 07 71 29-A 07 92 00-B 07 95 00-B 07 95 00-C 07 95 00-D 07 95 00-C 08 11 13-A 08 41 13-B 08 41 13-C 08 41 13-E	RIDGE VENT, SEE SPECIFICATIONS ALUMINUM COMPOSITE MATERIAL PANEL, COLOR TO MATCH EXISTING 1 1/2" VERTICAL HAT CHANNEL, SPACE AS REQUIRED FOR PANEL ATTACHMENT TWO PIECE FLASHING, COLOR TO MATCH PANELS ALUMINUM FASCIA CAP (CLADDING), MATCH EXISTING FASCIA COLOR ALUMINUM WALL TO ROOF HEADWALL FLASHING, MILL FINISH ALUMINUM EIFS TO BRICK CAP FLASHING w/ SUPPORT CLEAT, MATCH EXISTING FASCIA COLOR ALUMINUM DRIP EDGE ALUMINUM STEP FLASHING, MILL FINISH ALUMINUM GUTTER, MATCH EXISTING SIZE, PROFILE AND COLOR ALUMINUM RECTANGULAR DOWNSPOUT, MATCH EXISTING SIZE AND COLOR ALUMINUM 5X5 BOX GUTTER, MATCH EXISTING COLOR ROOF TO ROOF EXPANSION JOINT W/ FLEXIBLE BELLOW MATERIAL BACKER ROD AND SEALANT SEALANT INTERIOR WALL EXPANSION JOINT COVER CEILING EXPANSION JOINT COVER EXTERIOR WALL EXPANSION JOINT MATERIAL EXPANSION JOINT VAPOR BARRIER SYSTEM HOLLOW METAL DOOR/BORROWED LIGHT FRAME FLUSH WOOD DOOR 4 1/2" ALUMINUM FRAMED STOREFRONT WIDE STILE ALUMINUM ENTRANCE DOOR (NON-THERMAL, SEE OPENING SCHEDULE) WIDE STILE ALUMINUM ENTRANCE DOOR (THERMAL, SEE OPENING SCHEDULE) ALUMINUM BRAKE METAL ADAPTOR HEAD FRAME	Westfield Washington Scho ADDITION & RENOVATION AREY RIDGE ELEMEN 31 CAREY ROAD, WESTFIELD, INDIA
ALDMINUM WINDOWS SLIDING SILL 8 51 13-D ALLMINUM WINDOWS SLIDING JAMB W/ RECEPTOR 8 51 13-H INSECT SCREEN 8 51 13-J SHIM AS REQUIRED 8 51 13-L 8 51 13-L ALDMINUM SILL FLASHING, COLOR TO MATCH EXISTING WINDOWS 8 9 11 9-A PRE-FINISHED ALUMINUM FIXED LOUVER W/ BIRD SCREEN 9 21 16-B GLASS MAT FACED MOLD & MOISTURE RESISTANT 1" GYPSUM LINER PANEL 9 21 16-E 6" CH STUD 18 GA. MIN. @ 16"O.C., PROVIDE CROSS BRACING AS REQUIRED 9 22 16-B 9 22 16-H 3 5/8" STEEL STUD 9 22 16-K 6" STEEL STUD 9 22 16-M METAL STUD KICKERS AS REQUIRED 9 22 16-C 9 22 16-C 3 5/8" STEEL STUD SQ 24" O.C. MAX BETWEEN TRUSS BOTTOM CHORDS TO SUPPORT CEILING SOFFIT FRAMING 9 29 00-A 1/4" GYPSUM WALL BOARD 9 29 00-B 5/8" GYPSUM WALL BOARD 9 29 00-F 1/2" SAG RESISTANT GYPSUM CEILING BOARD 9 29 00-G METAL GYPSUM BOARD CONTROL JOINT, MATCH EXISTING HEIGHT AND	07 31 13-D 07 42 43-A 07 42 43-B 07 42 43-D 07 62 00-A 07 62 00-B 07 62 00-C 07 62 00-E 07 71 00-B 07 71 00-C 07 71 29-A 07 92 00-B 07 95 00-B 07 95 00-C 07 95 00-D 07 95 00-C 08 11 13-A 08 41 13-A 08 41 13-B 08 41 13-C 08 41 13-F	RIDGE VENT, SEE SPECIFICATIONS ALUMINUM COMPOSITE MATERIAL PANEL, COLOR TO MATCH EXISTING 1 1/2" VERTICAL HAT CHANNEL, SPACE AS REQUIRED FOR PANEL ATTACHMENT TWO PIECE FLASHING, COLOR TO MATCH PANELS ALUMINUM FASCIA CAP (CLADDING), MATCH EXISTING FASCIA COLOR ALUMINUM WALL TO ROOF HEADWALL FLASHING, MILL FINISH ALUMINUM EIFS TO BRICK CAP FLASHING w/ SUPPORT CLEAT, MATCH EXISTING FASCIA COLOR ALUMINUM DRIP EDGE ALUMINUM STEP FLASHING, MILL FINISH ALUMINUM GUTTER, MATCH EXISTING SIZE, PROFILE AND COLOR ALUMINUM FECTANGULAR DOWNSPOUT, MATCH EXISTING SIZE AND COLOR ALUMINUM 5X5 BOX GUTTER, MATCH EXISTING COLOR ROOF TO ROOF EXPANSION JOINT W/ FLEXIBLE BELLOW MATERIAL BACKER ROD AND SEALANT SEALANT INTERIOR WALL EXPANSION JOINT COVER CEILING EXPANSION JOINT COVER EXTERIOR WALL EXPANSION JOINT MATERIAL EXPANSION JOINT VAPOR BARRIER SYSTEM HOLLOW METAL DOOR/BORROWED LIGHT FRAME FLUSH WOOD DOOR 4 1/2" ALUMINUM FRAMED STOREFRONT WIDE STILE ALUMINUM ENTRANCE DOOR (NON-THERMAL, SEE OPENING SCHEDULE) WIDE STILE ALUMINUM ENTRANCE DOOR (THERMAL, SEE OPENING SCHEDULE) ALUMINUM BRAKE METAL ADAPTOR HEAD FRAME ALUMINUM BRAKE METAL ADAPTOR SILL FRAME	Westfield Washington Scho ADDITION & RENOVATION CAREY RIDGE ELEMEN 16231 CAREY ROAD, WESTFIELD, INDIA
08 51 13-H INSECT SCREEN 08 51 13-J SHIM AS REQUIRED 08 51 13-K SEALANT BOTH SIDES 08 51 13-L ALUMINUM SILL FLASHING, COLOR TO MATCH EXISTING WINDOWS 08 91 19-A PRE-FINISHED ALUMINUM FIXED LOUVER W/ BIRD SCREEN 09 21 16-B GLASS MAT FACED MOLD & MOISTURE RESISTANT 1" GYPSUM LINER PANEL 09 21 16-E 6" CH STUD 18 GA. MIN. @ 16"O.C., PROVIDE CROSS BRACING AS REQUIRED 09 22 16-B DEFLECTION TRACK 09 22 16-H 35/8" STEEL STUD 09 22 16-K 6" STEEL STUD 09 22 16-W METAL STUD KICKERS AS REQUIRED 09 22 16-O SOUND ISOLATION CLIP 09 22 16-O 3-5/8" STEEL STUDS @ 24" O.C. MAX BETWEEN TRUSS BOTTOM CHORDS TO SUPPORT CEILING SOFFIT FRAMING 09 29 00-A 1/4" GYPSUM WALL BOARD 09 29 00-B 5/8" GYPSUM WALL BOARD (SEE SPECS FOR TYPE) 09 29 00-C METAL GYPSUM BOARD CONTROL JOINT, MATCH EXISTING HEIGHT AND	07 31 13-D 07 42 43-A 07 42 43-B 07 42 43-D 07 62 00-A 07 62 00-B 07 62 00-C 07 62 00-E 07 71 00-A 07 71 00-B 07 71 00-C 07 71 29-A 07 92 00-B 07 95 00-B 07 95 00-C 07 95 00-C 07 95 00-D 07 95 00-E 08 11 13-A 08 41 13-B 08 41 13-C 08 41 13-F 08 51 13-A 08 51 13-A 08 51 13-B	RIDGE VENT, SEE SPECIFICATIONS ALUMINUM COMPOSITE MATERIAL PANEL, COLOR TO MATCH EXISTING 1 1/2" VERTICAL HAT CHANNEL, SPACE AS REQUIRED FOR PANEL ATTACHMENT TWO PIECE FLASHING, COLOR TO MATCH PANELS ALUMINUM FASCIA CAP (CLADDING), MATCH EXISTING FASCIA COLOR ALUMINUM WALL TO ROOF HEADWALL FLASHING, MILL FINISH ALUMINUM EIFS TO BRICK CAP FLASHING W/ SUPPORT CLEAT, MATCH EXISTING FASCIA COLOR ALUMINUM DRIP EDGE ALUMINUM STEP FLASHING, MILL FINISH ALUMINUM GUTTER, MATCH EXISTING SIZE, PROFILE AND COLOR ALUMINUM RECTANGULAR DOWNSPOUT, MATCH EXISTING SIZE AND COLOR ALUMINUM 5X5 BOX GUTTER, MATCH EXISTING COLOR ROOF TO ROOF EXPANSION JOINT W/ FLEXIBLE BELLOW MATERIAL BACKER ROD AND SEALANT SEALANT INTERIOR WALL EXPANSION JOINT COVER CEILING EXPANSION JOINT COVER EXTERIOR WALL EXPANSION JOINT MATERIAL EXPANSION JOINT VAPOR BARRIER SYSTEM HOLLOW METAL DOOR/BORROWED LIGHT FRAME FLUSH WOOD DOOR 4 1/2" ALUMINUM FRAMED STOREFRONT WIDE STILE ALUMINUM ENTRANCE DOOR (NON-THERMAL, SEE OPENING SCHEDULE) WIDE STILE ALUMINUM ENTRANCE DOOR (THERMAL, SEE OPENING SCHEDULE) ALUMINUM BRAKE METAL ADAPTOR HEAD FRAME ALUMINUM BRAKE METAL ADAPTOR SILL FRAME ALUMINUM WINDOW, COLOR TO MATCH EXISTING WINDOWS ALUMINUM WINDOW SLIDING HEAD W/ RECEPTOR	Westfield Washington Scho ADDITION & RENOVATION CAREY RIDGE ELEMEN 16231 CAREY ROAD, WESTFIELD, INDIA
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	07 31 13-D 07 42 43-A 07 42 43-B 07 42 43-D 07 62 00-A 07 62 00-B 07 62 00-E 07 71 00-C 07 71 00-B 07 71 00-C 07 71 29-A 07 92 00-B 07 95 00-D 07 95 00-D 07 95 00-D 07 95 00-E 08 11 13-A 08 14 13-B 08 41 13-B 08 41 13-B 08 41 13-B 08 41 13-B 08 51 13-A 08 51 13-B 08 51 13-C 09 21 16-B 09 22 16-B 09 22 16-B 09 22 16-B 09 22 16-C	RIDGE VENT, SEE SPECIFICATIONS ALUMINUM COMPOSITE MATERIAL PANEL, COLOR TO MATCH EXISTING 1 1/2" VERTICAL HAT CHANNEL, SPACE AS REQUIRED FOR PANEL ATTACHMENT TWO PIECE FLASHING, COLOR TO MATCH PANELS ALUMINUM FASCIA CAP (CLADDING), MATCH EXISTING FASCIA COLOR ALUMINUM FASCIA CAP (CLADDING), MATCH EXISTING FASCIA COLOR ALUMINUM WALL TO ROOF HEADWALL FLASHING, MILL FINISH ALUMINUM BIFS TO BRICK CAP FLASHING W/ SUPPORT CLEAT, MATCH EXISTING FASCIA COLOR ALUMINUM STEP PLASHING, MILL FINISH ALUMINUM STEP FLASHING, MILL FINISH ALUMINUM STED FLASHING, MILL FINISH ALUMINUM FECTANGULAR DOWNSPOUT, MATCH EXISTING SIZE AND COLOR ALUMINUM FECTANGULAR DOWNSPOUT, MATCH EXISTING SIZE AND COLOR ALUMINUM FECTANGULAR DOWNSPOUT, MATCH EXISTING SIZE AND COLOR ALUMINUM STE PLASHING, MILL FINISH BACKER ROD AND SEALANT INTERIOR WALL EXPANSION JOINT COVER EXTERIOR WALL EXPANSION JOINT COVER EXTERIOR WALL EXPANSION JOINT COVER EXTERIOR WALL EXPANSION JOINT TOVER EXTERIOR WALL EXPANSION JOINT MATCH EXISTING WALL E	SCOPE DRAWINGS: These drawings indicate the general scope of the project in terms of architectural design concept, the dimensions of the building, the major architectural elements and the type of structural, mechanical and electrical systems. The drawings do not necessarily indicate or describe all work required for full performance and completion of the requirements of the Contract. On the basis of the general scope indicated or described, the trade contractors shall furnish all items required for the proper execution and completion of the work. REVISIONS: 1 ADDENDUM #2 10-27-22
DDAWING TITLE:	07 31 13-D 07 42 43-A 07 42 43-B 07 42 43-D 07 62 00-A 07 62 00-B 07 62 00-E 07 71 00-B 07 71 00-B 07 71 00-B 07 71 29-A 07 92 00-B 07 95 00-C 07 95 00-C 07 95 00-C 07 95 00-D 07 95 00-E 08 11 13-A 08 41 13-B 08 41 13-B 08 41 13-B 08 41 13-C 08 41 13-B 08 41 13-C 08 41 13-B 08 51 13-B 09 21 16-B 09 22 16-B	RIDGE VENT, SEE SPECIFICATIONS ALUMINUM COMPOSITE MATERIAL PANEL, COLOR TO MATCH EXISTING 1 1/2' VERTICAL HAT CHANNEL, SPACE AS REQUIRED FOR PANEL ATTACHMENT TWO PIECE FLASHING, COLOR TO MATCH PANELS ALUMINUM FASCIA CAP (CLADDING), MATCH EXISTING FASCIA COLOR ALUMINUM WALL TO ROOF HEADWALL FLASHING, MILL FINISH ALUMINUM FEST TO BRICK CAP FLASHING W/ SUPPORT CLEAT, MATCH EXISTING FASCIA COLOR ALUMINUM STEP FLASHING, MILL FINISH ALUMINUM STEP SACIA COLOR ALUMINUM FECTANGULAR DOWNSPOUT, MATCH EXISTING SIZE AND COLOR ALUMINUM SX5 BOX GUTTER, MATCH EXISTING COLOR ROOF TO ROOF EXPANSION JOINT TOVER CEILING EXPANSION JOINT COVER CEILING EXPANSION JOINT WATERIAL EXPANSION JOINT VAPOR BARRIER SYSTEM HOLLOW METAL DOOR/BORROWED LIGHT FRAME FLUSH WOOD DOOR 4 1/2' ALUMINUM FRAMED STOREFRONT WIDE STILE ALUMINUM ENTRANCE DOOR (NON-THERMAL, SEE OPENING SCHEDULE) WIDE STILE ALUMINUM ENTRANCE DOOR (THERMAL, SEE OPENING SCHEDULE) ALUMINUM WINDOWS SLIDING HEAD WRECEPTOR ALUMINUM WINDOWS SLIDING HEAD WRECEPTOR ALUMINUM WINDOWS SLIDING JAMB W/ RECEPTOR OF STEEL STUD 6' STEEL STUD 7-8''S STEEL STUD 7-8''S STEEL STUD 8-8''S STEEL STUD 8-8	SCOPE DRAWINGS: These drawings indicate the general scope of the project in terms of architectural design concept, the dimensions of the building, the major architectural elements and the type of structural, mechanical and electrical systems. The drawings do not necessarily indicate or describe all work required for full performance and completion of the requirements of the Contract. On the basis of the general scope indicated or described, the trade contractors shall furnish all items required for the proper execution and completion of the work. REVISIONS: 1 ADDENDUM #2 10-27-22

ACOUSTICAL CEILING SUSPENSION ASSEMBLY

SEMI-RECESSED FIRE EXTINGUISHER CABINET

PLASTIC LAMINATE CLAD COUNTERTOPS

CONCRETE PAVING- SEE CIVIL SHEETS

RECESSED CORNER GUARD- SEE EQUIPMENT SCHEDULE


PLASTIC LAMINATE INSTITUTIONAL CASEWORK- SEE EQUIPMENT

RESILIENT BASE

DRAWING TITLE:

CERTIFIED BY:

DRAWING NUMBER A409

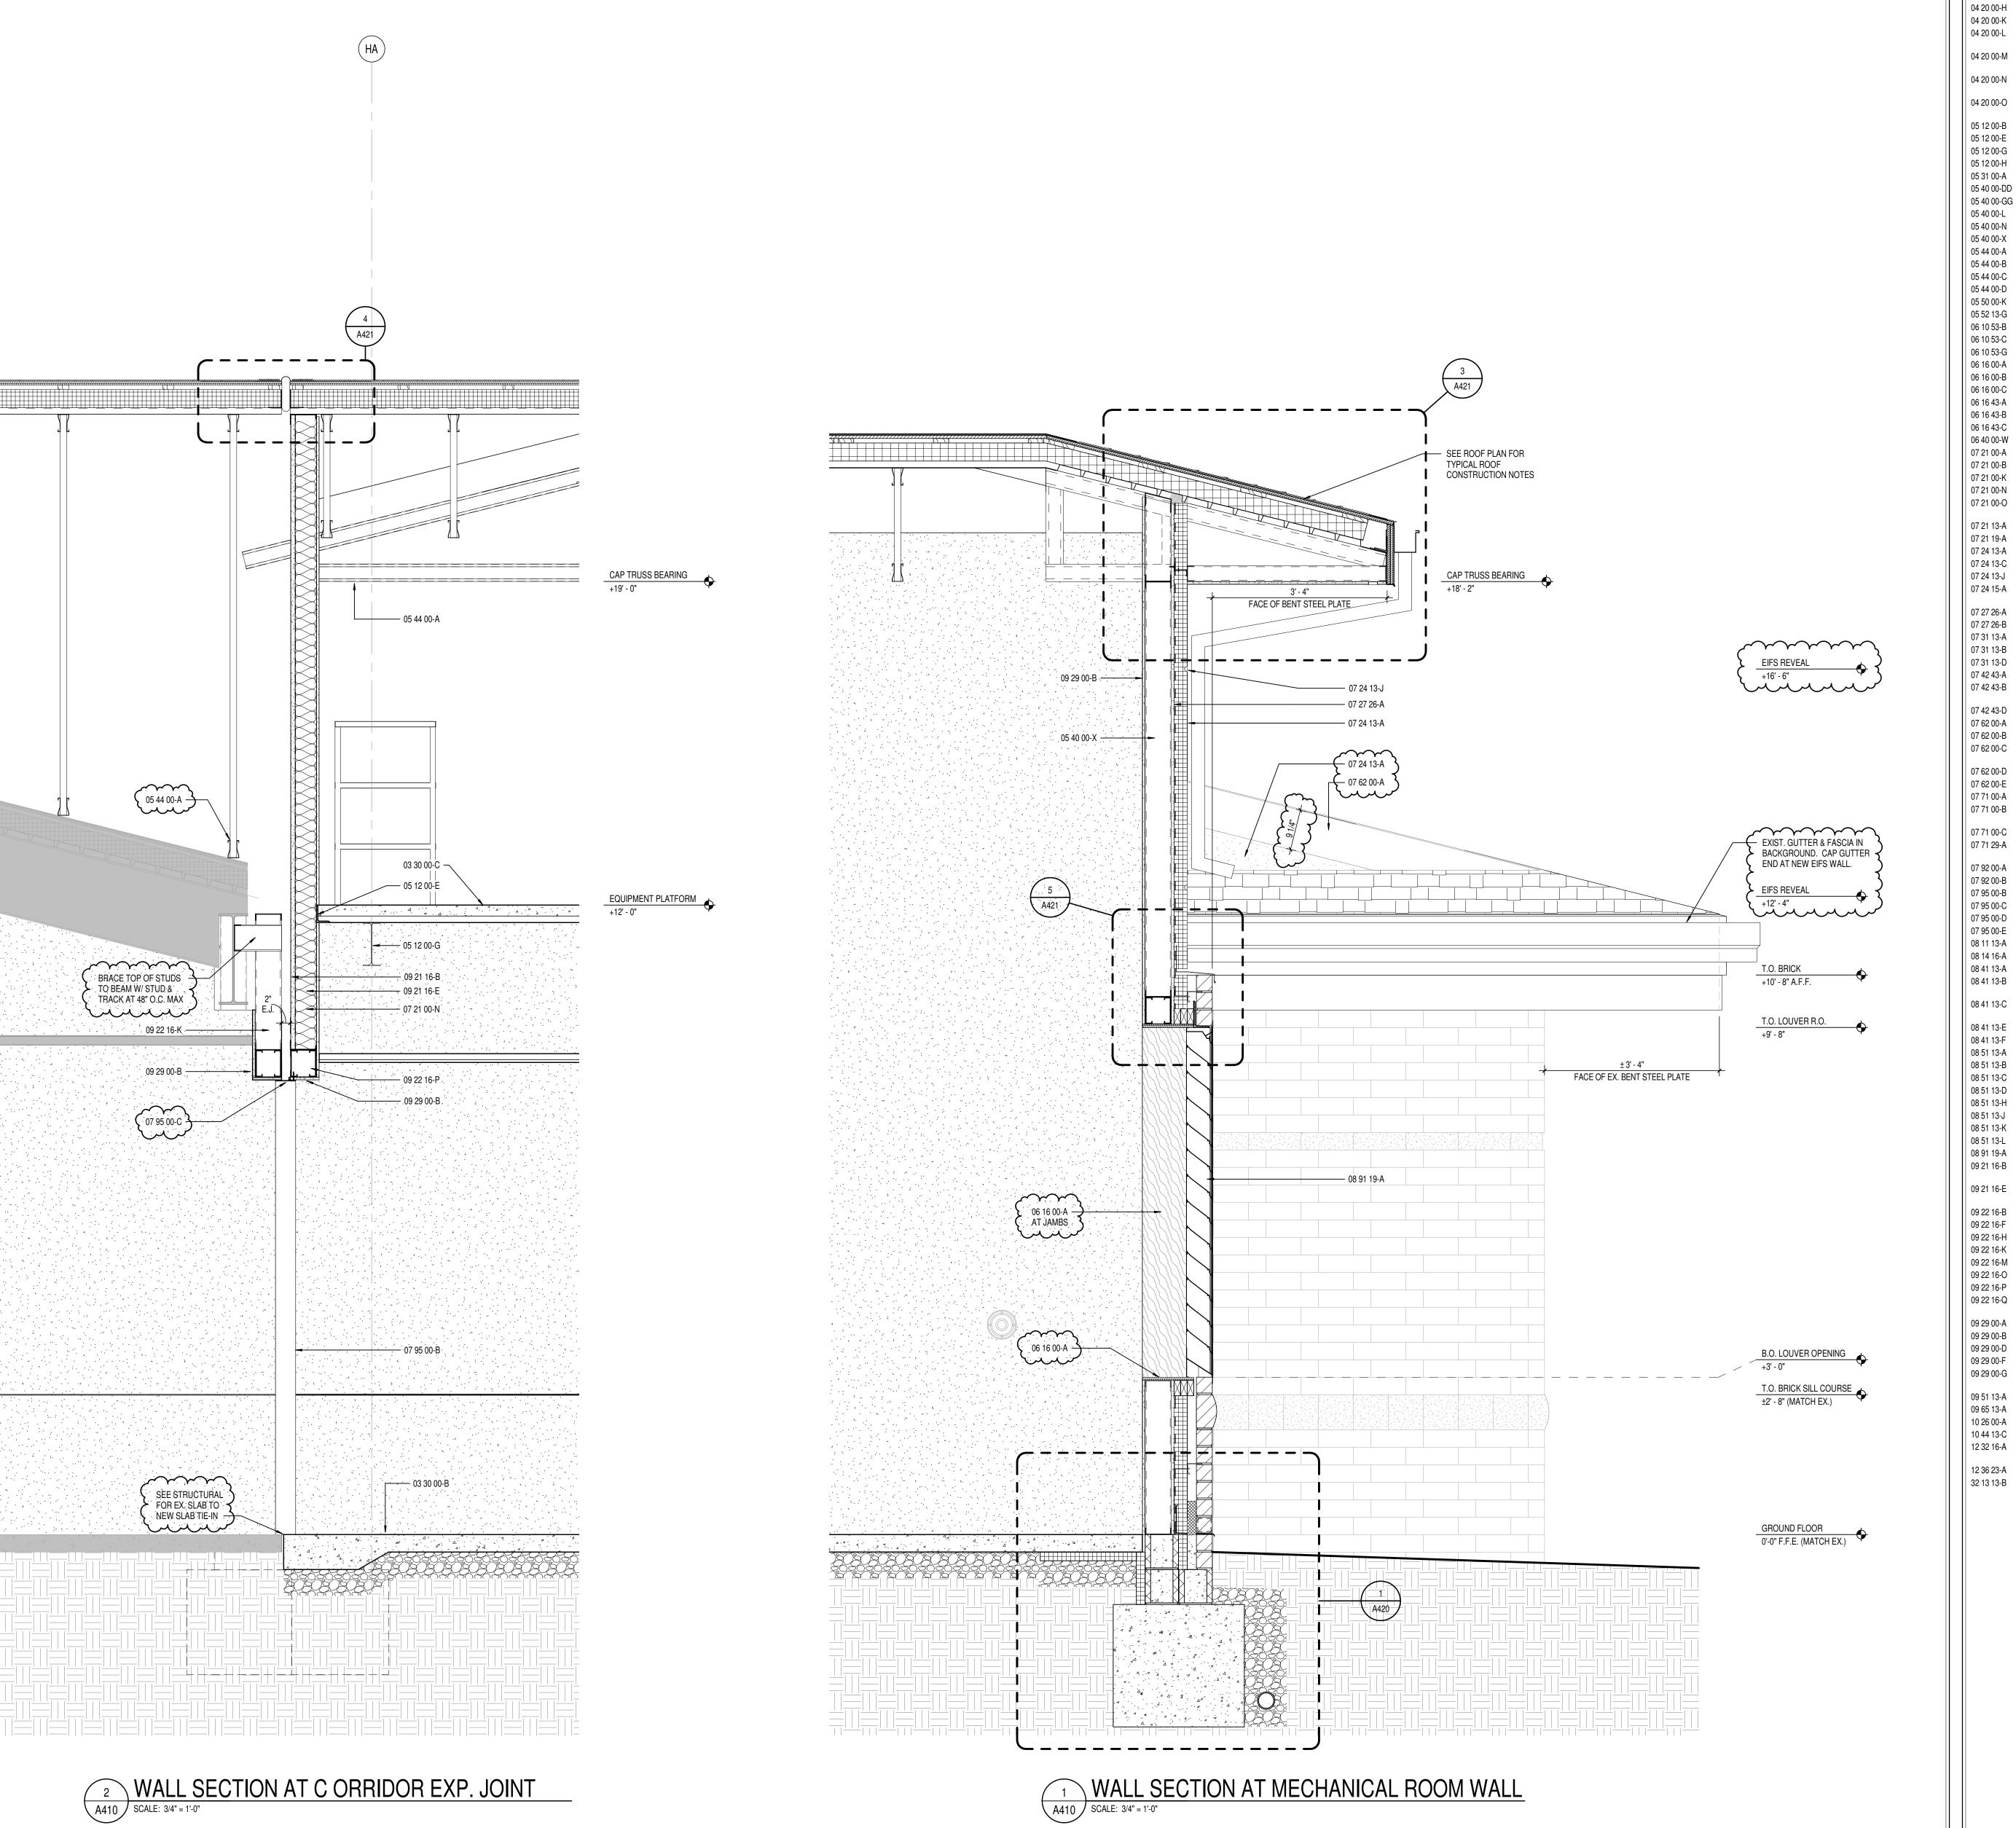

KEYNOTE I EGEND

03 30 00-B	CONCRETE SLAB OVER VAPOR BARRIER ON DRAINAGE FILL. SEE STRUCTURAL
03 30 00-C	CONCRETE SLAB ON METAL DECK- SEE STRUCTURAL
03 30 00-E	CONCRETE FOOTING- SEE STRUCTURAL
03 30 00-G	1/2" EXPANSION MATERIAL
04 20 00-C	MASONRY TIE
04 20 00-D	ADJUSTIBLE MASONRY VENEER ANCHOR AT 16" O.C. VERTICALLY
04 20 00-G	THROUGH WALL FLASHING W/ STAINLESS STEEL DRIP EDGE
04 20 00-H	CELL WEEPS/VENTS AT 24" O.C. MAX. HORIZONTAL
04 20 00-K	CAVITY DRAINAGE MATERIAL
04 20 00-L	UTILITY SIZE FIELD BRICK COLOR '1', MATCH EXISTING COLOR &

UTILITY SIZE ACCENT BRICK REVEAL, MATCH EXISTING COLOR, TEXTURE AND INSET DEPTH EXISTING COLOR & TEXTURE

8x8x4 NOMINAL RADIUS FRONT CUSTOM SHAPE ACCENT BRICK, MATCH 04 20 00-N 04 20 00-O UTILITY SIZE FIELD BRICK COLOR '2', MATCH EXISTING COLOR & 05 12 00-B STEEL ANGLE- SEE STRUCTURAL STEEL BENT PLATE- SEE STRUCTURAL 05 12 00-E

05 12 00-G STEEL BEAM- SEE STRUCTURAL 05 12 00-H STEEL COLUMN- SEE STRUCTURAL 05 31 00-A METAL ROOF DECKING- SEE STRUCTURAL 05 40 00-DD DEFLECTION TRACK 05 40 00-GG METAL STUD BOX HEADER, SIZE BY DELEGATED DESIGN 05 40 00-L 3 5/8" 16 GA. GALVANIZED STEEL STUD AT 16" O.C. 6" 16 GA. GALVANIZED STEEL STUD AT 16" O.C. 05 40 00-N 6" 16 GA. STEEL STUDS AT 16" O.C., CROSS BRACING AS REQUIRED. COLD-FORMED METAL TRUSSES - SEE STRUCTURAL

05 40 00-X 05 44 00-A COLD-FORMED METAL OUTRIGGERS - SEE STRUCTURAL 05 44 00-B 05 44 00-C DROPPED TOP CHORD RAKE TRUSS - SEE STRUCTURAL 05 44 00-D HEAVY GAUGE CFS BENT PLATE 1-1/4" I.D. PAINTED GALVANIZED STEEL PIPE RAILING

05 50 00-K PRE-MANUFACTURED ALUMINUM SHIPS LADDER 05 52 13-G 06 10 53-B 1X FRT WOOD BLOCKING 2X FRT WOOD BLOCKING 06 10 53-C 06 10 53-G 2x10 TREATED WOOD FASCIA 06 16 00-A 3/4" EXTERIOR GRADE PLYWOOD 5/8" EXTERIOR GRADE PLYWOOD 06 16 00-B

06 16 00-C 1/2" EXTERIOR GRADE PLYWOOD 06 16 43-A 5/8" EXTERIOR GYPSUM SHEATHING 06 16 43-B 1/2" EXTERIOR GYPSUM SHEATHING CONTINUOUS ALUMINUM LOUVERED SOFFIT VENT 06 16 43-C PLASTIC LAMINATE ON 3/4" PARTICLEBOARD 07 21 00-A SLAB PERIMETER RIGID INSULATION (R-15 FOR 24")

2" CAVITY WALL EXTRUDED POLYSTYRENE INSULATION (R-10) 07 21 00-B 07 21 00-K 3" CAVITY WALL EXTRUDED POLYSTYRENE INSULATION (R-16.8) 07 21 00-N MINERAL WOOL BATT INSULATION 07 21 00-O THERMALLY ISOLATED COMPOSITE Z-GIRT SYSTEM W/ EDGE PROFILED RIGID INSULATION 07 21 13-A VENTED NAIL BASE

07 21 19-A FOAMED-IN-PLACE INSULATION 07 24 13-A EXTERIOR INSULATION & FINISH SYSTEM (EIFS) W/ 3" INSULATION 07 24 13-C EIFS COMPATIBLE SEALANT 07 24 13-J EIFS V-GROOVE REVEAL

EXTERIOR GYPSUM SHEATHING 07 27 26-A FLUID APPLIED MEMBRANE AIR BARRIER, VAPOR PERMEABLE 07 27 26-B TRANSITION FLASHING TAPE 07 31 13-A ASPHALT SHINGLE, SEE SPECIFICATIONS 07 31 13-B UNDERLAYMENT, SEE SPECIFICATIONS

DIRECT APPLIED FINISH SYSTEM (DAFS) SOFFIT SYSTEM OVER 5/8"

07 31 13-D RIDGE VENT, SEE SPECIFICATIONS ALUMINUM COMPOSITE MATERIAL PANEL, COLOR TO MATCH EXISTING 07 42 43-A 1 1/2" VERTICAL HAT CHANNEL, SPACE AS REQUIRED FOR PANEL ATTACHMENT TWO PIECE FLASHING, COLOR TO MATCH PANELS

07 62 00-A ALUMINUM FASCIA CAP (CLADDING), MATCH EXISTING FASCIA COLOR ALUMINUM WALL TO ROOF HEADWALL FLASHING, MILL FINISH 07 62 00-B ALUMINUM EIFS TO BRICK CAP FLASHING w/ SUPPORT CLEAT, MATCH 07 62 00-C EXISTING FASCIA COLOR ALUMINUM DRIP EDGE 07 62 00-D

07 62 00-E ALUMINUM STEP FLASHING, MILL FINISH ALUMINUM GUTTER, MATCH EXISTING SIZE, PROFILE AND COLOR 07 71 00-B ALUMINUM RECTANGULAR DOWNSPOUT, MATCH EXISTING SIZE AND

07 71 00-C ALUMINUM 5X5 BOX GUTTER, MATCH EXISTING COLOR ROOF TO ROOF EXPANSION JOINT, ALUMINUM FLANGES W/ FLEXIBLE 07 71 29-A BELLOW MATERIAL & CLOSE CELL FOAM 07 92 00-A BACKER ROD AND SEALANT

07 92 00-B INTERIOR WALL EXPANSION JOINT COVER 07 95 00-B 07 95 00-C CEILING EXPANSION JOINT COVER 07 95 00-D EXTERIOR WALL EXPANSION JOINT MATERIAL

07 95 00-E EXPANSION JOINT VAPOR BARRIER SYSTEM 08 11 13-A HOLLOW METAL DOOR/BORROWED LIGHT FRAME 08 14 16-A FLUSH WOOD DOOR 08 41 13-A 4 1/2" ALUMINUM FRAMED STOREFRONT 08 41 13-B WIDE STILE ALUMINUM ENTRANCE DOOR (NON-THERMAL, SEE OPENING

WIDE STILE ALUMINUM ENTRANCE DOOR (THERMAL, SEE OPENING 08 41 13-C 08 41 13-E ALUMINUM BRAKE METAL ADAPTOR HEAD FRAME ALUMINUM BRAKE METAL ADAPTOR SILL FRAME

08 41 13-F 08 51 13-A ALUMINUM WINDOW, COLOR TO MATCH EXISTING WINDOWS 08 51 13-B ALUMINUM WINDOW SLIDING HEAD W/ RECEPTOR ALUMINUM WINDOWS SLIDING SILL 08 51 13-C 08 51 13-D ALUMINUM WINDOWS SLIDING JAMB W/ RECEPTOR

08 51 13-H INSECT SCREEN SHIM AS REQUIRED 08 51 13-J SEALANT BOTH SIDES 08 51 13-K ALUMINUM SILL FLASHING, COLOR TO MATCH EXISTING WINDOWS 08 51 13-L PRE-FINISHED ALUMINUM FIXED LOUVER W/ BIRD SCREEN 08 91 19-A

09 21 16-B GLASS MAT FACED MOLD & MOISTURE RESISTANT 1" GYPSUM LINER 6" CH STUD 18 GA. MIN. @ 16"O.C., PROVIDE CROSS BRACING AS 09 21 16-E DEFLECTION TRACK

09 22 16-F 1 5/8" STEEL STUD 3 5/8" STEEL STUD 09 22 16-H 09 22 16-K 6" STEEL STUD METAL STUD KICKERS AS REQUIRED 09 22 16-M 09 22 16-O SOUND ISOLATION CLIP

09 22 16-P METAL STUD BOX HEADER, SIZE BY DELEGATED DESIGN 3-5/8" STEEL STUDS @ 24" O.C. MAX BETWEEN TRUSS BOTTOM CHORDS 09 22 16-Q TO SUPPORT CEILING SOFFIT FRAMING 09 29 00-A 1/4" GYPSUM WALL BOARD

5/8" GYPSUM WALL BOARD (SEE SPECS FOR TYPE) 09 29 00-B SOUND ATTENUATION INSULATION 09 29 00-D 09 29 00-F 1/2" SAG RESISTANT GYPSUM CEILING BOARD 09 29 00-G METAL GYPSUM BOARD CONTROL JOINT, MATCH EXISTING HEIGHT AND 09 51 13-A ACOUSTICAL CEILING SUSPENSION ASSEMBLY

09 65 13-A RESILIENT BASE RECESSED CORNER GUARD- SEE EQUIPMENT SCHEDULE 10 26 00-A 10 44 13-C SEMI-RECESSED FIRE EXTINGUISHER CABINET 12 32 16-A PLASTIC LAMINATE INSTITUTIONAL CASEWORK- SEE EQUIPMENT

12 36 23-A CONCRETE PAVING- SEE CIVIL SHEETS 32 13 13-B

PLASTIC LAMINATE CLAD COUNTERTOPS

CERTIFIED BY:

DRAWING NUMBER A410

PROJECT NUMBER 2022020



SCOPE DRAWINGS: equirements of the Contract.

On the basis of the general scope indicated or described. the trade contractors shall furnish all items required for the proper execution and completion of the work.


> REVISIONS: ADDENDUM #2 10-27-22

ISSUE DATE | DRAWN BY | CHECKED BY

09/30/22 JBW

DRAWING TITLE:

WALL SECTIONS

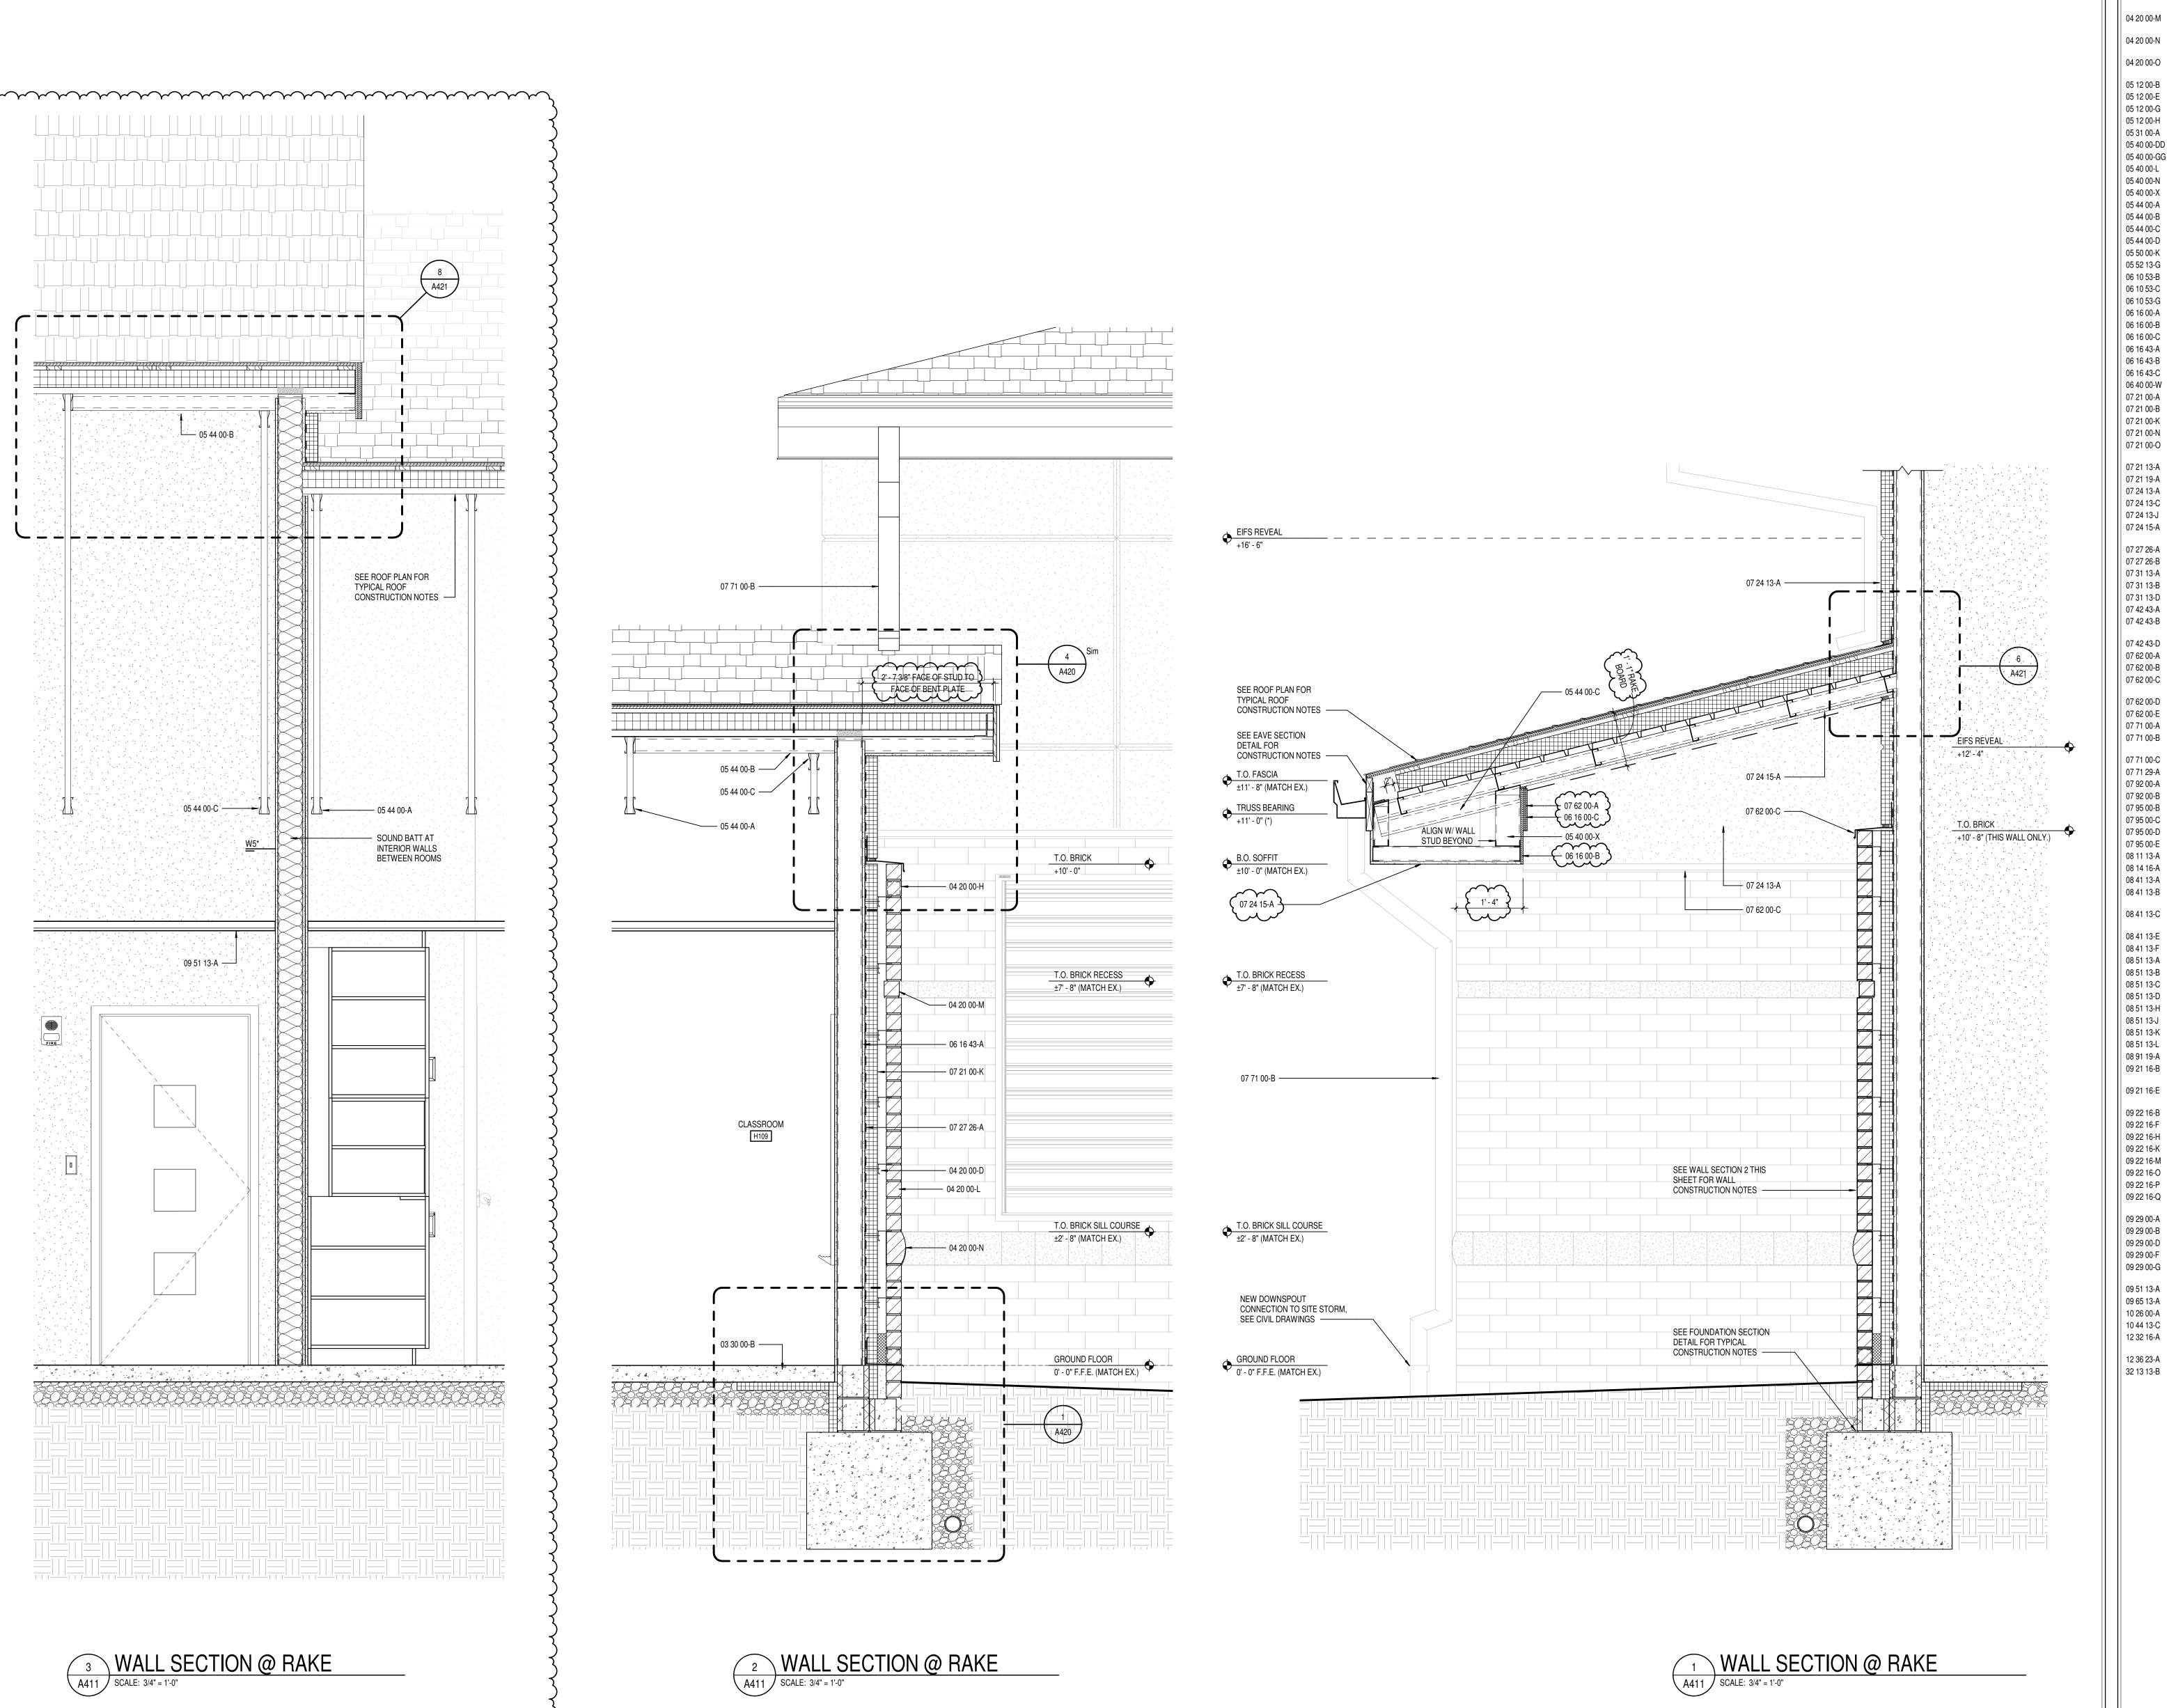

KEYNOTE LEGEND

CONCRETE SLAB OVER VAPOR BARRIER ON DRAINAGE FILL. SEE STRUCTURAL CONCRETE SLAB ON METAL DECK- SEE STRUCTURAL 03 30 00-E CONCRETE FOOTING- SEE STRUCTURAL 03 30 00-G 1/2" EXPANSION MATERIAL 04 20 00-C MASONRY TIE 04 20 00-D ADJUSTIBLE MASONRY VENEER ANCHOR AT 16" O.C. VERTICALLY 04 20 00-G THROUGH WALL FLASHING W/ STAINLESS STEEL DRIP EDGE 04 20 00-H CELL WEEPS/VENTS AT 24" O.C. MAX. HORIZONTAL 04 20 00-K

04 20 00-G
THROUGH WALL FLASHING W/ STAINLESS STEEL DRIP EDGE
04 20 00-H
CELL WEEPS/VENTS AT 24" O.C. MAX. HORIZONTAL
04 20 00-K
CAVITY DRAINAGE MATERIAL
04 20 00-L
UTILITY SIZE FIELD BRICK COLOR '1', MATCH EXISTING COLOR & TEXTURE
04 20 00-M
UTILITY SIZE ACCENT BRICK REVEAL, MATCH EXISTING COLOR, TEXTURE

04 20 00-M

UTILITY SIZE ACCENT BRICK REVEAL, MATCH EXISTING COLOR, TEXTURE AND INSET DEPTH

04 20 00-N

8x8x4 NOMINAL RADIUS FRONT CUSTOM SHAPE ACCENT BRICK, MATCH EXISTING COLOR & TEXTURE

04 20 00-O

UTILITY SIZE FIELD BRICK COLOR '2', MATCH EXISTING COLOR &

UTILITY SIZE FIELD BRICK COLOR '2', MATCH EXISTING COLO
TEXTURE

B STEEL ANGLE- SEE STRUCTURAL
E STEEL BENT PLATE- SEE STRUCTURAL
G STEEL BEAM- SEE STRUCTURAL
H STEEL COLUMN- SEE STRUCTURAL

05 31 00-A METAL ROOF DECKING- SEE STRUCTURAL
05 40 00-DD DEFLECTION TRACK
05 40 00-GG METAL STUD BOX HEADER, SIZE BY DELEGATED DESIGN
05 40 00-L 3 5/8" 16 GA. GALVANIZED STEEL STUD AT 16" O.C.
05 40 00-N 6" 16 GA. GALVANIZED STEEL STUD AT 16" O.C.
05 40 00-X 6" 16 GA. STEEL STUDS AT 16" O.C., CROSS BRACING AS REQUIRED.
05 44 00-A COLD-FORMED METAL TRUSSES - SEE STRUCTURAL
05 44 00-B COLD-FORMED METAL OUTRIGGERS - SEE STRUCTURAL

| 05 44 00-B | COLD-FORMED METAL OUTRIGGERS - SEE STRUCTURAL | 05 44 00-C | DROPPED TOP CHORD RAKE TRUSS - SEE STRUCTURAL | 05 44 00-D | HEAVY GAUGE CFS BENT PLATE | 05 50 00-K | PRE-MANUFACTURED ALUMINUM SHIPS LADDER | 05 52 13-G | 1-1/4" I.D. PAINTED GALVANIZED STEEL PIPE RAILING | 06 10 53-B | 1X FRT WOOD BLOCKING

 06 10 53-C
 2X FRT WOOD BLOCKING

 06 10 53-G
 2x10 TREATED WOOD FASCIA

 06 16 00-A
 3/4" EXTERIOR GRADE PLYWOOD

 06 16 00-B
 5/8" EXTERIOR GRADE PLYWOOD

 06 16 00-C
 1/2" EXTERIOR GRADE PLYWOOD

 06 16 43-A
 5/8" EXTERIOR GYPSUM SHEATHING

 06 16 43-B
 1/2" EXTERIOR GYPSUM SHEATHING

06 16 43-C CONTINUOUS ALUMINUM LOUVERED SOFFIT VENT
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07 21 00-A SLAB PERIMETER RIGID INSULATION (R-15 FOR 24")
07 21 00-B 2" CAVITY WALL EXTRUDED POLYSTYRENE INSULATION (R-10)
07 21 00-K 3" CAVITY WALL EXTRUDED POLYSTYRENE INSULATION (R-16.8)
07 21 00-N MINERAL WOOL BATT INSULATION
07 21 00-O THERMALLY ISOLATED COMPOSITE Z-GIRT SYSTEM W/ EDGE PROFILED

RIGID INSULATION

07 21 13-A

07 21 19-A

FOAMED-IN-PLACE INSULATION

07 24 13-A

EXTERIOR INSULATION & FINISH S

07 24 13-A EXTERIOR INSULATION
07 24 13-C EIFS COMPATIBLE SEALANT
07 24 13-J EIFS V-GROOVE REVEAL
07 24 15-A DIRECT APPLIED FINISH SYSTEM (DAFS) SOFFIT SYSTEM OVER 5/8"
EXTERIOR GYPSUM SHEATHING

FLUID APPLIED MEMBRANE AIR BARRIER, VAPOR PERMEABLE

07 27 26-B TRANSITION FLASHING TAPE
07 31 13-A ASPHALT SHINGLE, SEE SPECIFICATIONS
07 31 13-B UNDERLAYMENT, SEE SPECIFICATIONS
07 31 13-D RIDGE VENT, SEE SPECIFICATIONS
07 42 43-A ALUMINUM COMPOSITE MATERIAL PANEL, COLOR TO MATCH

07 42 43-B

07 42 43-B

07 42 43-D

07 42 43-D

07 62 00-A

RIDGE VENT, SEE SPECIFICATIONS

ALUMINUM COMPOSITE MATERIAL PANEL, COLOR TO MATCH EXISTING

1 1/2" VERTICAL HAT CHANNEL, SPACE AS REQUIRED FOR PANEL

ATTACHMENT

TWO PIECE FLASHING, COLOR TO MATCH PANELS

ALUMINUM FASCIA CAP (CLADDING), MATCH EXISTING FASCIA COLOR

07 62 00-B
ALUMINUM WALL TO ROOF HEADWALL FLASHING, MILL FINISH
07 62 00-C
ALUMINUM EIFS TO BRICK CAP FLASHING w/ SUPPORT CLEAT, MATCH
EXISTING FASCIA COLOR
07 62 00-D
ALUMINUM DRIP EDGE
07 62 00-E
ALUMINUM STEP FLASHING, MILL FINISH
07 71 00-A
ALUMINUM GUTTER, MATCH EXISTING SIZE, PROFILE AND COLOR

07 71 00-B
ALUMINUM RECTANGULAR DOWNSPOUT, MATCH EXISTING SIZE AND COLOR
07 71 00-C
ALUMINUM 5X5 BOX GUTTER, MATCH EXISTING COLOR
07 71 29-A
ROOF TO ROOF EXPANSION JOINT W/ FLEXIBLE BELLOW MATERIAL
07 92 00-A
BACKER ROD AND SEALANT

07 92 00-B SEALANT
07 95 00-B INTERIOR WALL EXPANSION JOINT COVER
07 95 00-C CEILING EXPANSION JOINT COVER
07 95 00-D EXTERIOR WALL EXPANSION JOINT MATERIAL
07 95 00-E EXPANSION JOINT VAPOR BARRIER SYSTEM
08 11 13-A HOLLOW METAL DOOR/BORROWED LIGHT FRAM

08 11 13-A HOLLOW METAL DOOR/BORROWED LIGHT FRAME
08 14 16-A FLUSH WOOD DOOR
08 41 13-A 4 1/2" ALUMINUM FRAMED STOREFRONT
08 41 13-B WIDE STILE ALUMINUM ENTRANCE DOOR (NON-THERMAL, SEE OPENING SCHEDULE)

08 41 13-C WIDE STILE ALUMINUM ENTRANCE DOOR (THERMAL, SEE OPENING SCHEDULE)

08 41 13-E ALUMINUM BRAKE METAL ADAPTOR HEAD FRAME

08 41 13-F ALUMINUM BRAKE METAL ADAPTOR SILL FRAME

08 51 13-A ALUMINUM WINDOW, COLOR TO MATCH EXISTING WINDOWS

08 51 13-B ALUMINUM WINDOW SLIDING HEAD W/ RECEPTOR

08 51 13-C ALUMINUM WINDOWS SLIDING SILL
08 51 13-D ALUMINUM WINDOWS SLIDING JAMB W/ RECEPTOR
08 51 13-H INSECT SCREEN
08 51 13-J SHIM AS REQUIRED
08 51 13-K SEALANT BOTH SIDES
08 51 13-L ALUMINUM SILL FLASHING, COLOR TO MATCH EXISTING WINDOWS
08 91 19-A PRE-FINISHED ALUMINUM FIXED LOUVER W/ BIRD SCREEN

09 21 16-B GLASS MAT FACED MOLD & MOISTURE RESISTANT 1" GYPSUM LINER PANEL

09 21 16-E 6" CH STUD 18 GA. MIN. @ 16"O.C., PROVIDE CROSS BRACING AS REQUIRED

09 22 16-B DEFLECTION TRACK

09 22 16-F 1 5/8" STEEL STUD

09 22 16-H 3 5/8" STEEL STUD
09 22 16-K 6" STEEL STUD
09 22 16-M METAL STUD KICKERS AS REQUIRED
09 22 16-O SOUND ISOLATION CLIP
09 22 16-P METAL STUD BOX HEADER, SIZE BY DELEGATED DESIGN
09 22 16-Q 3-5/8" STEEL STUDS @ 24" O.C. MAX BETWEEN TRUSS BOTTOM CHORDS TO SUPPORT CEILING SOFFIT FRAMING

09 29 00-A 1/4" GYPSUM WALL BOARD
09 29 00-B 5/8" GYPSUM WALL BOARD (SEE SPECS FOR TYPE)
09 29 00-D SOUND ATTENUATION INSULATION
09 29 00-F 1/2" SAG RESISTANT GYPSUM CEILING BOARD
09 29 00-G METAL GYPSUM BOARD CONTROL JOINT, MATCH EXISTING HEIGHT AND PROFILE
09 51 13-A ACOUSTICAL CEILING SUSPENSION ASSEMBLY

| 09 65 13-A | RESILIENT BASE | 10 26 00-A | RECESSED CORNER GUARD- SEE EQUIPMENT SCHEDULE | 10 44 13-C | SEMI-RECESSED FIRE EXTINGUISHER CABINET | 12 32 16-A | PLASTIC LAMINATE INSTITUTIONAL CASEWORK- SEE EQUIPMENT | SCHEDULE | 12 36 23-A | PLASTIC LAMINATE CLAD COUNTERTOPS

CONCRETE PAVING- SEE CIVIL SHEETS

8831 Keystone Crossing, Indianapolis, IN 46240

Westfield Washington Schools
ADDITION & RENOVATION TO
CAREY RIDGE ELEMENTARY
16231 CAREY ROAD, WESTFIELD, INDIANA 46074

SCOPE DRAWINGS:

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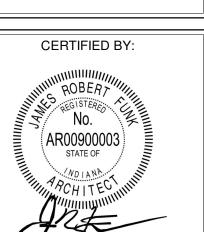
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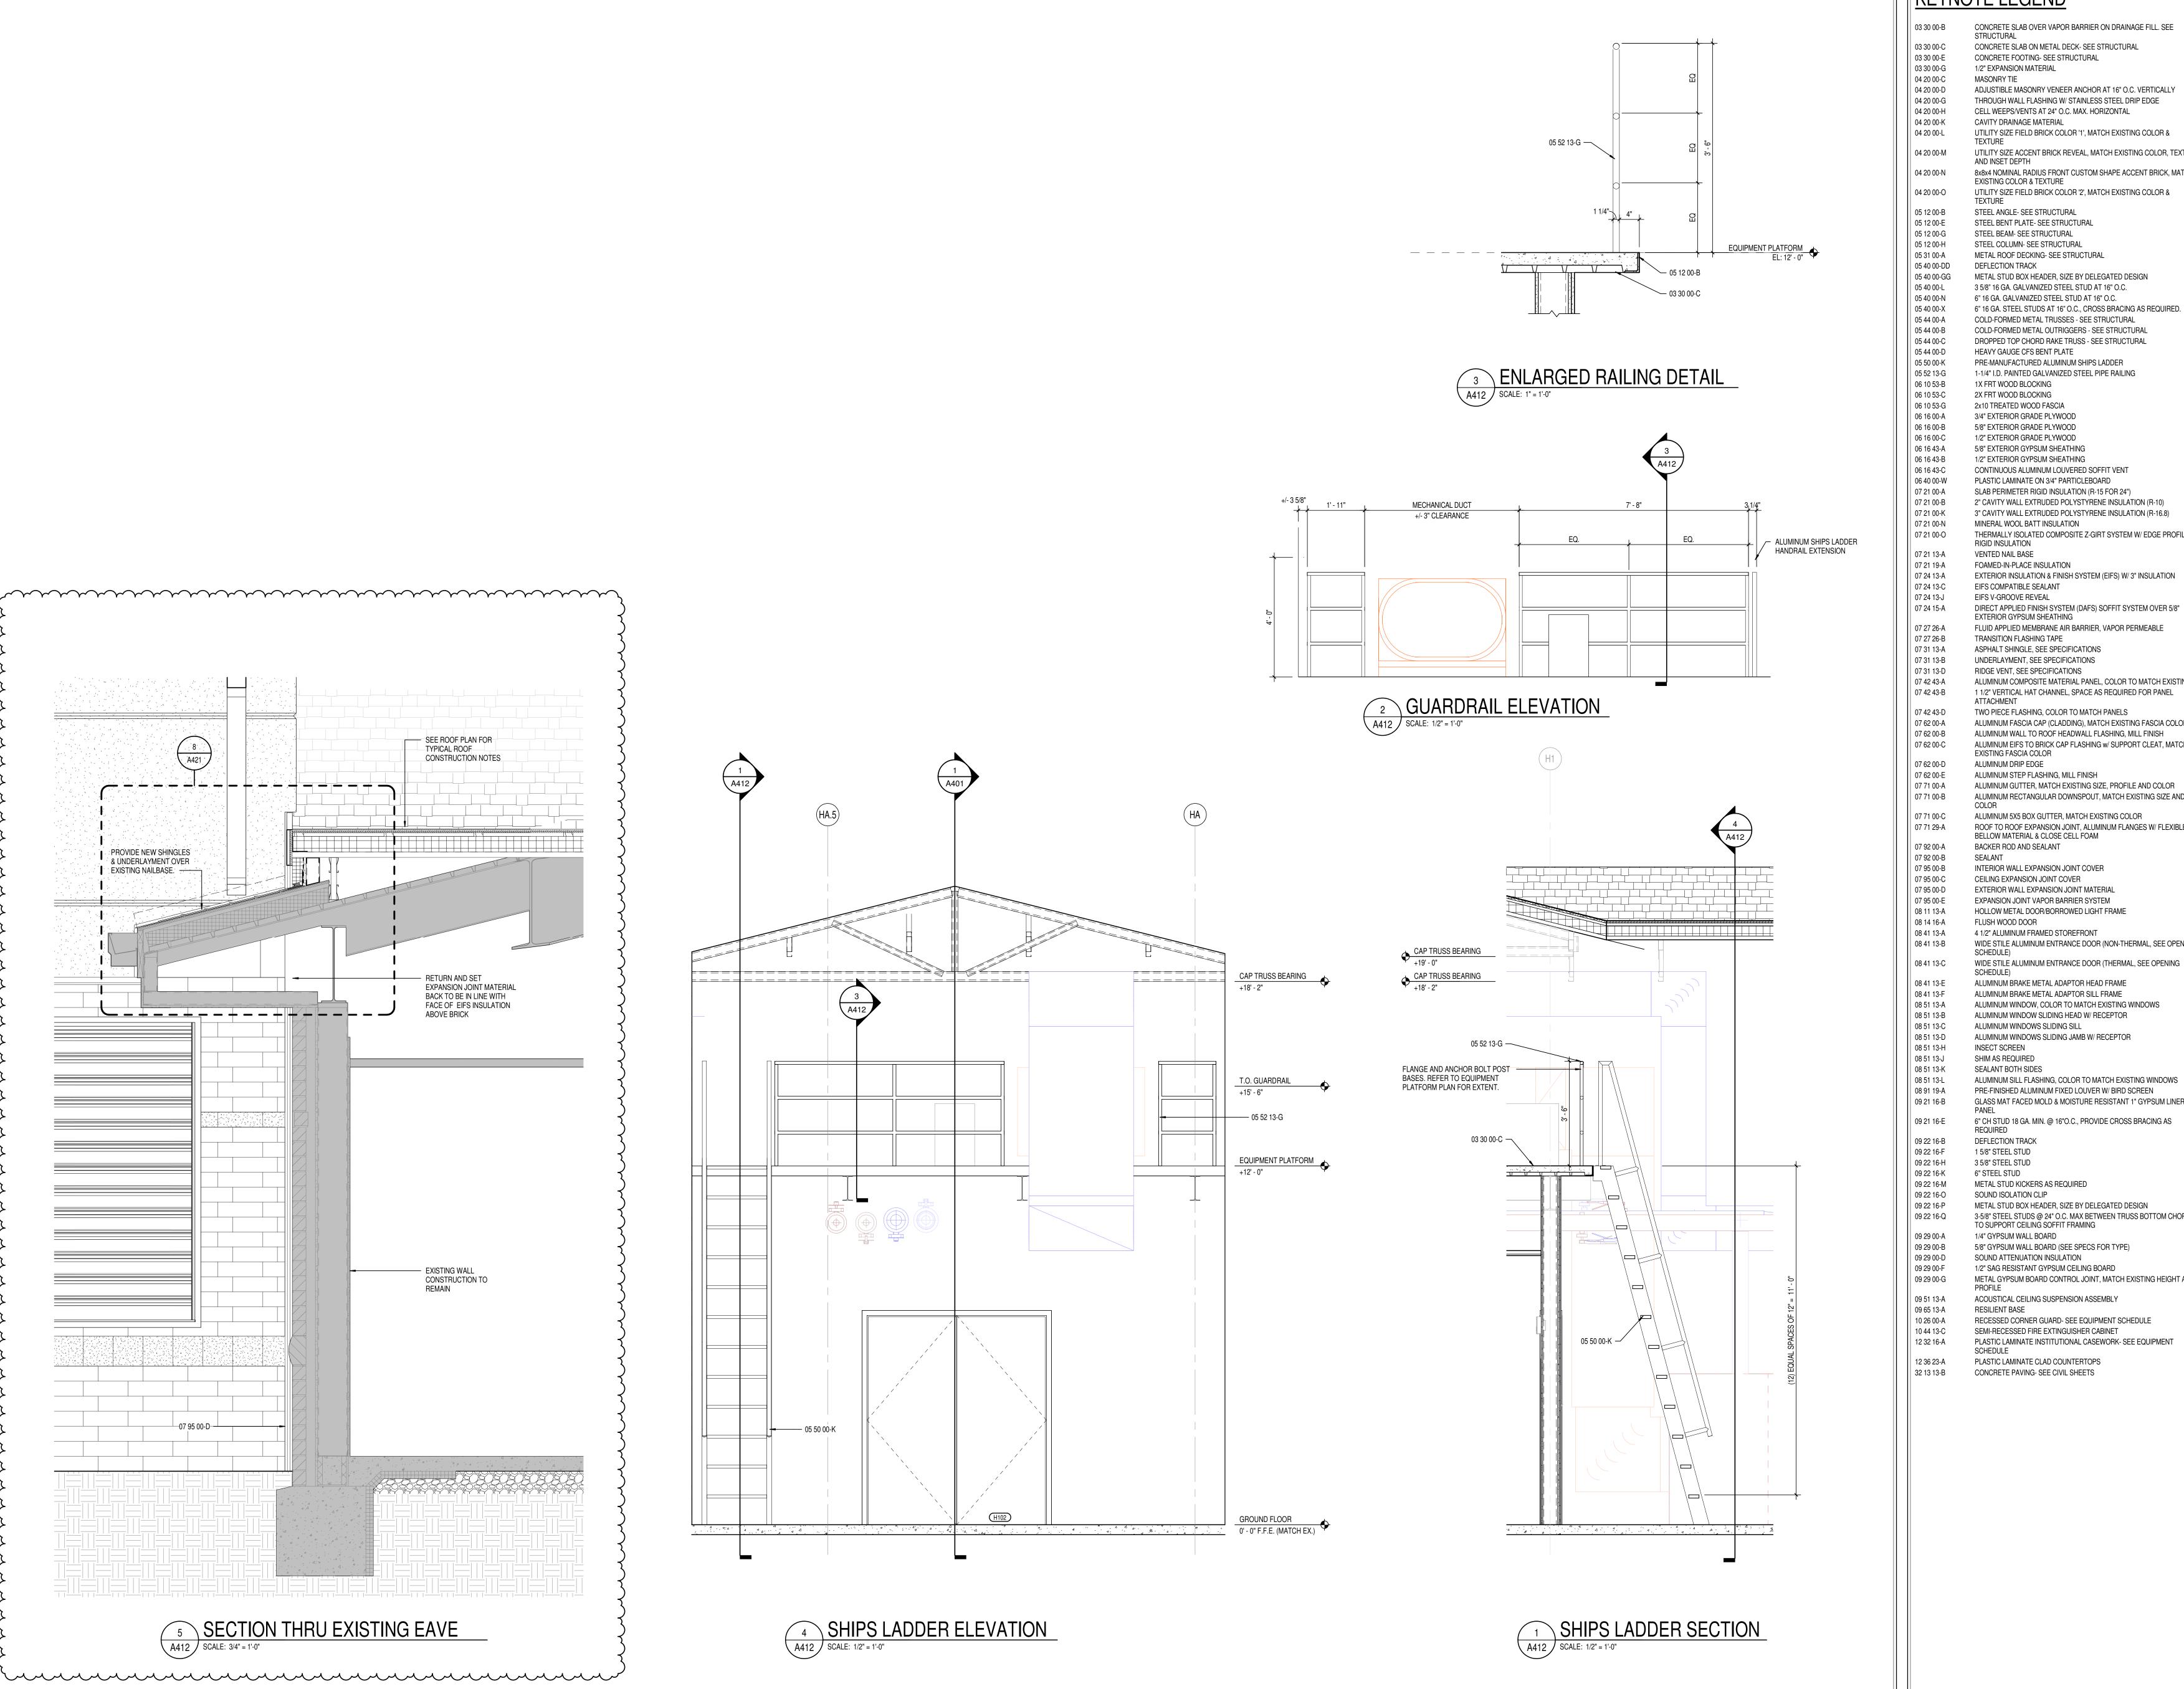
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09/30/22

DRAWING TITLE:



A411



CONCRETE SLAB OVER VAPOR BARRIER ON DRAINAGE FILL. SEE STRUCTURAL CONCRETE SLAB ON METAL DECK- SEE STRUCTURAL CONCRETE FOOTING- SEE STRUCTURAL 1/2" EXPANSION MATERIAL MASONRY TIE ADJUSTIBLE MASONRY VENEER ANCHOR AT 16" O.C. VERTICALLY THROUGH WALL FLASHING W/ STAINLESS STEEL DRIP EDGE CELL WEEPS/VENTS AT 24" O.C. MAX. HORIZONTAL

CAVITY DRAINAGE MATERIAL UTILITY SIZE FIELD BRICK COLOR '1', MATCH EXISTING COLOR &

UTILITY SIZE ACCENT BRICK REVEAL, MATCH EXISTING COLOR, TEXTURE AND INSET DEPTH 8x8x4 NOMINAL RADIUS FRONT CUSTOM SHAPE ACCENT BRICK, MATCH EXISTING COLOR & TEXTURE

UTILITY SIZE FIELD BRICK COLOR '2', MATCH EXISTING COLOR & STEEL ANGLE- SEE STRUCTURAL STEEL BENT PLATE- SEE STRUCTURAL STEEL BEAM- SEE STRUCTURAL

STEEL COLUMN- SEE STRUCTURAL METAL ROOF DECKING- SEE STRUCTURAL DEFLECTION TRACK 05 40 00-GG METAL STUD BOX HEADER, SIZE BY DELEGATED DESIGN 3 5/8" 16 GA. GALVANIZED STEEL STUD AT 16" O.C. 6" 16 GA. GALVANIZED STEEL STUD AT 16" O.C. 6" 16 GA. STEEL STUDS AT 16" O.C., CROSS BRACING AS REQUIRED.

COLD-FORMED METAL TRUSSES - SEE STRUCTURAL COLD-FORMED METAL OUTRIGGERS - SEE STRUCTURAL DROPPED TOP CHORD RAKE TRUSS - SEE STRUCTURAL HEAVY GAUGE CFS BENT PLATE

PRE-MANUFACTURED ALUMINUM SHIPS LADDER 1-1/4" I.D. PAINTED GALVANIZED STEEL PIPE RAILING 1X FRT WOOD BLOCKING 2X FRT WOOD BLOCKING 2x10 TREATED WOOD FASCIA 3/4" EXTERIOR GRADE PLYWOOD

1/2" EXTERIOR GRADE PLYWOOD 5/8" EXTERIOR GYPSUM SHEATHING 1/2" EXTERIOR GYPSUM SHEATHING CONTINUOUS ALUMINUM LOUVERED SOFFIT VENT PLASTIC LAMINATE ON 3/4" PARTICLEBOARD SLAB PERIMETER RIGID INSULATION (R-15 FOR 24")

2" CAVITY WALL EXTRUDED POLYSTYRENE INSULATION (R-10) 3" CAVITY WALL EXTRUDED POLYSTYRENE INSULATION (R-16.8) MINERAL WOOL BATT INSULATION THERMALLY ISOLATED COMPOSITE Z-GIRT SYSTEM W/ EDGE PROFILED RIGID INSULATION VENTED NAIL BASE

FOAMED-IN-PLACE INSULATION EXTERIOR INSULATION & FINISH SYSTEM (EIFS) W/ 3" INSULATION EIFS COMPATIBLE SEALANT EIFS V-GROOVE REVEAL

FLUID APPLIED MEMBRANE AIR BARRIER, VAPOR PERMEABLE TRANSITION FLASHING TAPE ASPHALT SHINGLE, SEE SPECIFICATIONS UNDERLAYMENT, SEE SPECIFICATIONS

RIDGE VENT, SEE SPECIFICATIONS ALUMINUM COMPOSITE MATERIAL PANEL, COLOR TO MATCH EXISTING 1 1/2" VERTICAL HAT CHANNEL, SPACE AS REQUIRED FOR PANEL ATTACHMENT TWO PIECE FLASHING, COLOR TO MATCH PANELS

ALUMINUM FASCIA CAP (CLADDING), MATCH EXISTING FASCIA COLOR ALUMINUM WALL TO ROOF HEADWALL FLASHING, MILL FINISH ALUMINUM EIFS TO BRICK CAP FLASHING w/ SUPPORT CLEAT, MATCH EXISTING FASCIA COLOR ALUMINUM DRIP EDGE

ALUMINUM STEP FLASHING, MILL FINISH ALUMINUM GUTTER, MATCH EXISTING SIZE, PROFILE AND COLOR ALUMINUM RECTANGULAR DOWNSPOUT, MATCH EXISTING SIZE AND

ALUMINUM 5X5 BOX GUTTER, MATCH EXISTING COLOR ROOF TO ROOF EXPANSION JOINT, ALUMINUM FLANGES W/ FLEXIBLE BELLOW MATERIAL & CLOSE CELL FOAM BACKER ROD AND SEALANT

CEILING EXPANSION JOINT COVER EXTERIOR WALL EXPANSION JOINT MATERIAL **EXPANSION JOINT VAPOR BARRIER SYSTEM** HOLLOW METAL DOOR/BORROWED LIGHT FRAME FLUSH WOOD DOOR 4 1/2" ALUMINUM FRAMED STOREFRONT

WIDE STILE ALUMINUM ENTRANCE DOOR (NON-THERMAL, SEE OPENING WIDE STILE ALUMINUM ENTRANCE DOOR (THERMAL, SEE OPENING

ALUMINUM BRAKE METAL ADAPTOR HEAD FRAME ALUMINUM BRAKE METAL ADAPTOR SILL FRAME ALUMINUM WINDOW, COLOR TO MATCH EXISTING WINDOWS ALUMINUM WINDOW SLIDING HEAD W/ RECEPTOR ALUMINUM WINDOWS SLIDING SILL

ALUMINUM WINDOWS SLIDING JAMB W/ RECEPTOR INSECT SCREEN SHIM AS REQUIRED SEALANT BOTH SIDES

ALUMINUM SILL FLASHING, COLOR TO MATCH EXISTING WINDOWS PRE-FINISHED ALUMINUM FIXED LOUVER W/ BIRD SCREEN GLASS MAT FACED MOLD & MOISTURE RESISTANT 1" GYPSUM LINER 6" CH STUD 18 GA. MIN. @ 16"O.C., PROVIDE CROSS BRACING AS

DEFLECTION TRACK 1 5/8" STEEL STUD 3 5/8" STEEL STUD 6" STEEL STUD

METAL STUD KICKERS AS REQUIRED SOUND ISOLATION CLIP METAL STUD BOX HEADER, SIZE BY DELEGATED DESIGN 3-5/8" STEEL STUDS @ 24" O.C. MAX BETWEEN TRUSS BOTTOM CHORDS TO SUPPORT CEILING SOFFIT FRAMING 1/4" GYPSUM WALL BOARD

5/8" GYPSUM WALL BOARD (SEE SPECS FOR TYPE) SOUND ATTENUATION INSULATION 1/2" SAG RESISTANT GYPSUM CEILING BOARD METAL GYPSUM BOARD CONTROL JOINT, MATCH EXISTING HEIGHT AND

ACOUSTICAL CEILING SUSPENSION ASSEMBLY RESILIENT BASE RECESSED CORNER GUARD- SEE EQUIPMENT SCHEDULE SEMI-RECESSED FIRE EXTINGUISHER CABINET PLASTIC LAMINATE INSTITUTIONAL CASEWORK- SEE EQUIPMENT

PLASTIC LAMINATE CLAD COUNTERTOPS

CONCRETE PAVING- SEE CIVIL SHEETS

SCOPE DRAWINGS: proper execution and completion of the work.


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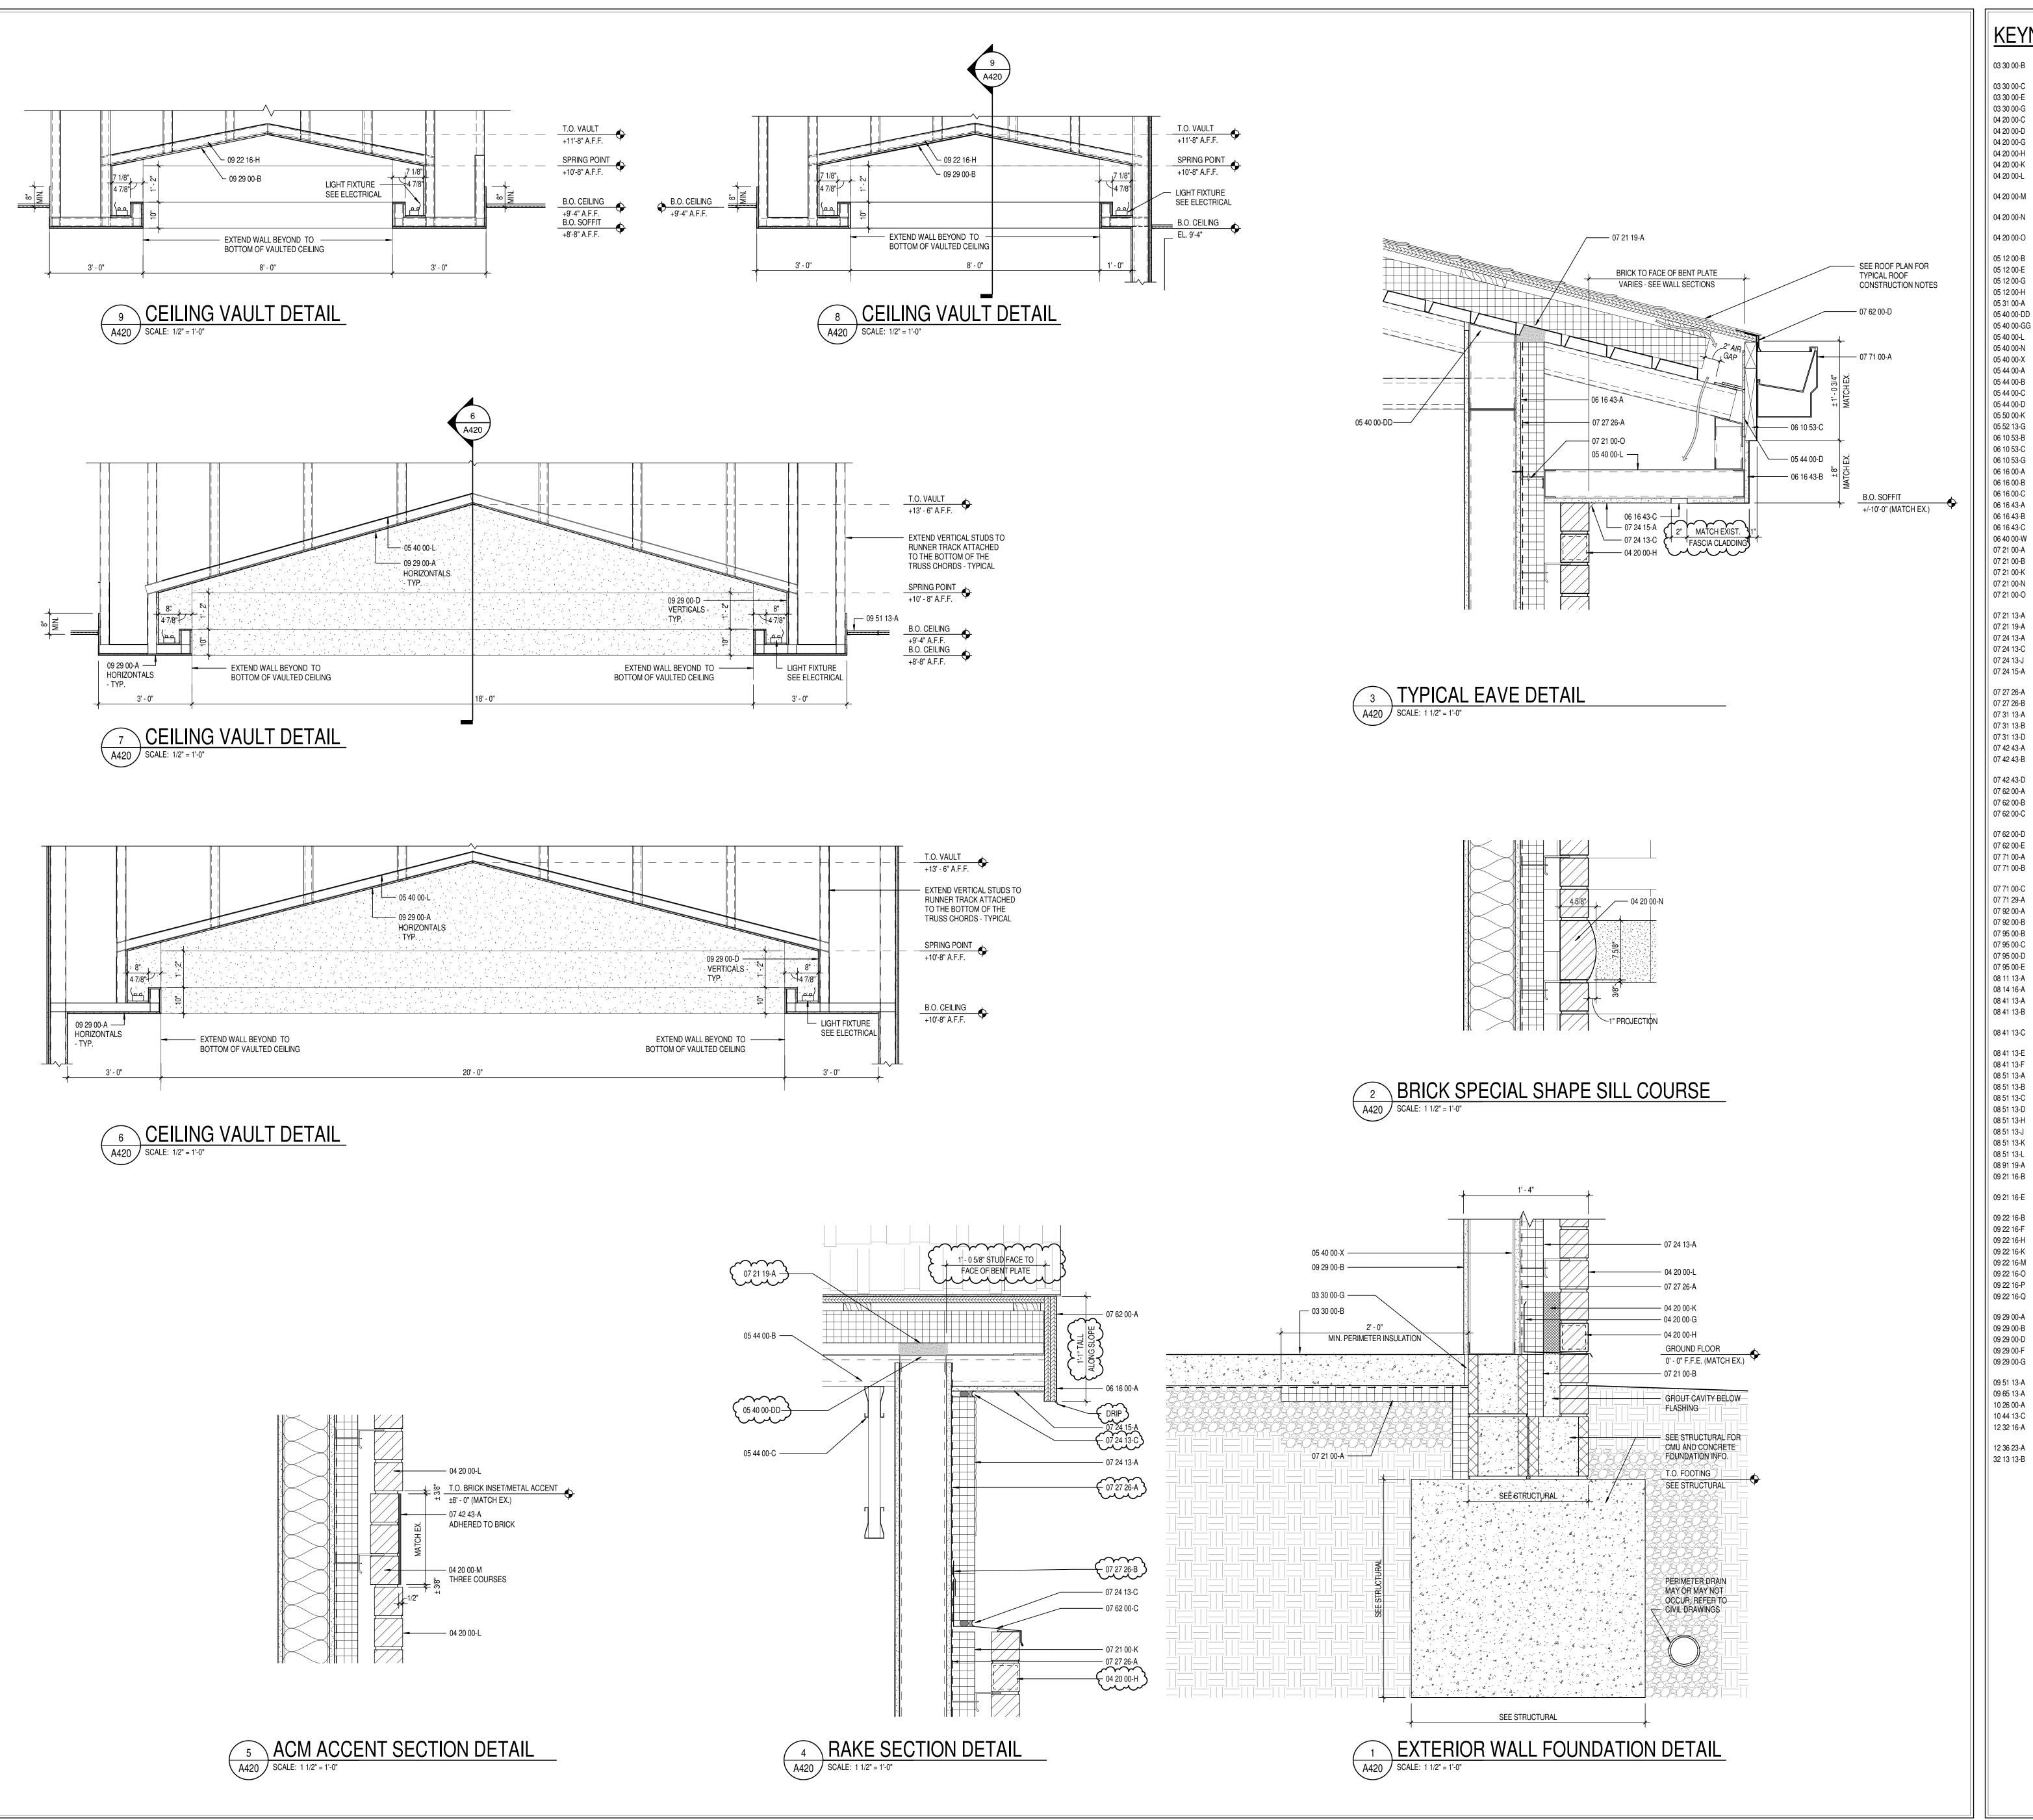
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09/30/22

DRAWING TITLE: **VERTICAL CIRCULATION** SECTIONS AND DETAILS



DRAWING NUMBER A412

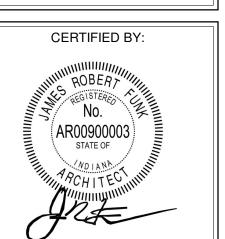

CONCRETE SLAB OVER VAPOR BARRIER ON DRAINAGE FILL. SEE 03 30 00-B STRUCTURAL CONCRETE SLAB ON METAL DECK- SEE STRUCTURAL 03 30 00-E CONCRETE FOOTING- SEE STRUCTURAL 03 30 00-G 1/2" EXPANSION MATERIAL 04 20 00-C MASONRY TIE 04 20 00-D ADJUSTIBLE MASONRY VENEER ANCHOR AT 16" O.C. VERTICALLY 04 20 00-G THROUGH WALL FLASHING W/ STAINLESS STEEL DRIP EDGE 04 20 00-H CELL WEEPS/VENTS AT 24" O.C. MAX. HORIZONTAL 04 20 00-K CAVITY DRAINAGE MATERIAL 04 20 00-L UTILITY SIZE FIELD BRICK COLOR '1', MATCH EXISTING COLOR &

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8x8x4 NOMINAL RADIUS FRONT CUSTOM SHAPE ACCENT BRICK, MATCH EXISTING COLOR & TEXTURE UTILITY SIZE FIELD BRICK COLOR '2', MATCH EXISTING COLOR &

STEEL ANGLE- SEE STRUCTURAL 05 12 00-B 05 12 00-E STEEL BENT PLATE- SEE STRUCTURAL 05 12 00-G STEEL BEAM- SEE STRUCTURAL 05 12 00-H STEEL COLUMN- SEE STRUCTURAL

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COLD-FORMED METAL OUTRIGGERS - SEE STRUCTURAL 05 44 00-B DROPPED TOP CHORD RAKE TRUSS - SEE STRUCTURAL 05 44 00-C HEAVY GAUGE CFS BENT PLATE PRE-MANUFACTURED ALUMINUM SHIPS LADDER 05 50 00-K 05 52 13-G 1-1/4" I.D. PAINTED GALVANIZED STEEL PIPE RAILING 06 10 53-B 1X FRT WOOD BLOCKING

2X FRT WOOD BLOCKING

2x10 TREATED WOOD FASCIA 06 16 00-A 3/4" EXTERIOR GRADE PLYWOOD 06 16 00-B 5/8" EXTERIOR GRADE PLYWOOD 06 16 00-C 1/2" EXTERIOR GRADE PLYWOOD 06 16 43-A 5/8" EXTERIOR GYPSUM SHEATHING 06 16 43-B 1/2" EXTERIOR GYPSUM SHEATHING 06 16 43-C CONTINUOUS ALUMINUM LOUVERED SOFFIT VENT

07 21 00-A SLAB PERIMETER RIGID INSULATION (R-15 FOR 24") 2" CAVITY WALL EXTRUDED POLYSTYRENE INSULATION (R-10) 07 21 00-B 07 21 00-K 3" CAVITY WALL EXTRUDED POLYSTYRENE INSULATION (R-16.8) 07 21 00-N MINERAL WOOL BATT INSULATION THERMALLY ISOLATED COMPOSITE Z-GIRT SYSTEM W/ EDGE PROFILED 07 21 00-O RIGID INSULATION

07 21 13-A VENTED NAIL BASE 07 21 19-A FOAMED-IN-PLACE INSULATION 07 24 13-A EXTERIOR INSULATION & FINISH SYSTEM (EIFS) W/ 3" INSULATION

07 24 13-C EIFS COMPATIBLE SEALANT 07 24 13-J EIFS V-GROOVE REVEAL DIRECT APPLIED FINISH SYSTEM (DAFS) SOFFIT SYSTEM OVER 5/8" 07 24 15-A EXTERIOR GYPSUM SHEATHING

PLASTIC LAMINATE ON 3/4" PARTICLEBOARD

FLUID APPLIED MEMBRANE AIR BARRIER, VAPOR PERMEABLE 07 27 26-A TRANSITION FLASHING TAPE ASPHALT SHINGLE, SEE SPECIFICATIONS 07 31 13-A 07 31 13-B UNDERLAYMENT, SEE SPECIFICATIONS RIDGE VENT, SEE SPECIFICATIONS

ALUMINUM COMPOSITE MATERIAL PANEL, COLOR TO MATCH EXISTING 07 42 43-A 1 1/2" VERTICAL HAT CHANNEL, SPACE AS REQUIRED FOR PANEL ATTACHMENT TWO PIECE FLASHING, COLOR TO MATCH PANELS 07 42 43-D ALUMINUM FASCIA CAP (CLADDING), MATCH EXISTING FASCIA COLOR 07 62 00-B ALUMINUM WALL TO ROOF HEADWALL FLASHING, MILL FINISH

ALUMINUM EIFS TO BRICK CAP FLASHING w/ SUPPORT CLEAT, MATCH 07 62 00-C EXISTING FASCIA COLOR ALUMINUM DRIP EDGE 07 62 00-D 07 62 00-E ALUMINUM STEP FLASHING, MILL FINISH 07 71 00-A ALUMINUM GUTTER, MATCH EXISTING SIZE, PROFILE AND COLOR

ALUMINUM RECTANGULAR DOWNSPOUT, MATCH EXISTING SIZE AND 07 71 00-B ALUMINUM 5X5 BOX GUTTER, MATCH EXISTING COLOR 07 71 00-C 07 71 29-A ROOF TO ROOF EXPANSION JOINT W/ FLEXIBLE BELLOW MATERIAL 07 92 00-A BACKER ROD AND SEALANT

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WIDE STILE ALUMINUM ENTRANCE DOOR (THERMAL, SEE OPENING 08 41 13-C ALUMINUM BRAKE METAL ADAPTOR HEAD FRAME 08 41 13-E ALUMINUM BRAKE METAL ADAPTOR SILL FRAME 08 41 13-F

WIDE STILE ALUMINUM ENTRANCE DOOR (NON-THERMAL, SEE OPENING

ALUMINUM WINDOW, COLOR TO MATCH EXISTING WINDOWS 08 51 13-A 08 51 13-B ALUMINUM WINDOW SLIDING HEAD W/ RECEPTOR 08 51 13-C ALUMINUM WINDOWS SLIDING SILL 08 51 13-D ALUMINUM WINDOWS SLIDING JAMB W/ RECEPTOR

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METAL GYPSUM BOARD CONTROL JOINT, MATCH EXISTING HEIGHT AND 09 29 00-G ACOUSTICAL CEILING SUSPENSION ASSEMBLY 09 51 13-A 09 65 13-A RESILIENT BASE

RECESSED CORNER GUARD- SEE EQUIPMENT SCHEDULE SEMI-RECESSED FIRE EXTINGUISHER CABINET 10 44 13-C 12 32 16-A PLASTIC LAMINATE INSTITUTIONAL CASEWORK- SEE EQUIPMENT

PLASTIC LAMINATE CLAD COUNTERTOPS 12 36 23-A 32 13 13-B CONCRETE PAVING- SEE CIVIL SHEETS



CA

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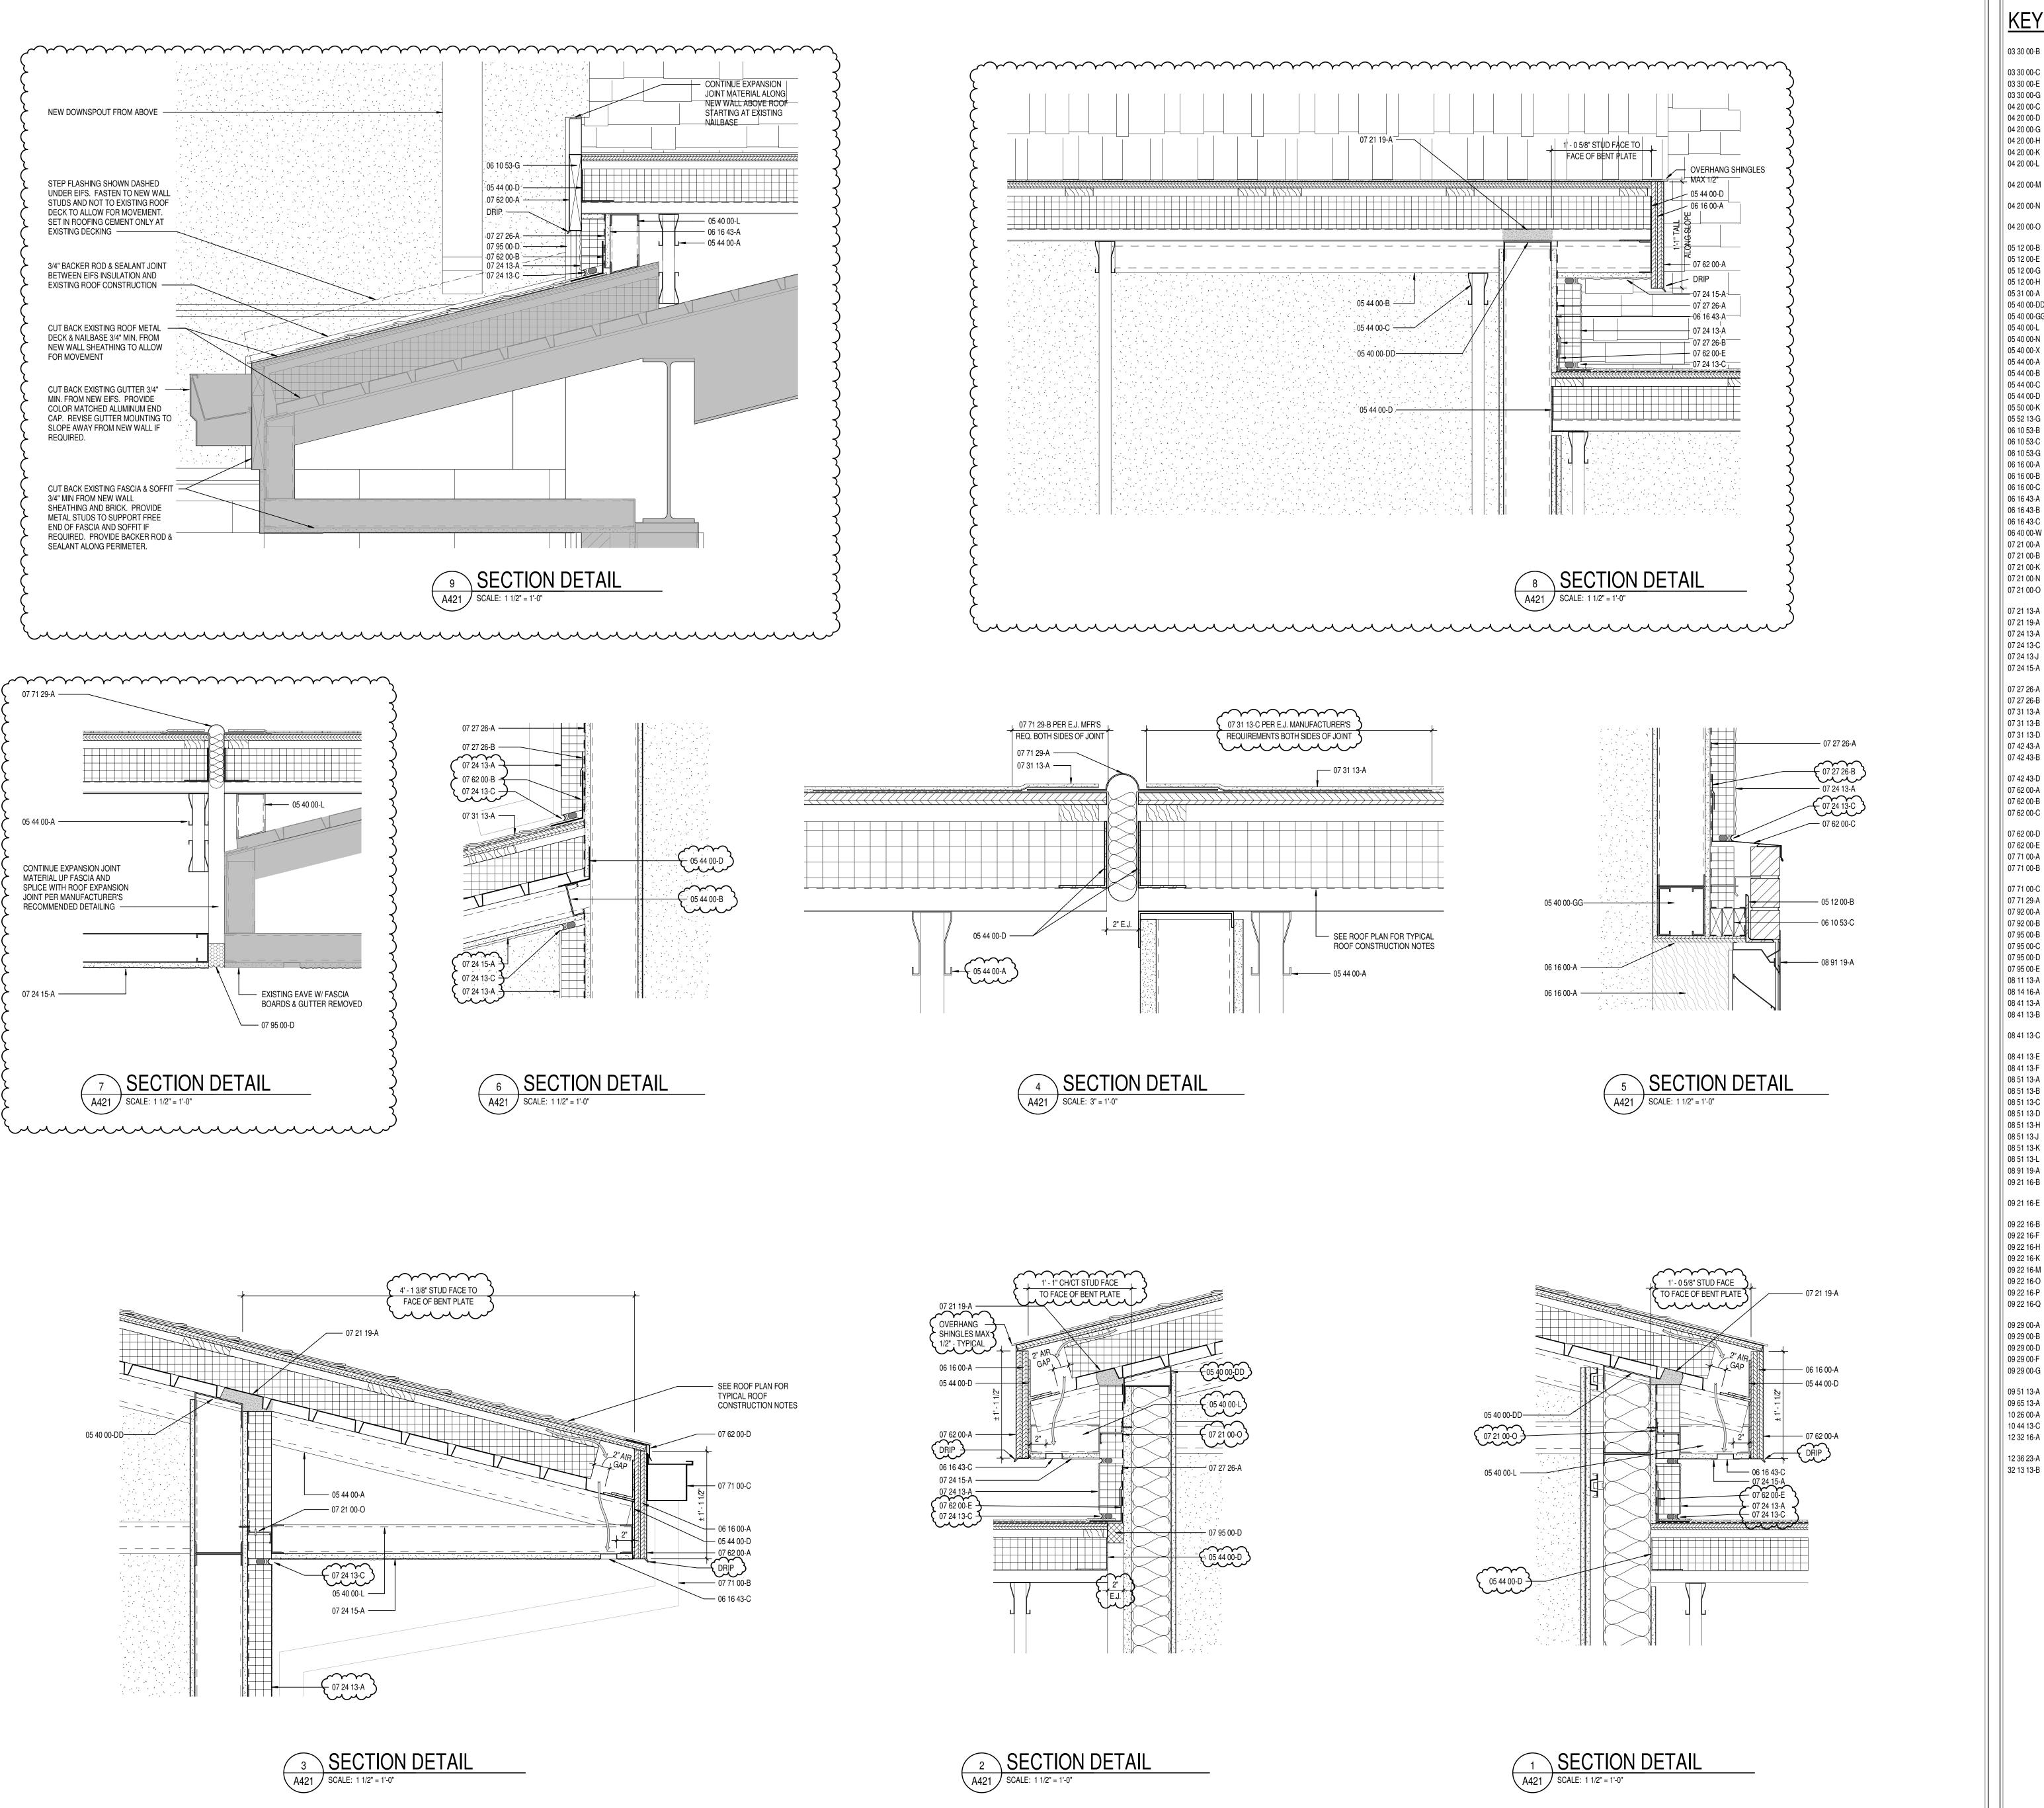
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09/30/22 Author

ADDENDUM #2 10-27-22

DRAWING NUMBER A420



CONCRETE SLAB OVER VAPOR BARRIER ON DRAINAGE FILL. SEE STRUCTURAL CONCRETE SLAB ON METAL DECK- SEE STRUCTURAL 03 30 00-C 03 30 00-E CONCRETE FOOTING- SEE STRUCTURAL 03 30 00-G 1/2" EXPANSION MATERIAL 04 20 00-C MASONRY TIE 04 20 00-D ADJUSTIBLE MASONRY VENEER ANCHOR AT 16" O.C. VERTICALLY 04 20 00-G THROUGH WALL FLASHING W/ STAINLESS STEEL DRIP EDGE 04 20 00-H CELL WEEPS/VENTS AT 24" O.C. MAX. HORIZONTAL 04 20 00-K CAVITY DRAINAGE MATERIAL 04 20 00-L UTILITY SIZE FIELD BRICK COLOR '1', MATCH EXISTING COLOR &

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ATTACHMENT

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1 1/2" VERTICAL HAT CHANNEL, SPACE AS REQUIRED FOR PANEL

07 71 00-C ALUMINUM 5X5 BOX GUTTER, MATCH EXISTING COLOR 07 71 29-A ROOF TO ROOF EXPANSION JOINT W/ FLEXIBLE BELLOW MATERIAL 07 92 00-A BACKER ROD AND SEALANT 07 92 00-B

07 95 00-B INTERIOR WALL EXPANSION JOINT COVER CEILING EXPANSION JOINT COVER 07 95 00-C EXTERIOR WALL EXPANSION JOINT MATERIAL 07 95 00-D EXPANSION JOINT VAPOR BARRIER SYSTEM 07 95 00-E 08 11 13-A HOLLOW METAL DOOR/BORROWED LIGHT FRAME

08 14 16-A FLUSH WOOD DOOR 08 41 13-A 4 1/2" ALUMINUM FRAMED STOREFRONT WIDE STILE ALUMINUM ENTRANCE DOOR (NON-THERMAL, SEE OPENING 08 41 13-B 08 41 13-C

WIDE STILE ALUMINUM ENTRANCE DOOR (THERMAL, SEE OPENING SCHEDULE) ALUMINUM BRAKE METAL ADAPTOR HEAD FRAME

08 41 13-E 08 41 13-F ALUMINUM BRAKE METAL ADAPTOR SILL FRAME ALUMINUM WINDOW, COLOR TO MATCH EXISTING WINDOWS 08 51 13-A 08 51 13-B ALUMINUM WINDOW SLIDING HEAD W/ RECEPTOR

08 51 13-C ALUMINUM WINDOWS SLIDING SILL 08 51 13-D ALUMINUM WINDOWS SLIDING JAMB W/ RECEPTOR 08 51 13-H INSECT SCREEN 08 51 13-J SHIM AS REQUIRED

SEALANT BOTH SIDES 08 51 13-K ALUMINUM SILL FLASHING, COLOR TO MATCH EXISTING WINDOWS 08 51 13-L 08 91 19-A PRE-FINISHED ALUMINUM FIXED LOUVER W/ BIRD SCREEN 09 21 16-B GLASS MAT FACED MOLD & MOISTURE RESISTANT 1" GYPSUM LINER

09 21 16-E 6" CH STUD 18 GA. MIN. @ 16"O.C., PROVIDE CROSS BRACING AS 09 22 16-B

DEFLECTION TRACK 09 22 16-F 1 5/8" STEEL STUD 09 22 16-H 3 5/8" STEEL STUD

6" STEEL STUD

09 22 16-M METAL STUD KICKERS AS REQUIRED SOUND ISOLATION CLIP 09 22 16-O 09 22 16-P METAL STUD BOX HEADER, SIZE BY DELEGATED DESIGN 3-5/8" STEEL STUDS @ 24" O.C. MAX BETWEEN TRUSS BOTTOM CHORDS 09 22 16-Q TO SUPPORT CEILING SOFFIT FRAMING

09 29 00-A 1/4" GYPSUM WALL BOARD 5/8" GYPSUM WALL BOARD (SEE SPECS FOR TYPE) 09 29 00-B 09 29 00-D SOUND ATTENUATION INSULATION 09 29 00-F 1/2" SAG RESISTANT GYPSUM CEILING BOARD METAL GYPSUM BOARD CONTROL JOINT, MATCH EXISTING HEIGHT AND 09 29 00-G

09 51 13-A ACOUSTICAL CEILING SUSPENSION ASSEMBLY 09 65 13-A RESILIENT BASE 10 26 00-A RECESSED CORNER GUARD- SEE EQUIPMENT SCHEDULE

10 44 13-C SEMI-RECESSED FIRE EXTINGUISHER CABINET PLASTIC LAMINATE INSTITUTIONAL CASEWORK- SEE EQUIPMENT 12 32 16-A 12 36 23-A

PLASTIC LAMINATE CLAD COUNTERTOPS CONCRETE PAVING- SEE CIVIL SHEETS

SCOPE DRAWINGS: structural, mechanical and electrical systems.

The drawings do not necessarily indicate or describe a On the basis of the general scope indicated or descri proper execution and completion of the work.


> **REVISIONS:** ADDENDUM #2 10-27-22

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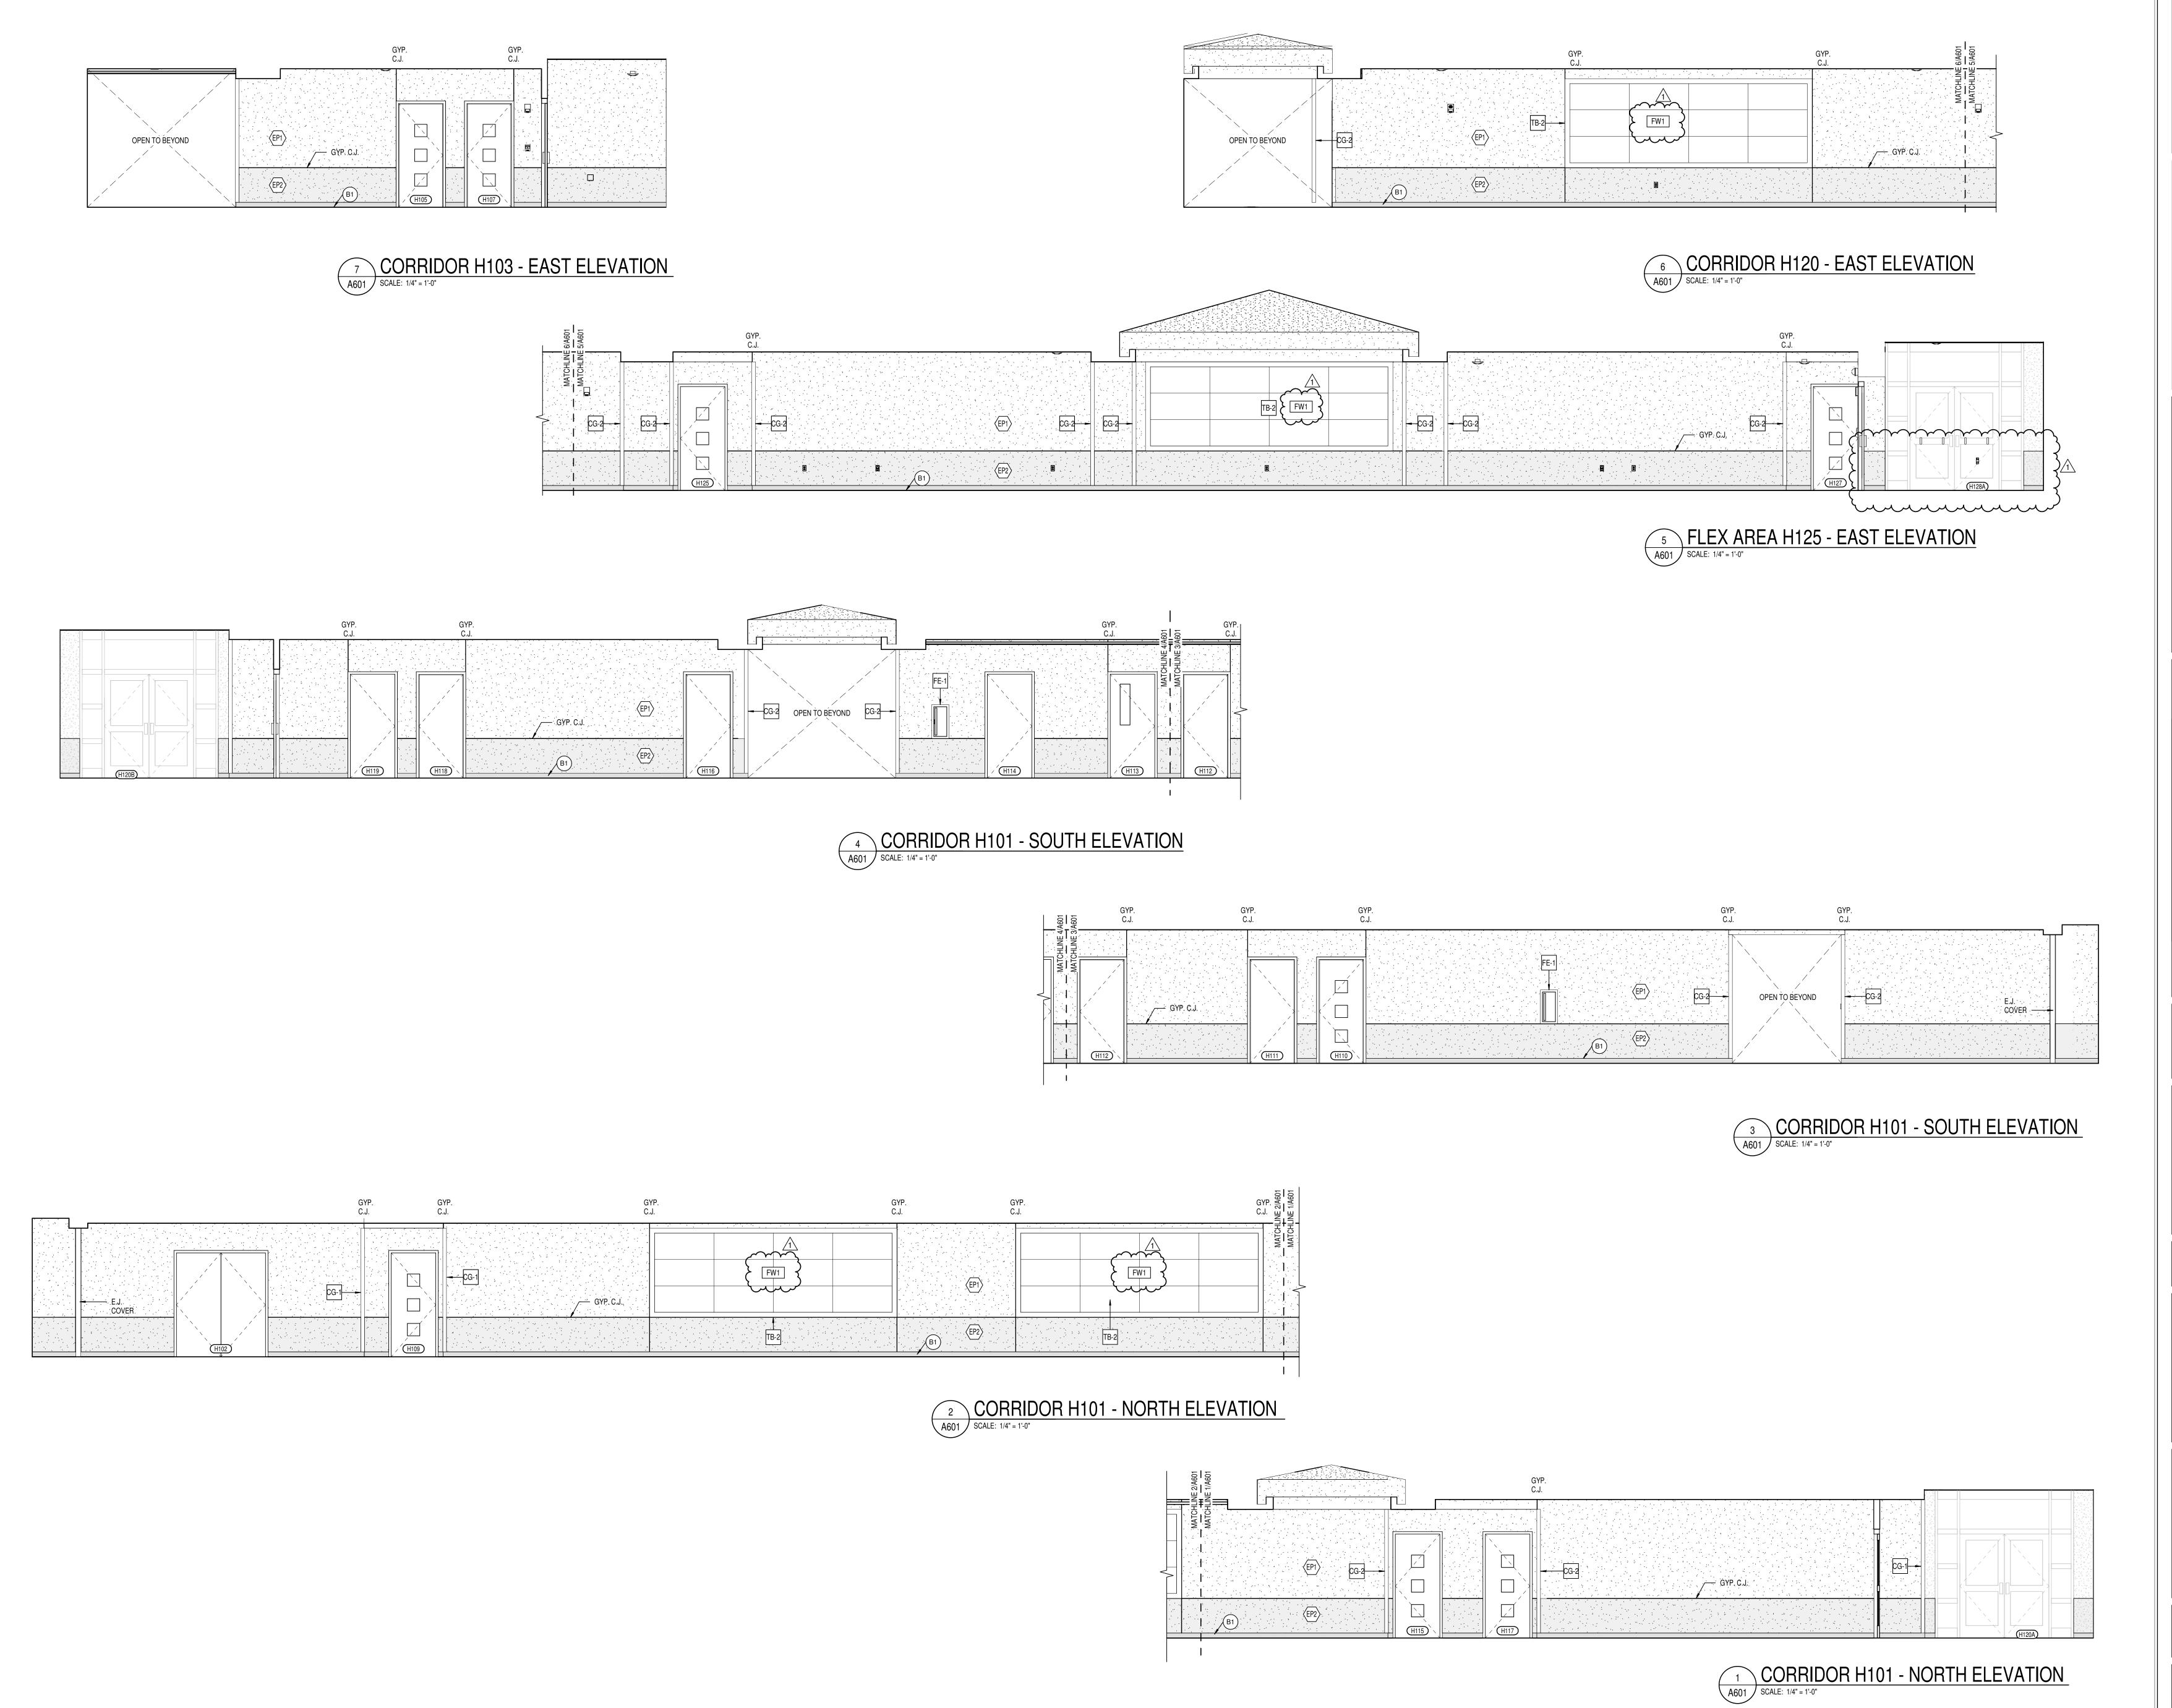
Author

09/30/22

DRAWING TITLE:

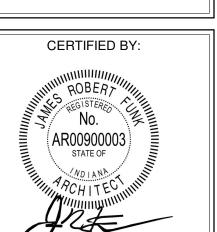

DRAWING NUMBER A421





S831 Keystone Crossing, Indianapolis, IN 46240

Westfield Washington Schools
ADDITION & RENOVATION TO
CAREY RIDGE ELEMENTARY
16231 CAREY ROAD, WESTFIELD, INDIANA 46074

SCOPE DRAWINGS:

These drawings indicate the general scope of the project in terms of architectural design concept, the dimensions of the building, the major architectural elements and the type of structural, mechanical and electrical systems.

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REVISIONS: ADDENDUM #2 10-27-22

ISSUE DATE DRAWN BY CHECKED BY 09/29/22 JBW BH

INTERIOR
ELEVATIONS

CERTIFIED BY:

ROBERT


No.

AR00900003

STATE OF

AROH I TECHNING

A601

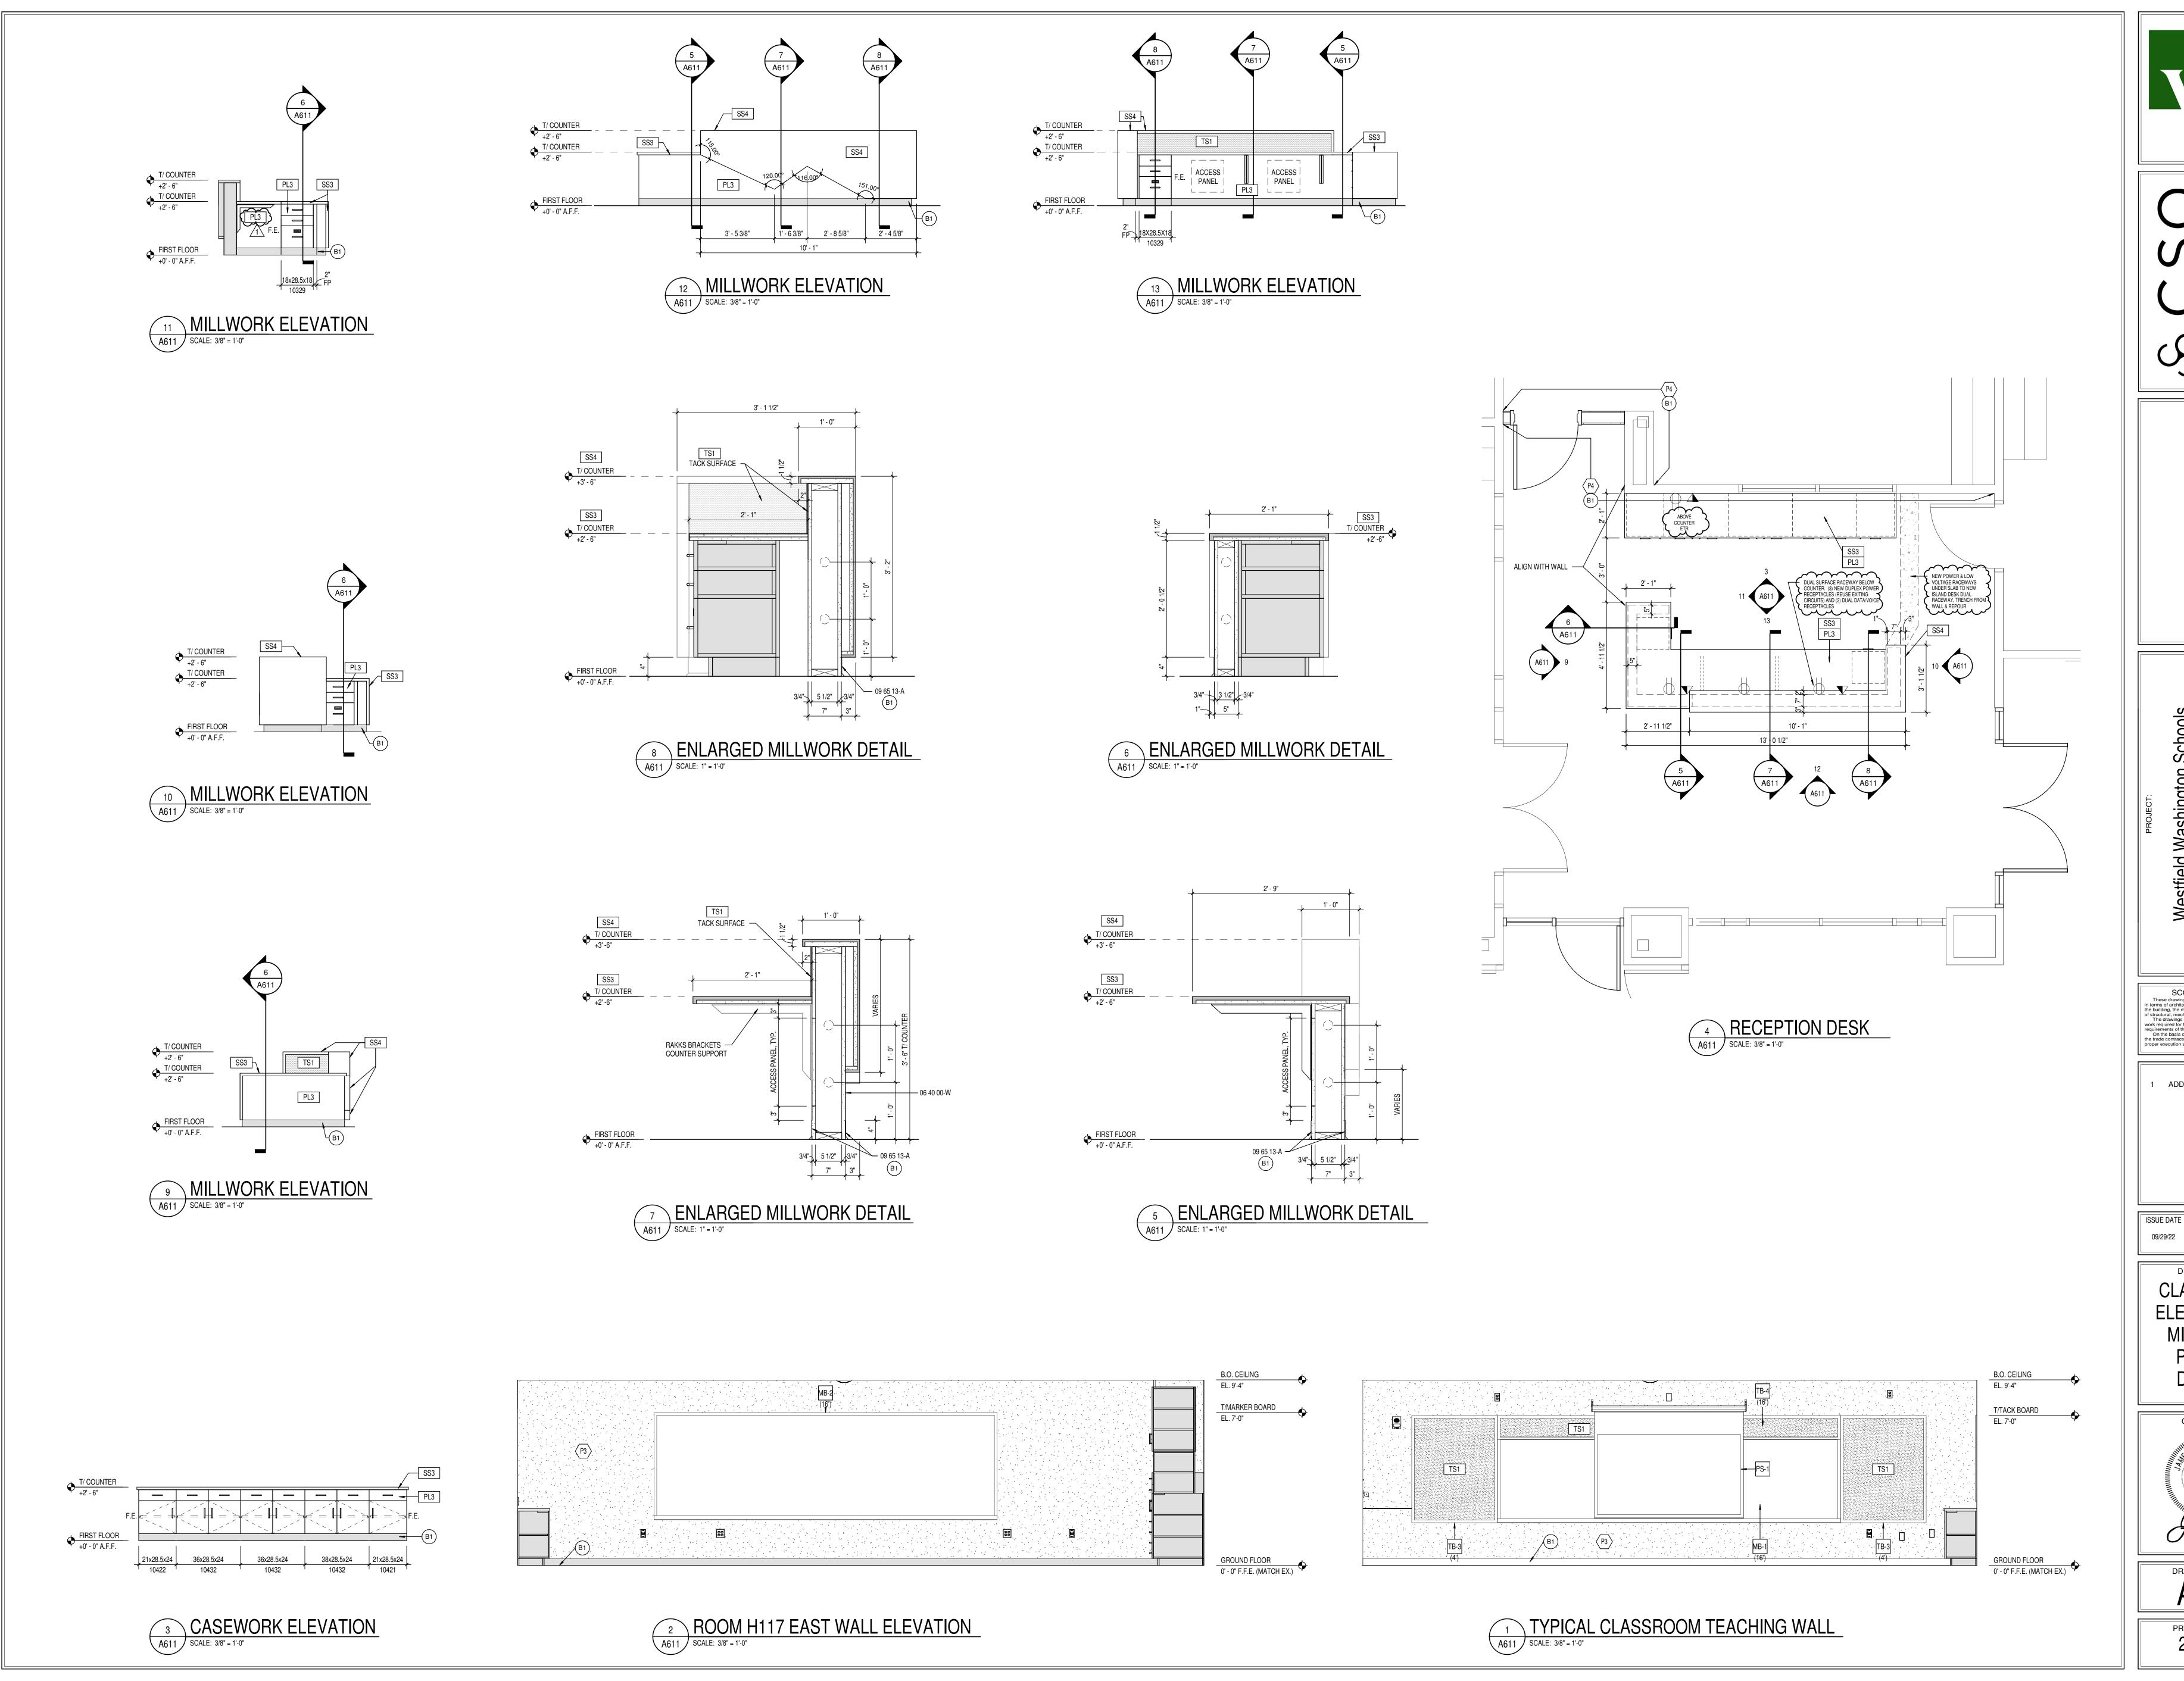



S831 Keystone Crossing, Indianapolis, IN 46240

Westfield Washington Schools
ADDITION & RENOVATION TO
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16231 CAREY ROAD, WESTFIELD, INDIANA 46074

SCOPE DRAWINGS:

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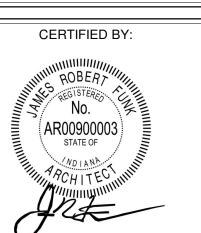
REVISIONS:

REVISIONS:
ADDENDUM #2 10-27-22


ISSUE DATE DRAWN BY CHECKED BY 09/29/22 JBW BH

CLASSROOM FLEVATIONS /

ELEVATIONS / MILLWORK PLANS & DETAILS



A611

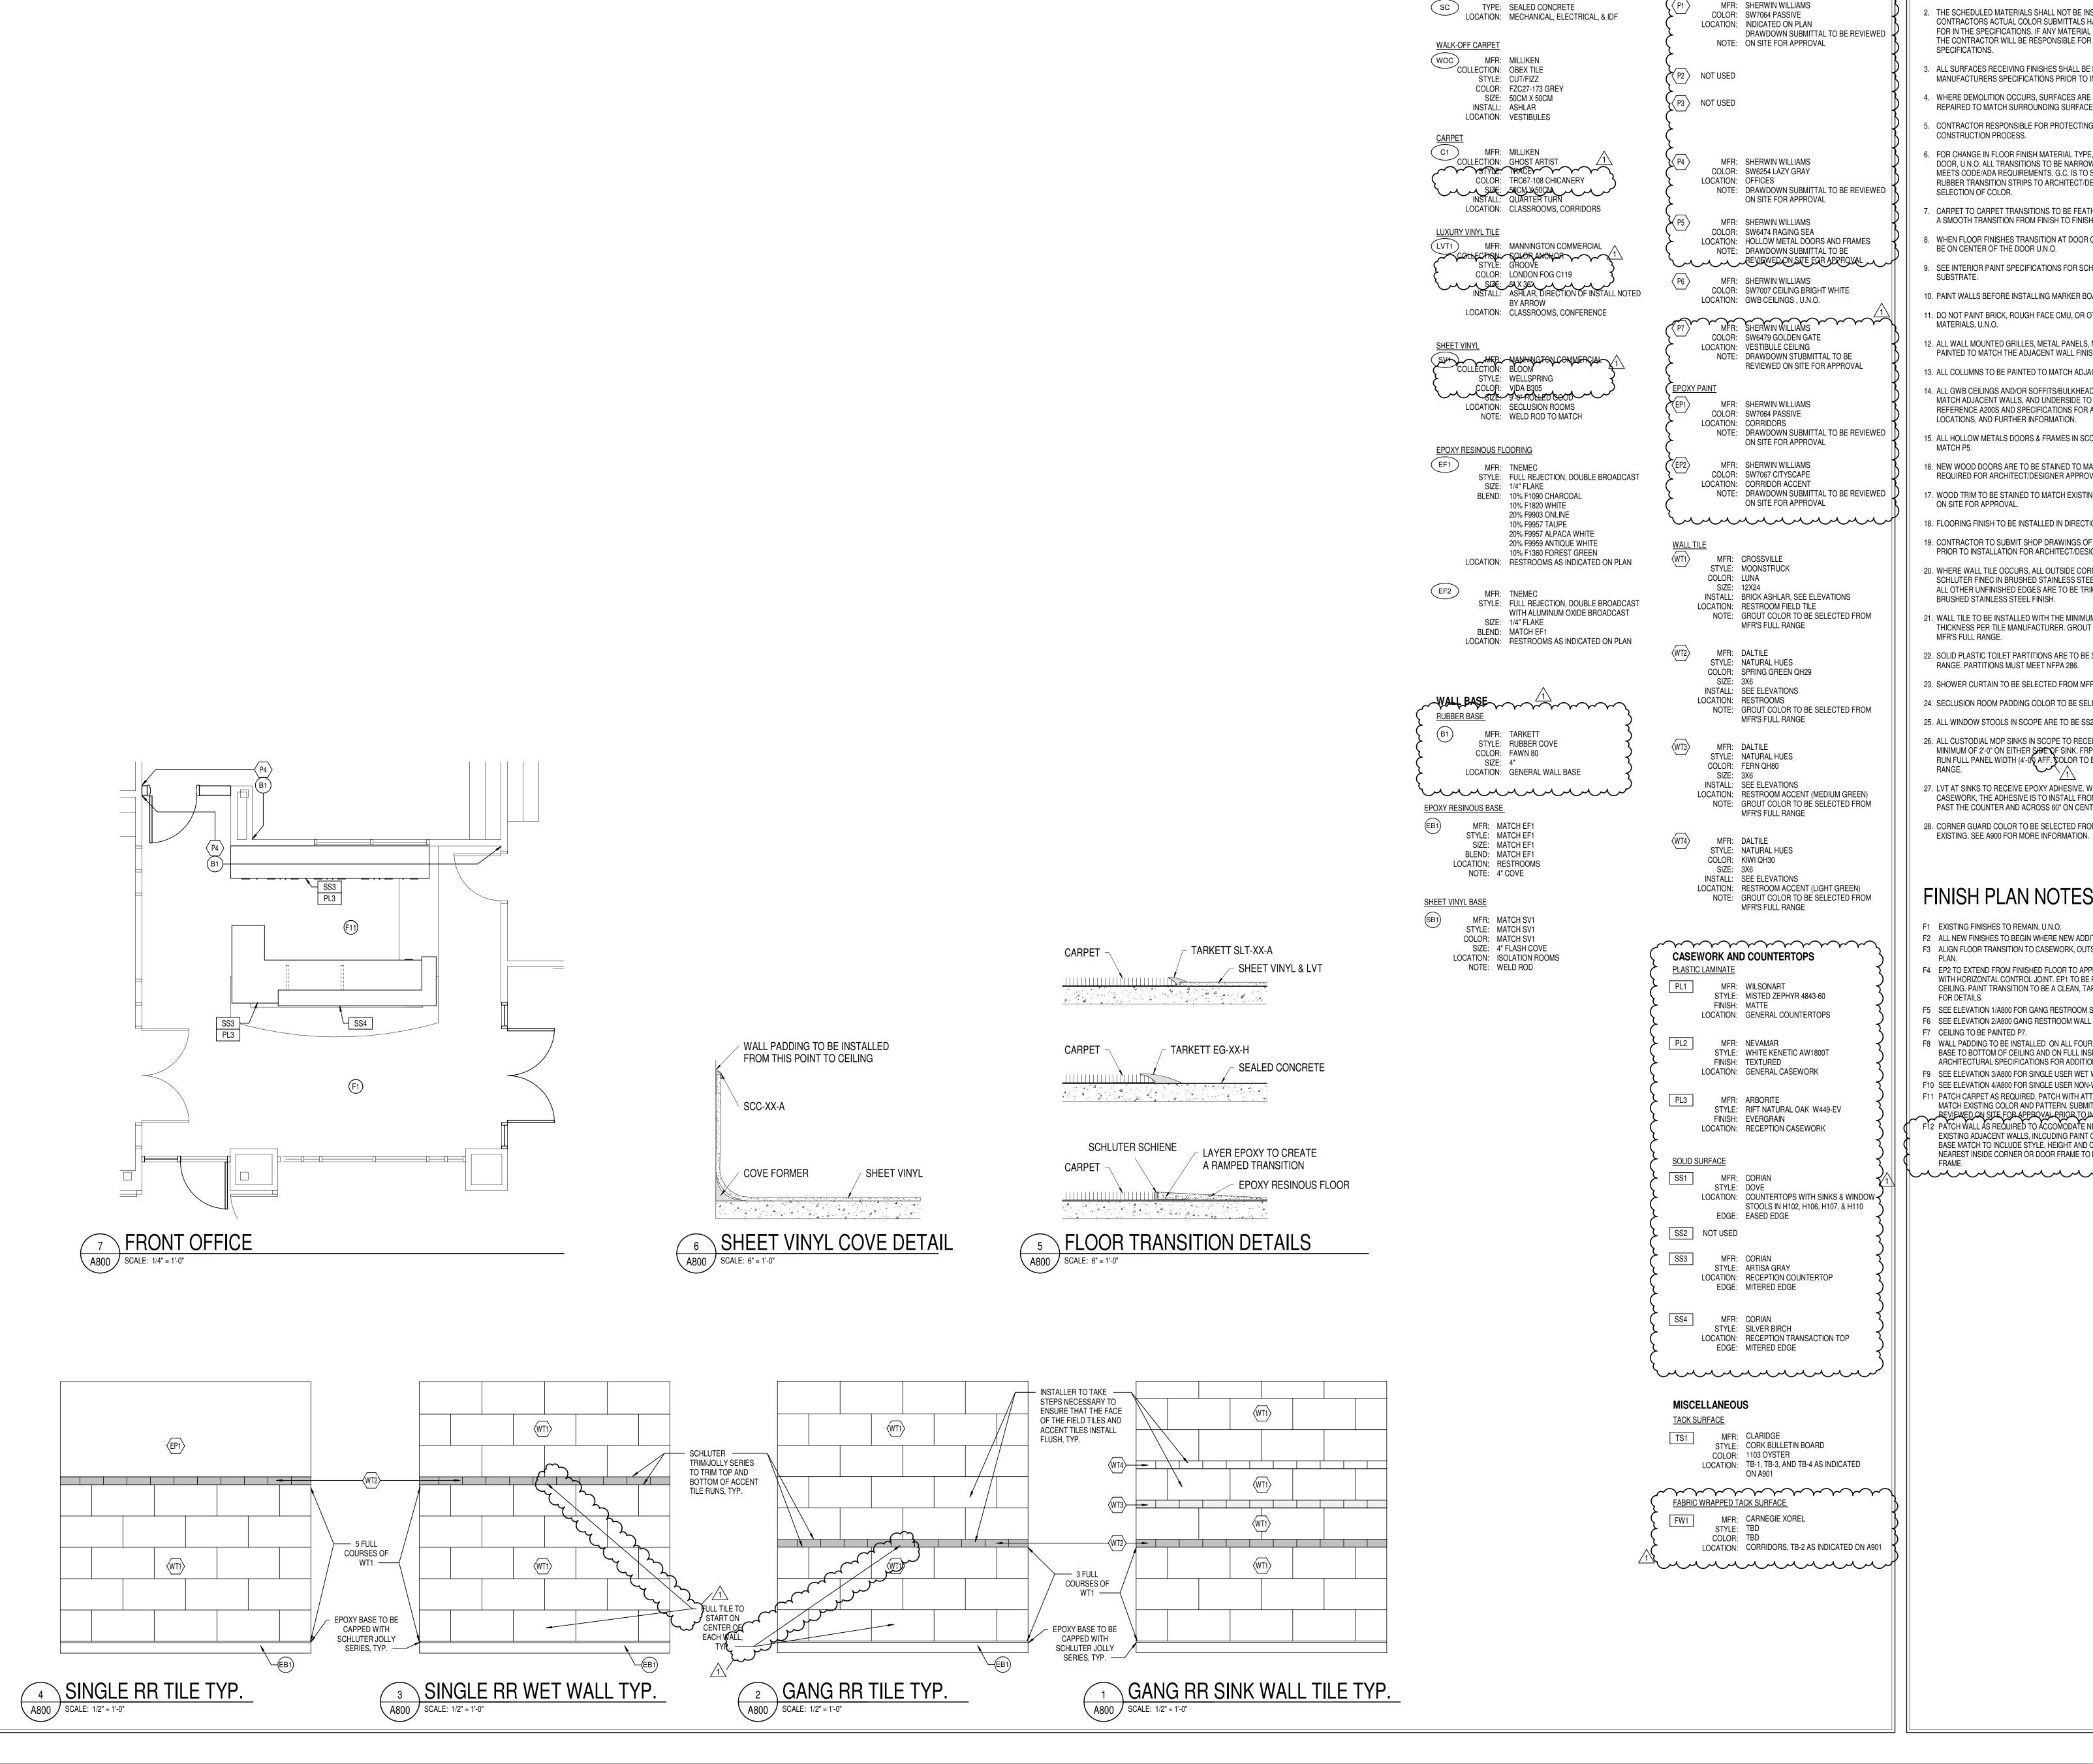

FINISH LEGEND

WALL FINISHES

PANIL TO THE PANIL

FLOOR FINISHES

<u>CONCRETE</u>

TYPE: SEALED CONCRETE

GENERAL FINISH NOTES

SPECIFICATIONS.

CONSTRUCTION PROCESS.

SELECTION OF COLOR.

MATERIALS, U.N.O.

- ANY DISCREPANCIES WITHIN THE DOCUMENTS SHOULD BE BROUGHT TO THE ATTENTION OF CSO ARCHITECTS PRIOR TO INSTALLATION, THESE DOCUMENTS
- WILL GOVERN OVER PREVIOUS SUPPLEMENTAL DRAWINGS. THE SCHEDULED MATERIALS SHALL NOT BE INSTALLED BEFORE THE CONTRACTORS ACTUAL COLOR SUBMITTALS HAVE BEEN APPROVED, AS CALLED FOR IN THE SPECIFICATIONS. IF ANY MATERIAL IS INSTALLED BEFORE APPROVAL, THE CONTRACTOR WILL BE RESPONSIBLE FOR ALL ERRONEOUS
- ALL SURFACES RECEIVING FINISHES SHALL BE PROPERLY PREPARED PER MANUFACTURERS SPECIFICATIONS PRIOR TO INSTALLATION.
- 4. WHERE DEMOLITION OCCURS, SURFACES ARE TO BE PROPERLY PATCHED AND REPAIRED TO MATCH SURROUNDING SURFACES BEFORE FINISH IS APPLIED. CONTRACTOR RESPONSIBLE FOR PROTECTING ALL FINISHES TO REMAIN DURING
- 6. FOR CHANGE IN FLOOR FINISH MATERIAL TYPE, PROVIDE TRANSITION STRIP AT DOOR, U.N.O. ALL TRANSITIONS TO BE NARROWEST PROFILE AVAILABLE THAT MEETS CODE/ADA REQUIREMENTS. G.C. IS TO SUBMIT COLOR SAMPLES OF RUBBER TRANSITION STRIPS TO ARCHITECT/DESIGNER FOR APPROVAL AND
- CARPET TO CARPET TRANSITIONS TO BE FEATHERED AS REQUIRED TO PROVIDE
- A SMOOTH TRANSITION FROM FINISH TO FINISH. WHEN FLOOR FINISHES TRANSITION AT DOOR OPENING THE TRANSITION IS TO
- BE ON CENTER OF THE DOOR U.N.O. SEE INTERIOR PAINT SPECIFICATIONS FOR SCHEDULE OF COATING TYPE PER
- 10. PAINT WALLS BEFORE INSTALLING MARKER BOARDS, TACKBOARDS, ETC.
- 11. DO NOT PAINT BRICK, ROUGH FACE CMU, OR OTHER FACTORY FINISHED
- 12. ALL WALL MOUNTED GRILLES, METAL PANELS, MISC. METALS, ETC. ARE TO BE
- PAINTED TO MATCH THE ADJACENT WALL FINISH U.N.O. 13. ALL COLUMNS TO BE PAINTED TO MATCH ADJACENT WALLS, U.N.O.
- 14. ALL GWB CEILINGS AND/OR SOFFITS/BULKHEADS TO HAVE FACES PAINTED TO MATCH ADJACENT WALLS, AND UNDERSIDE TO BE PAINTED P6, U.N.O.

REFERENCE A200S AND SPECIFICATIONS FOR ALL CEILING MATERIALS,

- LOCATIONS, AND FURTHER INFORMATION. 15. ALL HOLLOW METALS DOORS & FRAMES IN SCOPE ARE TO BE PAINTED TO
- 16. NEW WOOD DOORS ARE TO BE STAINED TO MATCH EXISTING. SUBMITTAL REQUIRED FOR ARCHITECT/DESIGNER APPROVAL.
- 17. WOOD TRIM TO BE STAINED TO MATCH EXISTING. SUBMITTAL TO BE REVIEWED ON SITE FOR APPROVAL.
- 18. FLOORING FINISH TO BE INSTALLED IN DIRECTION OF ARROWS ON PLAN.
- 19. CONTRACTOR TO SUBMIT SHOP DRAWINGS OF ALL FLOOR AND TILE PATTERNS PRIOR TO INSTALLATION FOR ARCHITECT/DESIGNER APPROVAL.
- 20. WHERE WALL TILE OCCURS, ALL OUTSIDE CORNERS ARE TO BE TRIMMED WITH SCHLUTER FINEC IN BRUSHED STAINLESS STEEL FINISH. TOP OF WAINSCOT AND ALL OTHER UNFINISHED EDGES ARE TO BE TRIMMED WITH SCHLUTER JOLLY IN BRUSHED STAINLESS STEEL FINISH.
- THICKNESS PER TILE MANUFACTURER. GROUT COLOR TO BE SELECTED FROM MFR'S FULL RANGE.

21. WALL TILE TO BE INSTALLED WITH THE MINIMUM RECOMMENDED GROUT

- 22. SOLID PLASTIC TOILET PARTITIONS ARE TO BE SELECTED FROM MFR'S FULL RANGE. PARTITIONS MUST MEET NFPA 286.
- 23. SHOWER CURTAIN TO BE SELECTED FROM MFR'S FULL RANGE.
- 24. SECLUSION ROOM PADDING COLOR TO BE SELECTED FROM MFR'S FULL RANGE.
- 25. ALL WINDOW STOOLS IN SCOPE ARE TO BE SS2, U.N.O.
- 26. ALL CUSTODIAL MOP SINKS IN SCOPE TO RECEIVE FRP. LENGTH AS NECESSARY, MINIMUM OF 2'-0" ON EITHER SHEE OF SINK. FRP TO START AT TOP OF BASE AND RUN FULL PANEL WIDTH (4'-0) AFF. SOLOR TO BE SELECTED FROM MFR'S FULL
 - 27. LVT AT SINKS TO RECEIVE EPOXY ADHESIVE. WHERE SINKS ARE LOCATED IN CASEWORK, THE ADHESIVE IS TO INSTALL FROM BASE OF CASEWORK OUT 30"
 - PAST THE COUNTER AND ACROSS 60" ON CENTER WITH SINK. 28. CORNER GUARD COLOR TO BE SELECTED FROM MFR'S FULL RANGE TO MATCH

EXISTING. SEE A900 FOR MORE INFORMATION.

- F1 EXISTING FINISHES TO REMAIN, U.N.O.
- F2 ALL NEW FINISHES TO BEGIN WHERE NEW ADDITION STARTS, U.N.O.
- F3 ALIGN FLOOR TRANSITION TO CASEWORK, OUTSIDE CORNER, OR AS INDICATED ON F4 EP2 TO EXTEND FROM FINISHED FLOOR TO APPROXIMATELY 2'-8" A.F.F. TO ALIGN WITH HORIZONTAL CONTROL JOINT. EP1 TO BE PAINTED FROM THAT POINT JQ
- F5 SEE ELEVATION 1/A800 FOR GANG RESTROOM SINK WALL TILE PATTERN.

CEILING. PAINT TRANSITION TO BE A CLEAN, TAPED LEVEL LINE. REFERENCE A601

- F6 SEE ELEVATION 2/A800 GANG RESTROOM WALL TILE PATTERN. F7 CEILING TO BE PAINTED P7.
- F8 WALL PADDING TO BE INSTALLED ON ALL FOUR WALLS FROM TOP OF SHEET VINYL
- BASE TO BOTTOM OF CEILING AND ON FULL INSIDE FACE OF DOOR. SEE ARCHITECTURAL SPECIFICATIONS FOR ADDITIONAL INFORMATION.
- F9 SEE ELEVATION 3/A800 FOR SINGLE USER WET WALL TILE PATTERN.
- F10 SEE ELEVATION 4/A800 FOR SINGLE USER NON-WET WALL TILE PATTERN. F11 PATCH CARPET AS REQUIRED. PATCH WITH ATTIC STOCK OR NEW MATERIAL TO
- MATCH EXISTING COLOR AND PATTERN. SUBMITTAL OF NEW MATERIAL TO BE REVIEWED ON SITE FOR APPROVAL PRIOR TO INSTALLATION.

 F12 PATCH WALL AS REQUIRED TO ACCOMODATE NEW FIXTURE. PATCH TO MATCH EXISTING ADJACENT WALLS, INLCUDING PAINT COLOR, QUALITY AND FINISH AND BASE MATCH TO INCLUDE STYLE, HEIGHT AND COLOR. REPLACE BASE FROM

NEAREST INSIDE CORNER OR DOOR FRAME TO NEAREST INSIDE CORNER OR DOOR ✓

ols TO TAF **CA** 16231

SCOPE DRAWINGS: equirements of the Contract.
On the basis of the general scope indicated or descri proper execution and completion of the work.

> **REVISIONS:** ADDENDUM #2 10-27-22

ISSUE DATE | DRAWN BY | CHECKED BY

KLK

AND NOTES


09/20/22

DRAWING TITLE: FINISH LEGEND

MEB

CERTIFIED BY: ROBERT (AR00900003)

DRAWING NUMBER A800

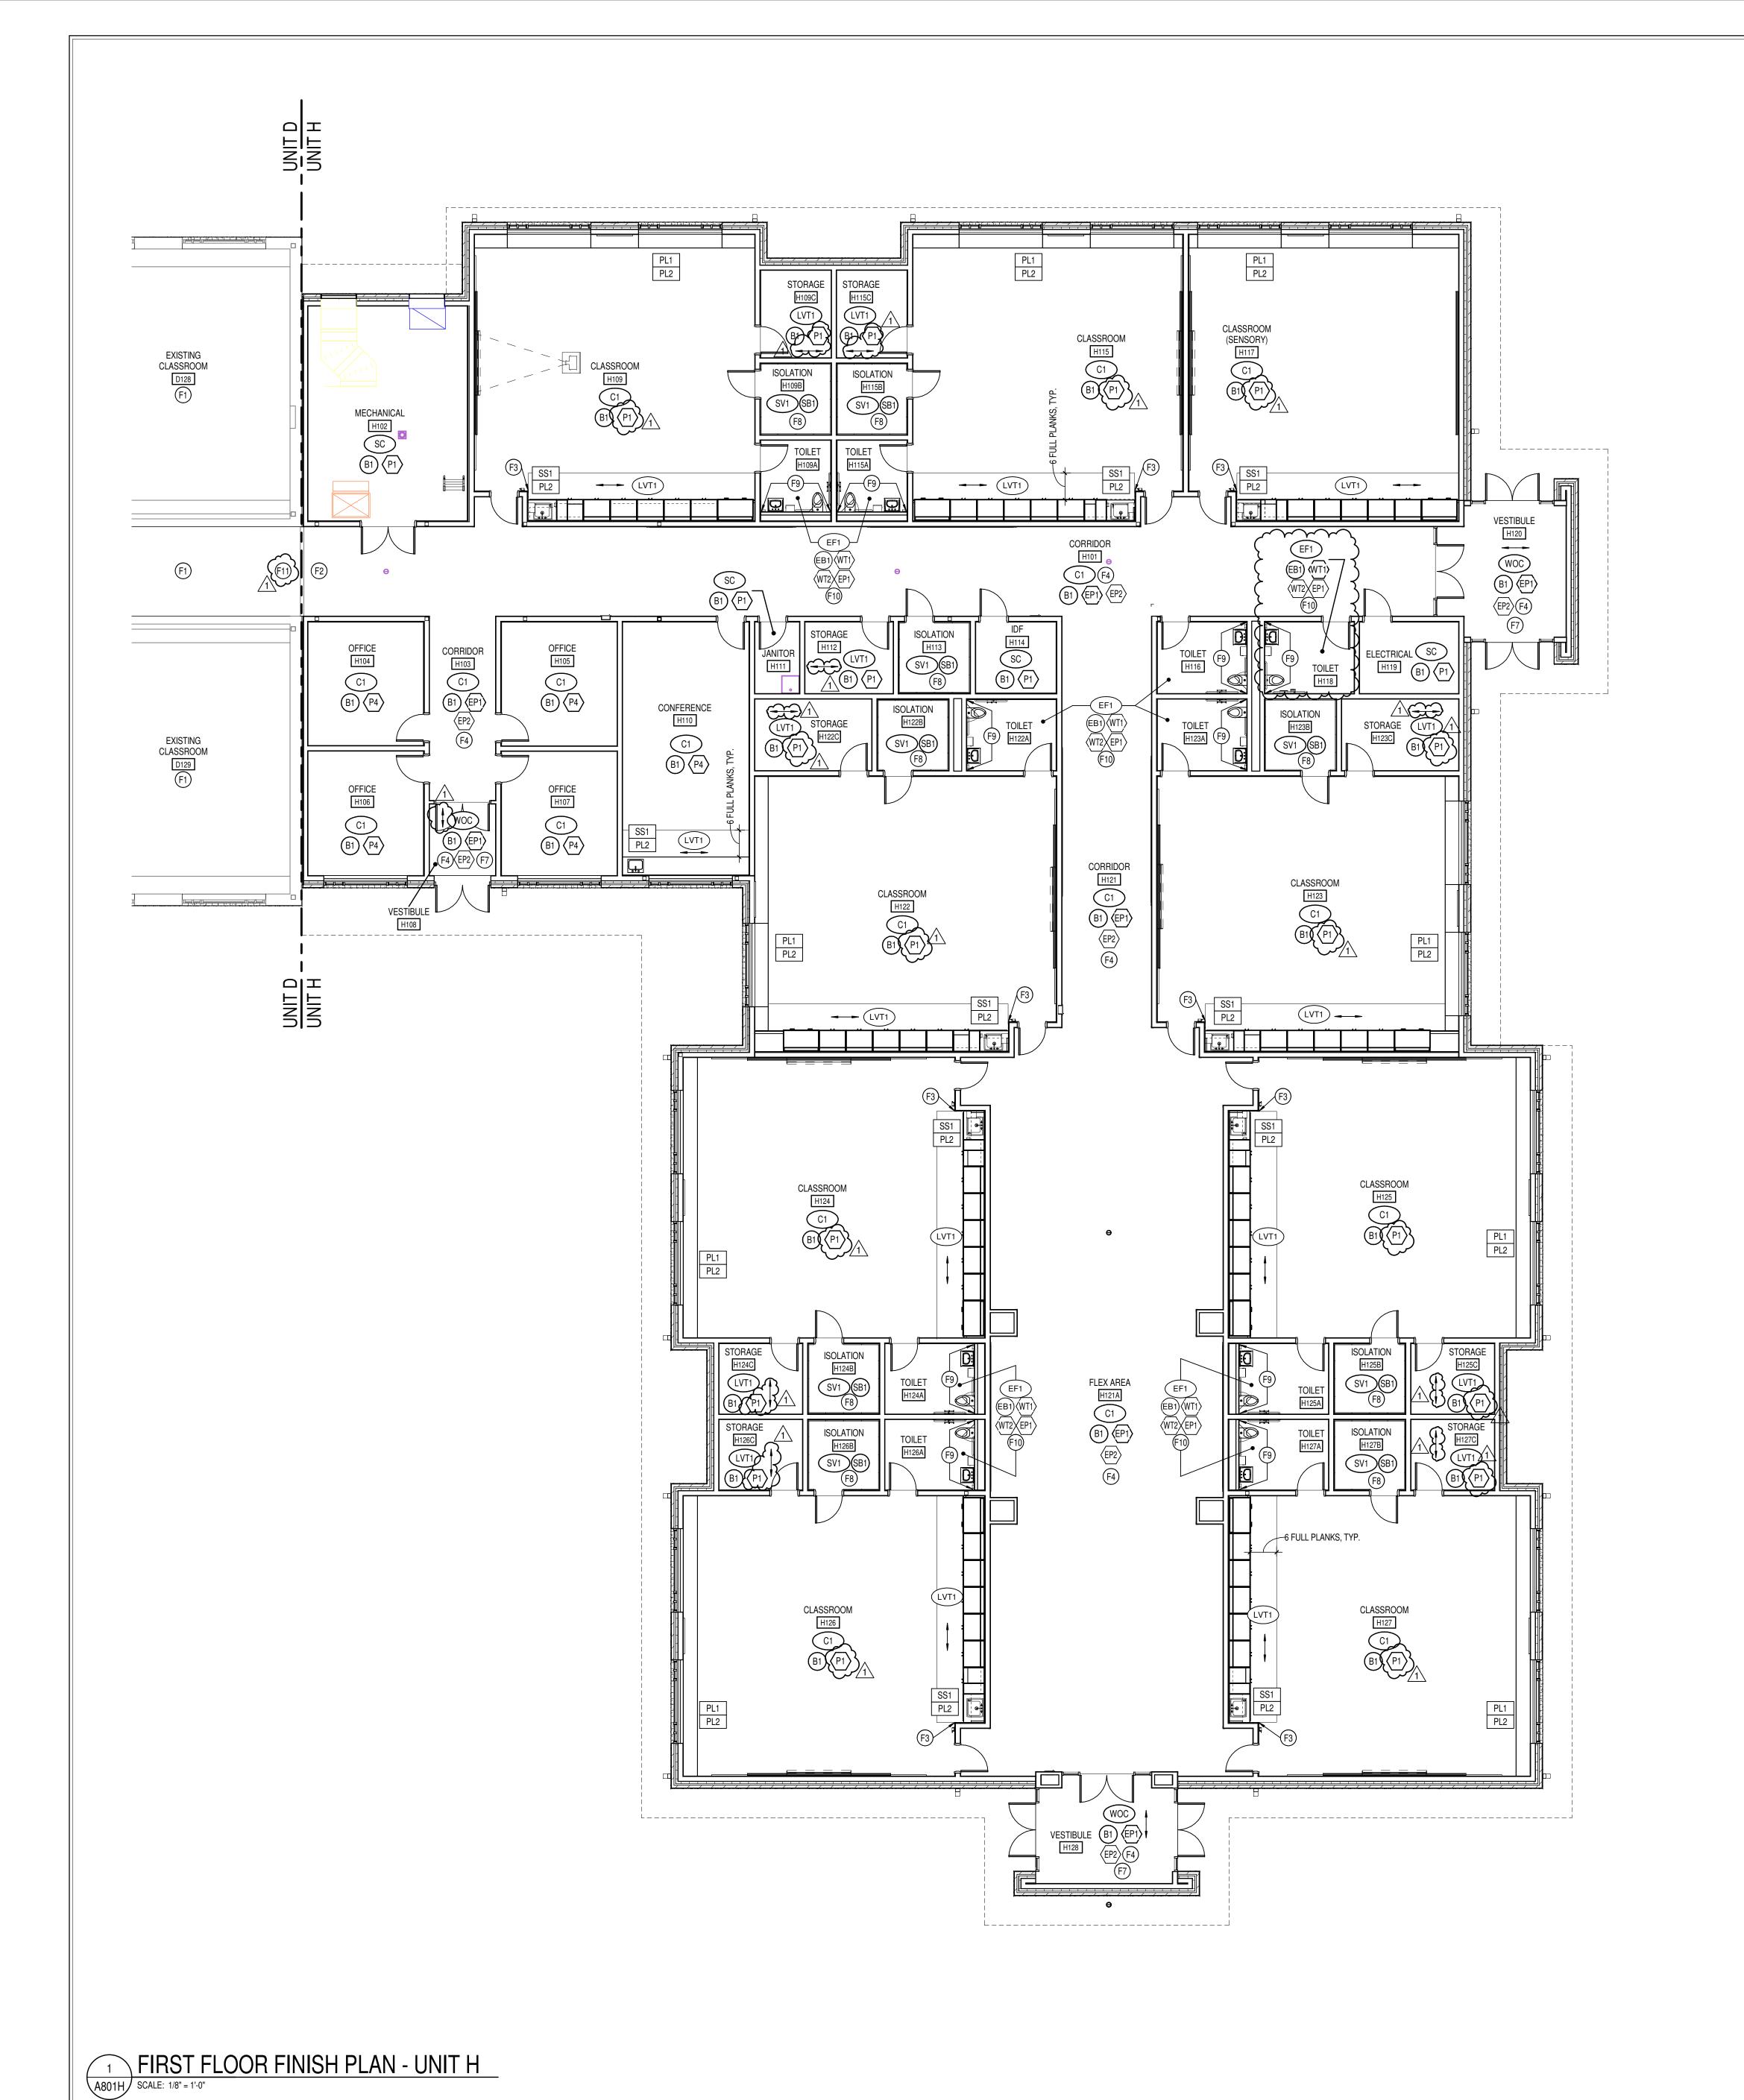

GENERAL FINISH NOTES

- ANY DISCREPANCIES WITHIN THE DOCUMENTS SHOULD BE BROUGHT TO THE ATTENTION OF CSO ARCHITECTS PRIOR TO INSTALLATION. THESE DOCUMENTS WILL GOVERN OVER PREVIOUS SUPPLEMENTAL DRAWINGS.
- 2. THE SCHEDULED MATERIALS SHALL NOT BE INSTALLED BEFORE THE CONTRACTORS ACTUAL COLOR SUBMITTALS HAVE BEEN APPROVED, AS CALLED FOR IN THE SPECIFICATIONS. IF ANY MATERIAL IS INSTALLED BEFORE APPROVAL, THE CONTRACTOR WILL BE RESPONSIBLE FOR ALL ERRONEOUS SPECIFICATIONS.
- 3. ALL SURFACES RECEIVING FINISHES SHALL BE PROPERLY PREPARED PER MANUFACTURERS SPECIFICATIONS PRIOR TO INSTALLATION.
- 4. WHERE DEMOLITION OCCURS, SURFACES ARE TO BE PROPERLY PATCHED AND REPAIRED TO MATCH SURROUNDING SURFACES BEFORE FINISH IS APPLIED.
- 5. CONTRACTOR RESPONSIBLE FOR PROTECTING ALL FINISHES TO REMAIN DURING CONSTRUCTION PROCESS.6. FOR CHANGE IN FLOOR FINISH MATERIAL TYPE, PROVIDE TRANSITION STRIP AT
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- 7. CARPET TO CARPET TRANSITIONS TO BE FEATHERED AS REQUIRED TO PROVIDE A SMOOTH TRANSITION FROM FINISH TO FINISH.
- 8. WHEN FLOOR FINISHES TRANSITION AT DOOR OPENING THE TRANSITION IS TO BE ON CENTER OF THE DOOR U.N.O.
- 9. SEE INTERIOR PAINT SPECIFICATIONS FOR SCHEDULE OF COATING TYPE PER
- 10. PAINT WALLS BEFORE INSTALLING MARKER BOARDS, TACKBOARDS, ETC.
- 11. DO NOT PAINT BRICK, ROUGH FACE CMU, OR OTHER FACTORY FINISHED MATERIALS, U.N.O.
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- 13. ALL COLUMNS TO BE PAINTED TO MATCH ADJACENT WALLS, U.N.O.
- 14. ALL GWB CEILINGS AND/OR SOFFITS/BULKHEADS TO HAVE FACES PAINTED TO MATCH ADJACENT WALLS, AND UNDERSIDE TO BE PAINTED P6, U.N.O. REFERENCE A200S AND SPECIFICATIONS FOR ALL CEILING MATERIALS,
- 15. ALL HOLLOW METALS DOORS & FRAMES IN SCOPE ARE TO BE PAINTED TO MATCH P5.

LOCATIONS, AND FURTHER INFORMATION.

BRUSHED STAINLESS STEEL FINISH.

- 16. NEW WOOD DOORS ARE TO BE STAINED TO MATCH EXISTING. SUBMITTAL REQUIRED FOR ARCHITECT/DESIGNER APPROVAL.
- 17. WOOD TRIM TO BE STAINED TO MATCH EXISTING. SUBMITTAL TO BE REVIEWED ON SITE FOR APPROVAL.
- 18. FLOORING FINISH TO BE INSTALLED IN DIRECTION OF ARROWS ON PLAN.
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- 21. WALL TILE TO BE INSTALLED WITH THE MINIMUM RECOMMENDED GROUT THICKNESS PER TILE MANUFACTURER. GROUT COLOR TO BE SELECTED FROM MFR'S FULL RANGE.
- 22. SOLID PLASTIC TOILET PARTITIONS ARE TO BE SELECTED FROM MFR'S FULL RANGE. PARTITIONS MUST MEET NFPA 286.
- 23. SHOWER CURTAIN TO BE SELECTED FROM MFR'S FULL RANGE.
- 24. SECLUSION ROOM PADDING COLOR TO BE SELECTED FROM MFR'S FULL RANGE.
- 25. ALL WINDOW STOOLS IN SCOPE ARE TO BE SS2, U.N.O.
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- 27. LVT AT SINKS TO RECEIVE EPOXY ADHESIVE. WHERE SINKS ARE LOCATED IN CASEWORK, THE ADHESIVE IS TO INSTALL FROM BASE OF CASEWORK OUT 30" PAST THE COUNTER AND ACROSS 60" ON CENTER WITH SINK.
- 28. CORNER GUARD COLOR TO BE SELECTED FROM MFR'S FULL RANGE TO MATCH EXISTING. SEE A900 FOR MORE INFORMATION.

FINISH PLAN NOTES

- F1 EXISTING FINISHES TO REMAIN, U.N.O.F2 ALL NEW FINISHES TO BEGIN WHERE NEW ADDITION STARTS, U.N.O.
- F3 ALIGN FLOOR TRANSITION TO CASEWORK, OUTSIDE CORNER, OR AS INDICATED ON
- F4 EP2 TO EXTEND FROM FINISHED FLOOR TO APPROXIMATELY 2'-8" A.F.F. TO ALIGN WITH HORIZONTAL CONTROL JOINT. EP1 TO BE PAINTED FROM THAT POINT TO CEILING. PAINT TRANSITION TO BE A CLEAN, TAPED LEVEL LINE. REFERENCE A601 FOR DETAILS.
- F5 SEE ELEVATION 1/A800 FOR GANG RESTROOM SINK WALL TILE PATTERN.
 F6 SEE ELEVATION 2/A800 GANG RESTROOM WALL TILE PATTERN.
- F6 SEE ELEVATION 2/A800 GANG RESTROOM WALL TILE PATTERN.
 F7 CEILING TO BE PAINTED P7.
 F8 WALL PADDING TO BE INSTALLED ON ALL FOUR WALLS FROM TOP OF SHEET VINYL
- ARCHITECTURAL SPECIFICATIONS FOR ADDITIONAL INFORMATION.

 F9 SEE ELEVATION 3/A800 FOR SINGLE USER WET WALL TILE PATTERN.

BASE TO BOTTOM OF CEILING AND ON FULL INSIDE FACE OF DOOR. SEE

- F9 SEE ELEVATION 3/A800 FOR SINGLE USER WET WALL TILE PATTERN.
 F10 SEE ELEVATION 4/A800 FOR SINGLE USER NON-WET WALL TILE PATTERN.
 F11 PATCH CARPET AS REQUIRED. PATCH WITH ATTIC STOCK OR NEW MATERIAL TO
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 F12 PATCH WALL AS REQUIRED TO ACCOMODATE NEW FIXTURE. PATCH TO MATCH EXISTING ADJACENT WALLS. INI CUDING PAINT COLOR. QUALITY AND FINISH AND
- EXISTING ADJACENT WALLS, INLCUDING PAINT COLOR, QUALITY AND FINISH AND BASE MATCH TO INCLUDE STYLE, HEIGHT AND COLOR. REPLACE BASE FROM NEAREST INSIDE CORNER OR DOOR FRAME TO NEAREST INSIDE CORNER OR DOOR FRAME.



8831 Keystone Crossing, Indianapolis, IN 46240

ADDITION & RENOVATION TO
CAREY RIDGE ELEMENTARY
16231 CAREY ROAD, WESTFIELD, INDIANA 4607

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REVISIONS:

SCOPE DRAWINGS:

ADDENDUM #2 10-27-22


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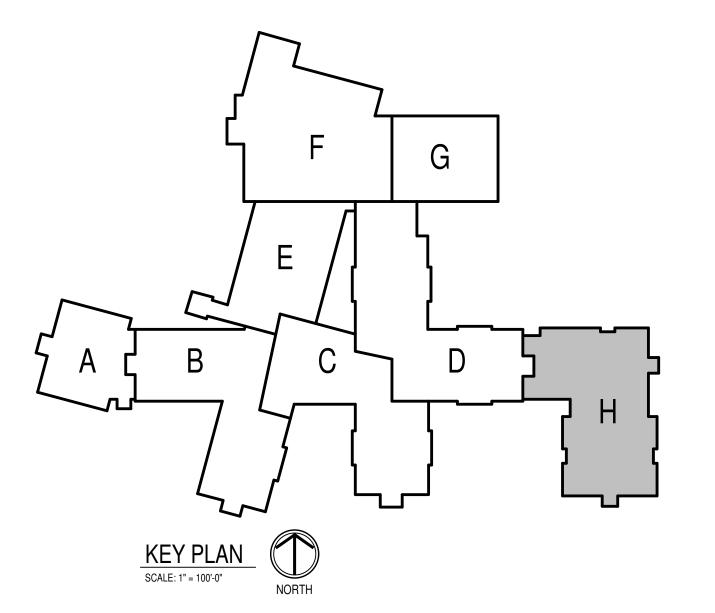
09/16/22


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MEB



DRAWING NUMBER
A801H



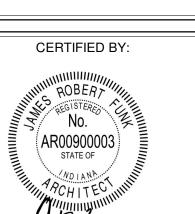


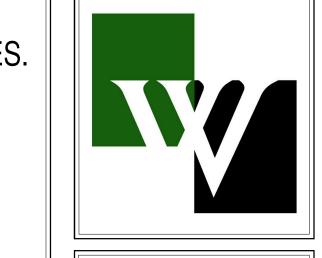Westfield Washington Schools
ADDITION & RENOVATION TO
CAREY RIDGE ELEMENTARY
16231 CAREY ROAD, WESTFIELD, INDIANA 46074

REVISIONS: ADDENDUM #2 10-27-22

ISSUE DATE | DRAWN BY | CHECKED BY 09/20/22 KLK

DRAWING TITLE: **ENLARGED** RESTROOM FINISH PLANS (ALTERNATE)

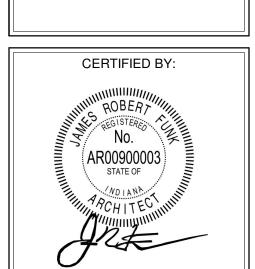


DRAWING NUMBER A802

PROJECT NUMBER 2022020

UNIT A RESTROOM #1 FINISH PLAN

A802 SCALE: 1/4" = 1'-0"

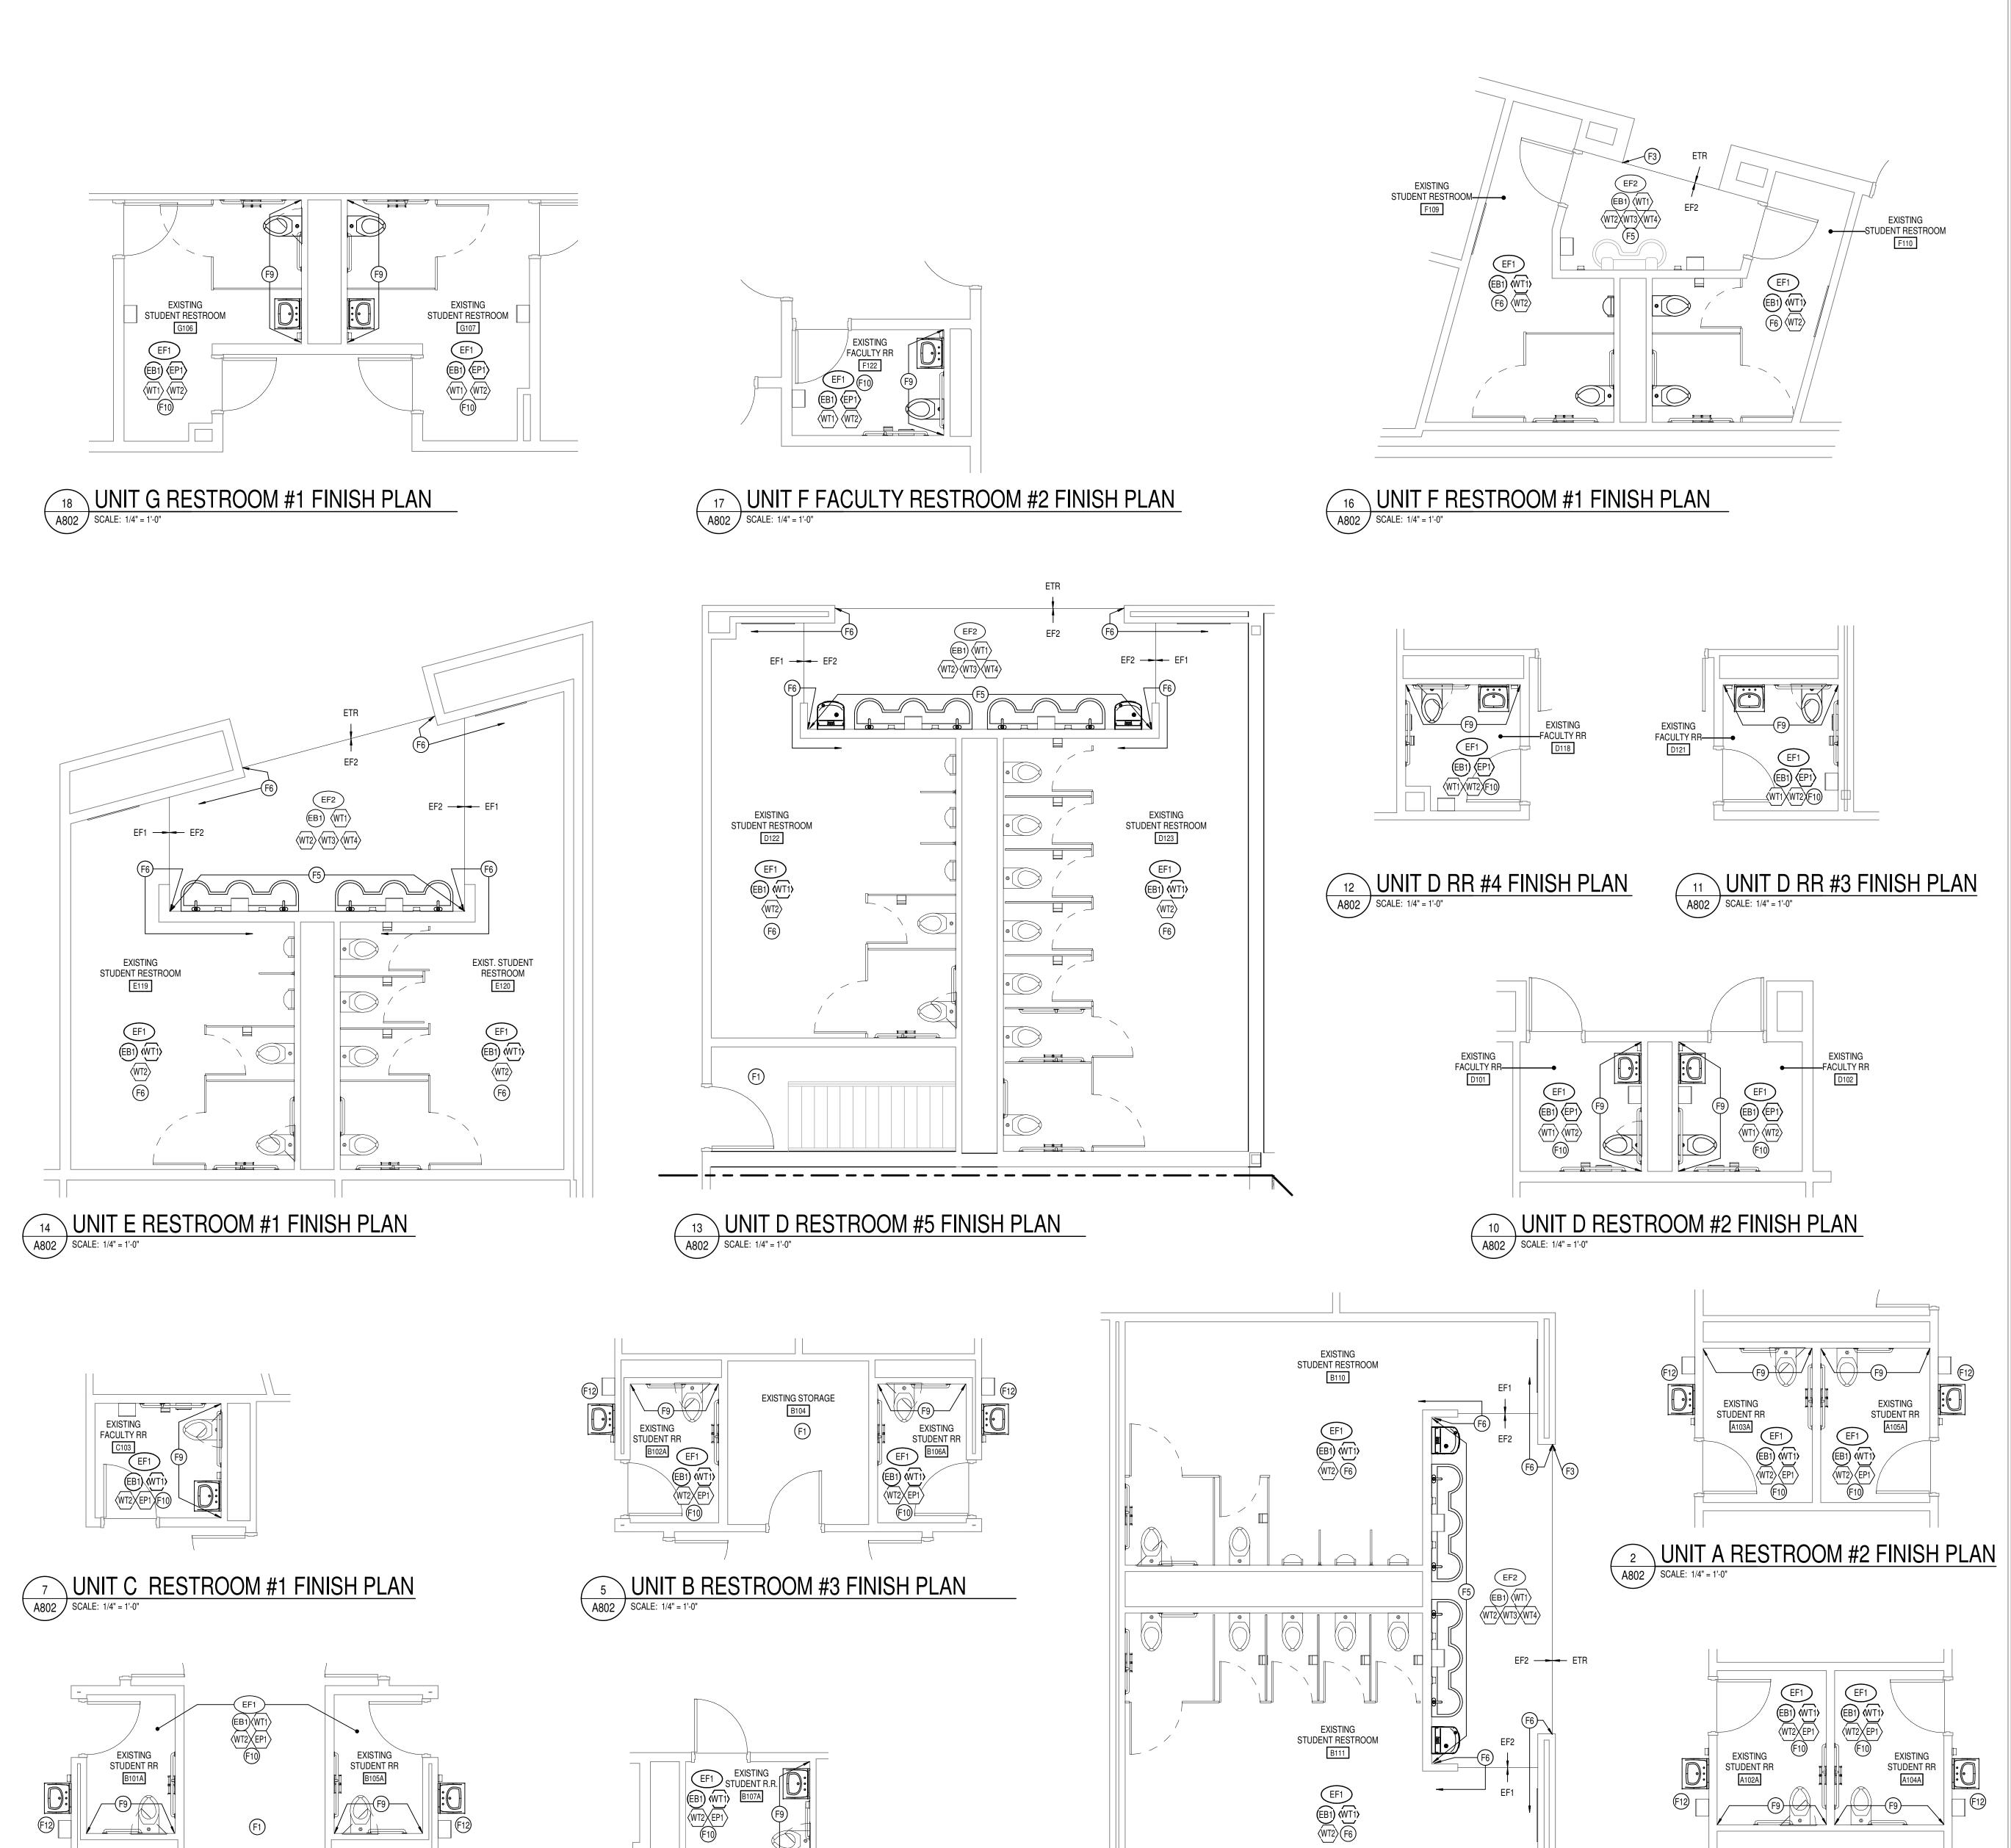

9 UNIT D RESTROOM #1 FINISH PLAN

SCALE: 1/4" = 1'-0" (WT2\EP1\) EXISTING FACULTY RR C101 8 UNIT C RESTROOM #2 FINISH PLAN

SCALE: 1/4" = 1'-0"

(EB1) (WT1) (WT2) (EP1) (F10)

STUDENT RR

EF1 (WT1) (F6 (WT2)

EXISTING
FACULTY RR

E114

EF1


(EB1) (WT1)


EXISTING NURSES RR E111A


UNIT E FACULTY & NURSE RESTROOM #2 FINISH PLAN

SCALE: 1/4" = 1'-0"

STUDENT RR

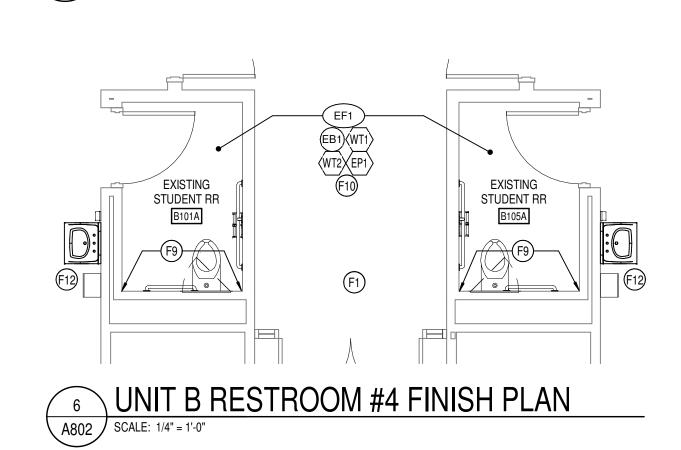

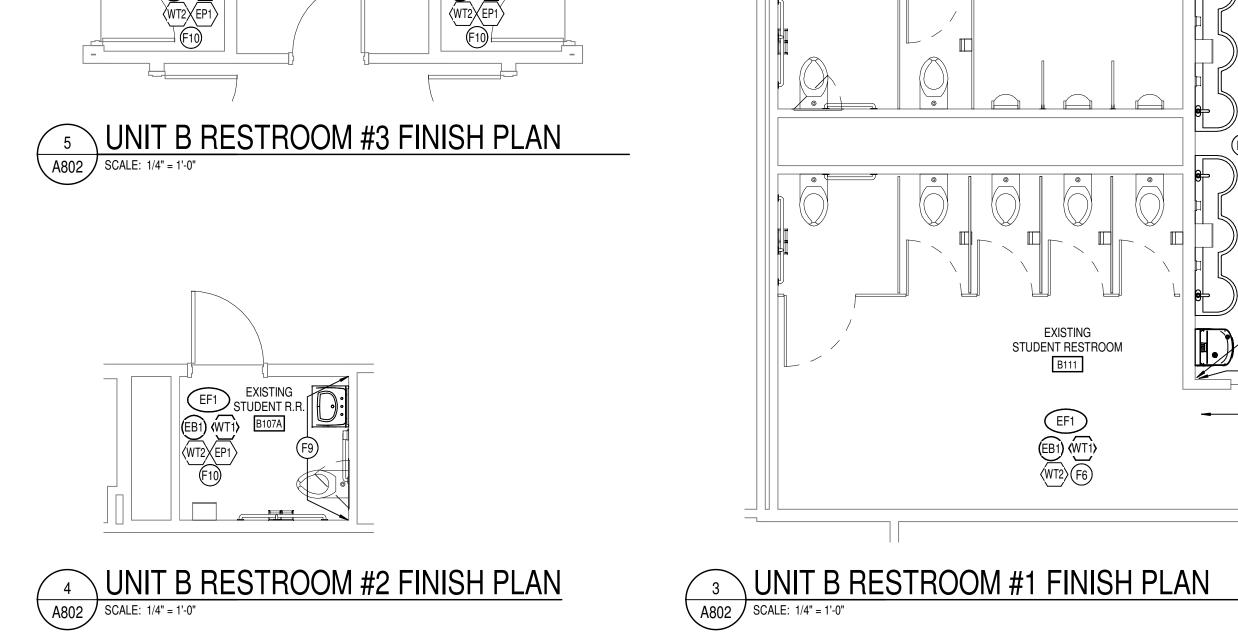


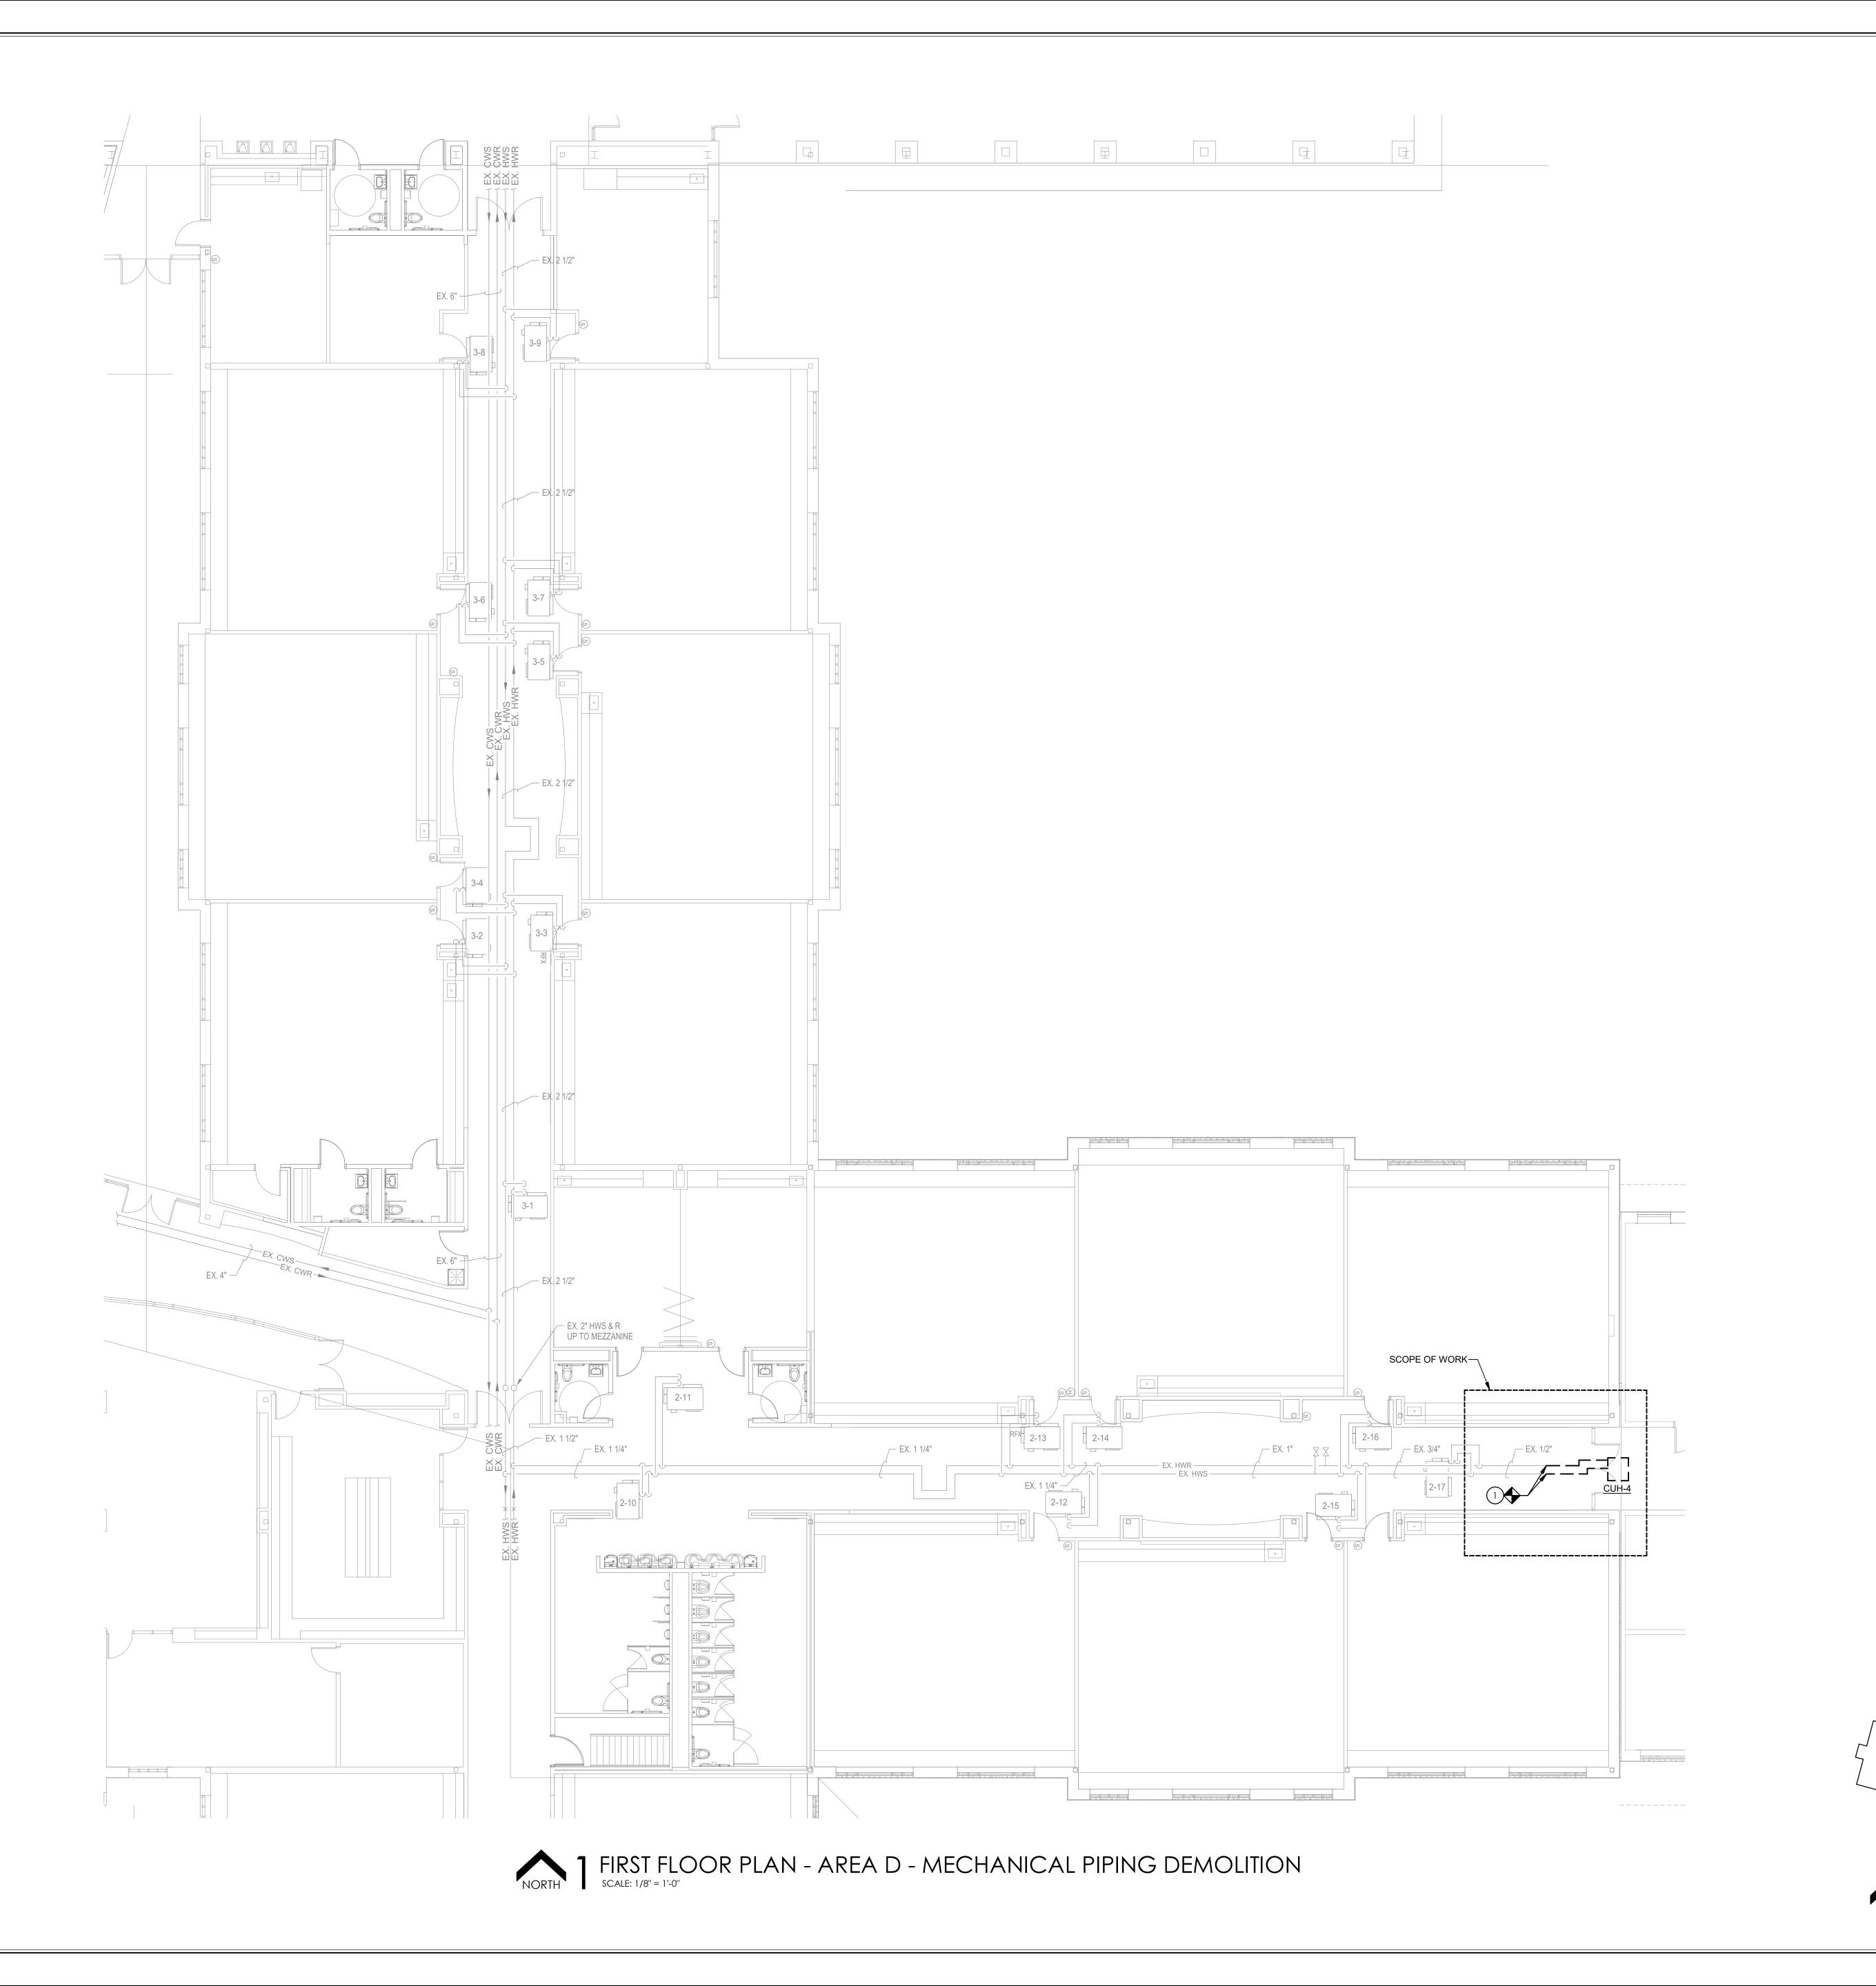

GENERAL NOTES:

G1 FIELD VERIFY EXISTING CONDITIONS AND NOTIFY ENGINEER OF ANY DISCREPANCIES.

1 DEMOLISH CUH-4 AND ASSOCIATED PIPING BACK TO SHUTOFF VAVLES. CAP AND SEAL.

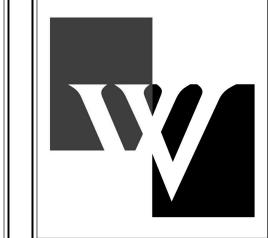

S831 Keystone Crossing, Indianapolis, IN 46240



USSETT NICHOLAS

ASSOCIATES

ENGINEERS + ARCHITECTS

502 South West Street
Indianapolis, Indiana 46225
317.631.9241

5510 Six Forks Road, Suite 270
Raleigh, North Carolina 27609
919.703.4028

Westfield Washington School Corp.
ADDITION & RENOVATIONS TO
AREY RIDGE ELEMENTARY
3231 CAREY ROAD, WESTFIELD, INDIANA 46074

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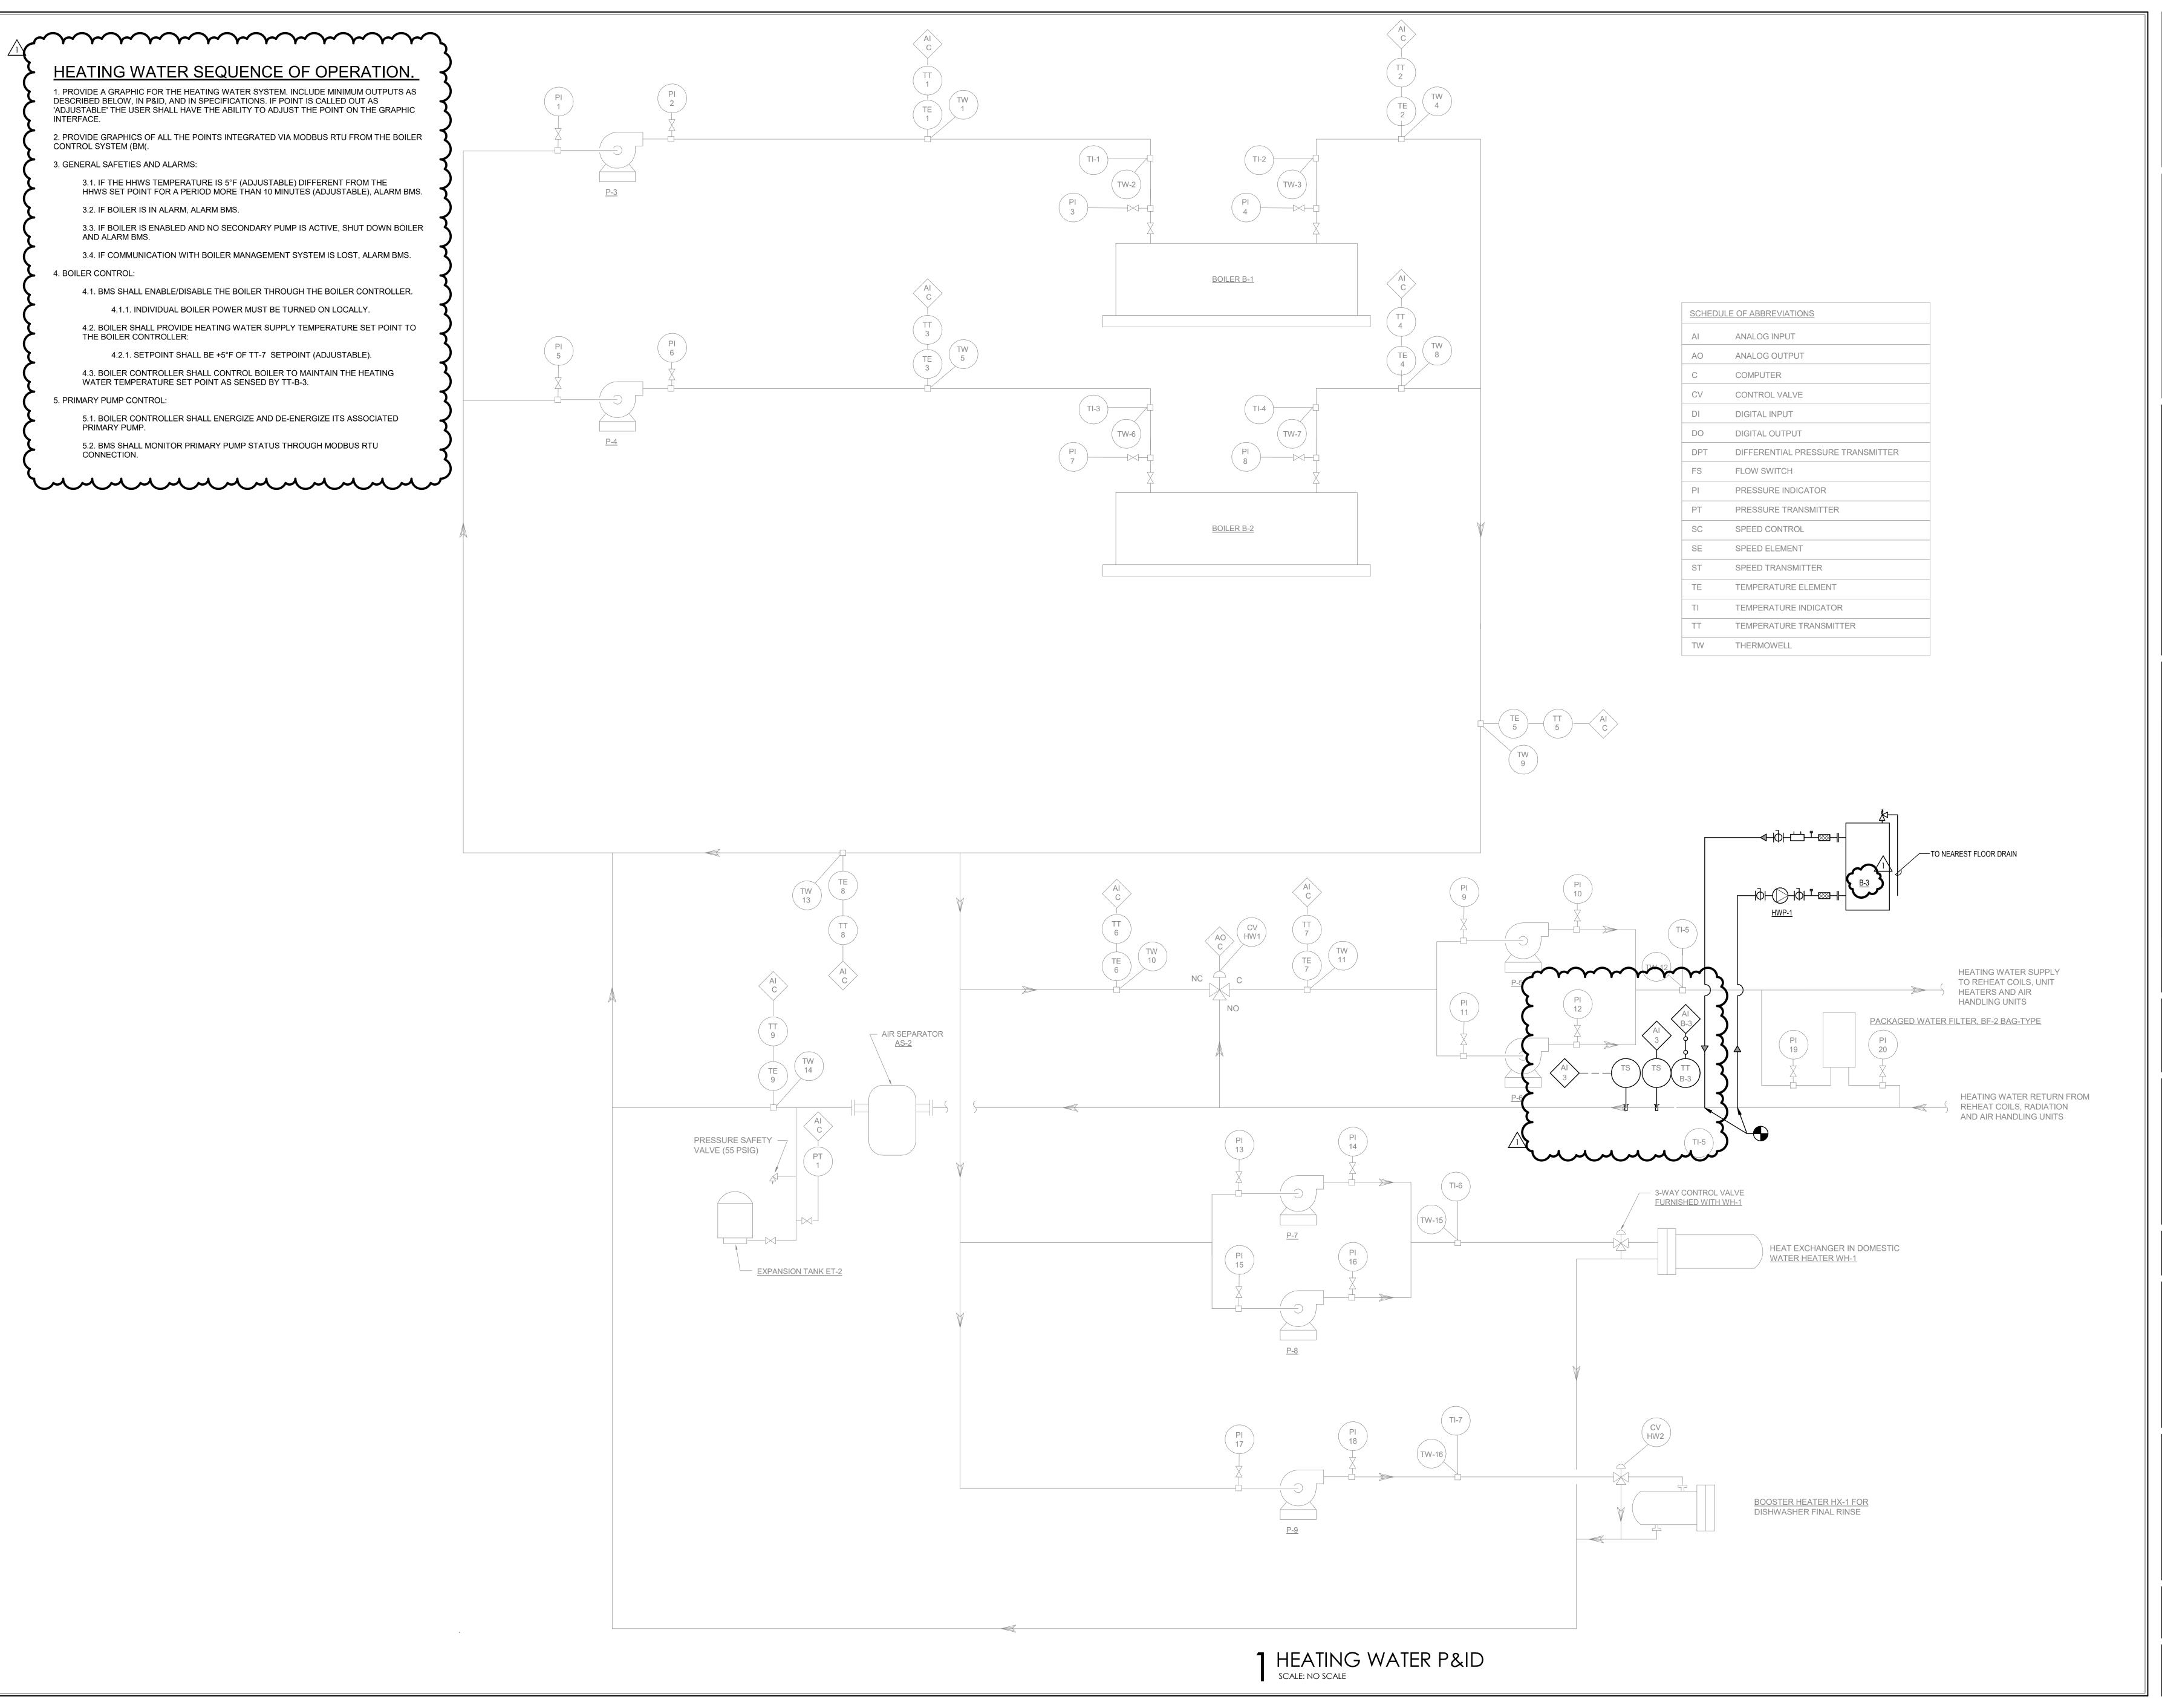
09/30/22 DGF GMS

DRAWING TITLE:

FIRST FLOOR
PLAN - UNIT D MECHANICAL
PIPING
DEMOLITION

CERTIFIED BY:

DRAWING NUMBER





S831 Keystone Crossing, Indianapolis, IN 46240 317.848.7800 | csoinc.net



MUSSETT NICHOLAS

ASSOCIATES

ENGINEERS + ARCHITECTS

502 South West Street
Indianapolis, Indiana 46225
317.631.9241

5510 Six Forks Road, Suite 270
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REVISIONS:
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ISSUE DATE DRAWN BY CHECKED BY
09/30/22 DGF GMS

DRAWING TITLE:
1ECHANICAL
P&IDs

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