ADDENDUM NO. 3

April 11, 2023

WINFIELD ELEMENTARY SCHOOL 2023 ADDITIONS, RENOVATIONS, AND RELATED WORK

Crown Point, IN 46307

TO: ALL BIDDERS OF RECORD

This Addendum forms a part of and modifies the Bidding Requirements, Contract Forms, Contract Conditions, the Specifications, and the Drawings dated March 9, 2023 by Gibraltar Design. Acknowledge receipt of the Addendum in the space provided on the Bid Form. Failure to do so may subject the Bidder to disqualification.

This Addendum consists of Pages ADD 3-1 through 3-2 and attached Addendum No. 3 from Gibraltar Design dated April 11, 2023 and consisting of 4 pages and 26 drawings.

A. SPECIFICATION SECTION 00 31 00 - BID FORM

1. Replace:

Specification Section 00 31 00 - Bid Form with the attached revised Bid Form.

B. SPECIFICATION SECTION 01 12 00 - MULTIPLE CONTRACT SUMMARY

A. BID CATEGORY NO. 1 – GENERAL TRADES/SITEWORK

1. **ADD**:

Clarification No. 24:

The **Bid Category No. 1 Contractor** is responsible for the removal and relocation of the existing pavilion as indicated on construction documents. The **Bid Category No. 10 Contractor** is responsible for the disconnect and reinstallation of the existing electrical within the pavilion.

B. BID CATEGORY NO. 5 – METAL STUDS/DRYWALL/CEILINGS

2. **Delete:**

Clarification No. 6 in its entirety.

C. <u>BID CATEGORY NO. 10 – ELECTRICAL</u>

1. **ADD**:

Clarification No. 12:

The **Bid Category No. 1 Contractor** is responsible for the removal and relocation of the existing pavilion as indicated on construction documents. The **Bid Category No. 10 Contractor** is responsible for the disconnect and reinstallation of the existing electrical within the pavilion.

C. SPECIFICATION SECTION 01 23 00 - ALTERNATES

1. Replace:

E. <u>ALTERNATE NO. 5: State the cost to remove existing chiller and install new chiller including support piping, pumps, electrical, etc. as required to make new chiller function as indicated on drawings. **Base Bid**: Existing Chiller to remain.</u>

1. Delete:

F. ALTERNATE NO. 6 in its entirety.

CONTRACTOR'S BID FOR PUBLIC WORKS FORM NO. 96

Format (Revised 2013) (Amended for CPCSC)

Winfield Elementary School 2023 Additions, Renovations, and Related Work

Crown Point Community School Corporation
Crown Point, IN

PART I

(To be completed for all bids. Please type or print)

	Date (month, day, year):
BIDDER (Firm)	
Address	P.O. Box
City/State/Zip	
Telephone Number:	Email Address:
Person to contact regarding this Bid	
Pursuant to notices given, the undersig complete the public works project of:	gned offers to furnish labor and/or materials necessary to
Insert C	Category No. (s) and Name(s)
	mentary School 2023 Additions, Renovations, and ns and Specifications prepared by Gibraltar Design, Inc., Indianapolis, IN 46260, as follows:
BASE BID	
For the sum of	
	(Sum in words)
	DOLLARS (\$)
	(Sum in figures)
The undersigned acknowledges receip Receipt of Addenda No. (s)	t of the following Addenda:

TSC 220210.12

PROPOSAL TIME

Bidder agrees that this Bid shall remain in force for a period of sixty (60) consecutive calendar days from the due date, and Bids may be accepted or rejected during this period. Bids not accepted within said sixty (60) consecutive calendar days shall be deemed rejected.

Attended pre-bid conference	YES	NO
Has visited the jobsite	YES	NO
The Bidder has reviewed the Guidel Of the schedule can be met.	ine Schedule in Section YES	on 01 32 00 and the intent NO
	-	covers all employees of the bidder who or exceeds the requirements set in IC 4-NO

The undersigned further agrees to furnish a bond or certified check with this Bid for an amount specified in the Notice to Bidders. If Alternate Bids apply, submit a proposal for each in accordance with the Plans and Specifications.

If additional units of material included in the contract are needed, the cost of units must be the same as that shown in the original contract if accepted by the governmental unit. If the bid is to be awarded on a unit bases, the itemization of the units shall be shown on a separate attachment.

The contractor and his subcontractors, if any, shall not discriminate against or intimidate any employee, or applicant for employment, to be employed in the performance of this contract, with respect to any matter directly or indirectly related to employment because of race, religion, color, sex, national origin or ancestry. Breach of this covenant may be regarded as a material breach of the contract.

CERTIFICATION OF USE OF UNITED STATES STEEL PRODUCTS (if applicable)

I, the undersigned bidder, Nor agent as a contractor on a public works project, understand my statutory obligation to use steel products made in the United States (I.C. 5-16-8-2). I hereby certify that I and all subcontractors employed by me for this project will use U.S. steel on this project if awarded. I understand that violations hereunder may result in forfeiture of contractual payments.

ALTERNATE BIDS

A blank entry or an entry of "No Bid", "N/A", or similar entry on any Alternate will cause the bid to be rejected as non-responsive only if that Alternate is selected. If no change in the bid amount is required, indicate "No Change".

<u>MARK "ADD" OR "DEDUCT" FOR EACH ALTERNATE</u>

Alternate Bid No. 1 – New Acoustical Ceiling, Bulkhead, LED Lights, and Technology Modifications

Change the Base Bid the sum of		
-	(sum in words)	4 DD
	DOLLARS (\$)	ADD DEDUCT
	(sum in figures)	BEBGGT
Alternate Bid No. 2 – New Canopies Outside Gy	mnasium A-121	
Change the Base Bid the sum of		
	(sum in words)	A DD
	DOLLARS (\$) (sum in figures)	ADD DEDUCT
Alternate Bid No. 3 – Replace Existing Doors an	nd Frames	
Change the Base Bid the sum of		
	(sum in words)	ADD
	DOLLARS (\$) (sum in figures)	DEDUCT
Alternate Bid No. 4 – Replace Roof Membrane		
Change the Base Bid the sum of		
-	(sum in words)	A DD
	DOLLARS (\$) (sum in figures)	ADD DEDUCT
Alternate Bid No. 5 – Remove Existing Chiller a piping, pumps, electrical, etc.	and Install New Chiller including su	<u>pport</u>
Change the Base Bid the sum of		
Change the Base Bid the sum of	(sum in words)	ADD
	DOLLARS (\$)	DEDUCT
	(sum in figures)	

Alternate Bid No. 6 New 4 Pipe Chilled/Hot Water Ceiling Cassette Fan Coil Units Change the Base Bid the sum of_____ (sum in words) ADD DOLLARS (\$_____) (sum in figures) **DEDUCT** <u>Alternate Bid No. 7 – Chiller Manufactured by Trane</u> Change the Base Bid the sum of_____ (sum in words) ADD _DOLLARS (\$_____) (sum in figures) **DEDUCT** Alternate Bid No. 8 – Roof-Top Units Manufactured by Trane Change the Base Bid the sum of_____ (sum in words) ADD _DOLLARS (\$_____) (sum in figures) **DEDUCT** Alternate Bid No. 9 - Chemical Water Treatment manufactured by Global Water Technology Inc. Change the Base Bid the sum of_____ (sum in words) ADD _DOLLARS (\$_____) (sum in figures) **DEDUCT**

PART II

(For projects of \$150,000 or more – IC 36-1-12-4)

These statements to be submitted under oath by each bidder with and as a part of his bid. (Attach additional pages for each section as needed.)

SECTION I EXPERIENCE QUESTIONNAIRE

1.	What public works projects has your organization completed for the period of one (1)
	year prior to the date of the current bid?

Contract Amount	Class of Work	Completion Date	Name and Address of Owner

2	XX71 41.1:1			C	. 1	
<i>1</i>	What public works	projects are	now in proce	ss of construction	i ny vour	organization /
	" Hat parelle " offic	projects are	mo ,, m proce	DD OI COIIDH GC	10)) 001	or Sami Lation.

Contract Amount	Class of Work	Completion Date	Name and Address of Owner

3.	Have you ever failed to complete any work awarded to you?why?	_If so, where and
4.	List references from private firms for which you have performed work.	

SECTION II PLAN AND EQUIPMENT QUESTIONNAIRE

1.	Explain your plan or layout for performing proposed Work. (Examples could include a narrative of when you could begin, complete the project, number of workers, etc. and any other information which you believe would enable the governmental unit to consider your bid.)
2.	Please list the names and addresses of all subcontractors (i.e. persons or firms outside your own firm who have performed part of the work) that you have used on public works projects during the past five (5) years along with a brief description of the work done by each subcontractor.
3.	If you intend to sublet any portion of the work, state the name and addresses of each subcontractor, equipment to be used by the subcontractor, and whether you will require a bond. However, if you are unable to currently provide a listing, please understand a listing must be provided prior to contract approval. Until the completion of the proposed project, you are under a continuing obligation to immediately notify the governmental unit in the event that you subsequently determine that you will use a subcontractor on the proposed project.

4.	used by subcontractors may also be required to be listed by the governmental unit.
5.	Have you into contracts or received offers for all materials which substantiate the prices used in preparing your proposal? If not, please explain the rationale used which corroborate the process listed.

SECTION III CONTRACTOR'S FINANCIAL STATEMENT

Attachment of Bidder's financial statement is mandatory. Any Bid submitted without said financial statement as required by statute shall thereby be rendered invalid. The financial statement provided hereunder to the governing body awarding the Contract must be specific enough in detail so that said governing body can make a proper determination of the Bidder's capability for completing the Project if awarded.

SECTION IV CONTRACTOR NON-COLLUSION AFFIDAVIT

The undersigned Bidder or agent, being duly sworn on oath, says that he has not, nor has any other member, representative, or agent of the firm, company, corporation or partnership represented by him, entered into any combination, collusion or agreement with any person relative to the price to be bid by anyone at such letting nor to prevent any person from bidding nor to induce anyone to refrain from bidding, and that this Bid is made without reference to any other bid and without any agreement, understanding or combination with any other person in reference to such bidding.

He further says that no person or persons, firms, or corporations has, have, or will receive directly or indirectly, any rebate, fee, gift, commission, or thing of value on account of such contract.

SECTION V OATH AND AFFIRMATION

I HEREBY AFFIRM UNDER THE PENALTIES OF PERJURY THAT THE FACTS AND INFORMATION CONTAINED IN THE FOREGOING BID FOR PUBLIC WORKS ARE TRUE AND CORRECT

Dated at	this	day of	, 20	
			(Name of Organ	ization)
	Ву			
_			(Title of Person	Signing)
	ACKNO	WLEDGEM	ENT	
STATE OF) (33			
COUNTY OF) SS:)			
Before me, a Notary Publi	c, personally appea	ared the abov	e-named	
Swore that the statements	contained in the fo	regoing docu	ment are true and co	orrect.
Subscribed and sworn to b	efore me this	(day of	
(Title)				
Ν	lotary Public			
My Commission Expires:	_			
County of Residence: _				

END OF SECTION 00 31 00





ADDENDUM THREE

Addendum Three (AD.03) to the drawings and specifications prepared by Gibraltar Design for **Winfield Elementary School 2023 Additions, Renovations, and Related Work** for Crown Point Community School Corporation, Crown Point, Indiana.

All Contractors bidding on this project shall read all of the items covered below and shall comply with all of the requirements as set forth, including any necessary refinements or additions generated by this Addendum and required by the intent of the original contract documents. All Contractors shall acknowledge on their bid form that they have received this Addendum, Addendum One and Addendum Two, and include the appropriate content of same within their bid proposal.

QUESTIONS

Question: Drawing MP103 shows two new VRF cassettes which are on the schedule. However, there is no information about the condensers on the schedule. Where are the condensers to be located?

Answer: The VRF cassettes are to be connected to the existing VRF condensing unit system. According to the shop drawings from the previous project, there is a spare port available on the existing refrigerant manifold box.

SPECIFICATIONS

1. Specification Section 04 20 00 Foodservice Equipment

A. Revise Paragraph 2.5.B. to read "B. Concrete Block: Exposed to exterior weather, Mechanical Yard:"

2. Specification Section 11 40 00 Foodservice Equipment

A. Add ITEM #44 to read:

"ITEM #44: Cooking Equipment Water Treatment System

MFGR: Optipure or Approved Equal

MODEL: OP\$175/16

Provide and set-in place one (1) only Cooking Equipment Water Treatment System per plan. Complete with all standard accessories."



DRAWINGS

For each sheet listed in this Addendum, refer to attached full size drawing sheet(s) for revisions, unless noted as (Sheet Not attached).

1. Sheet C-2.0

A. Legend: "C – Concrete Pavement" to be renamed to "Concrete Pad, Refer to Structural"

2. Sheet C-4.0 (Sheet Not Attached)

A. Delete Concrete Pavement detail as new Structural Details override this detail.

3. Sheet S-201

- A. Mechanical screen wall foundations added.
- B. Structural pads at mechanical units added.

4. Sheet S-202

A. New structural pad and detail references added for concrete to accommodate relocated Pavilion structure.

5. Sheet A-201 (Sheet Not Attached)

A. Delete note 8 form the scope of work.

6. Sheet S-402

A. New Section 7-9 added.

7. Sheet A-501

A. New Details added to Sheet, Details #8 and #9.

8. Sheet A-702

- A. Equipment Plan Notes: Add note 4.
- B. Add note 4 to Cafeteria B-107.
- C. Add 2 TVs to Media Center B-118.

9. Sheet A-703

A. Add TV to Room C-125

10. Sheet A-901

- A. Revise Gypsum bulkhead hatch note to refer to detail 1/A-902.
- B. Reflected Ceiling Plan Notes: Note 2 Revise detail callout to be 1/A-901.
- C. Add detail 1/A-901.
- D. Remove corridor mechanical diffusers that were associated with the new fan coil units from the scope of work.

11. Sheet A-902

- A. Revise Gypsum bulkhead hatch note to refer to detail 1/A-902.
- B. Reflected Ceiling Plan Notes: Note 2 Revise detail callout to be 1/A-901.
- C. Add detail 1/A-902.
- D. Remove corridor mechanical diffusers that were associated with the new fan coil units from the scope of work.



12. Sheets A-903 and A-904 (Sheet Not Attached)

- A. Revise Gypsum bulkhead hatch note to refer to detail 1/A-902.
- B. Reflected Ceiling Plan Notes: Note 2 Revise detail callout to be 1/A-901.
- C. Remove corridor mechanical diffusers that were associated with the new fan coil units from the scope of work.

13. Sheet K-101

- A. Add Item #44 Water Treatment System.
- B. Revise floor plan to eliminate 8" build-out at eds of pass thru units.

14. Sheet K-102

- A. Add item wall backing for water treatment system.
- B. Delete Note 1 regarding trim-out around pass thrus.

15. Sheet K-200

A. Add Item #44 Water Treatment System.

16. Sheet K-300

A. Add Item #44 Water Treatment System and tie into combi ovens and ice machine.

17. Sheet K-600 (Sheet Not Attached)

A. Delete detail "I" for frame-out of pass-thrus.

18. Sheet K-601

A. Revise dimensions on Item #14 and Item #17 to match floor plan.

19. Sheets K-602 and K-603

A. Revise counter finishes to be quartz in lieu of solid surface.

20. Sheet MV101 through MV104 (Sheet Not Attached)

A. Remove corridor fan coil units from scope.

21. Sheet MP101 through MP104 (Sheet Not Attached)

A. Remove corridor fan coil units from scope.

22. Sheet M-301 through M-304 (Sheet Not Attached)

A. Remove corridor fan coil units from scope.

23. Sheet M-601 (Sheet Not Attached)

A. Remove corridor fan coil units from scope.

24. Sheet P-001 (Sheet Not Attached)

- A. Revise the water softener to the following:
 - 1. Culligan CTM-300-PF Duplex Softener

Progressive Parallel

195 GPM Total

95 GPM Each Tank

FRP Vessel: 24" Dia x 95"

Brine Tank: 30" dia x 50" high

Equivalents by Culligan, Eco Water, Pelican





25. Sheet PD101 (Sheet Not Attached)

- A. Delete removal of existing well pump and expansion tank associated with well pump from the scope of work.
- B. Delete removal of existing water storage tanks from the scope of work.

26. Sheet ED101 through ED104

A. Added alternate bid scope outlines.

27. Sheet EL103

A. Added alternate bid scope outlines.

28. Sheet EP101 and EP102

- A. See revised sheet for removal of corridor fan coil units from scope.
- B. Added alternate bid scope outlines.

29. Sheet EP103

- A. See revised sheet for removal of corridor fan coil units from scope.
- B. Added alternate bid scope outlines.
- C. Added new pilot light switch.

30. Sheet EP104

- A. See revised sheet for removal of corridor fan coil units from scope.
- B. Added alternate bid scope outlines.


31. Sheet E-601


A. See revised sheet for removal of corridor fan coil units from scope.

Pages 1 through 4, inclusive, and twenty-six (26) Full-Size Drawings, constitute the total makeup of **Addendum Three**.




wn Point CSC - Winfield ES 2013 Additions and Renovations\Specs\Addendum 3\21-110_AD03.doc

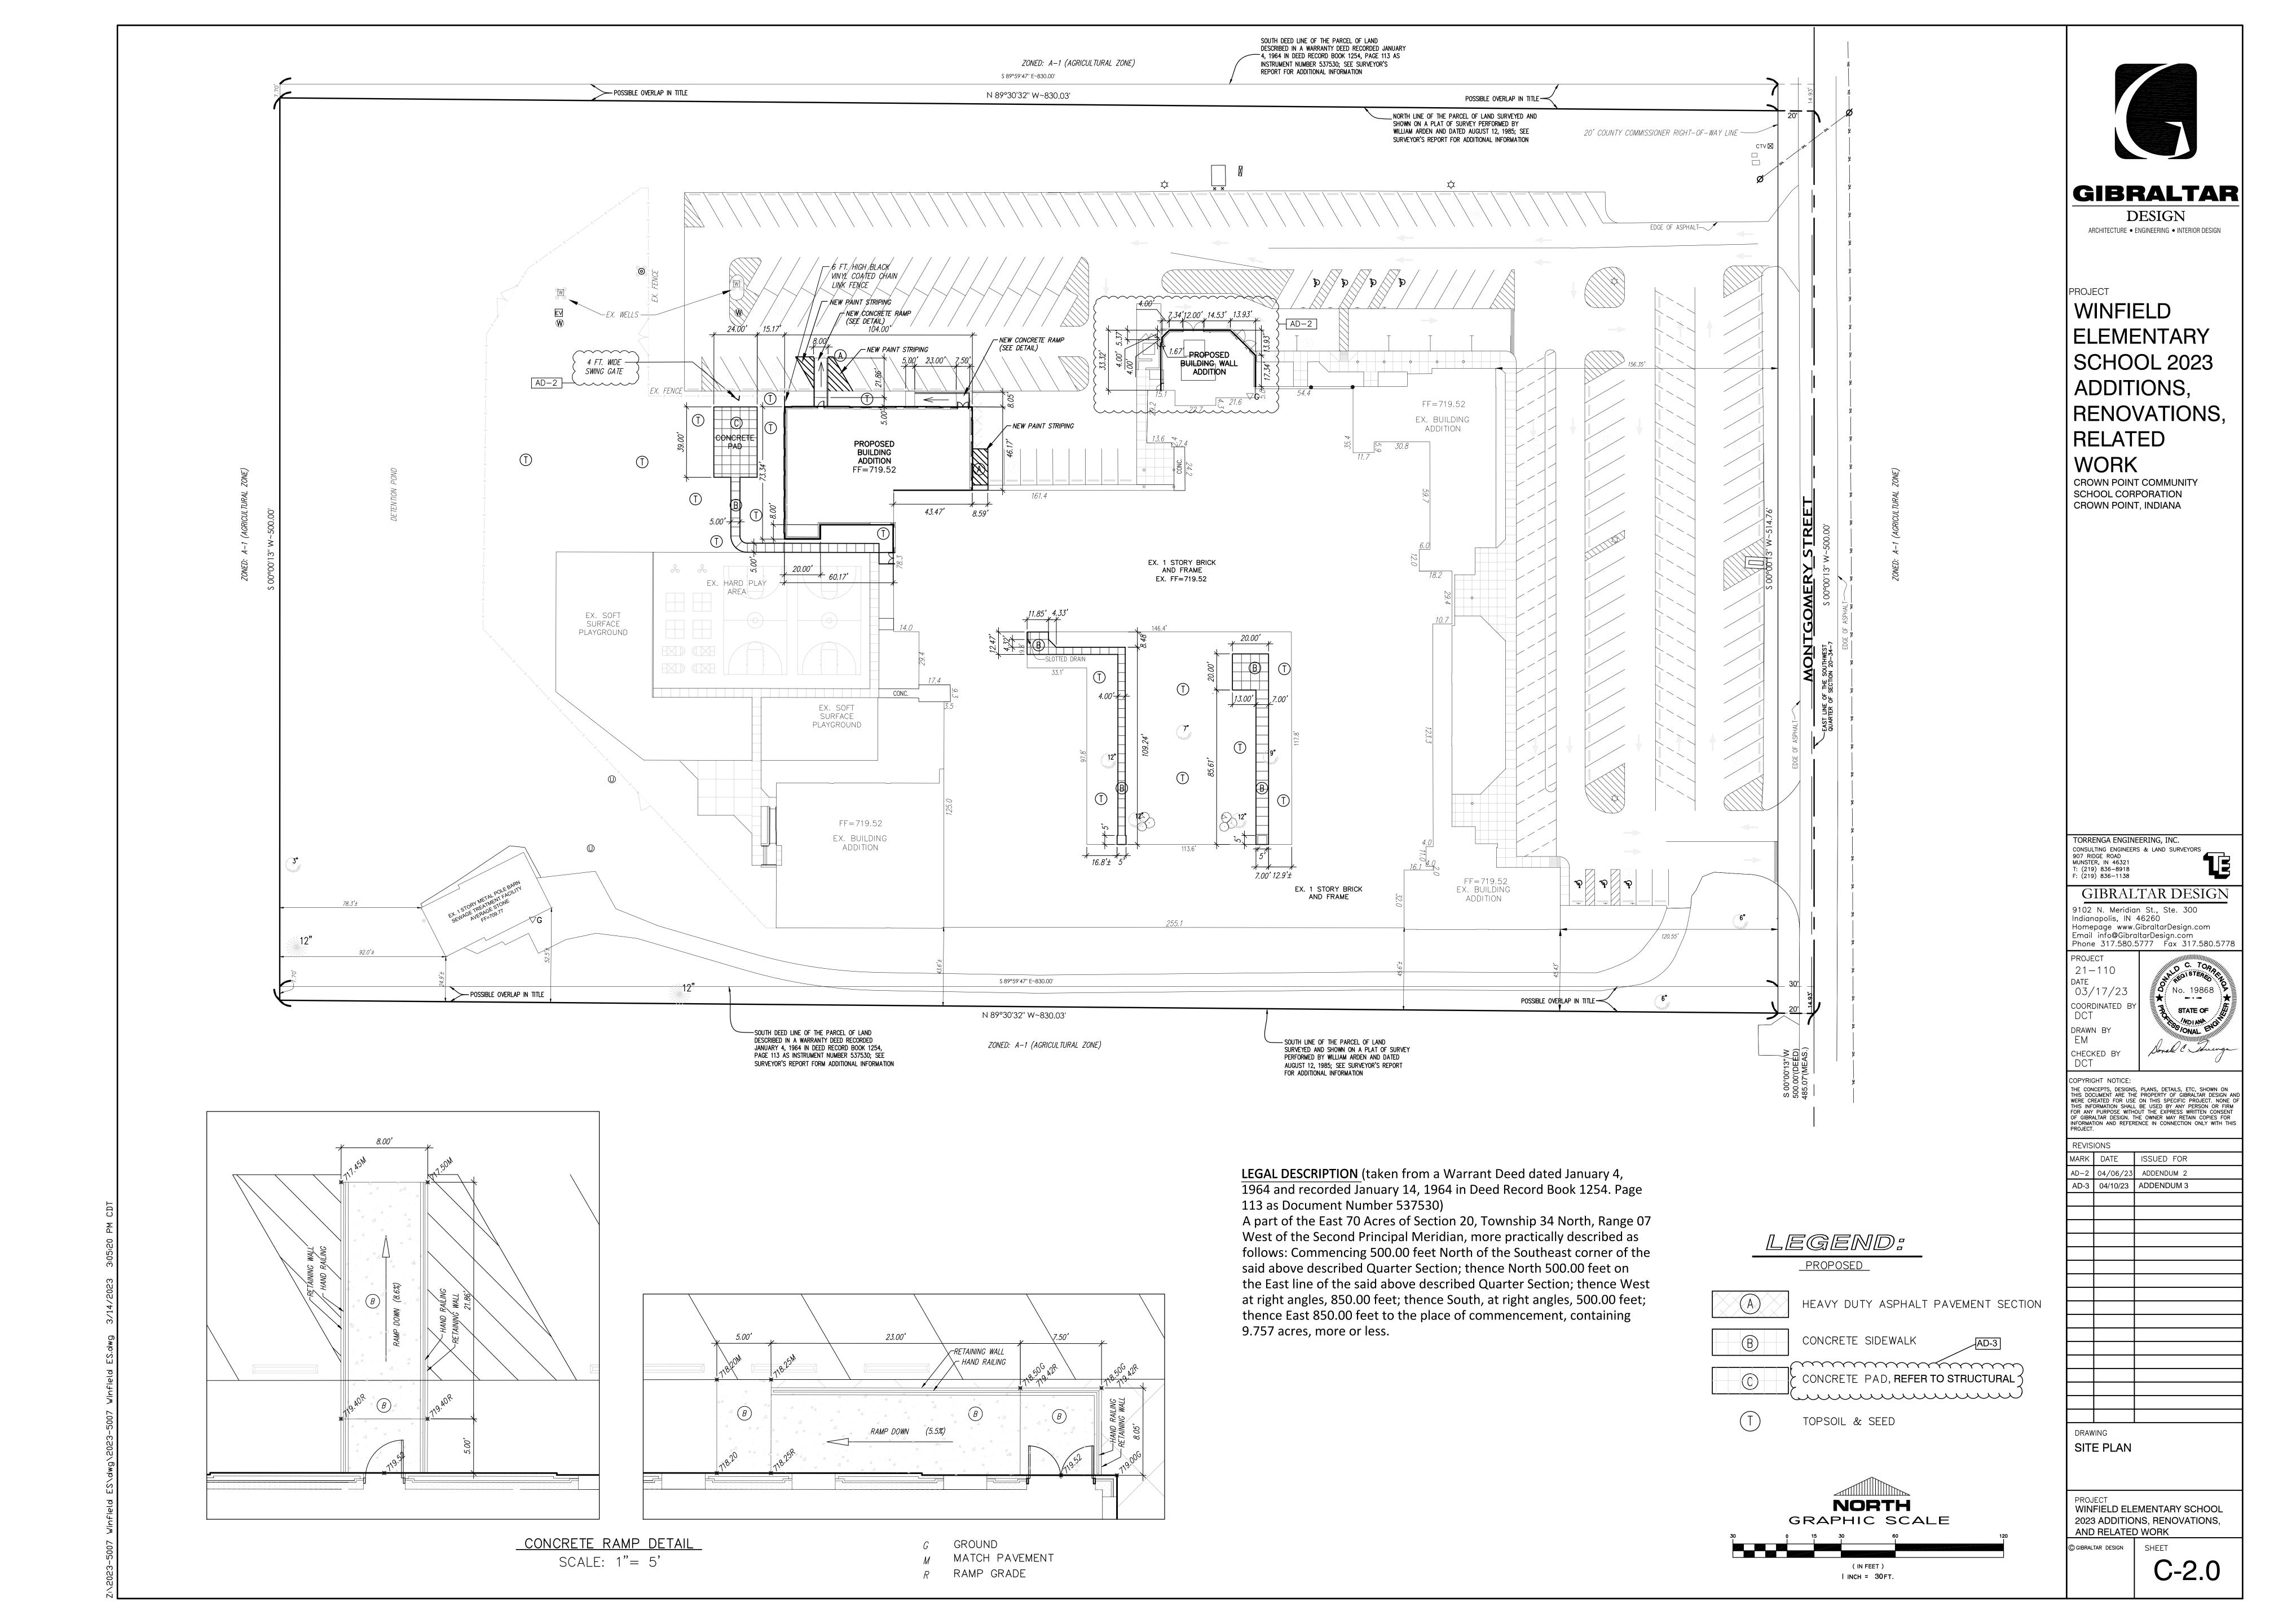

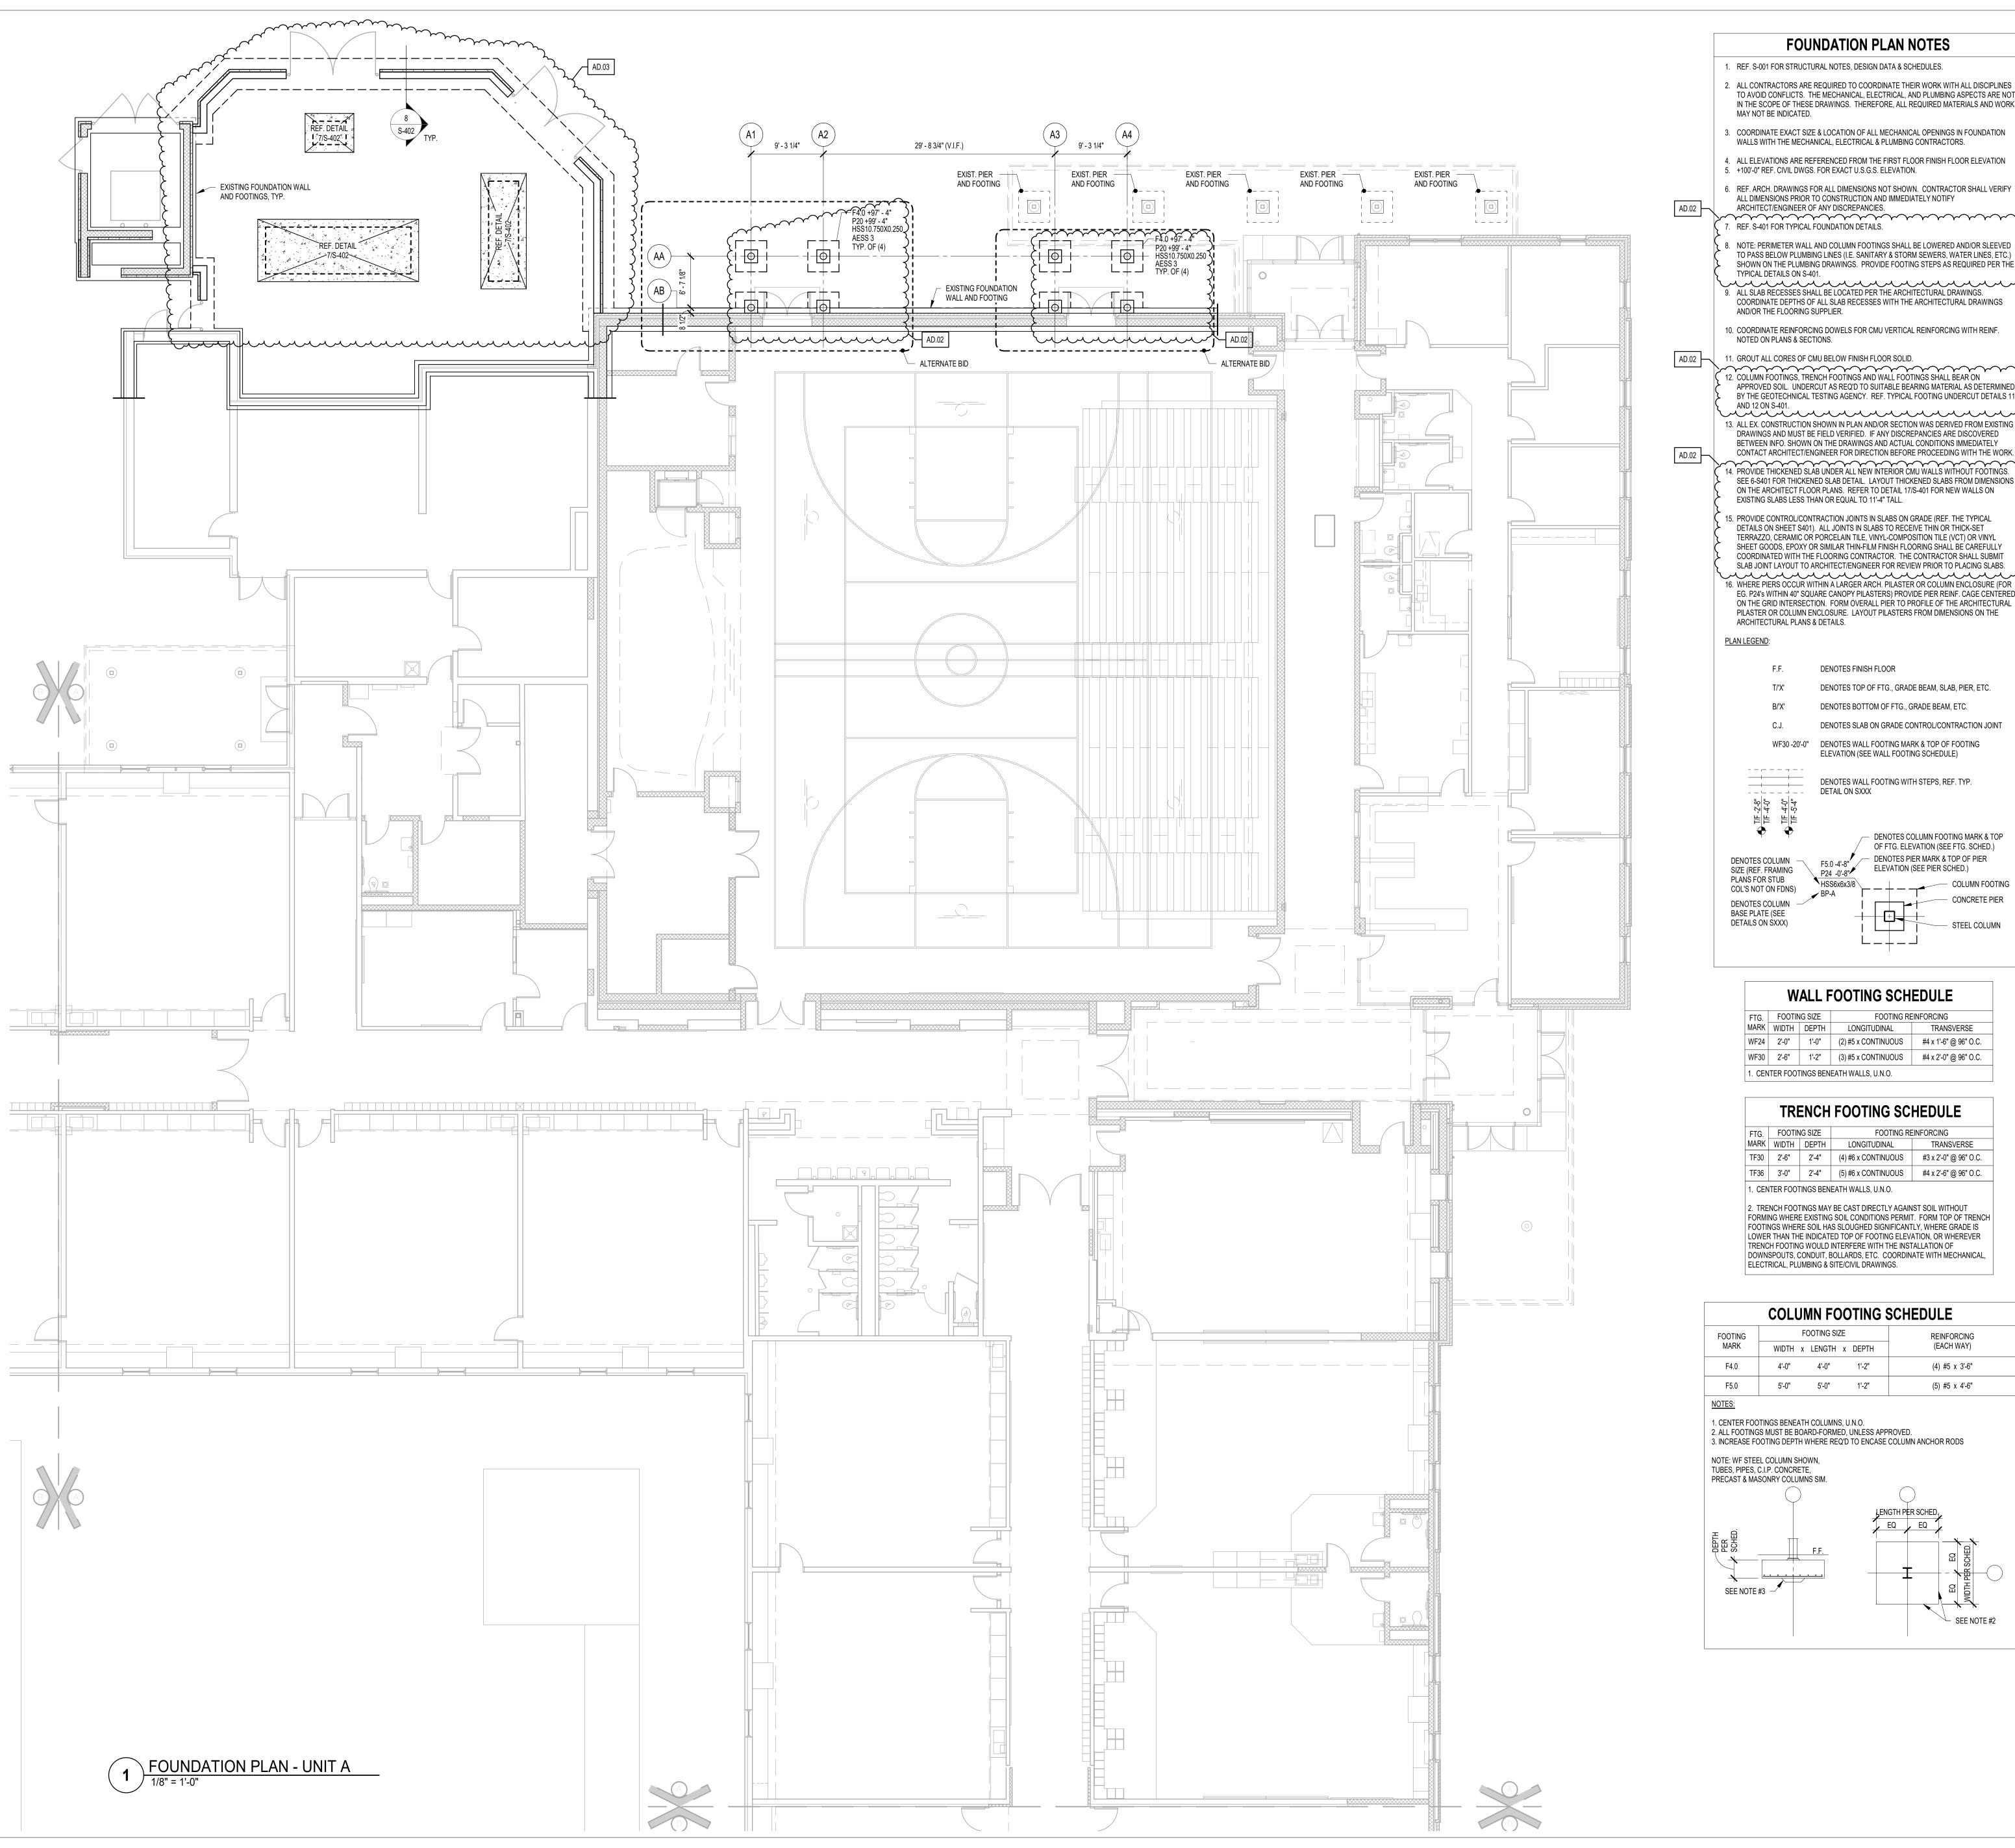

FOUNDATION PLAN NOTES

- 1. REF. S-001 FOR STRUCTURAL NOTES, DESIGN DATA & SCHEDULES.
- 2. ALL CONTRACTORS ARE REQUIRED TO COORDINATE THEIR WORK WITH ALL DISCIPLINES TO AVOID CONFLICTS. THE MECHANICAL, ELECTRICAL, AND PLUMBING ASPECTS ARE NOT IN THE SCOPE OF THESE DRAWINGS. THEREFORE, ALL REQUIRED MATERIALS AND WORK
- 3. COORDINATE EXACT SIZE & LOCATION OF ALL MECHANICAL OPENINGS IN FOUNDATION WALLS WITH THE MECHANICAL, ELECTRICAL & PLUMBING CONTRACTORS.
- 4. ALL ELEVATIONS ARE REFERENCED FROM THE FIRST FLOOR FINISH FLOOR ELEVATION
- 6. REF. ARCH. DRAWINGS FOR ALL DIMENSIONS NOT SHOWN. CONTRACTOR SHALL VERIFY ALL DIMENSIONS PRIOR TO CONSTRUCTION AND IMMEDIATELY NOTIFY ARCHITECT/ENGINEER OF ANY DISCREPANCIES. \cdots
- B. NOTE: PERIMETER WALL AND COLUMN FOOTINGS SHALL BE LOWERED AND/OR SLEEVED TO PASS BELOW PLUMBING LINES (I.E. SANITARY & STORM SEWERS, WATER LINES, ETC.) SHOWN ON THE PLUMBING DRAWINGS. PROVIDE FOOTING STEPS AS REQUIRED PER THE \prec 9. ALL SLAB RECESSES SHALL BE LOCATED PER THE ARCHITECTURAL DRAWINGS.
- COORDINATE DEPTHS OF ALL SLAB RECESSES WITH THE ARCHITECTURAL DRAWINGS
- 12. COLUMN FOOTINGS, TRENCH FOOTINGS AND WALL FOOTINGS SHALL BEAR ON APPROVED SOIL. UNDERCUT AS REQ'D TO SUITABLE BEARING MATERIAL AS DETERMINED
- DRAWINGS AND MUST BE FIELD VERIFIED. IF ANY DISCREPANCIES ARE DISCOVERED BETWEEN INFO. SHOWN ON THE DRAWINGS AND ACTUAL CONDITIONS IMMEDIATELY CONTACT ARCHITECT/ENGINEER FOR DIRECTION BEFORE PROCEEDING WITH THE WORK 14. PROVIDE THICKENED SLAB UNDER ALL NEW INTERIOR CMU WALLS WITHOUT FOOTINGS. SEE 6-S401 FOR THICKENED SLAB DETAIL. LAYOUT THICKENED SLABS FROM DIMENSIONS -ON THE ARCHITECT FLOOR PLANS. REFER TO DETAIL 17/S-401 FOR NEW WALLS ON EXISTING SLABS LESS THAN OR EQUAL TO 11'-4" TALL.
- DETAILS ON SHEET S401). ALL JOINTS IN SLABS TO RECEIVE THIN OR THICK-SET TERRAZZO, CERAMIC OR PORCELAIN TILE, VINYL-COMPOSITION TILE (VCT) OR VINYL SHEET GOODS, EPOXY OR SIMILAR THIN-FILM FINISH FLOORING SHALL BE CAREFULLY COORDINATED WITH THE FLOORING CONTRACTOR. THE CONTRACTOR SHALL SUBMIT SLAB JOINT LAYOUT TO ARCHITECT/ENGINEER FOR REVIEW PRIOR TO PLACING SLABS. 16. WHERE PIERS OCCUR WITHIN A LARGER ARCH. PILASTER OR COLUMN ENCLOSURE (FOR EG. P24's WITHIN 40" SQUARE CANOPY PILASTERS) PROVIDE PIER REINF. CAGE CENTERED
 - DENOTES FINISH FLOOR DENOTES TOP OF FTG., GRADE BEAM, SLAB, PIER, ETC. DENOTES BOTTOM OF FTG., GRADE BEAM, ETC.
 - WF30 -20'-0" DENOTES WALL FOOTING MARK & TOP OF FOOTING ELEVATION (SEE WALL FOOTING SCHEDULE)
- DENOTES WALL FOOTING WITH STEPS, REF. TYP. DETAIL ON SXXX

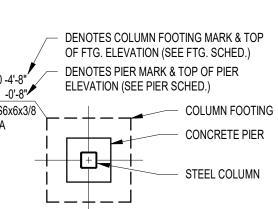

WALL FOOTING SCHEDULE

FTG. FOOTING SIZE		IG SIZE	FOOTING REINFORCING		
MARK	WIDTH	DEPTH	LONGITUDINAL	TRANSVERSE	
WF24	2'-0"	1'-0"	(2) #5 x CONTINUOUS	#4 x 1'-6" @ 96" O.	
WF30	2'-6"	1'-2"	(3) #5 x CONTINUOUS	#4 x 2'-0" @ 96" O.	
1 CFN	ITER FOOT	TINGS BEN	FATH WALLS LINO		

TRENCH FOOTING SCHEDULE


FTG.	FOOTIN	IG SIZE	FOOTING REINFORCING								
MARK	WIDTH	DEPTH	LONGITUDINAL	TRANSVERSE							
TF30	2'-6"	2'-4"	(4) #6 x CONTINUOUS	#3 x 2'-0" @ 96" O.C.							
TF36	3'-0"	2'-4"	(5) #6 x CONTINUOUS	#4 x 2'-6" @ 96" O.C.							
1 CEN	ITED EAA1	LINICS DEN	EATH WALLS IIN O								

2. TRENCH FOOTINGS MAY BE CAST DIRECTLY AGAINST SOIL WITHOUT FORMING WHERE EXISTING SOIL CONDITIONS PERMIT. FORM TOP OF TRENCH FOOTINGS WHERE SOIL HAS SLOUGHED SIGNIFICANTLY, WHERE GRADE IS LOWER THAN THE INDICATED TOP OF FOOTING ELEVATION, OR WHEREVER TRENCH FOOTING WOULD INTERFERE WITH THE INSTALLATION OF DOWNSPOUTS, CONDUIT, BOLLARDS, ETC. COORDINATE WITH MECHANICAL,

COLUMN FOOTING SCHEDULE

	COLUMIN I OOTING SCIILDULL												
FOOTING	F	OOTING SIZ	Έ	REINFORCING									
MARK	WIDTH x	LENGTH	x DEPTH	(EACH WAY)									
F4.0	4'-0"	4'-0"	1'-2"	(4) #5 x 3'-6"									
F5.0	5'-0"	5'-0"	1'-2"	(5) #5 x 4'-6"									

1. CENTER FOOTINGS BENEATH COLUMNS, U.N.O. 2. ALL FOOTINGS MUST BE BOARD-FORMED, UNLESS APPROVED. 3. INCREASE FOOTING DEPTH WHERE REQ'D TO ENCASE COLUMN ANCHOR RODS

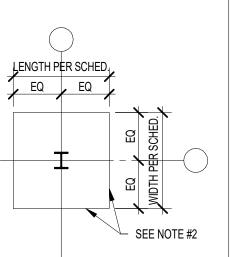




GIBRALTAR DESIGN

ARCHITECTURE • ENGINEERING • INTERIOR DESIGN

PROJECT

WINFIELD **ELEMENTARY SCHOOL 2023** ADDITIONS, RENOVATIONS, **AND RELATED** WORK


CROWN POINT COMMUNITY SCHOOL CORPORATION CROWN POINT, INDIANA

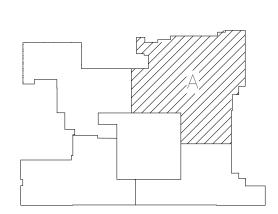

FIRST FLOOR KEY PLAN

GIBRALTAR DESIGN 9102 N. Meridian St., Ste. 300 Indianapolis, IN 46260 | Homepage www.GibraltarDesign.com Email info@GibraltarDesign.com

Phone 317.580.5777 Fax 317.580.5778 21-110 DATE 03/16/23

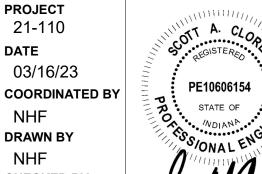

THE CONCEPTS, DESIGNS, PLANS, DETAILS, ETC, SHOWN ON THIS DOCUMENT ARE THE PROPERTY OF GIBRALTAR DESIGN AND WERE CREATED FOR USE ON THIS SPECIFIC PROJECT. NONE OF THIS INFORMATION SHALL BE USED BY ANY PERSON OR FIRM FOR ANY PURPOSE WITHOUT THE EXPRESS WRITTEN CONSENT OF GIBRALTAR DESIGN. THE OWNER MAY RETAIN COPIES FOR INFORMATION AND REFERENCE IN CONNECTION ONLY WITH THIS PROJECT.

DRAWN BY


CHECKED BY

S	SIONS											
(DATE	ISSUED FOR										
	04/06/23	ADDENDUM 2										
	04/10/23	ADDENDUM 3										
_												
_												
		I control of the cont										

DRAWING FOUNDATION PLAN - UNIT A

PROJECT WINFIELD ELEMENTARY SCHOOL 2023 ADDITIONS, RENOVATIONS,

AND RELATED WORK

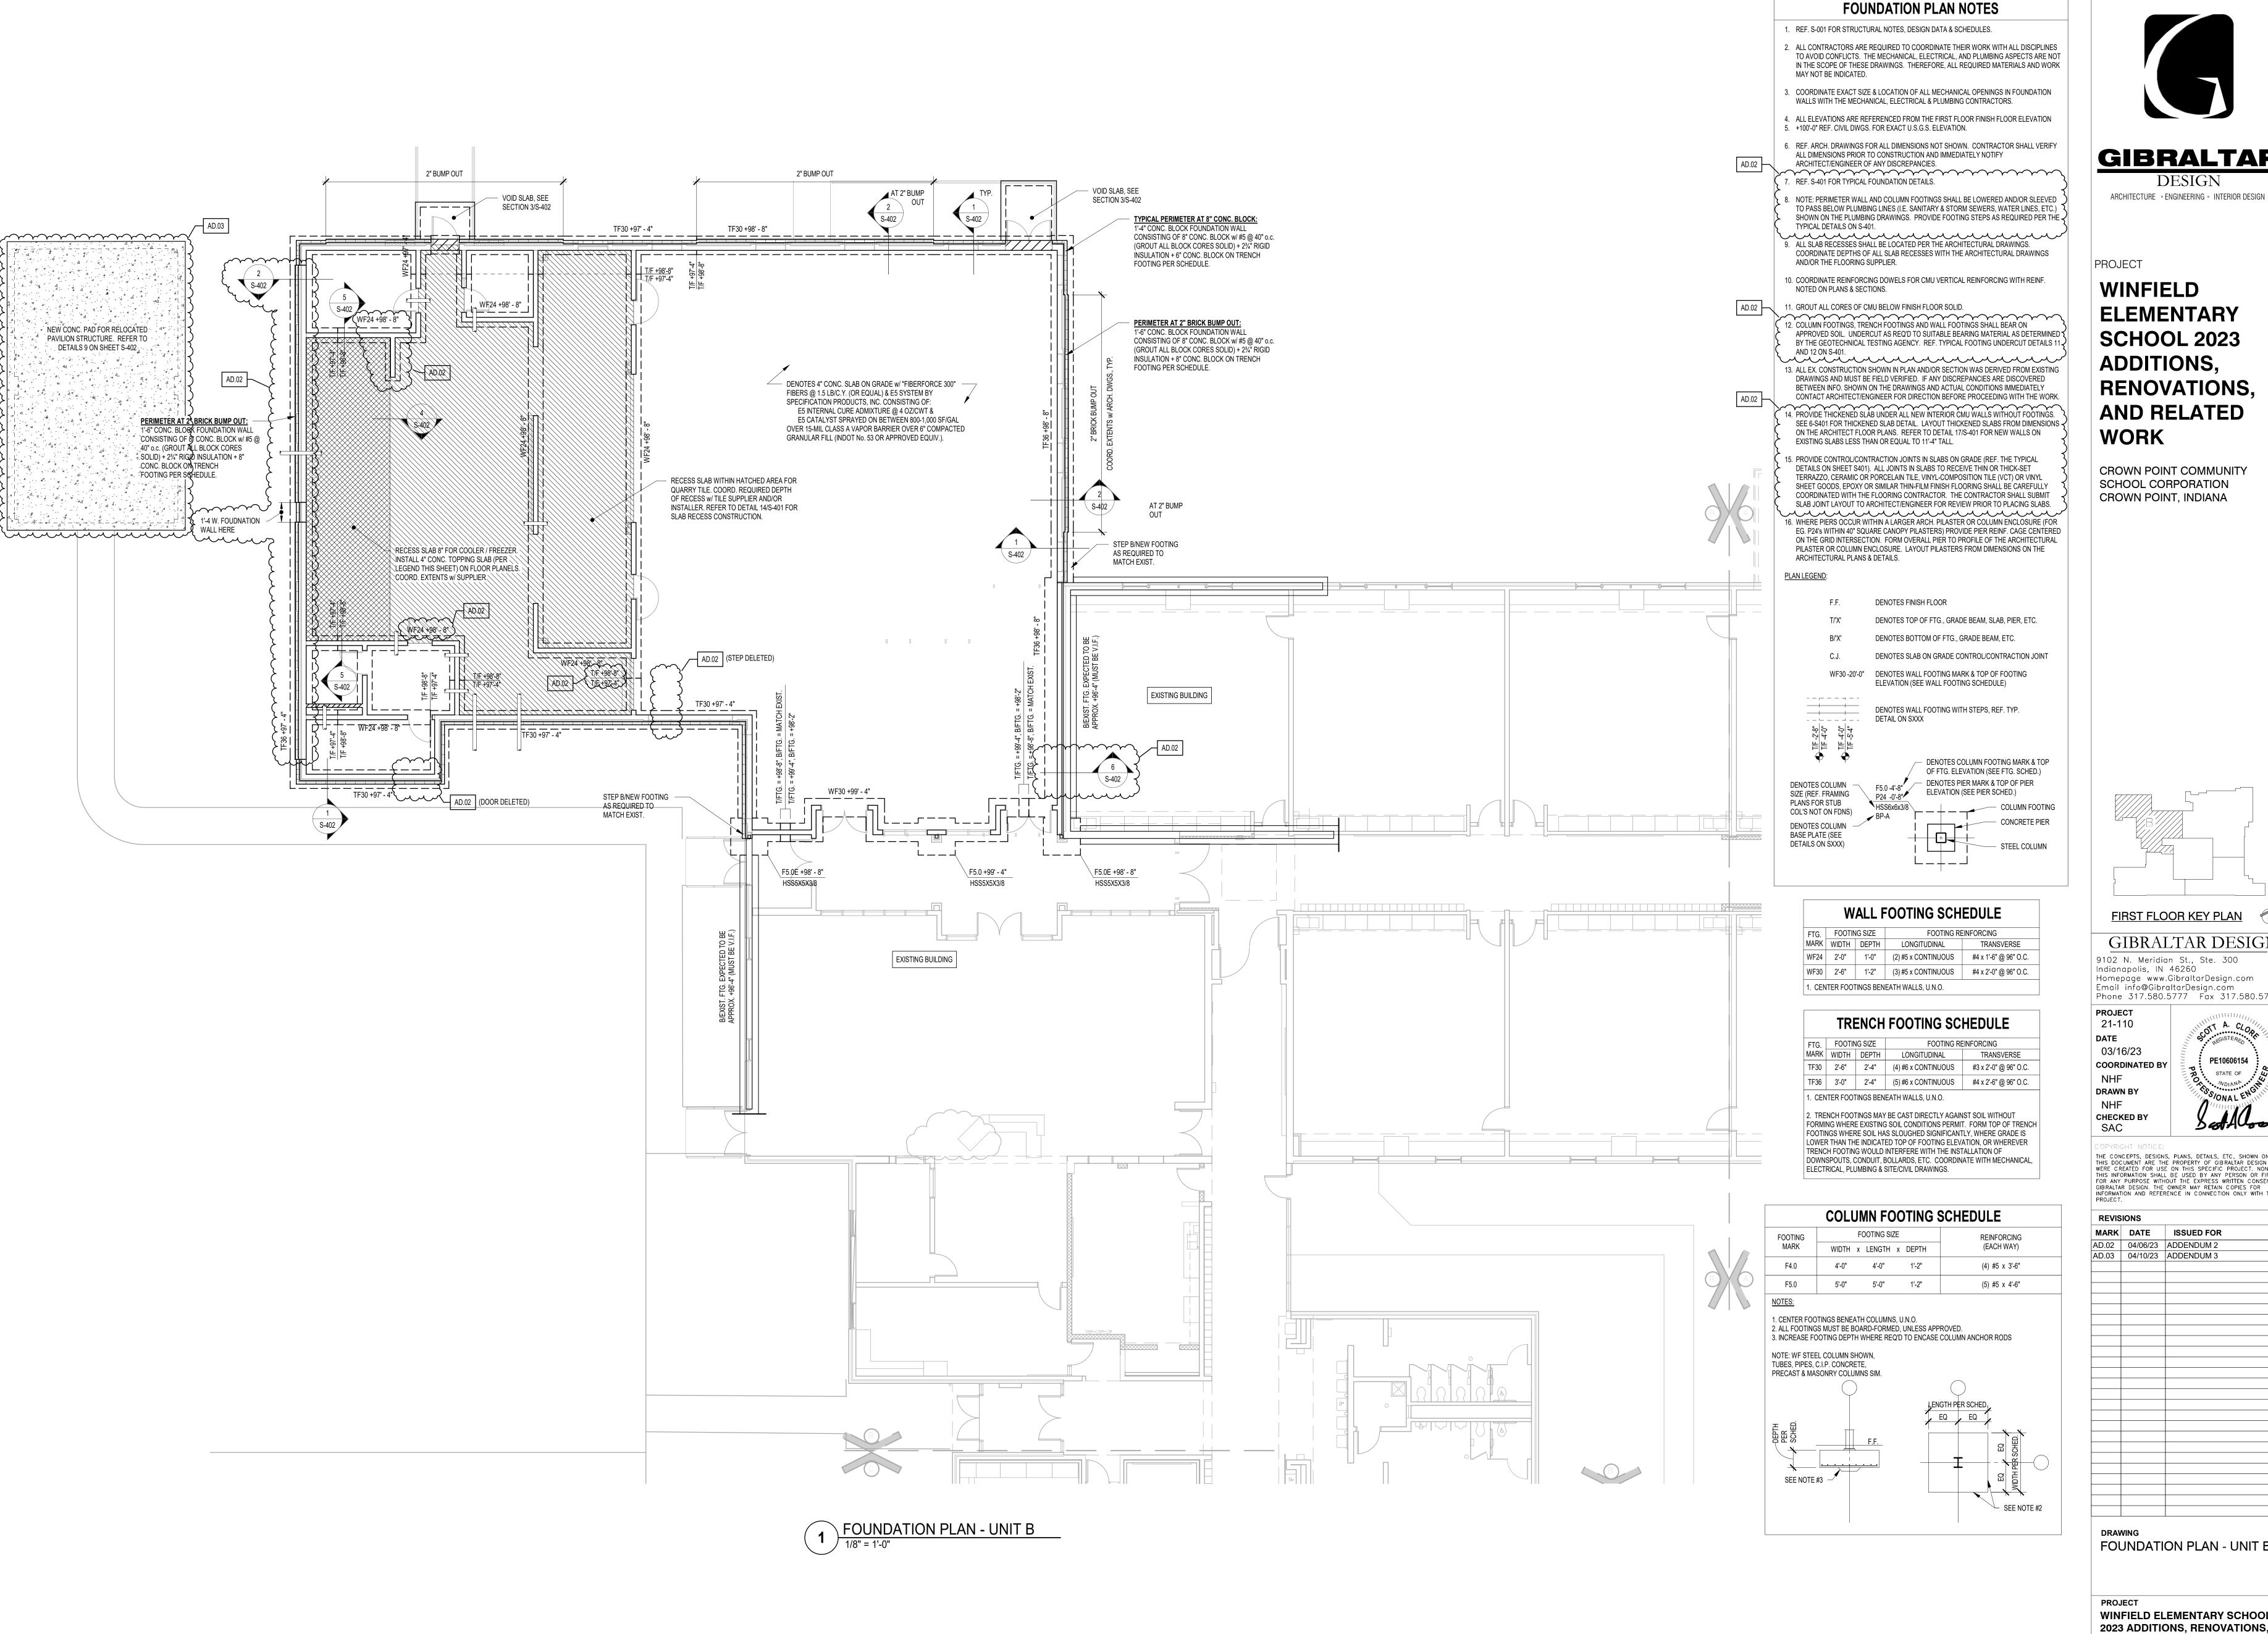




GIBRALTAR

DESIGN

WINFIELD **ELEMENTARY SCHOOL 2023** ADDITIONS, RENOVATIONS, **AND RELATED** WORK

CROWN POINT COMMUNITY SCHOOL CORPORATION CROWN POINT, INDIANA

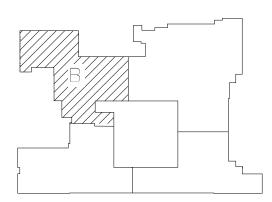


FIRST FLOOR KEY PLAN

GIBRALTAR DESIGN 9102 N. Meridian St., Ste. 300 Indianapolis, IN 46260 Homepage www.GibraltarDesign.com

Phone 317.580.5777 Fax 317.580.5778

03/16/23 **COORDINATED BY DRAWN BY**

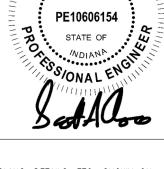


THE CONCEPTS, DESIGNS, PLANS, DETAILS, ETC, SHOWN ON THIS DOCUMENT ARE THE PROPERTY OF GIBRALTAR DESIGN AND WERE CREATED FOR USE ON THIS SPECIFIC PROJECT. NONE OF THIS INFORMATION SHALL BE USED BY ANY PERSON OR FIRM FOR ANY PURPOSE WITHOUT THE EXPRESS WRITTEN CONSENT OF GIBRALTAR DESIGN. THE OWNER MAY RETAIN COPIES FOR INFORMATION AND PREFERENCE IN CONNECTION ONLY WITH THIS INFORMATION AND REFERENCE IN CONNECTION ONLY WITH THIS

REVISIONS MARK DATE ISSUED FOR AD.02 04/06/23 ADDENDUM 2 AD.03 | 04/10/23 | ADDENDUM 3

DRAWING FOUNDATION PLAN - UNIT B

PROJECT WINFIELD ELEMENTARY SCHOOL 2023 ADDITIONS, RENOVATIONS.

AND RELATED WORK

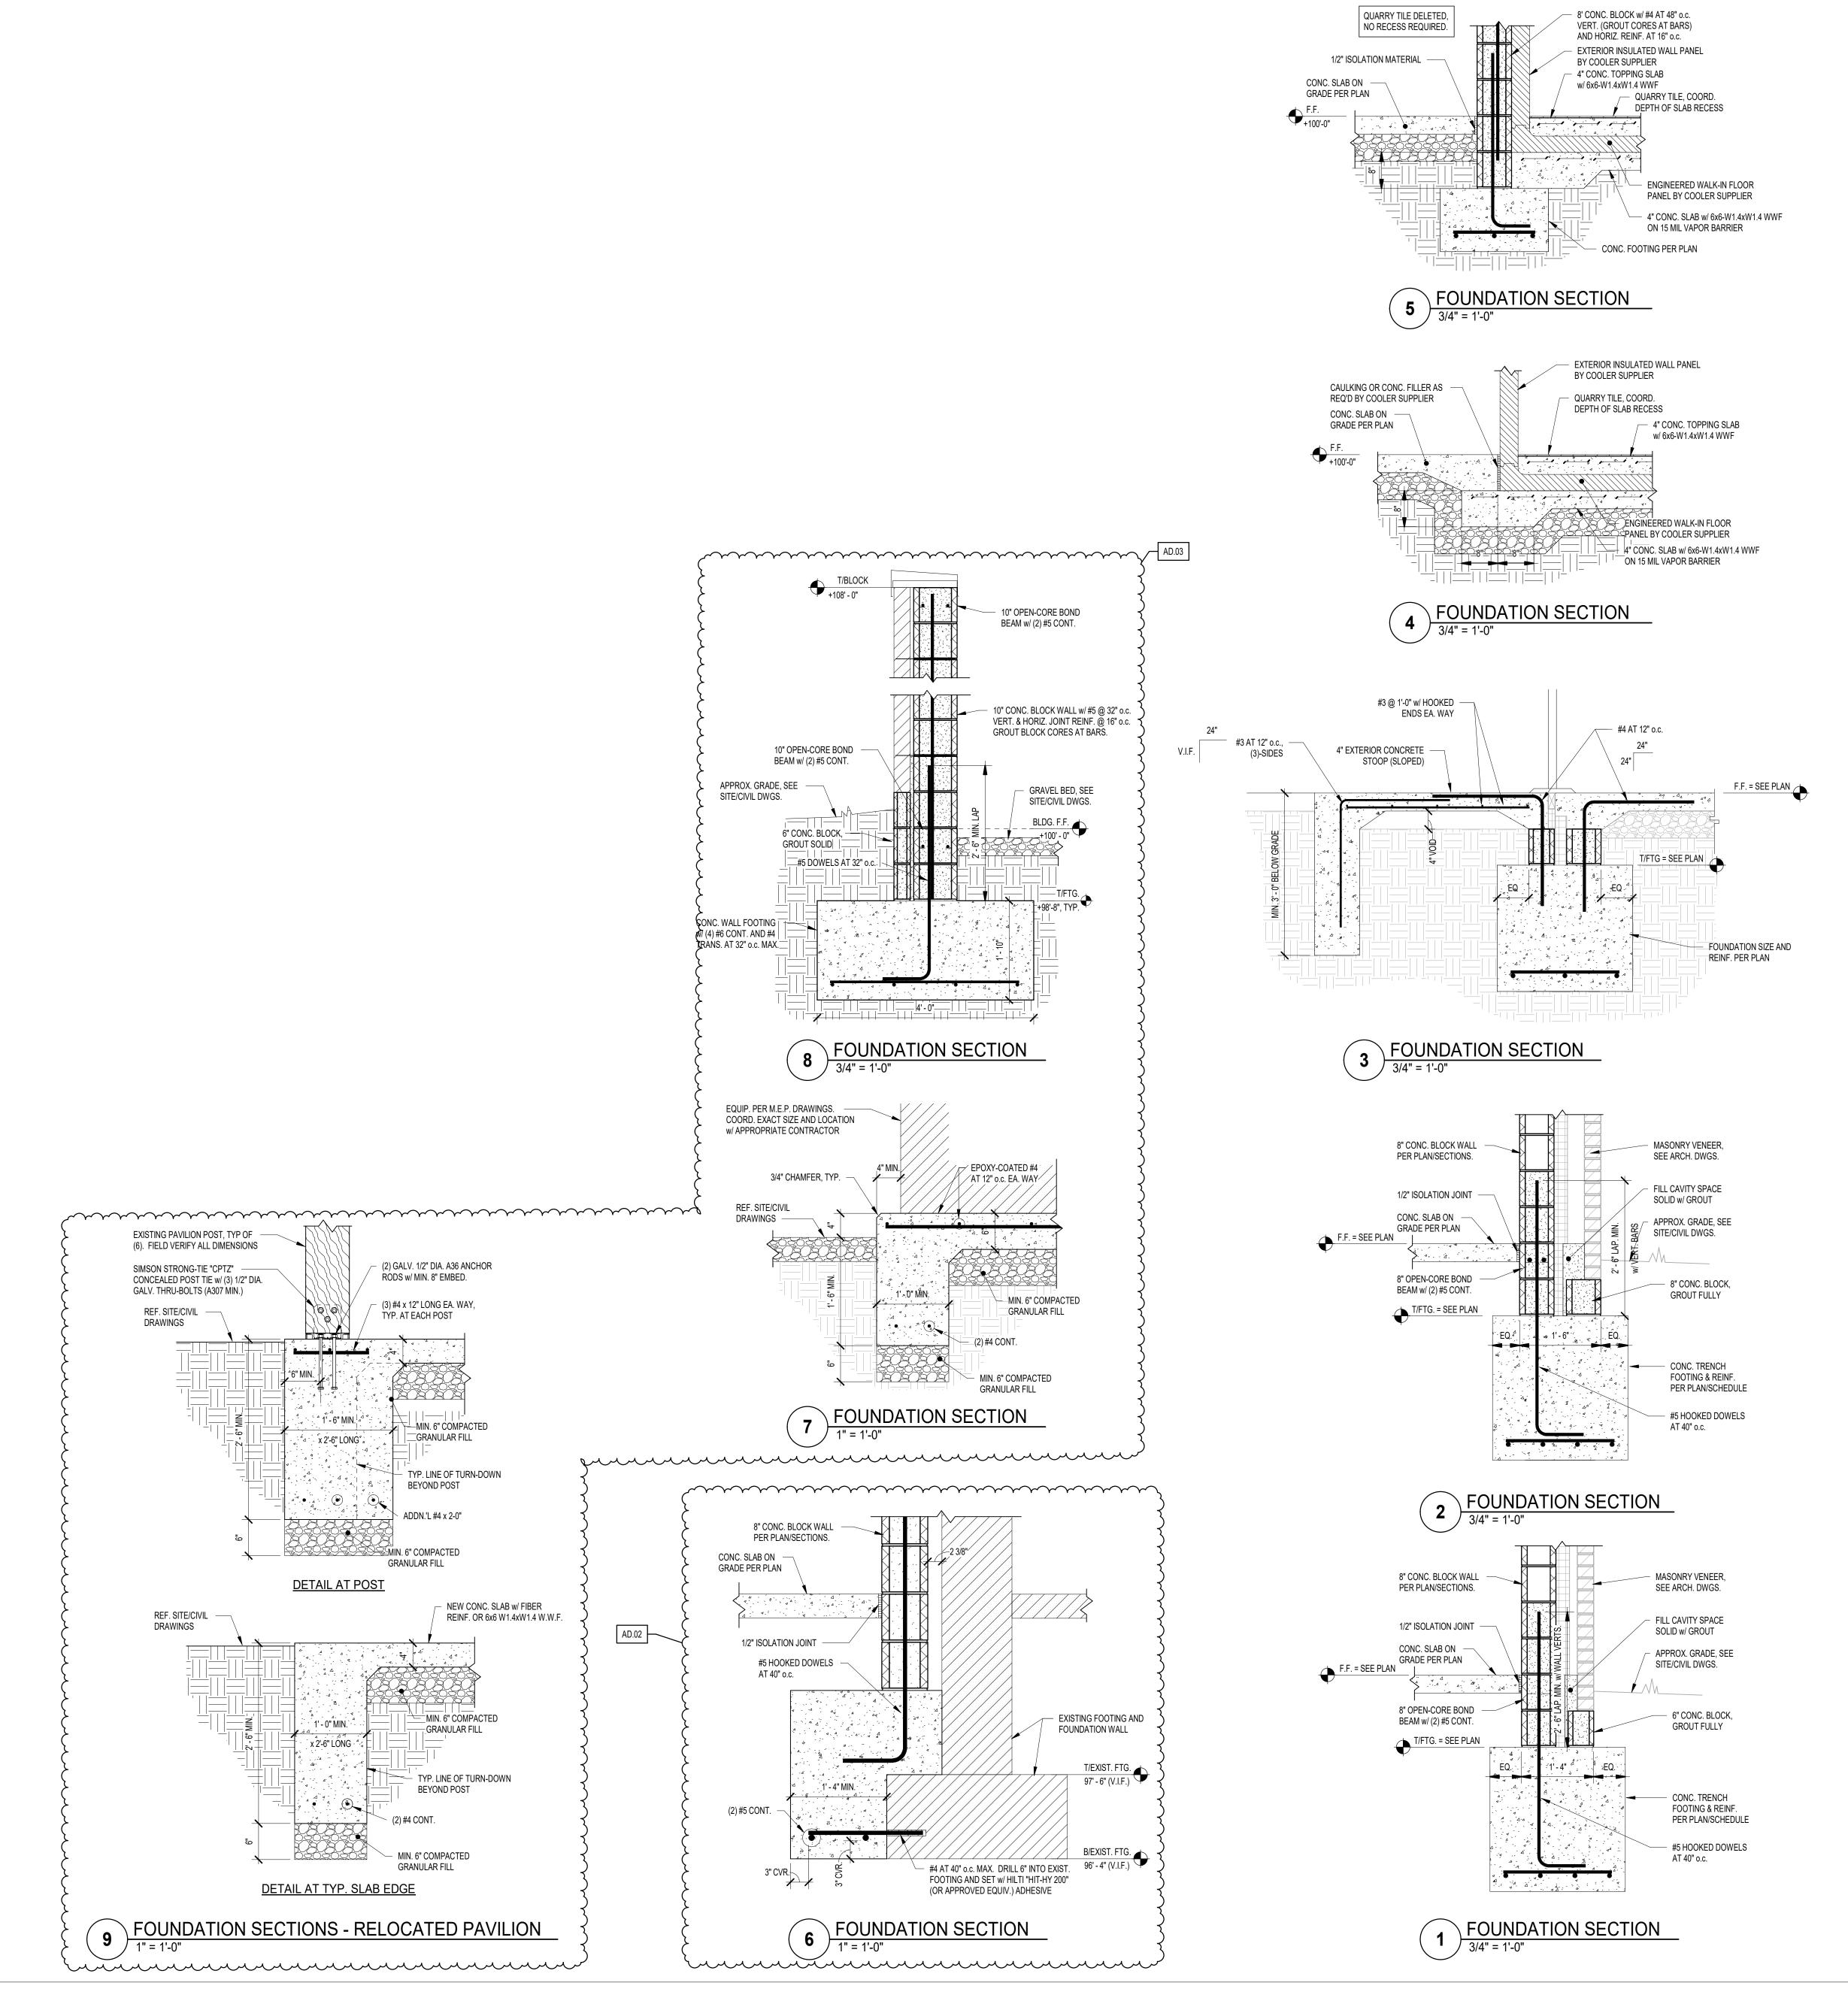



GIBRALTAR DESIGN

ARCHITECTURE • ENGINEERING • INTERIOR DESIGN

PROJECT


WINFIELD
ELEMENTARY
SCHOOL 2023
ADDITIONS,
RENOVATIONS,
AND RELATED
WORK

CROWN POINT COMMUNITY SCHOOL CORPORATION CROWN POINT, INDIANA

GIBRALTAR DESIGN
9102 N. Meridian St., Ste. 300
Indianapolis, IN 46260
Homepage www.GibraltarDesign.com
Email info@GibraltarDesign.com
Phone 317.580.5777 Fax 317.580.5778

PROJECT

21-110
DATE
03/16/23
COORDINATED BY
NHF
DRAWN BY
NHF
CHECKED BY

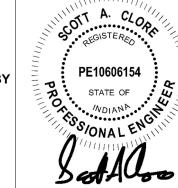

THE CONCEPTS, DESIGNS, PLANS, DETAILS, ETC, SHOWN ON THIS DOCUMENT ARE THE PROPERTY OF GIBRALTAR DESIGN AND WERE CREATED FOR USE ON THIS SPECIFIC PROJECT. NONE OF THIS INFORMATION SHALL BE USED BY ANY PERSON OR FIRM FOR ANY PURPOSE WITHOUT THE EXPRESS WRITTEN CONSENT OF GIBRALTAR DESIGN. THE OWNER MAY RETAIN COPIES FOR INFORMATION AND REFERENCE IN CONNECTION ONLY WITH THIS PROJECT.

REVISIONS

MARK DATE ISSUED FOR

AD.02 04/06/23 ADDENDUM 2

AD.03 04/10/23 ADDENDUM 3


AD.02	04/06/23	ADDENDUM 2
AD.03	04/10/23	ADDENDUM 3
DRAN	_	DAL FOLINDATION

STRUCTURAL FOUNDATION
SECTIONS


PROJECT
WINFIELD ELEMENTARY SCHOOL
2023 ADDITIONS, RENOVATIONS,
AND RELATED WORK

© GIBRALTAR DESIGN SHEET

S-402

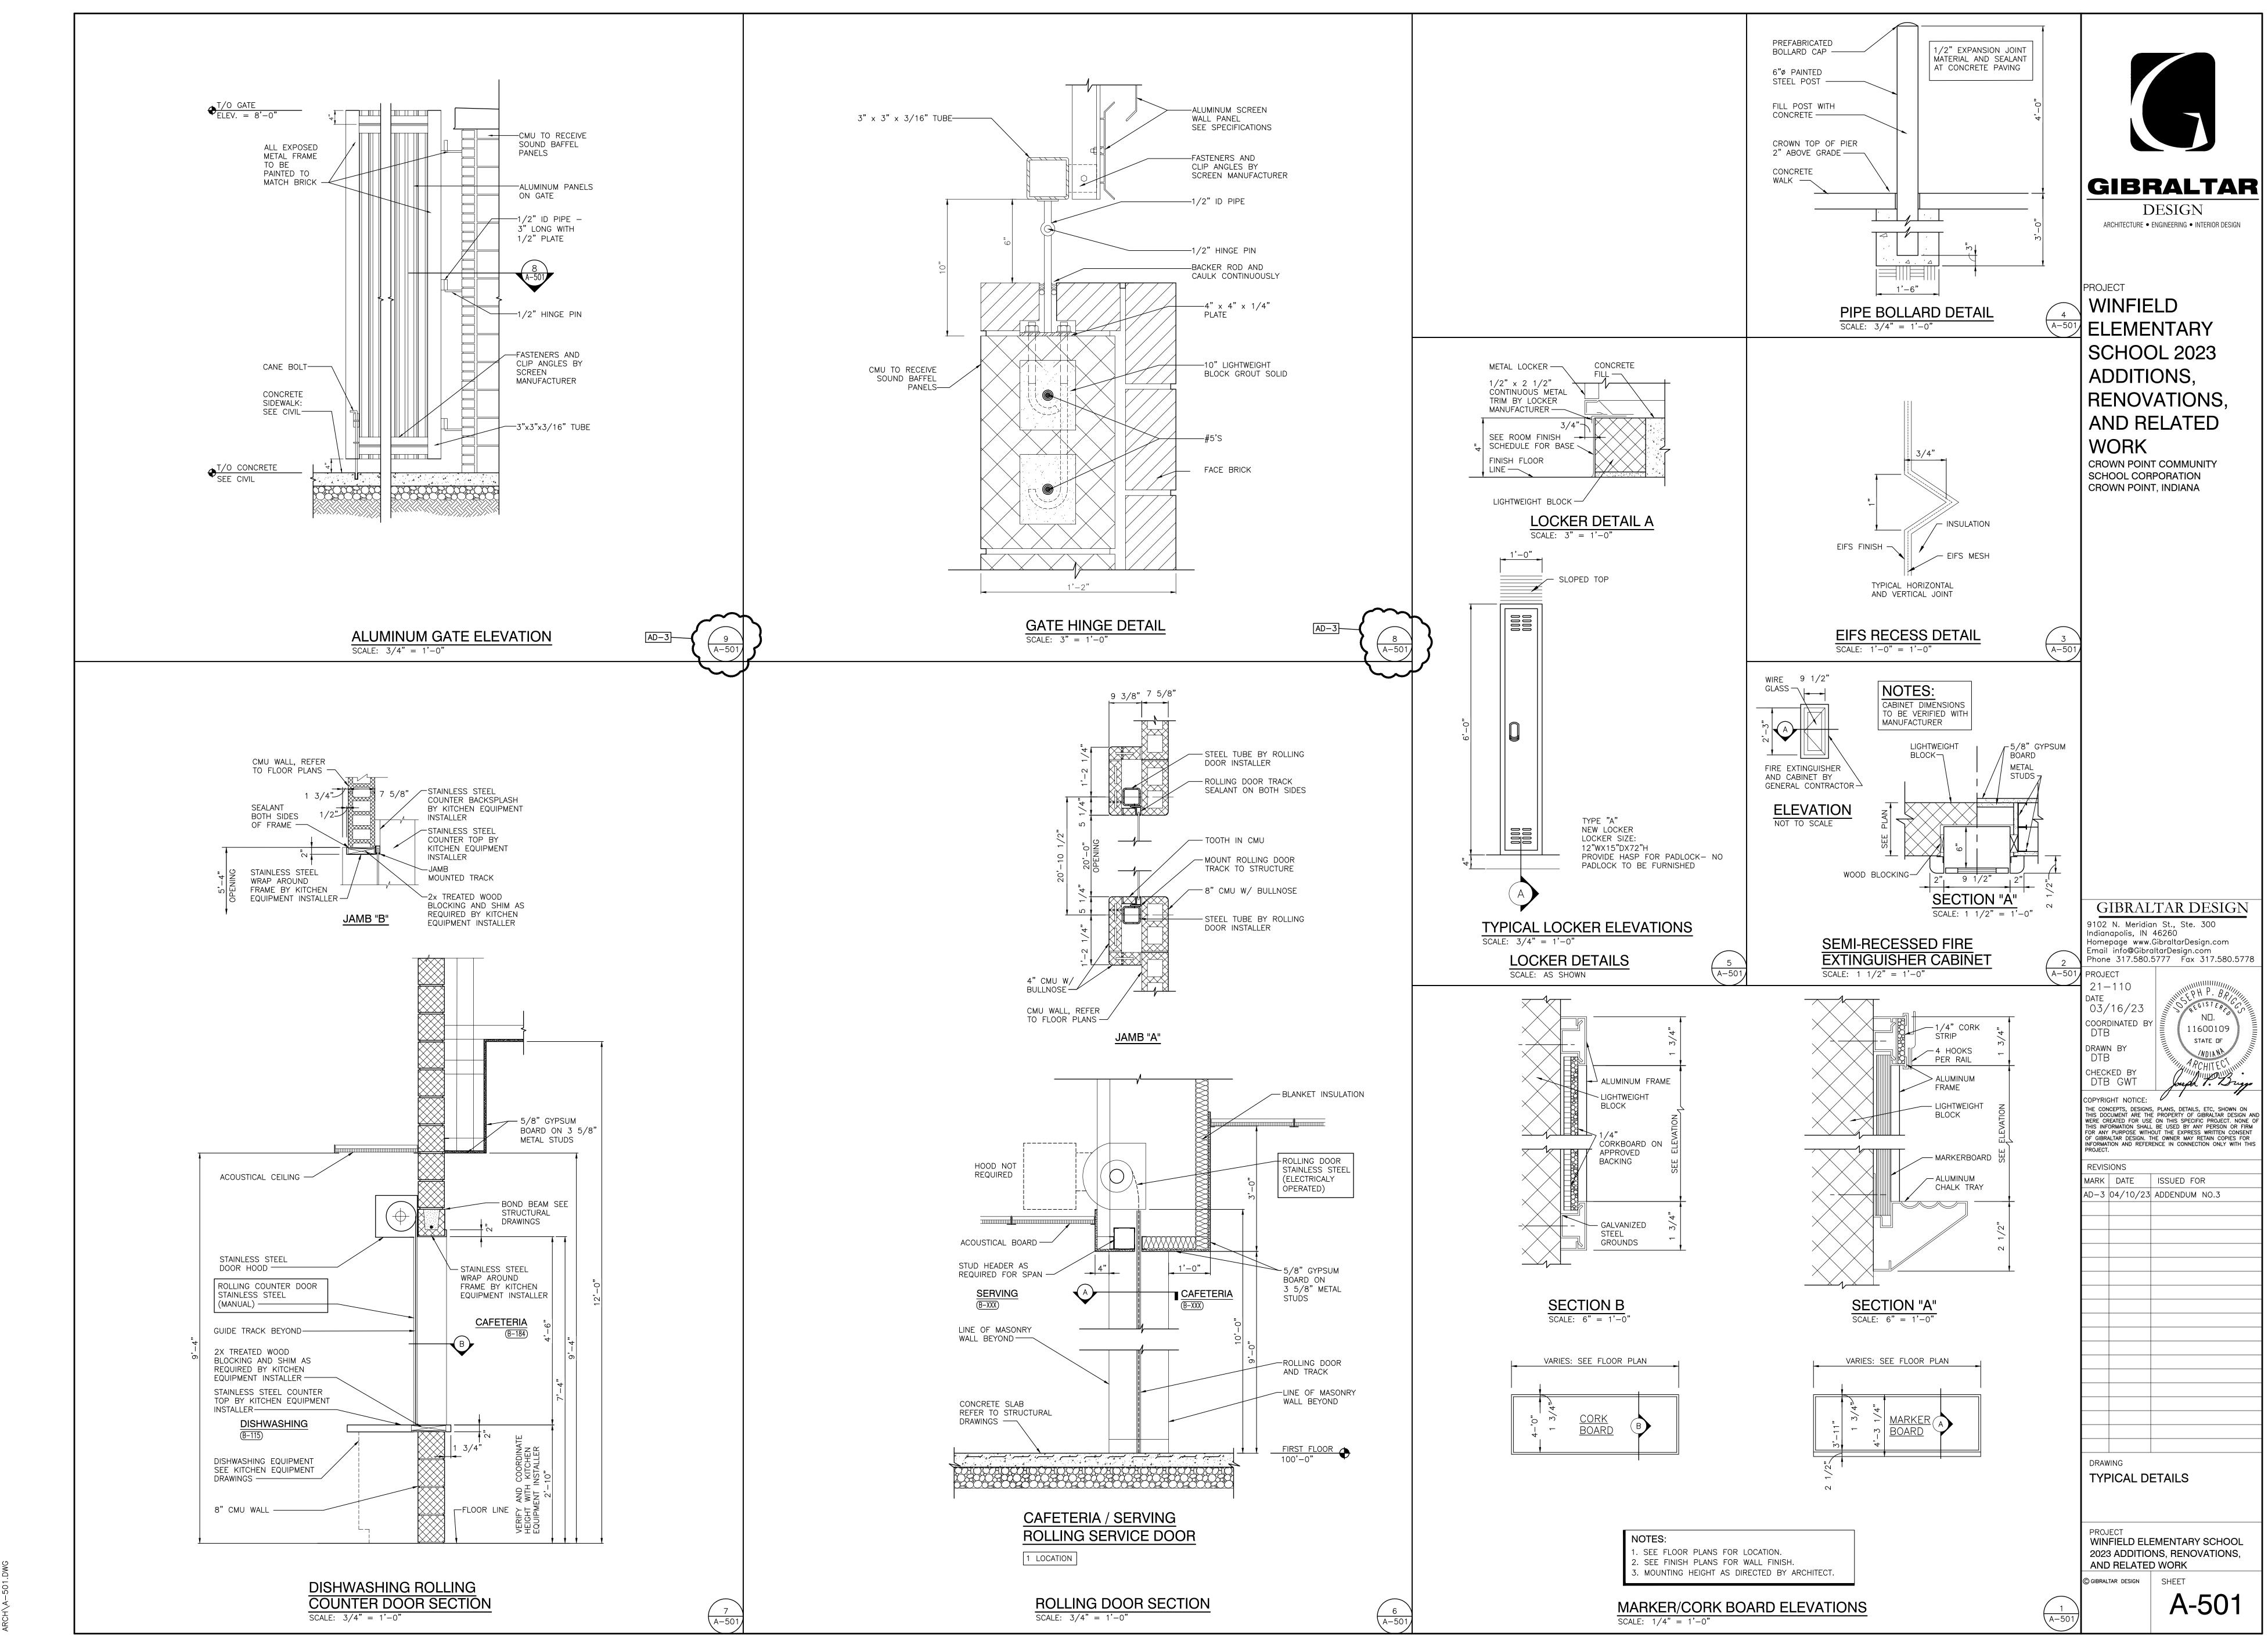

Tuesday, 4/11/2023 — 10:45 AM — LAST SAVED BY:DBURN\$
Y:\21—110 CROWN POINT CSC — WINFIELD ES 2023
ADDITIONS AND RENOVATIONS\21—110 DRAWINGS\05
ARCH\A—501.DWG

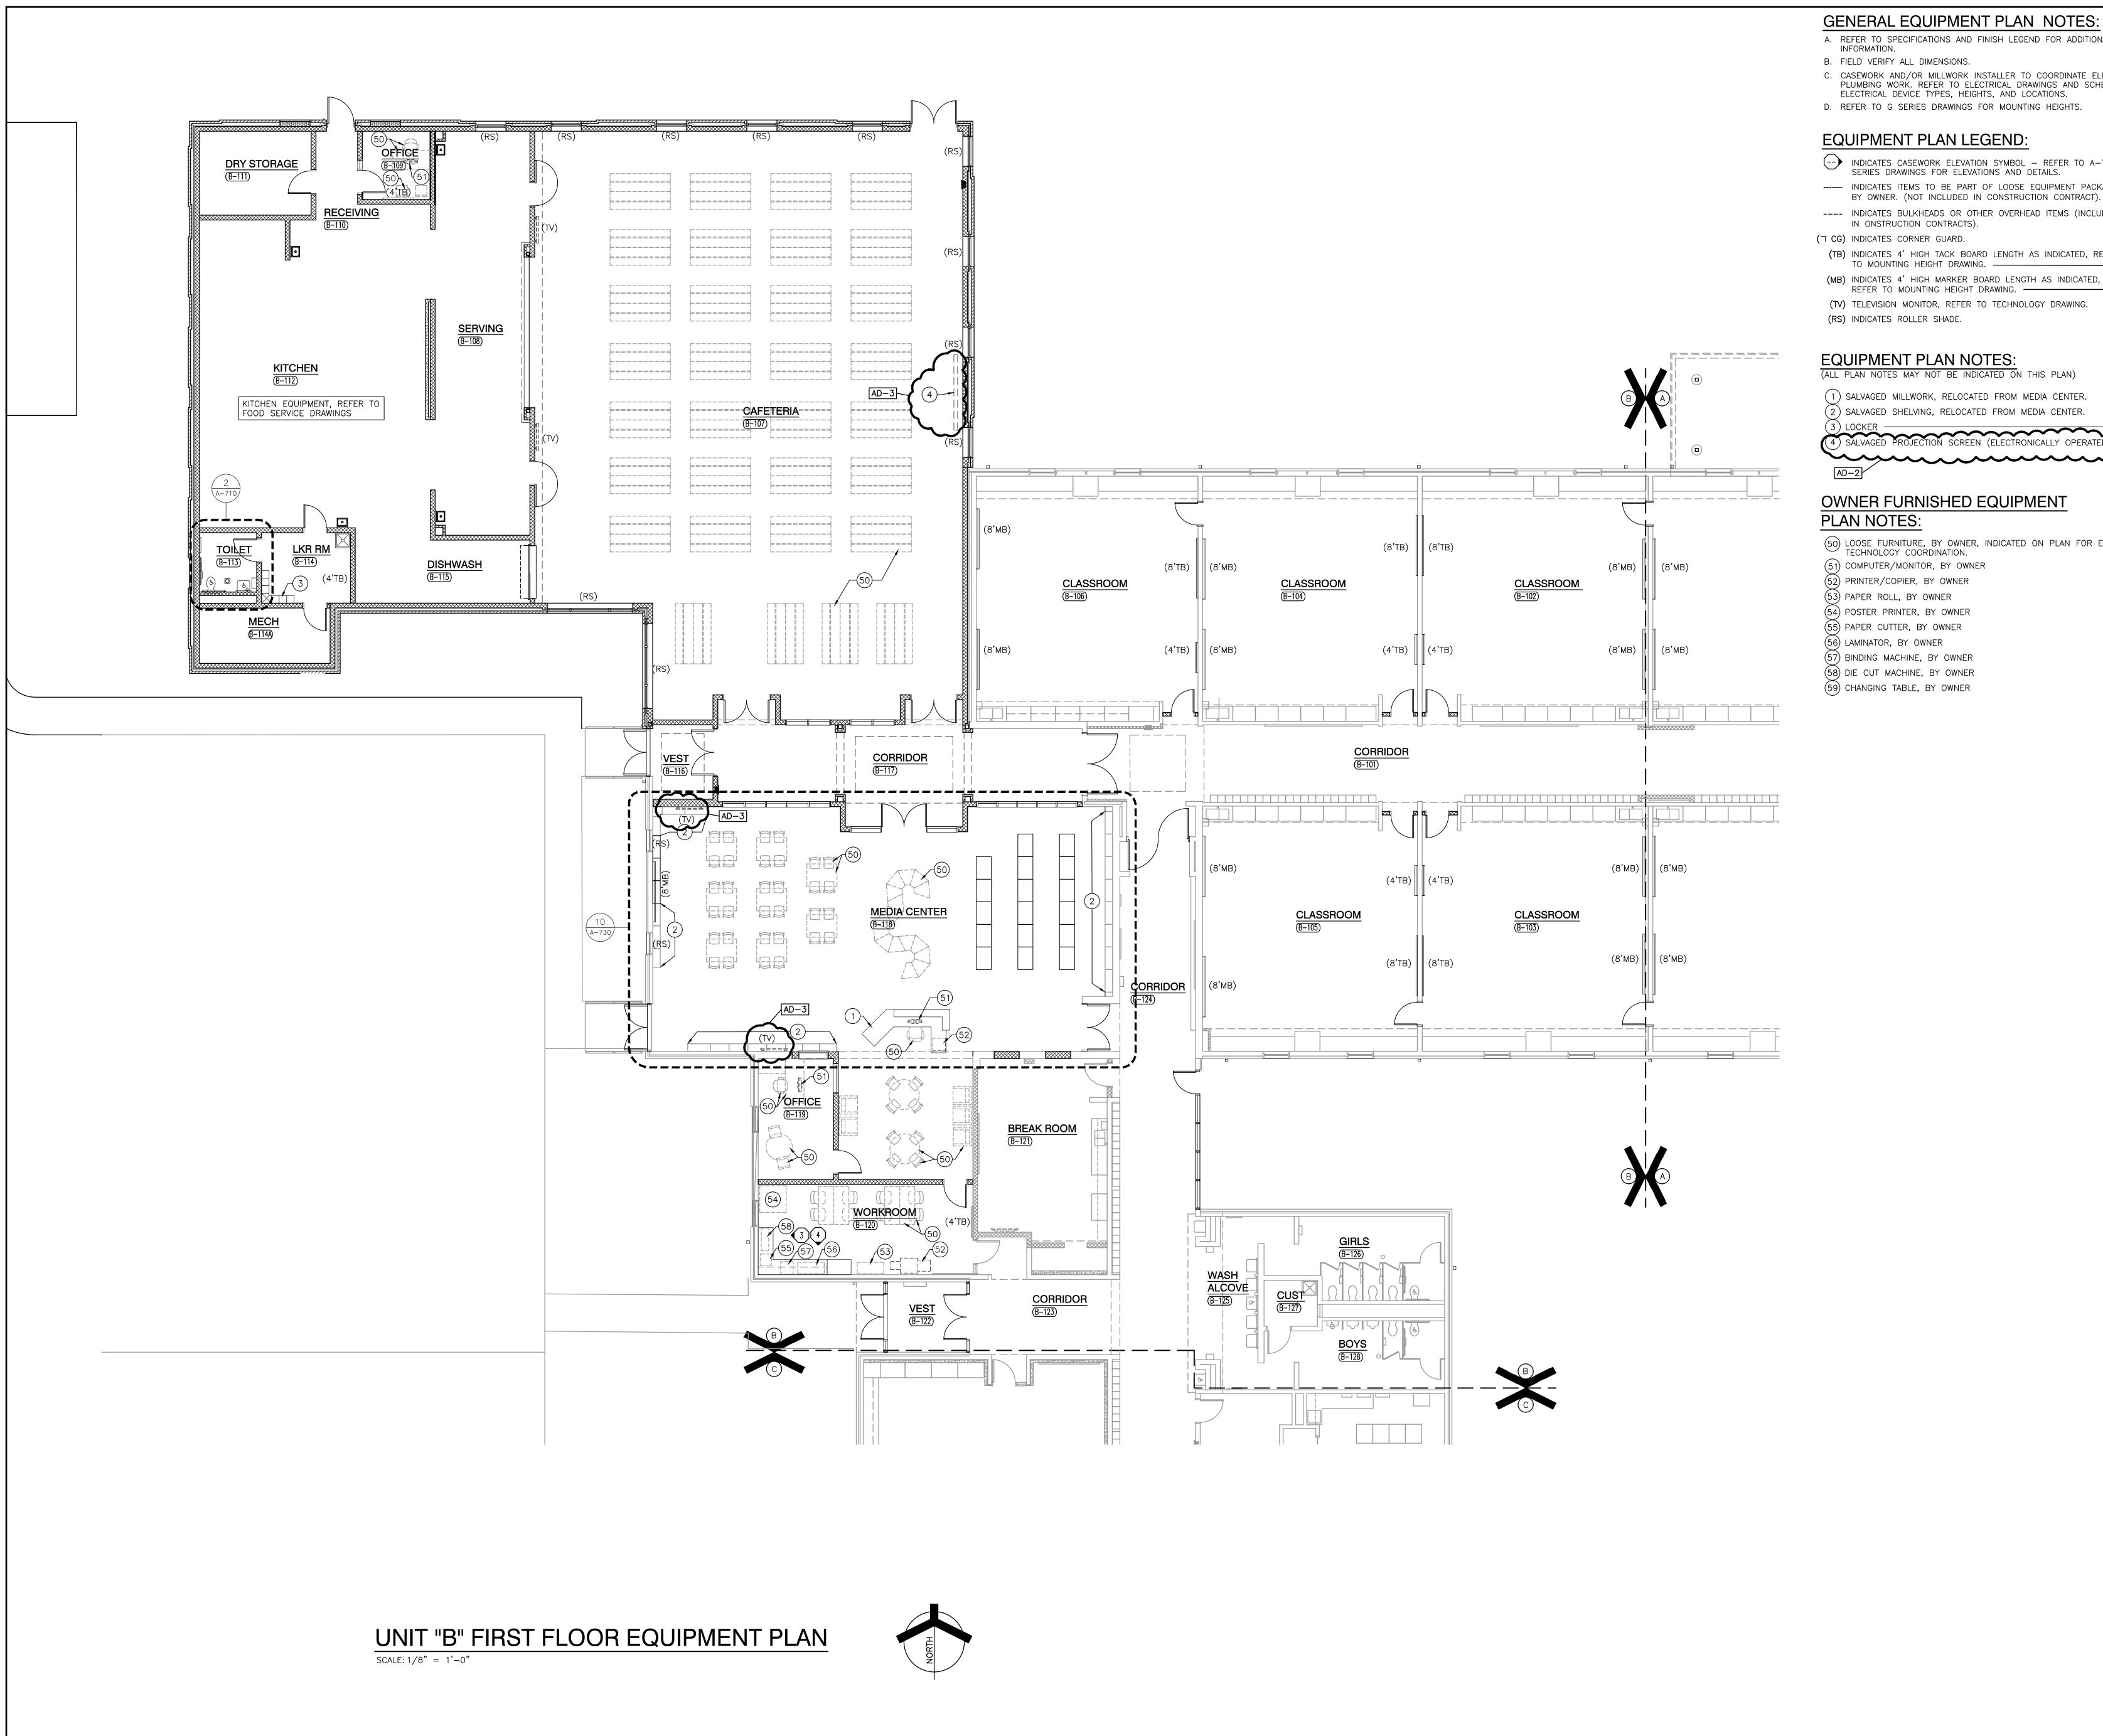

GENERAL EQUIPMENT PLAN NOTES:

A. REFER TO SPECIFICATIONS AND FINISH LEGEND FOR ADDITIONAL INFORMATION.

B. FIELD VERIFY ALL DIMENSIONS.

C. CASEWORK AND/OR MILLWORK INSTALLER TO COORDINATE ELECTRICAL AND PLUMBING WORK. REFER TO ELECTRICAL DRAWINGS AND SCHEDULES FOR ELECTRICAL DEVICE TYPES, HEIGHTS, AND LOCATIONS.

EQUIPMENT PLAN LEGEND:

INDICATES CASEWORK ELEVATION SYMBOL — REFER TO A-730 SERIES DRAWINGS FOR ELEVATIONS AND DETAILS.

----- INDICATES ITEMS TO BE PART OF LOOSE EQUIPMENT PACKAGE BY OWNER. (NOT INCLUDED IN CONSTRUCTION CONTRACT).

---- INDICATES BULKHEADS OR OTHER OVERHEAD ITEMS (INCLUDED IN ONSTRUCTION CONTRACTS).

(TB) INDICATES 4' HIGH TACK BOARD LENGTH AS INDICATED, REFER

(MB) INDICATES 4' HIGH MARKER BOARD LENGTH AS INDICATED, REFER TO MOUNTING HEIGHT DRAWING. —

(ALL PLAN NOTES MAY NOT BE INDICATED ON THIS PLAN) 1) SALVAGED MILLWORK, RELOCATED FROM MEDIA CENTER. 2) SALVAGED SHELVING, RELOCATED FROM MEDIA CENTER. CALLYAGES CONTROLLED

(50) LOOSE FURNITURE, BY OWNER, INDICATED ON PLAN FOR ELECTRICAL AND TECHNOLOGY COORDINATION. (51) COMPUTER/MONITOR, BY OWNER (52) PRINTER/COPIER, BY OWNER (53) PAPER ROLL, BY OWNER (54) POSTER PRINTER, BY OWNER (55) PAPER CUTTER, BY OWNER




DESIGN ARCHITECTURE • ENGINEERING • INTERIOR DESIGN

WINFIELD ELEMENTARY SCHOOL 2023 ADDITIONS, RENOVATIONS, AND RELATED WORK **CROWN POINT COMMUNITY**

SCHOOL CORPORATION

CROWN POINT, INDIANA

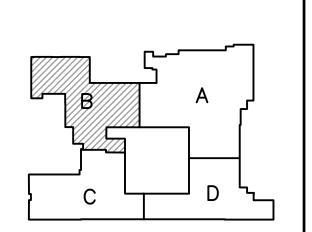

FIRST FLOOR KEY PLAN

11600109

GIBRALTAR DESIGN 9102 N. Meridian St., Ste. 300 Indianapolis, IN 46260
Homepage www.GibraltarDesign.com
Email info@GibraltarDesign.com
Phone 317.580.5777 Fax 317.580.5778

03/16/23 COORDINATED E DRAWN BY

EKM CHECKED BY NAS

THE CONCEPTS, DESIGNS, PLANS, DETAILS, ETC, SHOWN ON THIS DOCUMENT ARE THE PROPERTY OF GIBRALTAR DESIGN AND WERE CREATED FOR USE ON THIS SPECIFIC PROJECT. NONE OF THIS INFORMATION SHALL BE USED BY ANY PERSON OR FIRM FOR ANY PURPOSE WITHOUT THE EXPRESS WRITTEN CONSENT OF GIBRALTAR DESIGN. THE OWNER MAY RETAIN COPIES FOR INFORMATION AND REFERENCE IN CONNECTION ONLY WITH THIS PROJECT.


MARK DATE ISSUED FOR AD-3 04/10/23 ADDENDUM NO.3

UNIT "B" FIRST FLOOR EQUIPMENT PLAN

WINFIELD ELEMENTARY SCHOOL 2023 ADDITIONS, RENOVATIONS, AND RELATED WORK

В

A-702

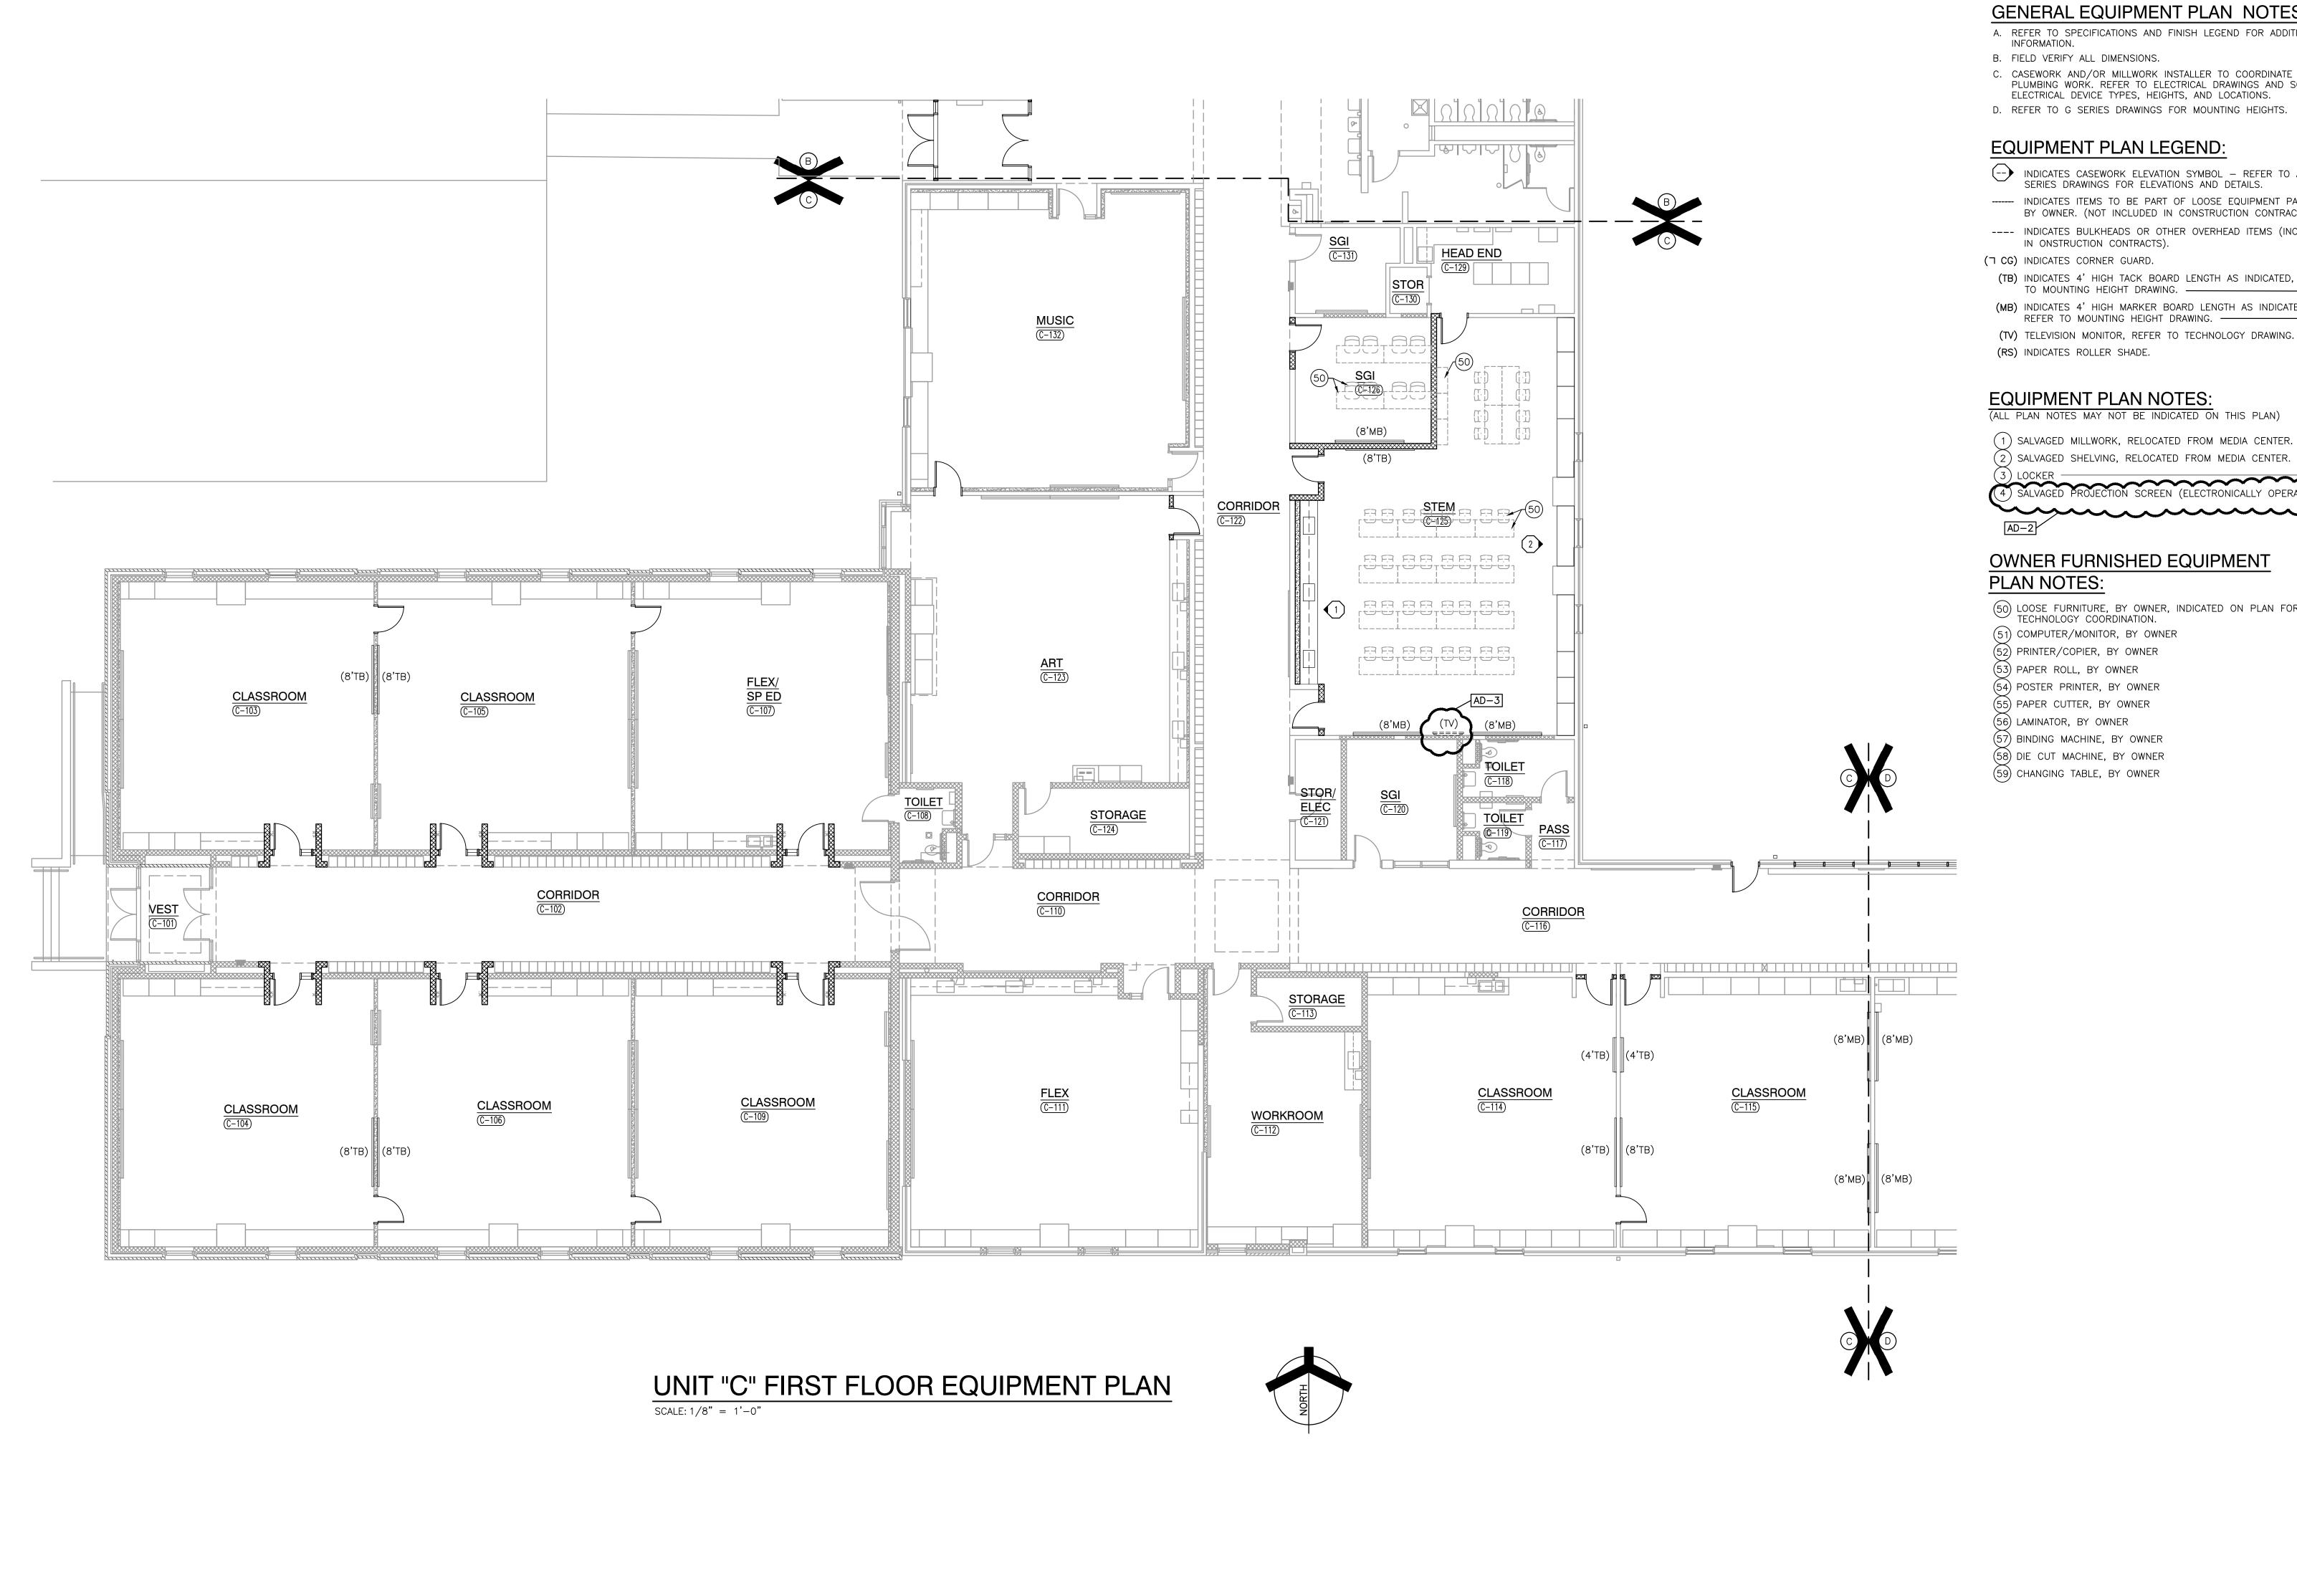

GENERAL EQUIPMENT PLAN NOTES:

A. REFER TO SPECIFICATIONS AND FINISH LEGEND FOR ADDITIONAL INFORMATION.

B. FIELD VERIFY ALL DIMENSIONS.

C. CASEWORK AND/OR MILLWORK INSTALLER TO COORDINATE ELECTRICAL AND PLUMBING WORK. REFER TO ELECTRICAL DRAWINGS AND SCHEDULES FOR ELECTRICAL DEVICE TYPES, HEIGHTS, AND LOCATIONS.

EQUIPMENT PLAN LEGEND:

INDICATES CASEWORK ELEVATION SYMBOL — REFER TO A-730 SERIES DRAWINGS FOR ELEVATIONS AND DETAILS.

----- INDICATES ITEMS TO BE PART OF LOOSE EQUIPMENT PACKAGE BY OWNER. (NOT INCLUDED IN CONSTRUCTION CONTRACT).

---- INDICATES BULKHEADS OR OTHER OVERHEAD ITEMS (INCLUDED IN ONSTRUCTION CONTRACTS). (7 CG) INDICATES CORNER GUARD.

(TB) INDICATES 4' HIGH TACK BOARD LENGTH AS INDICATED, REFER TO MOUNTING HEIGHT DRAWING. —

(MB) INDICATES 4' HIGH MARKER BOARD LENGTH AS INDICATED, REFER TO MOUNTING HEIGHT DRAWING. $-\!-\!-$ (TV) TELEVISION MONITOR, REFER TO TECHNOLOGY DRAWING.

EQUIPMENT PLAN NOTES:

(ALL PLAN NOTES MAY NOT BE INDICATED ON THIS PLAN)

2) SALVAGED SHELVING, RELOCATED FROM MEDIA CENTER. (4) SALVAGED PROJECTION SCREEN (FIFCTRONICALLY OPERATED

OWNER FURNISHED EQUIPMENT **PLAN NOTES:**

50) LOOSE FURNITURE, BY OWNER, INDICATED ON PLAN FOR ELECTRICAL AND TECHNOLOGY COORDINATION. (51) COMPUTER/MONITOR, BY OWNER (52) PRINTER/COPIER, BY OWNER (53) PAPER ROLL, BY OWNER (54) POSTER PRINTER, BY OWNER (55) PAPER CUTTER, BY OWNER


GIBRALTAR

DESIGN

ARCHITECTURE • ENGINEERING • INTERIOR DESIGN

WINFIELD ELEMENTARY SCHOOL 2023 ADDITIONS, RENOVATIONS, AND RELATED WORK CROWN POINT COMMUNITY

SCHOOL CORPORATION CROWN POINT, INDIANA

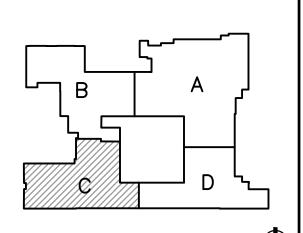

FIRST FLOOR KEY PLAN

11600109 STATE OF

GIBRALTAR DESIGN 9102 N. Meridian St., Ste. 300 Indianapolis, IN 46260
Homepage www.GibraltarDesign.com
Email info@GibraltarDesign.com
Phone 317.580.5777 Fax 317.580.5778

21-110

03/16/23 COORDINATED E

DRAWN BY EKM CHECKED BY NAS

COPYRIGHT NOTICE: THE CONCEPTS, DESIGNS, PLANS, DETAILS, ETC, SHOWN ON THIS DOCUMENT ARE THE PROPERTY OF GIBRALTAR DESIGN AND WERE CREATED FOR USE ON THIS SPECIFIC PROJECT. NONE OF THIS INFORMATION SHALL BE USED BY ANY PERSON OR FIRM FOR ANY PURPOSE WITHOUT THE EXPRESS WRITTEN CONSENT OF GIBRALTAR DESIGN. THE OWNER MAY RETAIN COPIES FOR INFORMATION AND REFERENCE IN CONNECTION ONLY WITH THIS PROJECT.

MARK DATE ISSUED FOR


AD-3 04/10/23 ADDENDUM NO.3

UNIT "C" FIRST FLOOR EQUIPMENT PLAN


WINFIELD ELEMENTARY SCHOOL 2023 ADDITIONS, RENOVATIONS, AND RELATED WORK

GIBRALTAR DESIGN SHEET


A-703

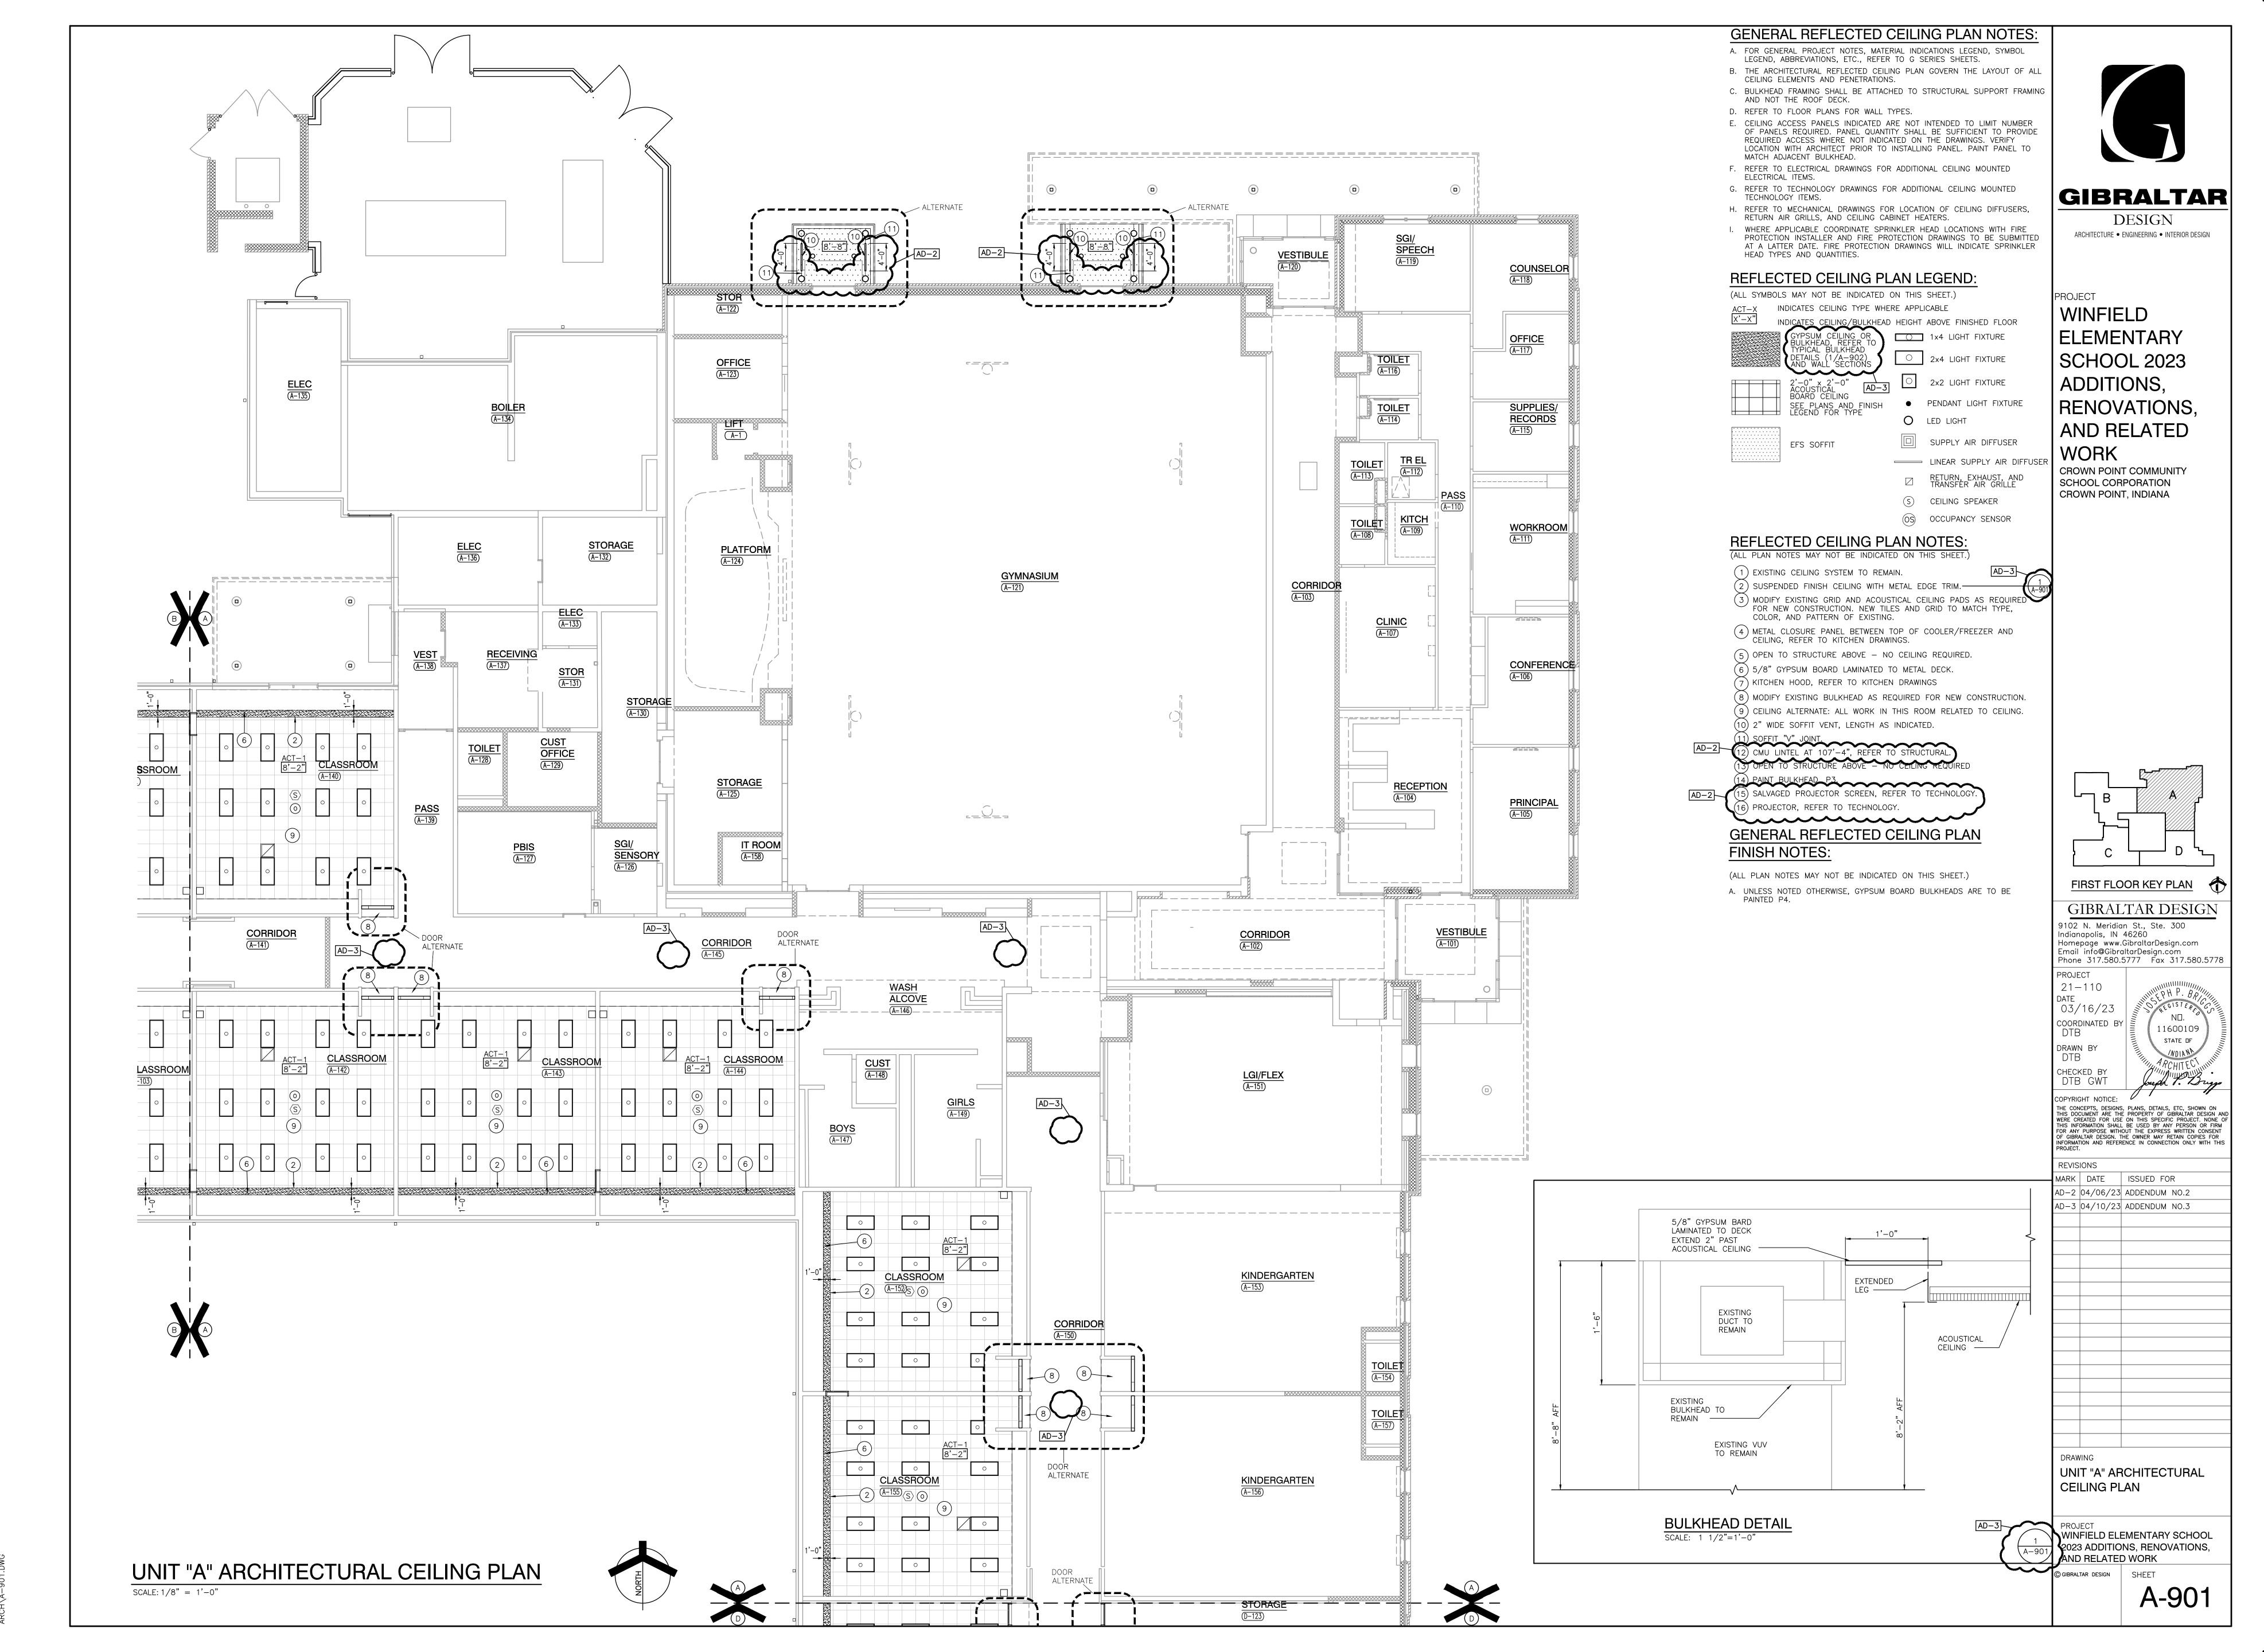


Monday, 4/10/2023 — 3:57 PM — LAST SAVED BY:DBURNSY:\21—110 CROWN POINT CSC — WINFIELD ES 2023
ADDITIONS AND RENOVATIONS\21—110 DRAWINGS\05

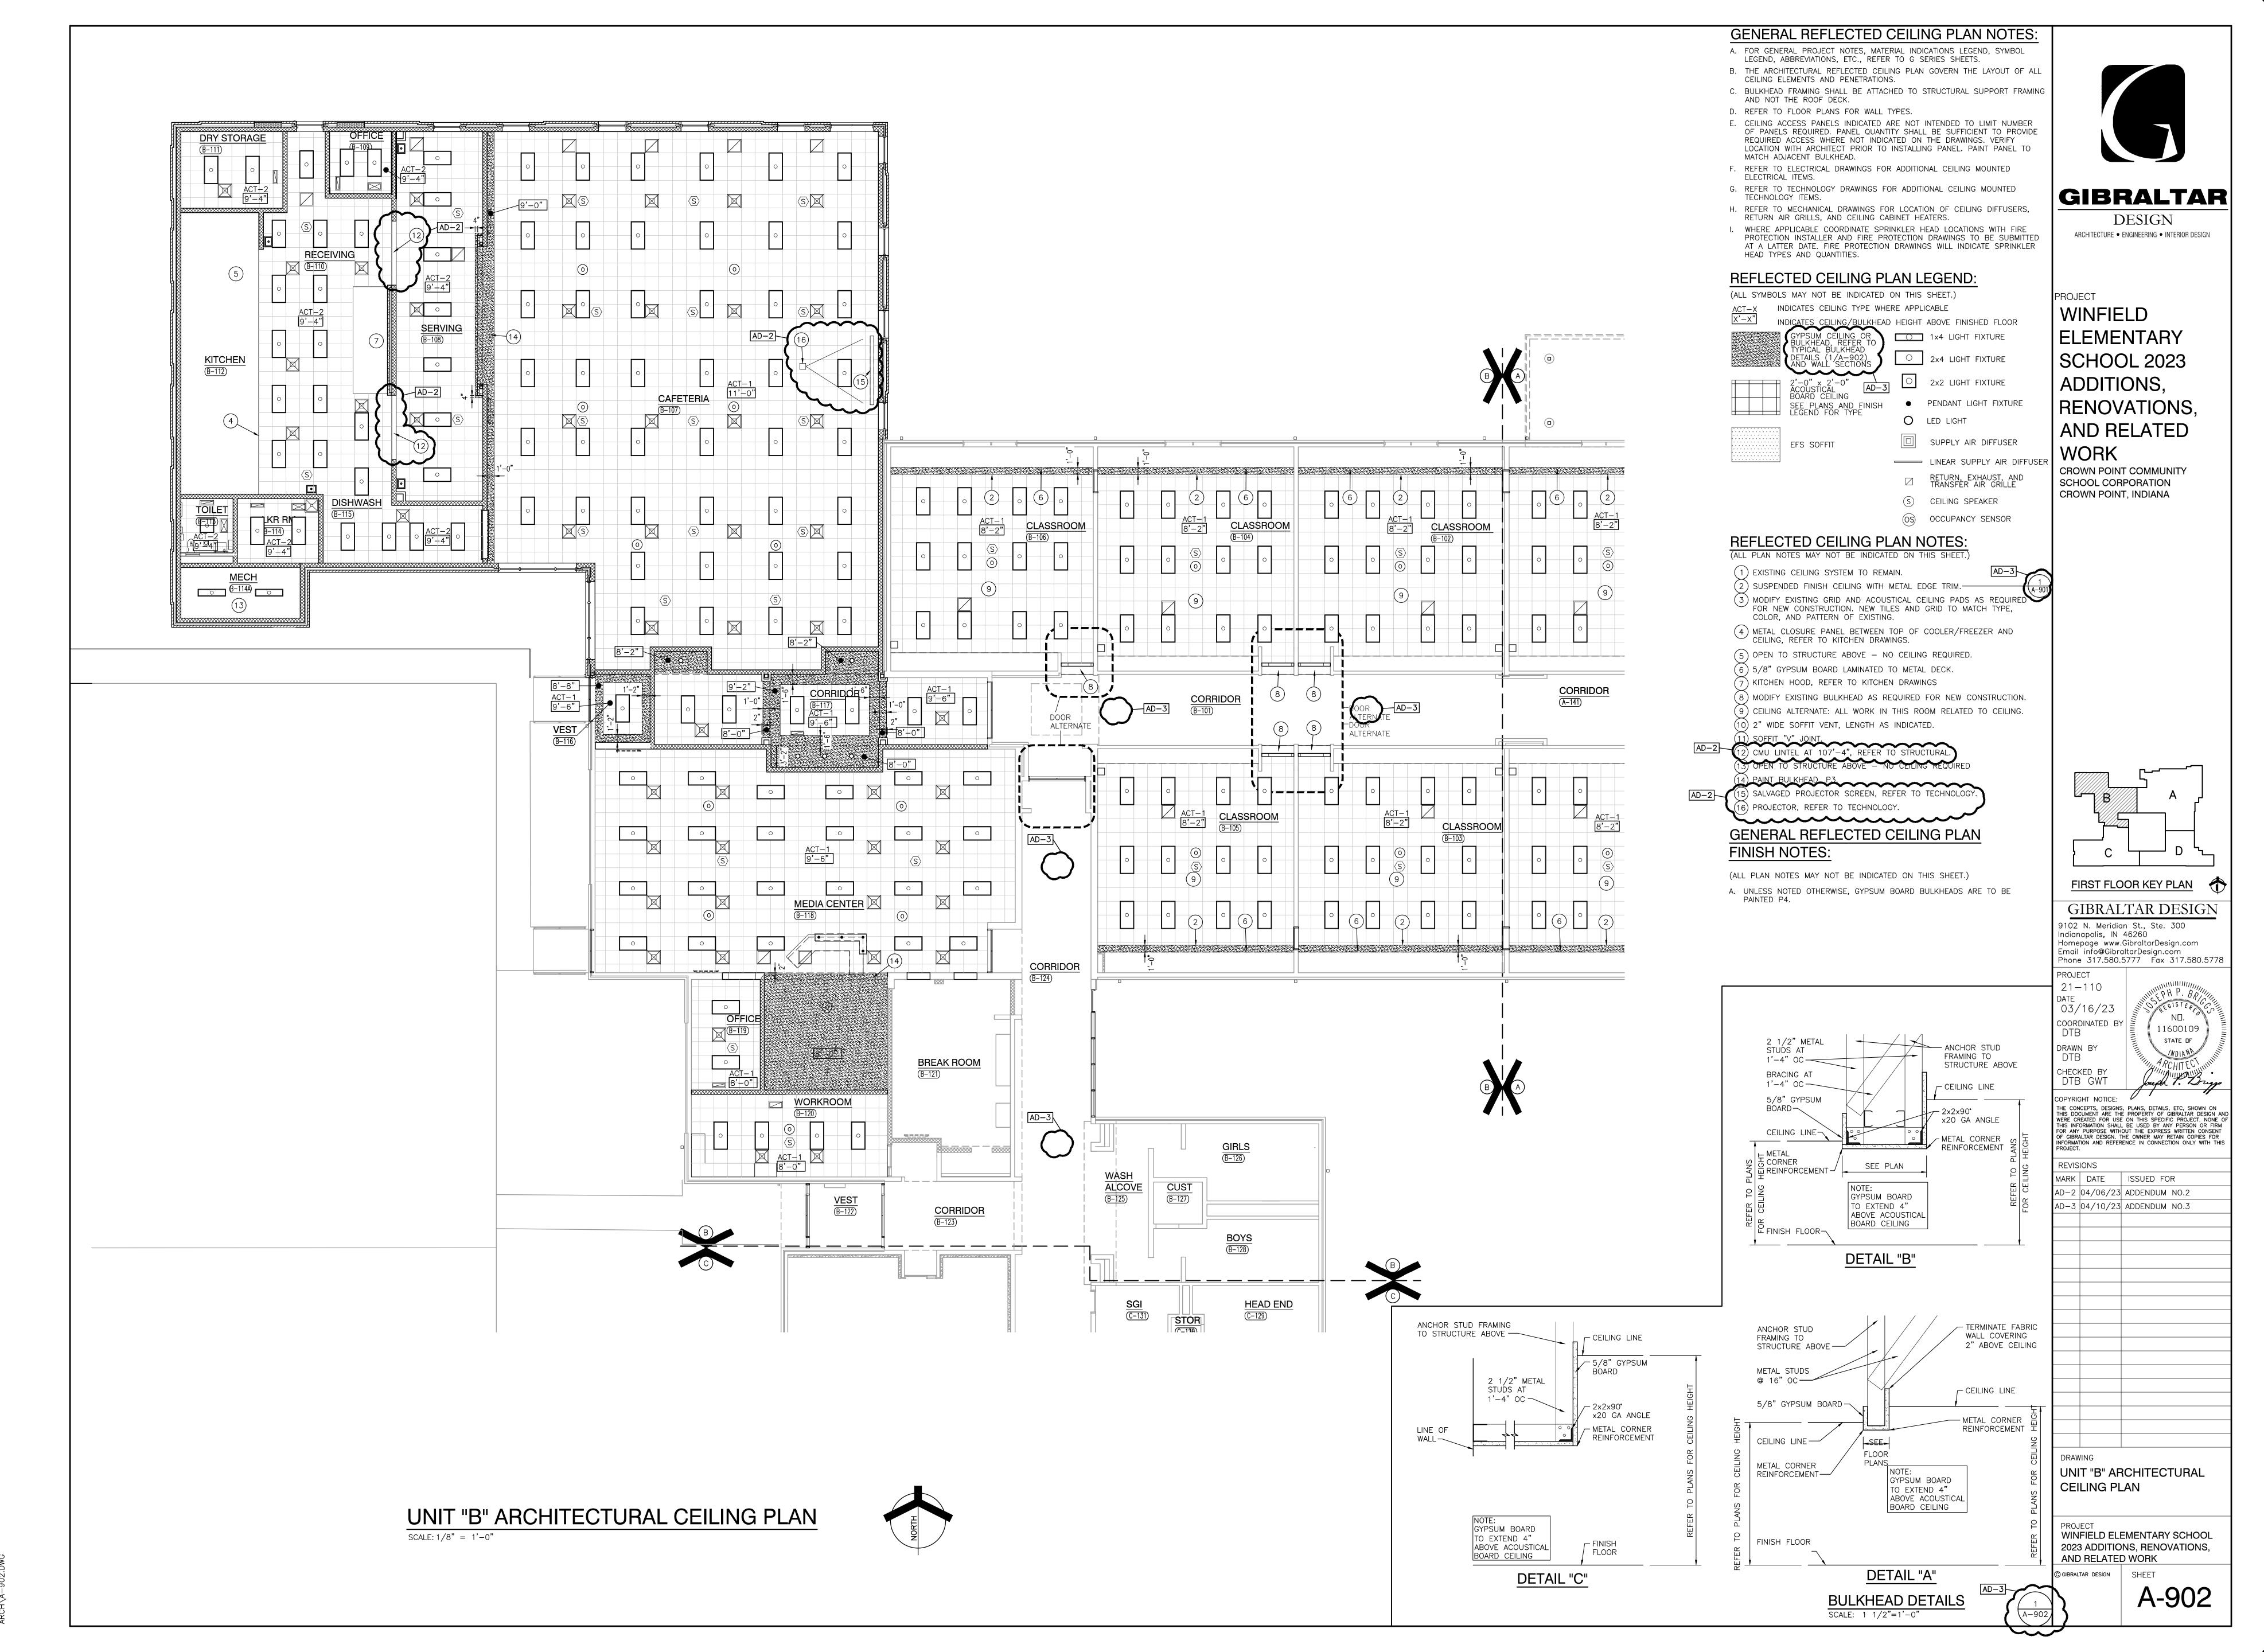

Monday, 4/10/2023 — 3:57 PM — LAST SAVED BY:DBURNS Y:\21—110 CROWN POINT CSC — WINFIELD ES 2023 ADDITIONS AND RENOVATIONS\21—110 DRAWINGS\05 ARCH\A—902.DWG

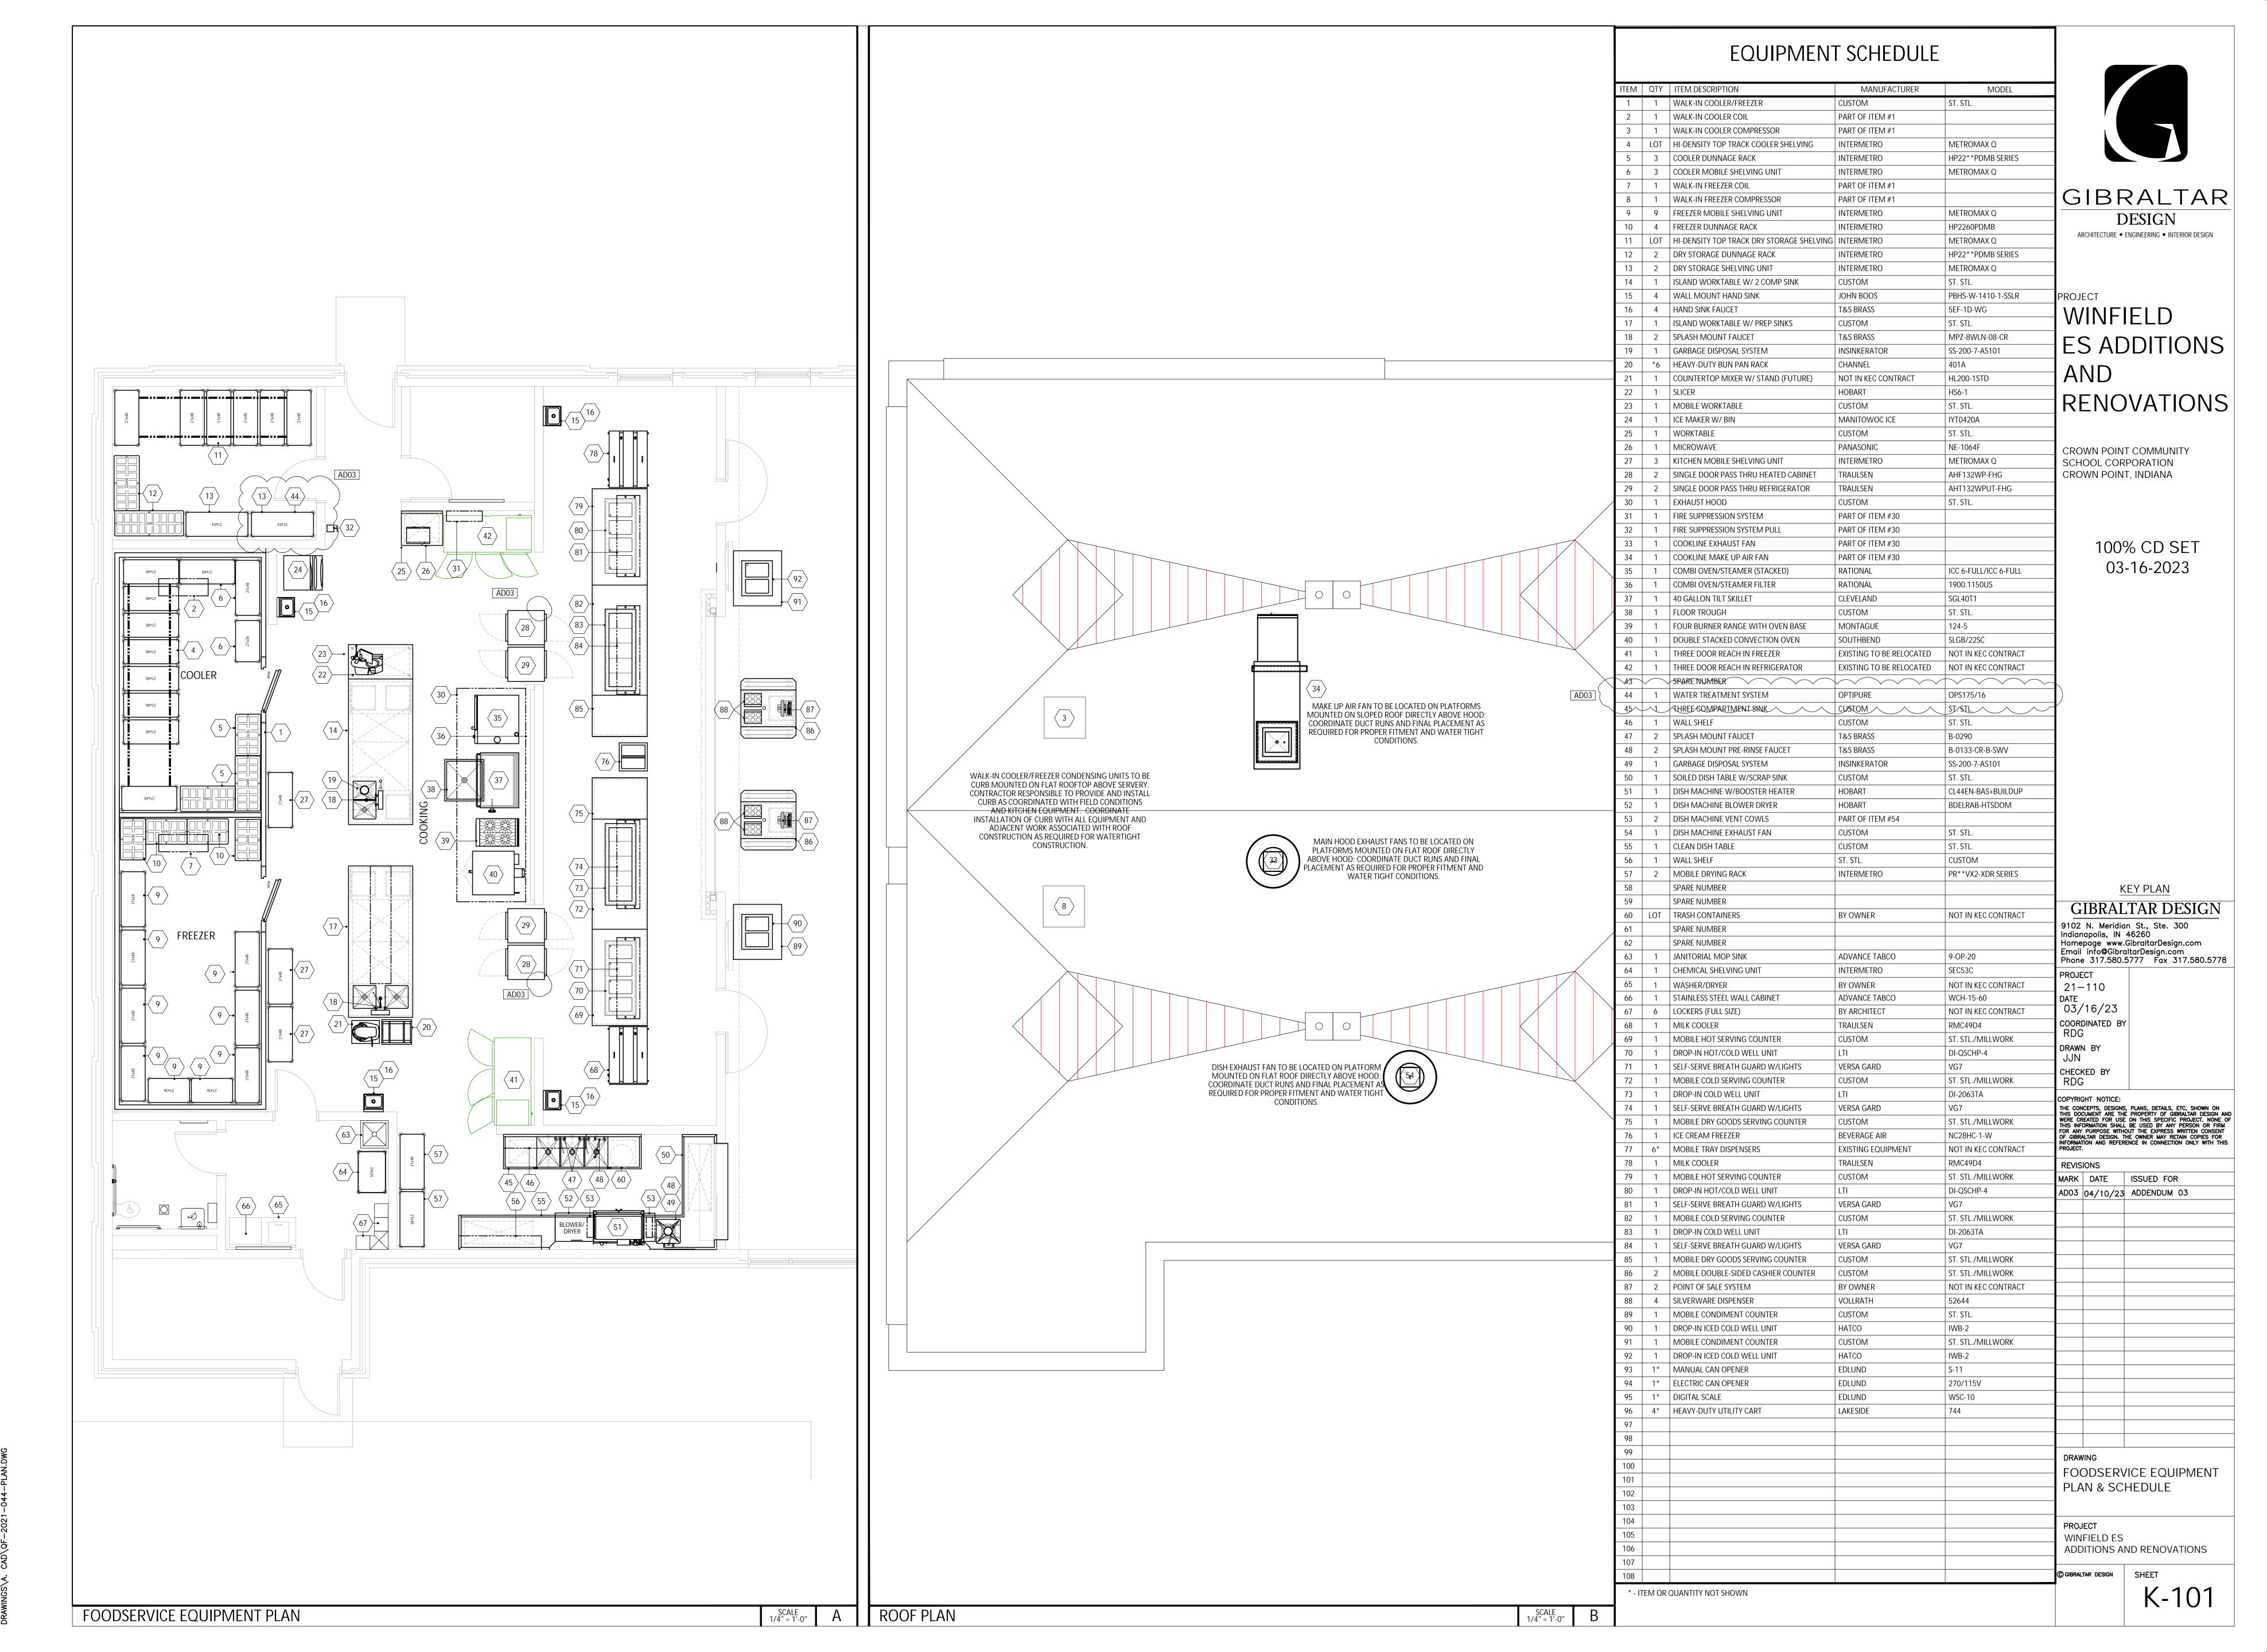

Monday, 4/10/2023 — 11:19 AM — LAST SAVED BY:JONA G:\SHARED DRIVES\RDG PROJECT DATA\RDG PROJECT FOLDER (2021)\2021—044— GIBRALTAR — WINFIELD ES\3. DRAWINGS\A. CAD\QF—2021—044—PLAN.DWG

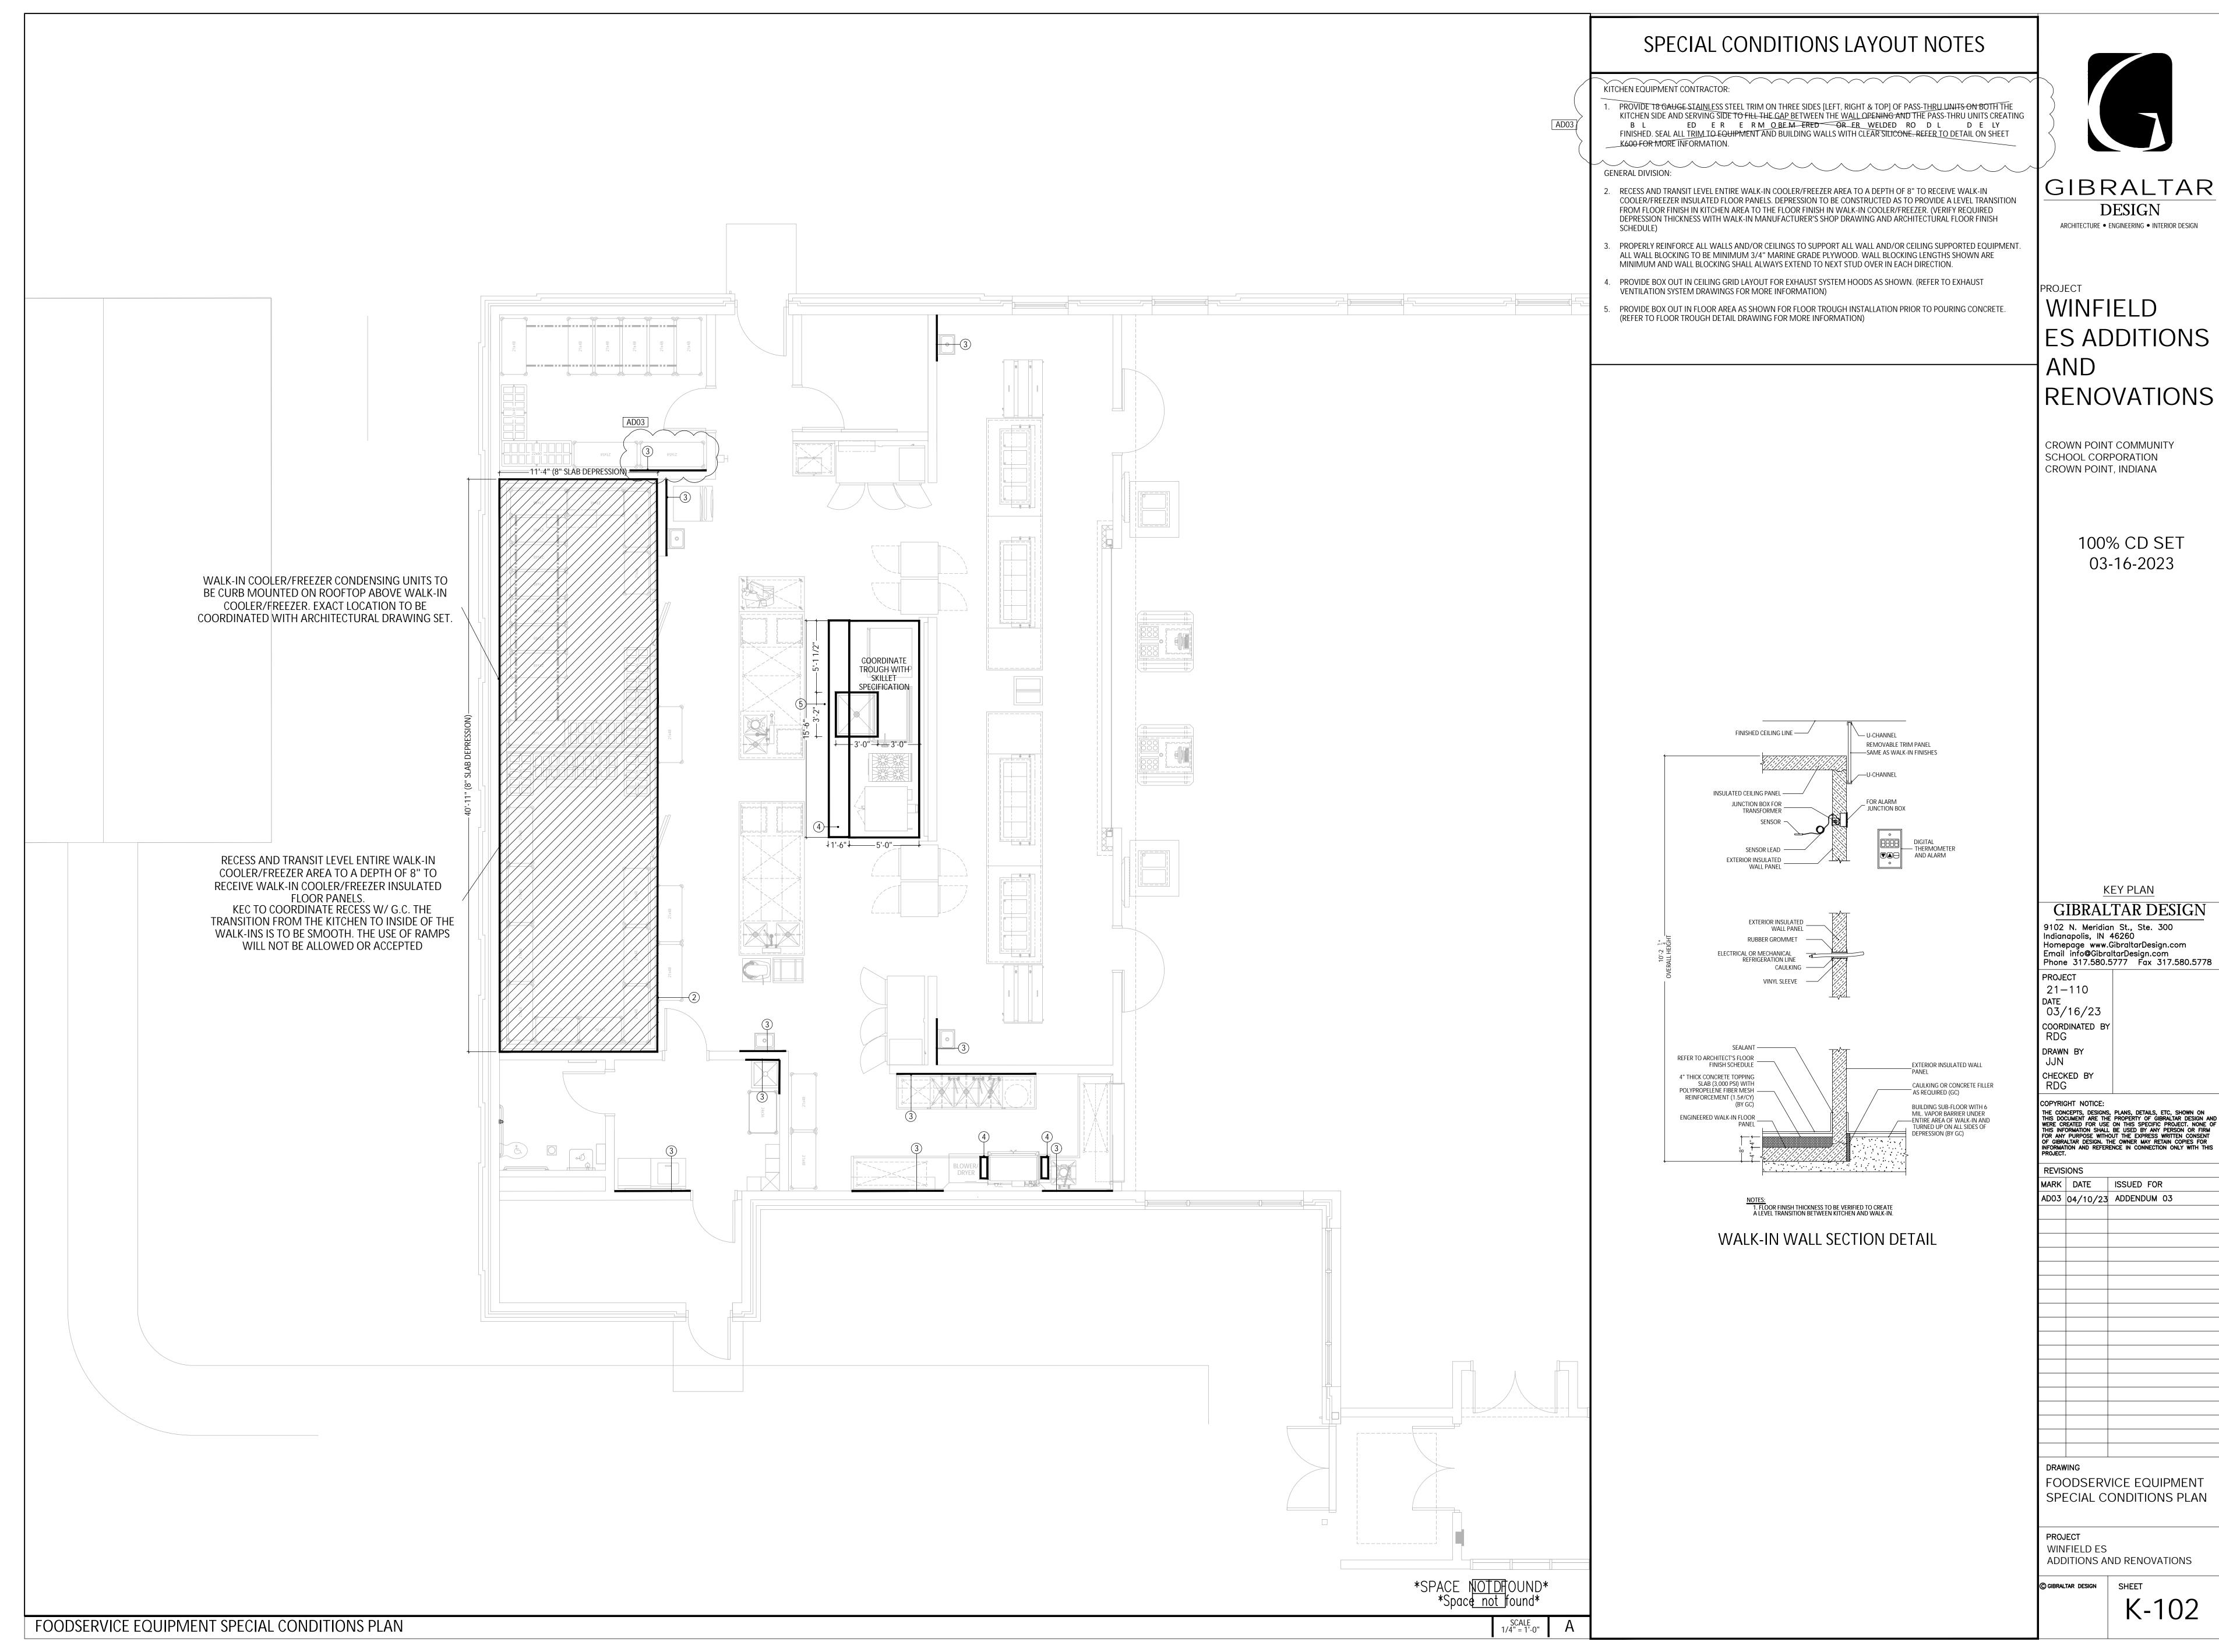

Monday, 4/10/2023 — 11:19 AM — LAST SAVED BY:JONA' G:\SHARED DRIVES\RDG PROJECT DATA\RDG PROJECT FOLDER (2021)\2021—044— GIBRALTAR — WINFIELD ES\3. DRAWINGS\A. CAD\QF—2021—044—PLAN.DWG

K-102

120

16.0

FURNISH HORIZONTAL RECEPTACLE WHEN MOUNTED

48 ABOVE COUNTERTOP

Monday, 4/10/2023 — 11:20 AM — LAST SAVED BY:JOI G:\SHARED DRIVES\RDG PROJECT DATA\RDG PROJECT FOLDER (2021)\2021—044— GIBRALTAR — WINFIELD ES\ DRAWINGS\A. CAD\QF—2021—044—SPOT.DWG

DUPLEX CONVENIENCE

DUPLEX CONVENIENCE

RECEPTACLE

RECEPTACLE

ADDITIONS AND RENOVATIONS GIBRALTAR DESIGN SHEET K-200

SPOT LOCATION SCHEDULES

PROJECT

WINFIELD ES


DESIGN

ARCHITECTURE • ENGINEERING • INTERIOR DESIGN


100% CD SET

03-16-2023


KEY PLAN

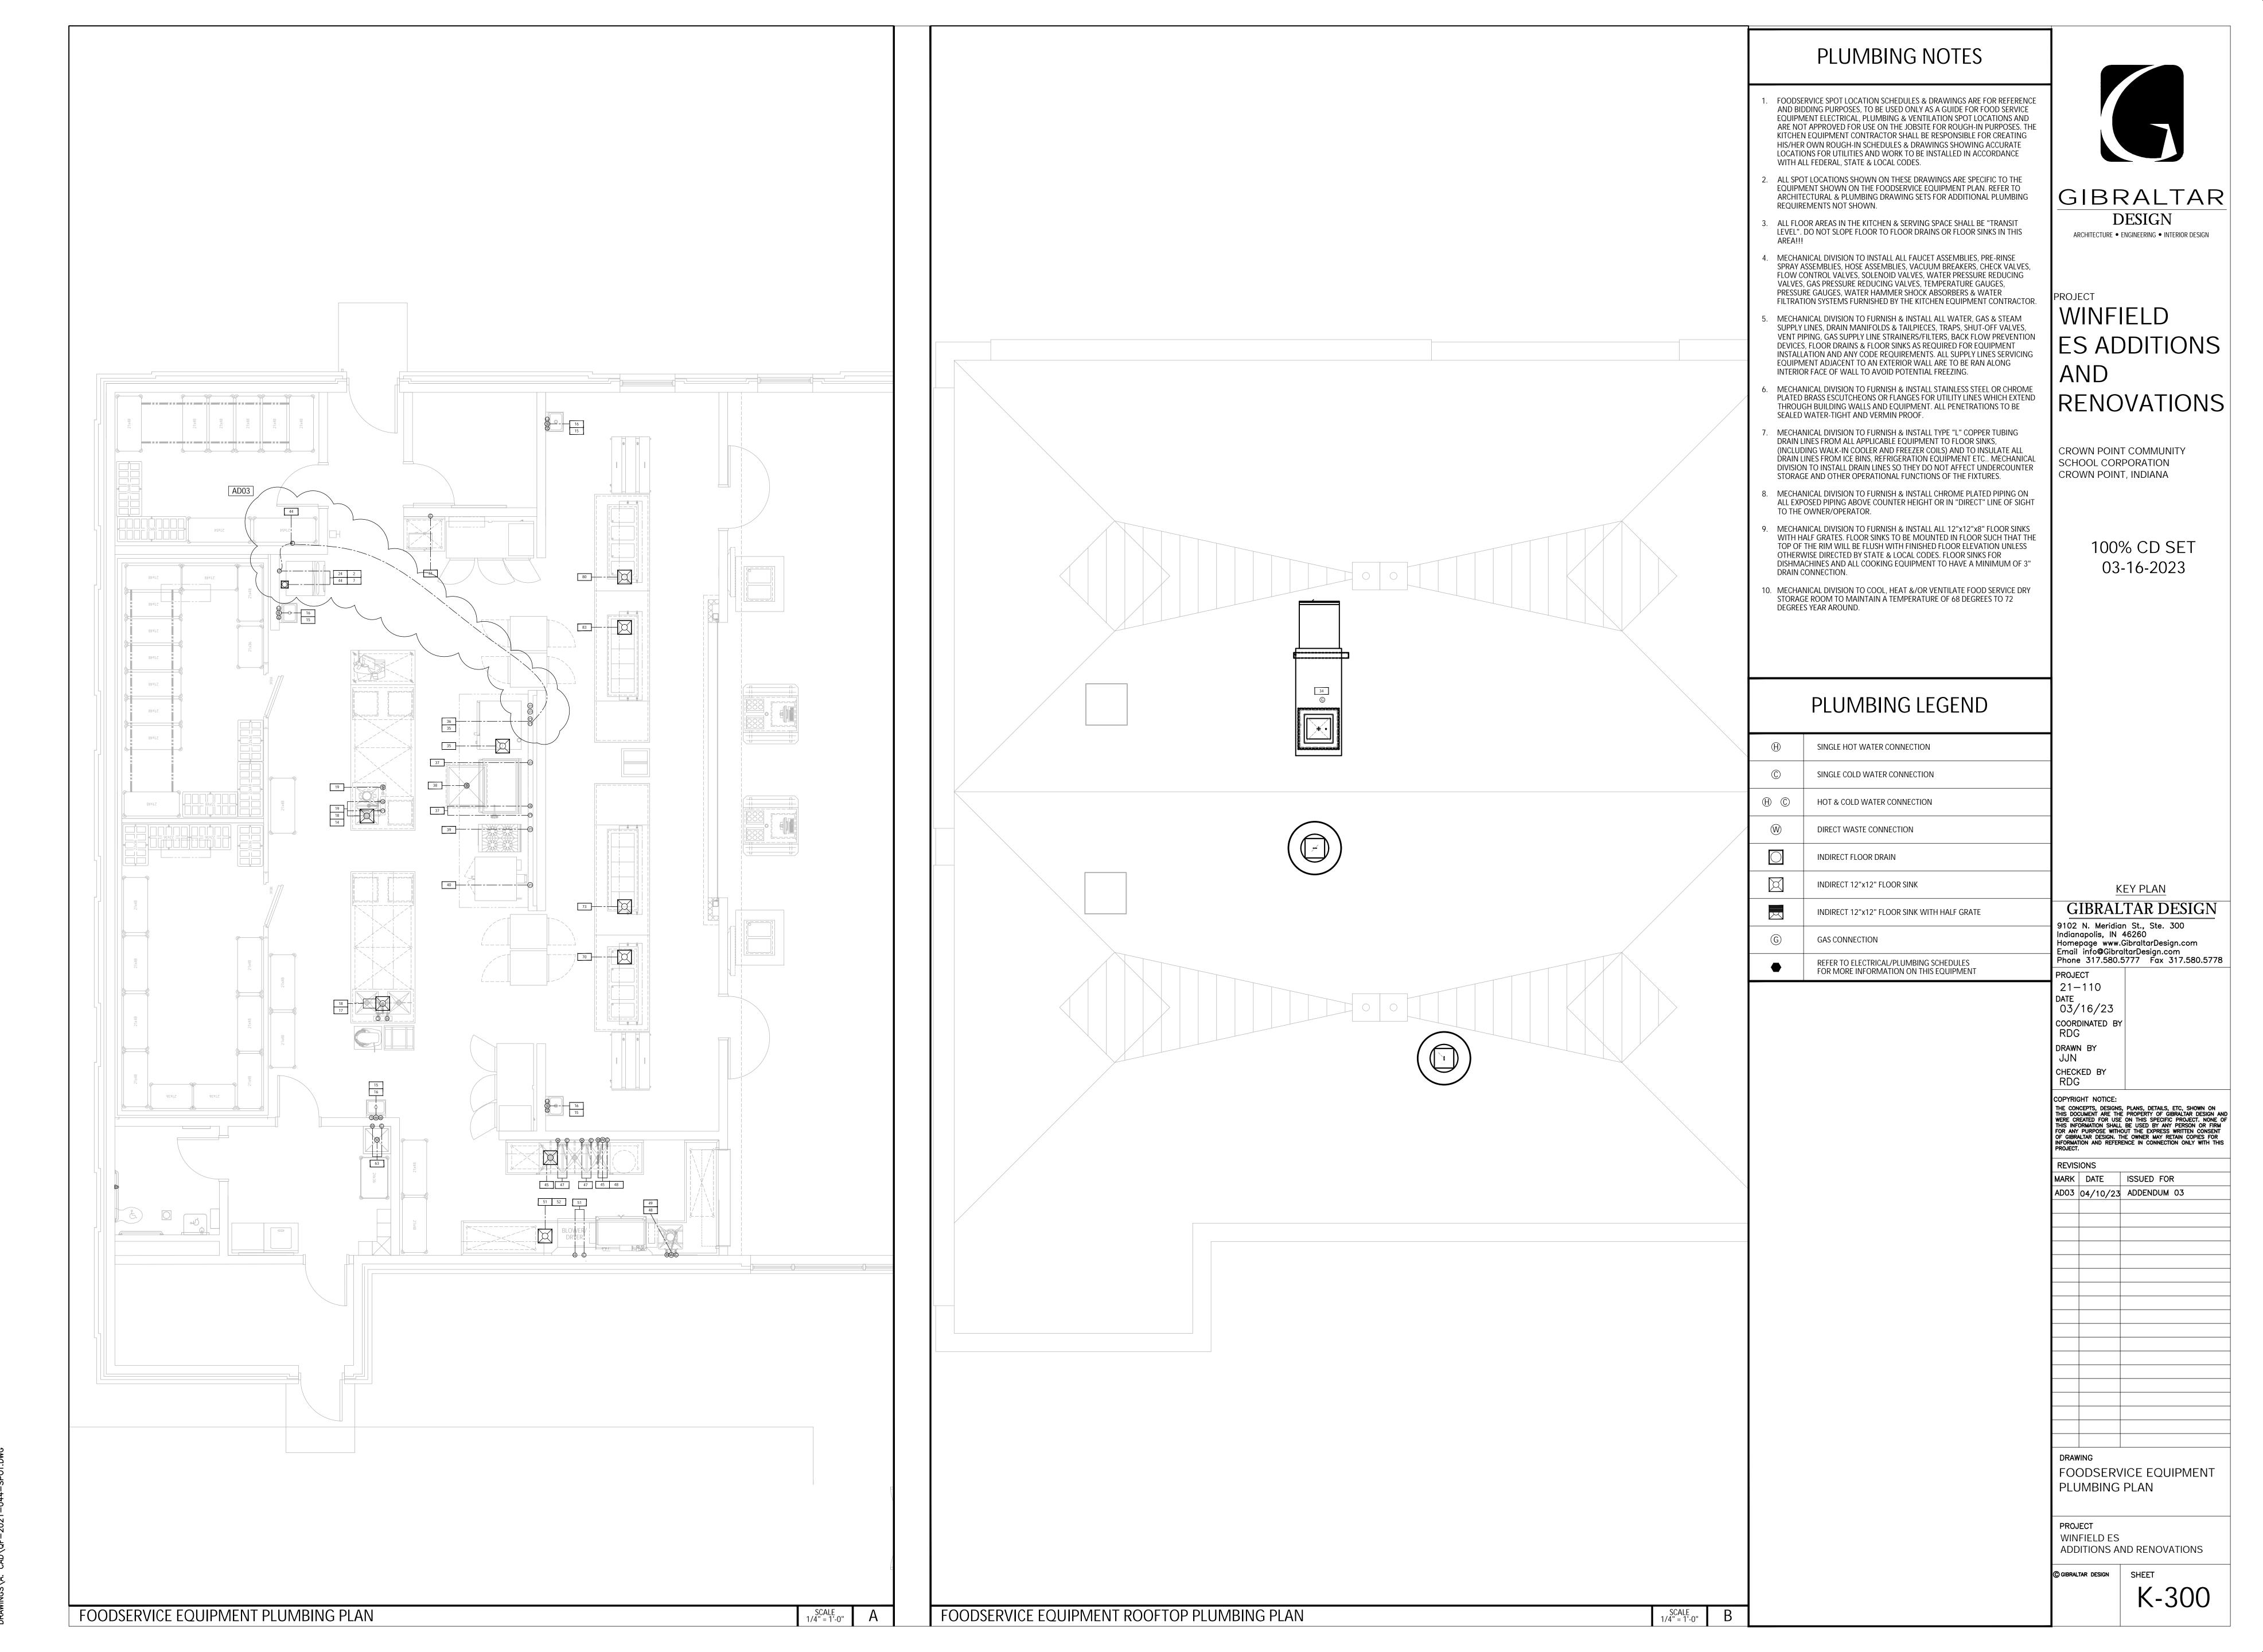

Monday, 4/10/2023 — 11:20 AM — LAST SAVED BY:JONA'G:\SHARED DRIVES\RDG PROJECT DATA\RDG PROJECT FOLDER (2021)\2021—044— GIBRALTAR — WINFIELD ES\3. DRAWINGS\A. CAD\QF—2021—044—SPOT.DWG

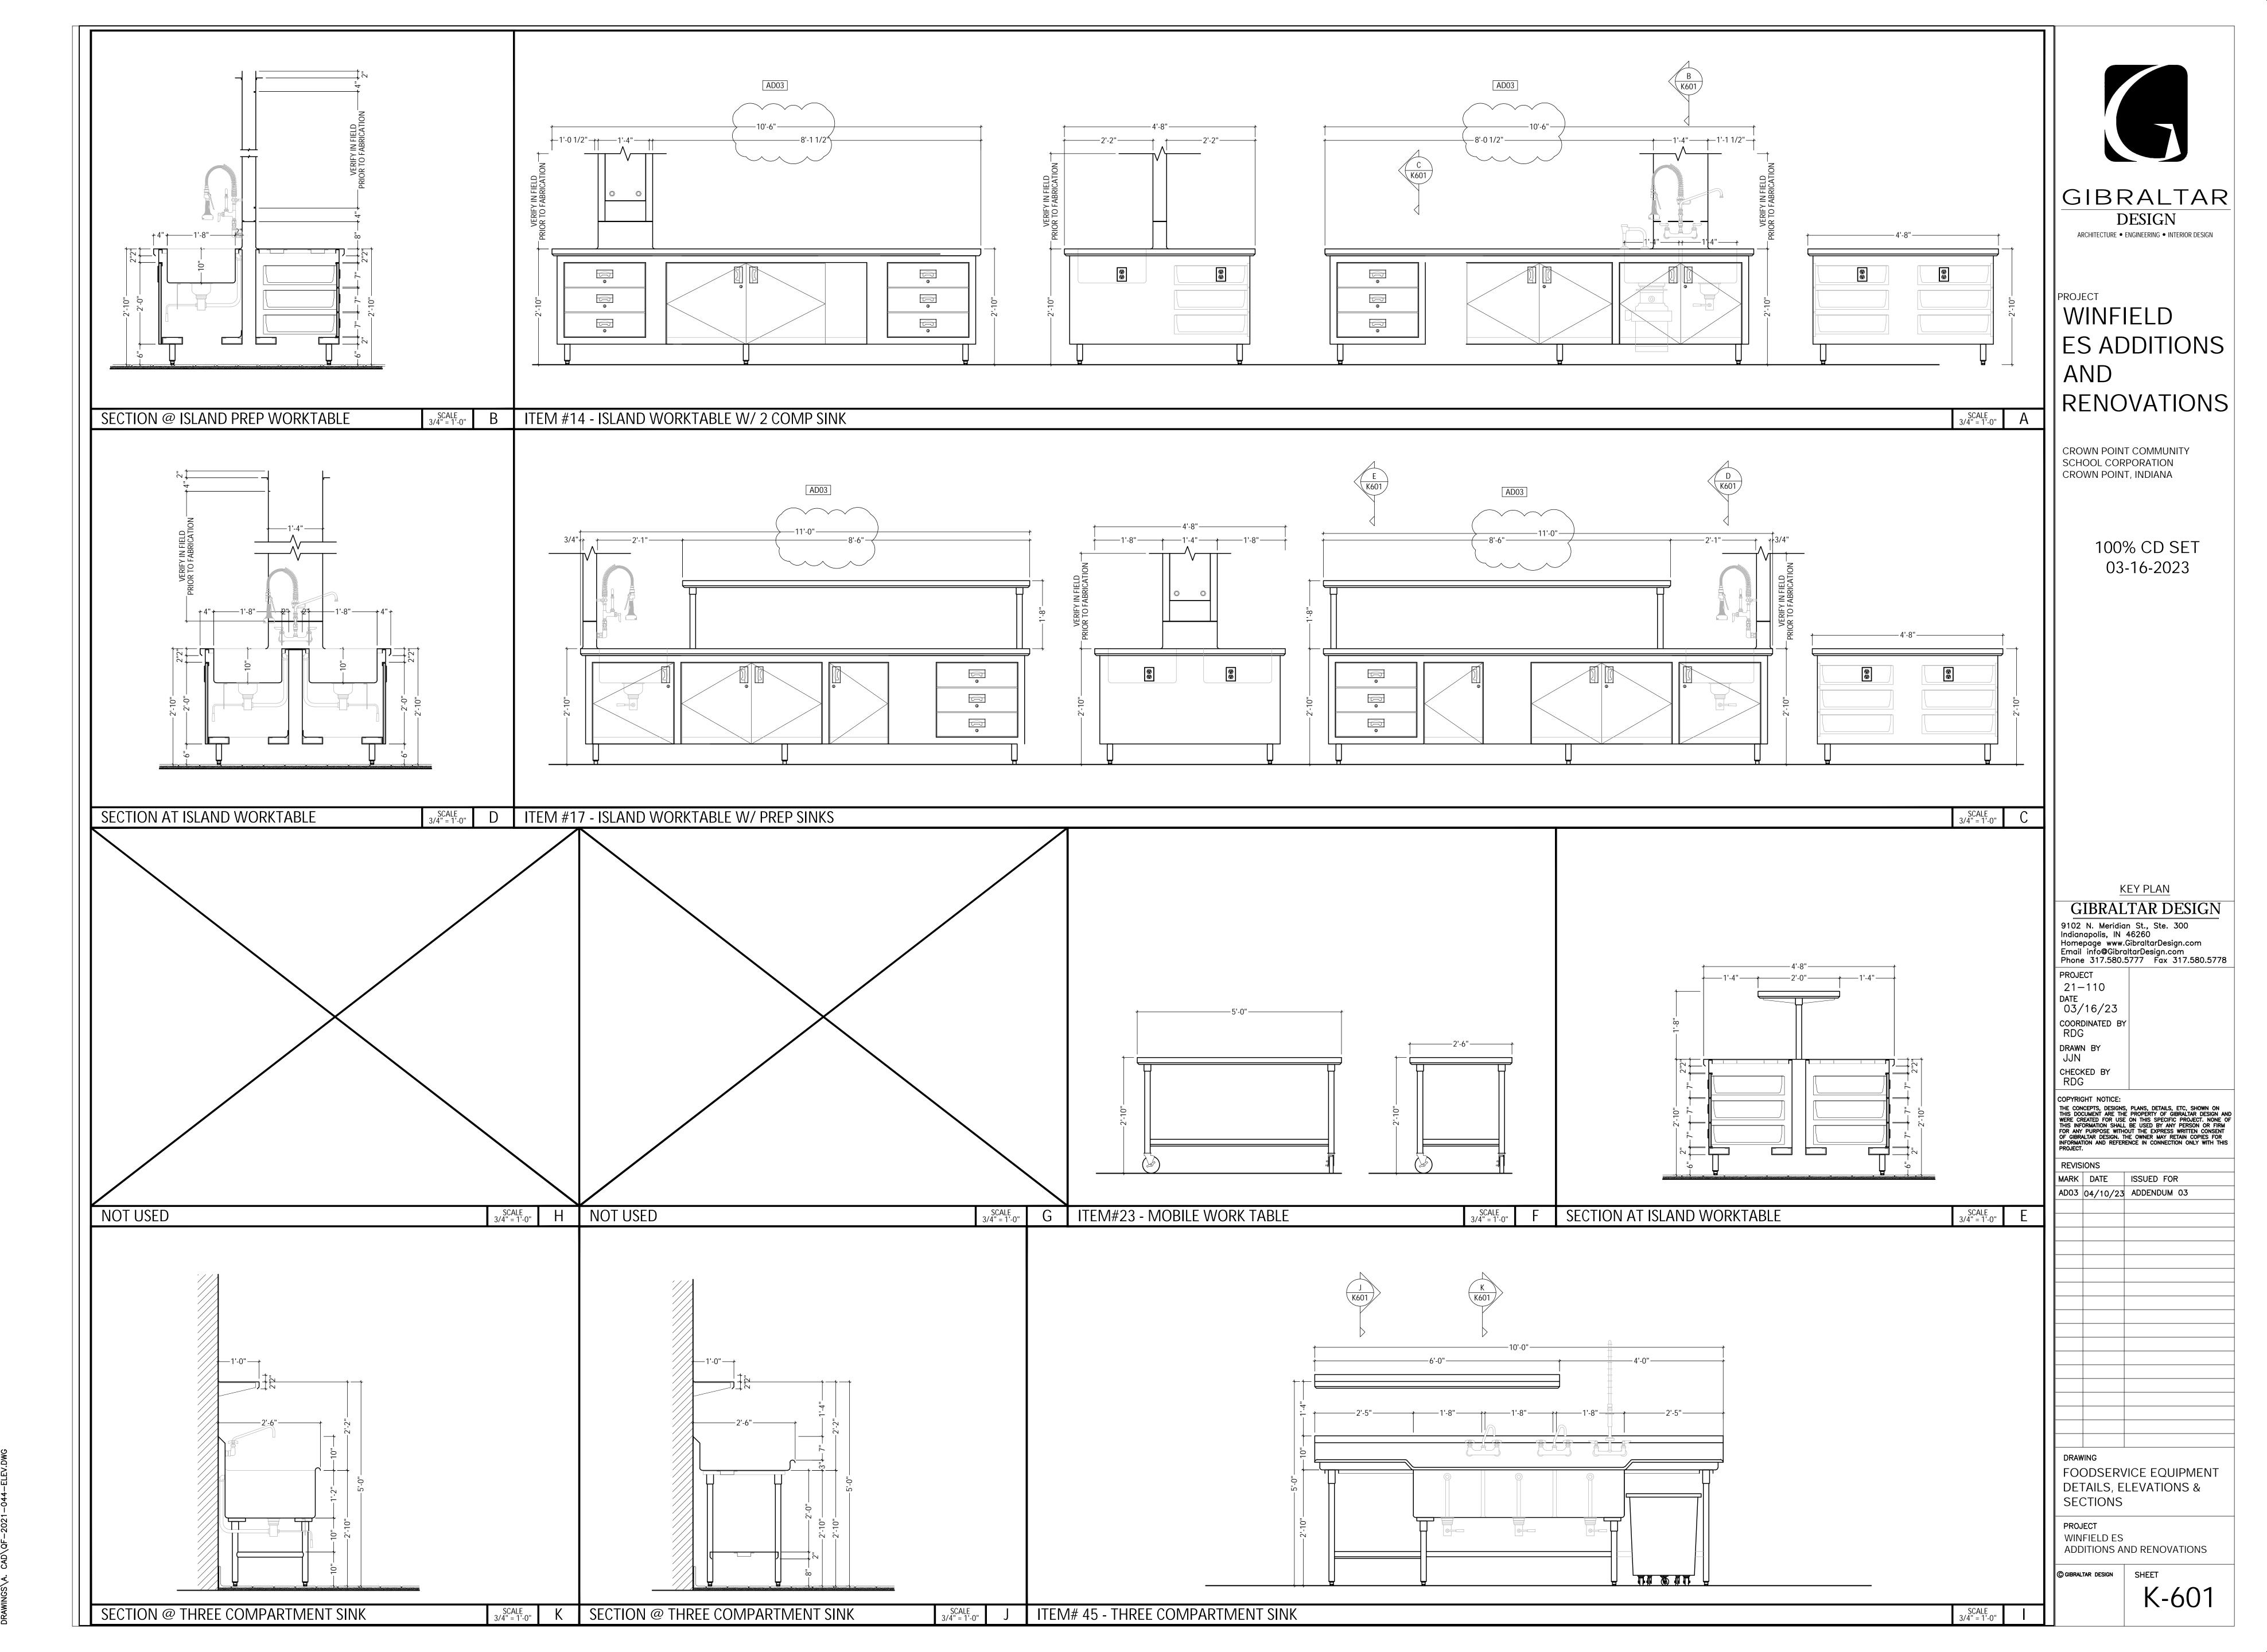


Monday, 4/10/2023 — 11:22 AM — LAST SAVED BY:JONATHAN NIKIEL G:\SHARED DRIVES\RDG PROJECT FOLDER (2021)\2021-044— GIBRALTAR — WINFIELD ES\3.

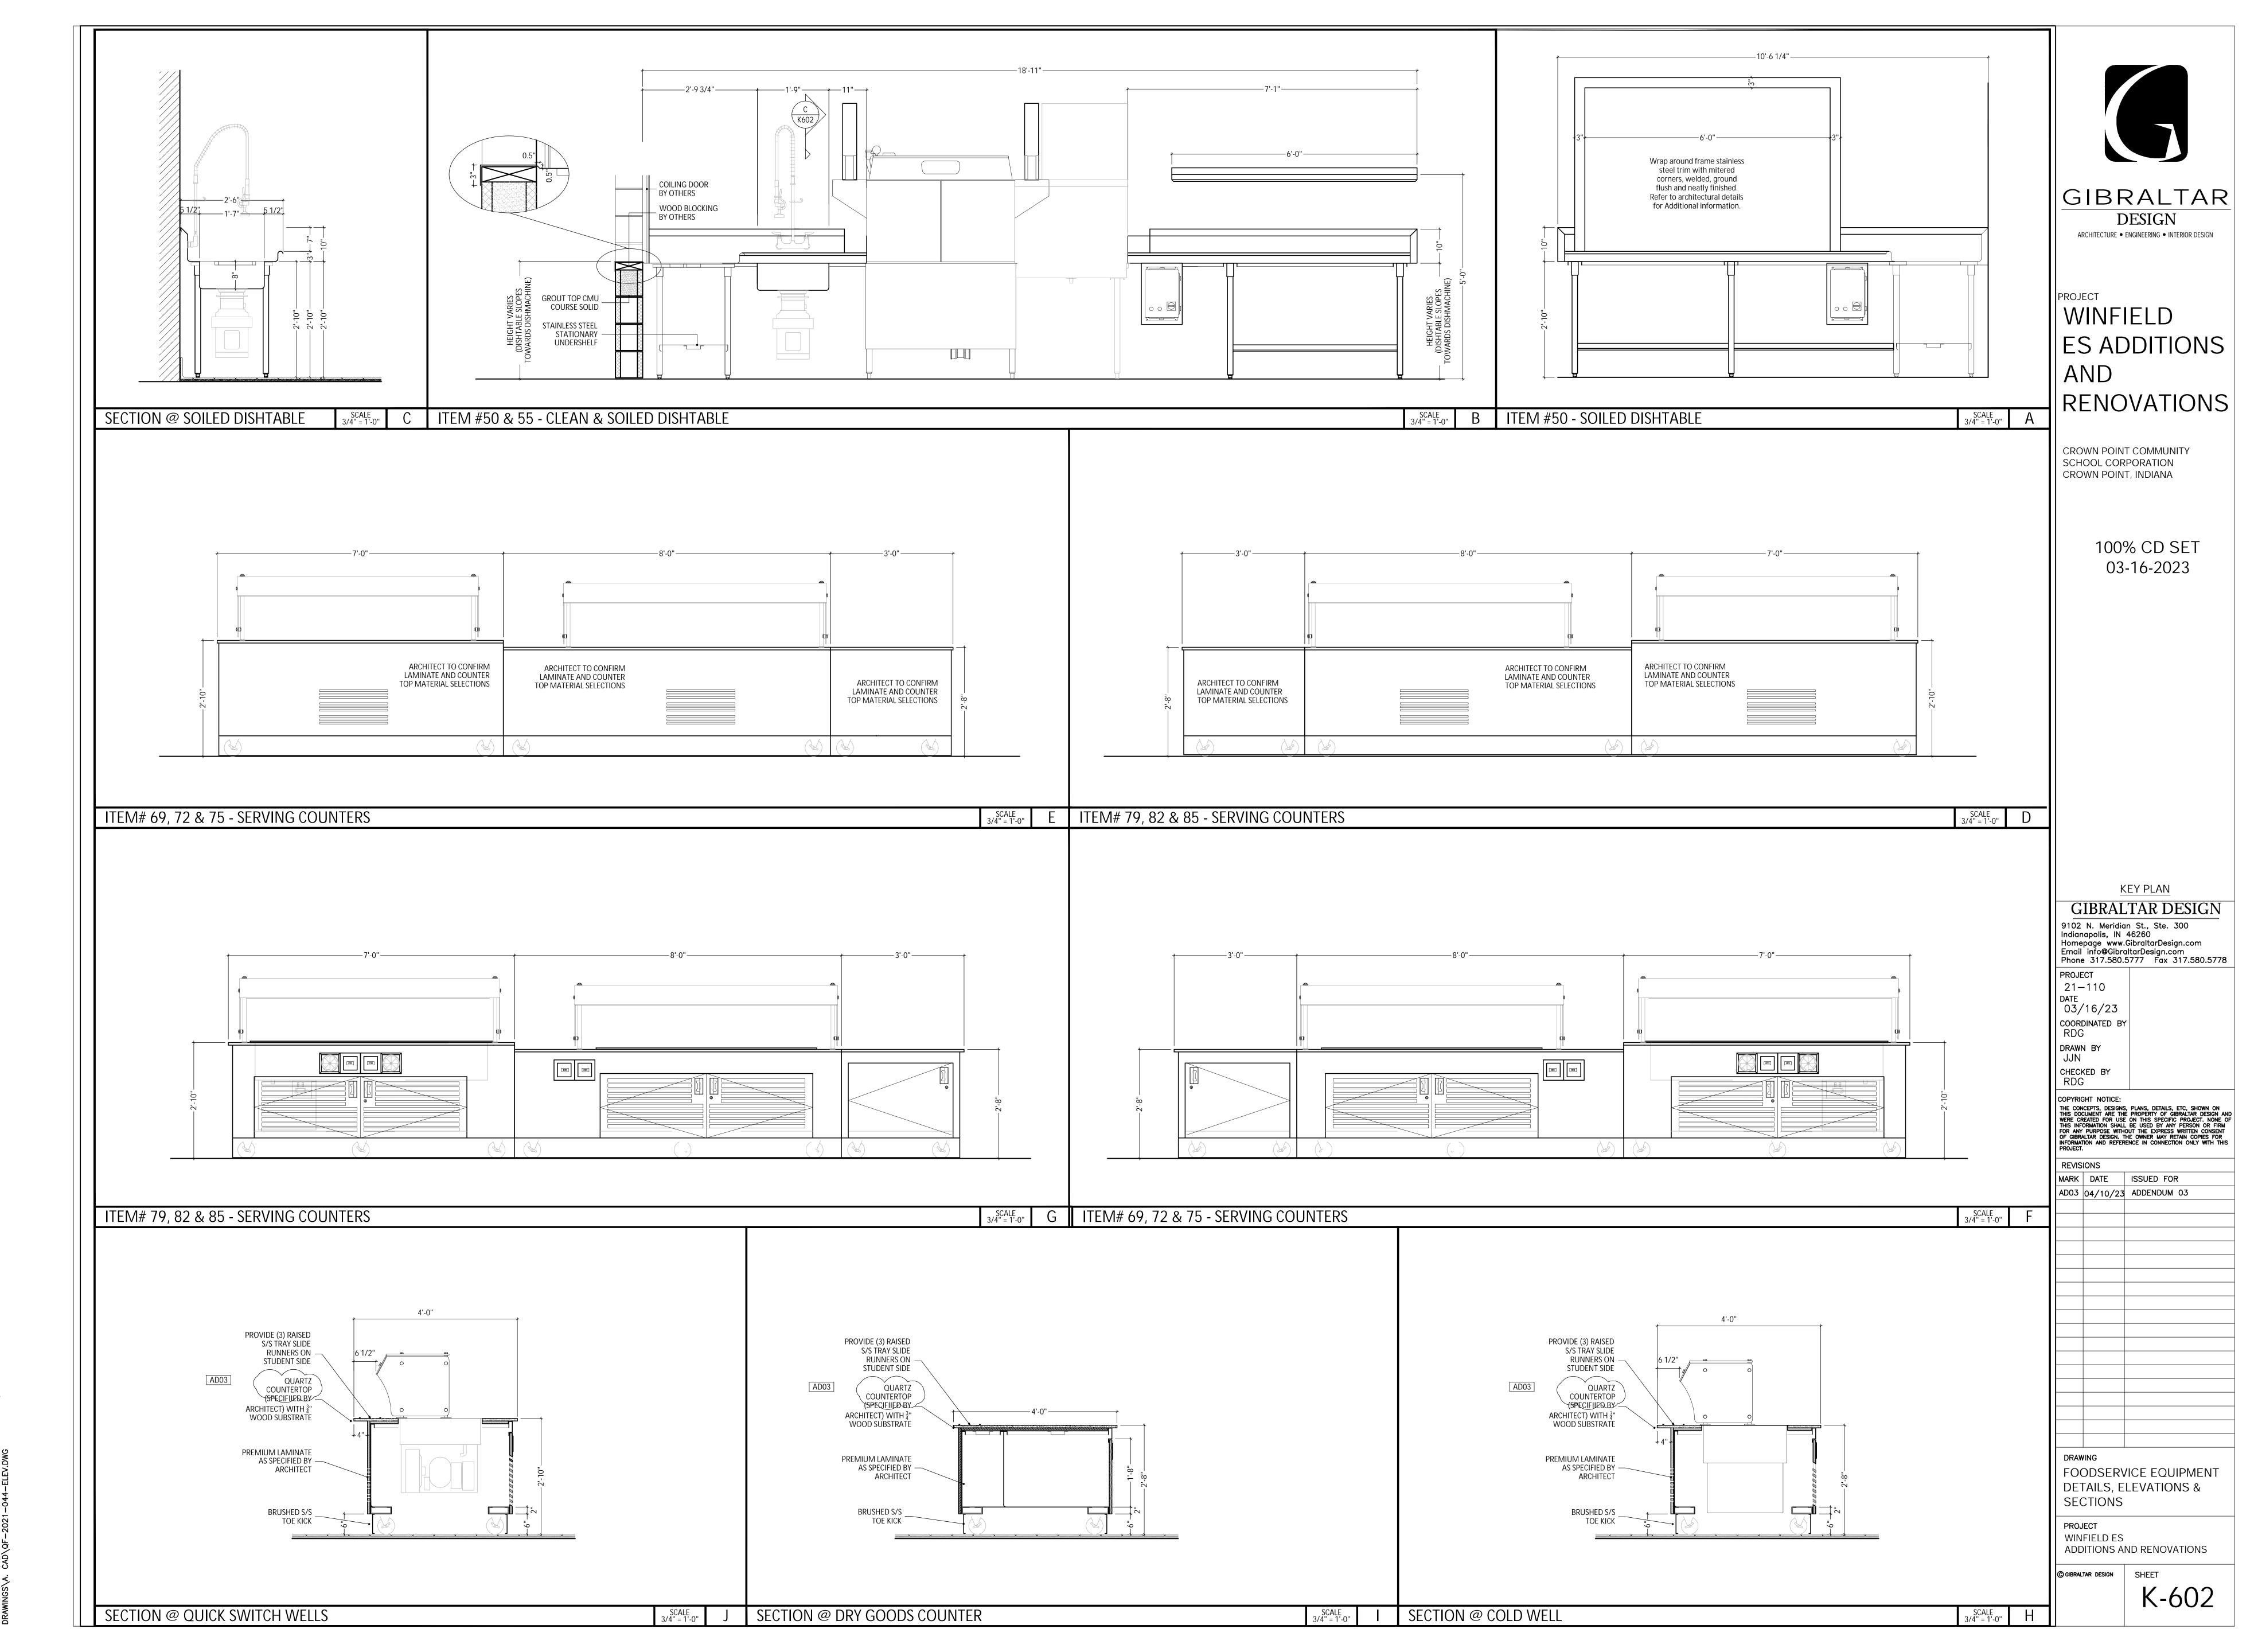

Monday, 4/10/2023 — 11:23 AM — LAST SAVED BY:JONATHAN NIKI G:\SHARED DRIVES\RDG PROJECT DATA\RDG PROJECT FOLDER (2021)\2021—044— GIBRALTAR — WINFIELD ES\3. DRAWINGS\A. CAD\QF—2021—044—ELEV.DWG

Monday, 4/10/2023 — 11:23 AM — LAST SAVED BY:JONA'G:\SHARED DRIVES\RDG PROJECT DATA\RDG PROJECT FOLDER (2021)\2021—044— GIBRALTAR — WINFIELD ES\3. DRAWINGS\A. CAD\QF—2021—044—ELEV.DWG

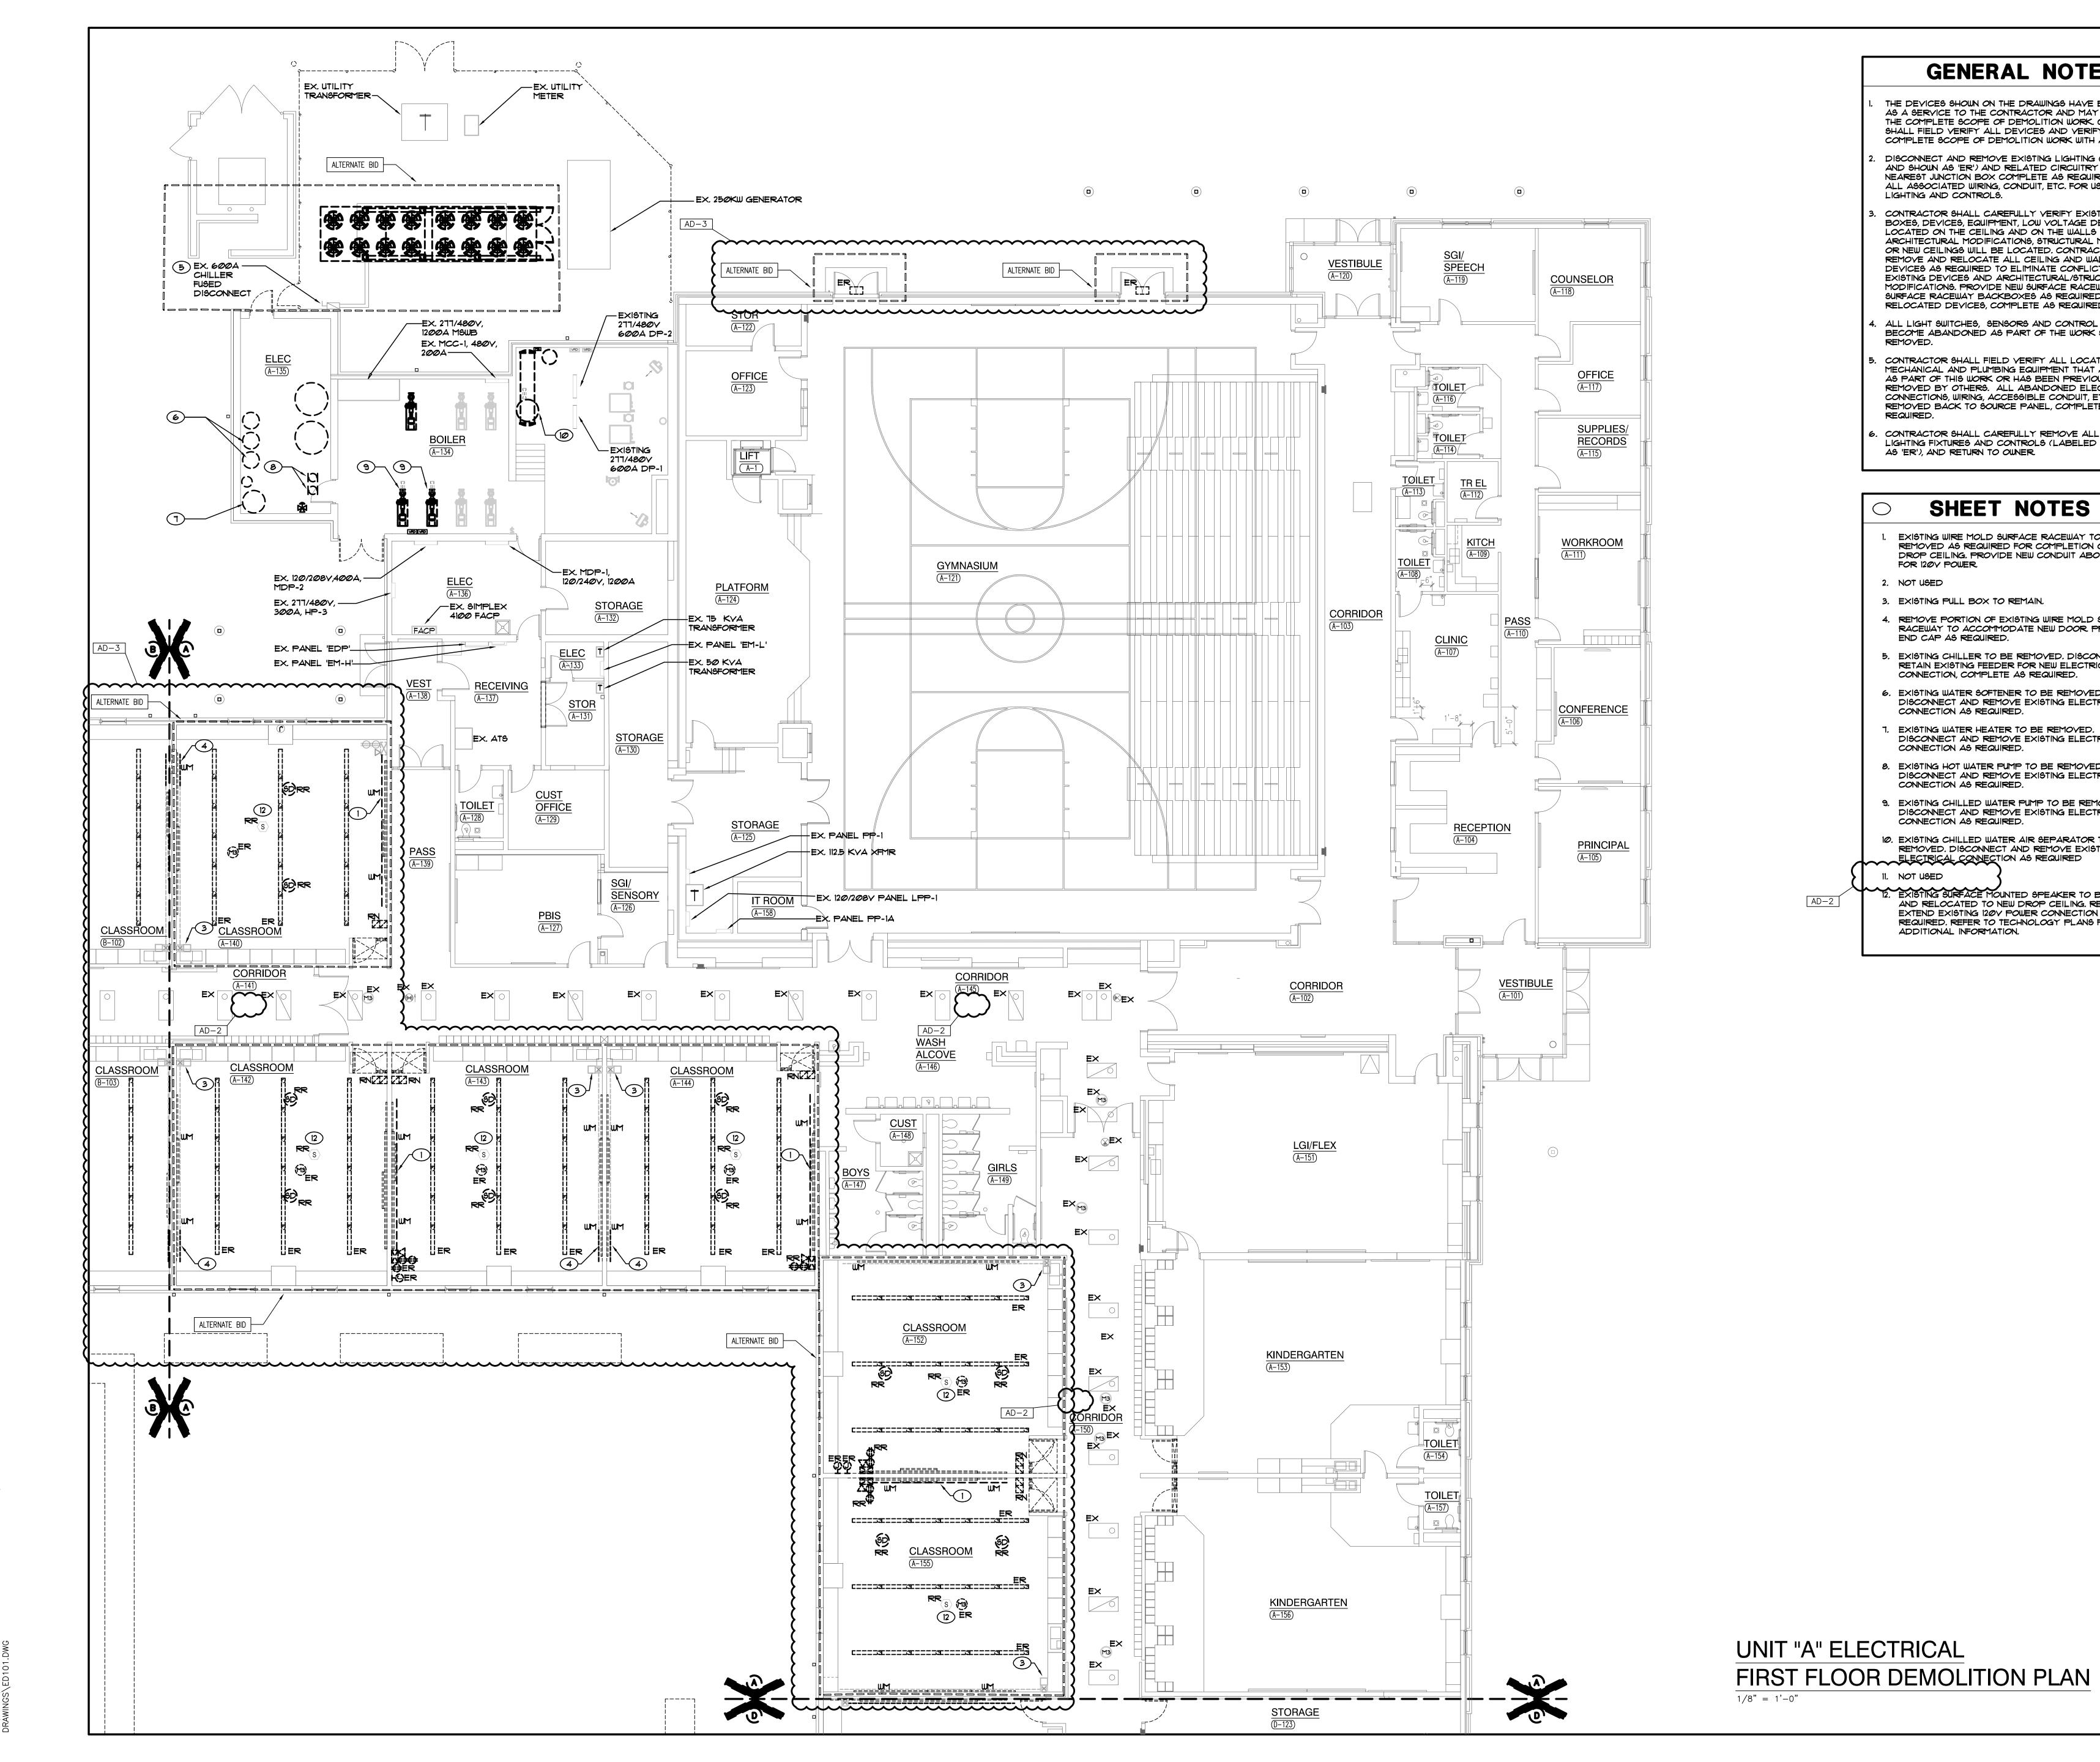

GENERAL NOTES

- THE DEVICES SHOWN ON THE DRAWINGS HAVE BEEN LOCATED AS A SERVICE TO THE CONTRACTOR AND MAY NOT INDICATE THE COMPLETE SCOPE OF DEMOLITION WORK. CONTRACTOR SHALL FIELD VERIFY ALL DEVICES AND VERIFY THE COMPLETE SCOPE OF DEMOLITION WORK WITH ARCHITECT.
- DISCONNECT AND REMOVE EXISTING LIGHTING (LABELED AND SHOWN AS 'ER') AND RELATED CIRCUITRY BACK TO NEAREST JUNCTION BOX COMPLETE AS REQUIRED. RETAIN ALL ASSOCIATED WIRING, CONDUIT, ETC. FOR USE WITH NEW LIGHTING AND CONTROLS.
- CONTRACTOR SHALL CAREFULLY VERIFY EXISTING CONDUITS, BOXES, DEVICES, EQUIPMENT, LOW YOLTAGE DEVICES, ETC. LOCATED ON THE CEILING AND ON THE WALLS IN WHICH ARCHITECTURAL MODIFICATIONS, STRUCTURAL MODIFICATION OR NEW CEILINGS WILL BE LOCATED. CONTRACTOR SHALL REMOVE AND RELOCATE ALL CEILING AND WALL MOUNTED DEVICES AS REQUIRED TO ELIMINATE CONFLICTS BETWEEN EXISTING DEVICES AND ARCHITECTURAL/STRUCTURAL MODIFICATIONS. PROVIDE NEW SURFACE RACEWAY AND SURFACE RACEWAY BACKBOXES AS REQUIRED FOR ALL RELOCATED DEVICES, COMPLETE AS REQUIRED.
- ALL LIGHT SWITCHES, SENSORS AND CONTROL DEVICES THAT BECOME ABANDONED AS PART OF THE WORK SHALL BE
- . CONTRACTOR SHALL FIELD VERIFY ALL LOCATIONS OF MECHANICAL AND PLUMBING EQUIPMENT THAT ARE REMOVED AS PART OF THIS WORK OR HAS BEEN PREVIOUSLY REMOVED BY OTHERS. ALL ABANDONED ELECTRICAL CONNECTIONS, WIRING, ACCESSIBLE CONDUIT, ETC. ARE TO BE REMOVED BACK TO SOURCE PANEL, COMPLETE AS REQUIRED.
- CONTRACTOR SHALL CAREFULLY REMOVE ALL CLASSROOM LIGHTING FIXTURES AND CONTROLS (LABELED AND SHOWN AS 'ER'), AND RETURN TO OWNER.

SHEET NOTES

EXISTING WIRE MOLD SURFACE RACEWAY TO BE REMOVED AS REQUIRED FOR COMPLETION OF NEW DROP CEILING. PROVIDE NEW CONDUIT ABOVE CEILING FOR 120Y POWER

- 2. NOT USED
- 3. EXISTING PULL BOX TO REMAIN.
- 4. REMOVE PORTION OF EXISTING WIRE MOLD SURFACE RACEWAY TO ACCOMMODATE NEW DOOR PROVIDE NEW END CAP AS REQUIRED.
- 5. EXISTING CHILLER TO BE REMOVED. DISCONNECT AND RETAIN EXISTING FEEDER FOR NEW ELECTRICAL CONNECTION, COMPLETE AS REQUIRED.
- 6. EXISTING WATER SOFTENER TO BE REMOVED. DISCONNECT AND REMOVE EXISTING ELECTRICAL CONNECTION AS REQUIRED.
- 1. EXISTING WATER HEATER TO BE REMOVED. DISCONNECT AND REMOVE EXISTING ELECTRICAL CONNECTION AS REQUIRED.
- 8. EXISTING HOT WATER PUMP TO BE REMOVED. DISCONNECT AND REMOVE EXISTING ELECTRICAL CONNECTION AS REQUIRED.
- 9. EXISTING CHILLED WATER PUMP TO BE REMOVED. DISCONNECT AND REMOVE EXISTING ELECTRICAL
- CONNECTION AS REQUIRED. 10. EXISTING CHILLED WATER AIR SEPARATOR TO BE
- REMOVED. DISCONNECT AND REMOVE EXISTING
- ELECTRICAL CONNECTION AS REQUIRED

. EXISTING SURFACE MOUNTED SPEAKER TO BE REMOVED AND RELOCATED TO NEW DROP CEILING. REVISE AND EXTEND EXISTING 120Y POWER CONNECTION AS REQUIRED. REFER TO TECHNOLOGY PLANS FOR ADDITIONAL INFORMATION.

GIBRALTAR


DESIGN ARCHITECTURE ◆ ENGINEERING ◆ INTERIOR DESIGN

(219) 924-8400

WINFIELD **ELEMENTARY** SCHOOL 2023 ADDITIONS, RENOVATIONS, AND RELATED WORK

ROJECT

CROWN POINT COMMUNITY SCHOOL CORPORATION CROWN POINT, INDIANA

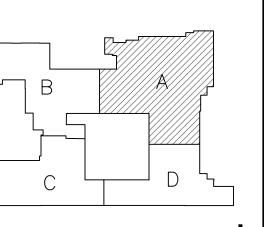

FIRST FLOOR KEY PLAN GIBRALTAR DESIGN

9102 N. Meridian St., Ste. 300 ndianapolis, IN 46260 Homepage www.GibraltarDesign.com Email info@GibraltarDesign.com

Phone 317.580.5777 Fax 317.580.5778

COORDINATED

DRAWN BY CHECKED BY

COPYRIGHT NOTICE: THE CONCEPTS, DESIGNS, PLANS, DETAILS, ETC, SHOWN ON THIS DOCUMENT ARE THE PROPERTY OF GIBRALTAR DESIGN AND WERE CREATED FOR USE ON THIS SPECIFIC PROJECT. NONE OF THIS INFORMATION SHALL BE USED BY ANY PERSON OR FIRM FOR ANY PURPOSE WITHOUT THE EXPRESS WRITTEN CONSENT OF GIBRALTAR DESIGN. THE OWNER MAY RETAIN COPIES FOR INFORMATION AND REFERENCE IN CONNECTION ONLY WITH THIS PROJECT

MARK DATE ISSUED FOR AD-2 | 04/06/23 | ADDENDUM NO. 02AD-3 | 04/10/23 | ADDENDUM NO. 03

UNIT "A" ELECTRICAL

FIRST FLOOR DEMOLITION PLAN WINFIELD ELEMENTARY SCHOOL

2023 ADDITIONS, RENOVATIONS, AND RELATED WORK

A

ED101

GENERAL NOTES

- THE DEVICES SHOWN ON THE DRAWINGS HAVE BEEN LOCATED AS A SERVICE TO THE CONTRACTOR AND MAY NOT INDICATE THE COMPLETE SCOPE OF DEMOLITION WORK, CONTRACTOR SHALL FIELD VERIFY ALL DEVICES AND VERIFY THE COMPLETE SCOPE OF DEMOLITION WORK WITH ARCHITECT.
- DISCONNECT AND REMOVE EXISTING LIGHTING (LABELED AND SHOWN AS 'ER') AND RELATED CIRCUITRY BACK TO NEAREST JUNCTION BOX COMPLETE AS REQUIRED. RETAIN ALL ASSOCIATED WIRING, CONDUIT, ETC. FOR USE WITH NEW LIGHTING AND CONTROLS.
- CONTRACTOR SHALL CAREFULLY VERIFY EXISTING CONDUITS, BOXES, DEVICES, EQUIPMENT, LOW YOLTAGE DEVICES, ETC. LOCATED ON THE CEILING AND ON THE WALLS IN WHICH ARCHITECTURAL MODIFICATIONS, STRUCTURAL MODIFICATION OR NEW CEILINGS WILL BE LOCATED. CONTRACTOR SHALL REMOVE AND RELOCATE ALL CEILING AND WALL MOUNTED DEVICES AS REQUIRED TO ELIMINATE CONFLICTS BETWEEN EXISTING DEVICES AND ARCHITECTURAL/STRUCTURAL MODIFICATIONS. PROVIDE NEW SURFACE RACEWAY AND SURFACE RACEWAY BACKBOXES AS REQUIRED FOR ALL RELOCATED DEVICES, COMPLETE AS REQUIRED.
- ALL LIGHT SWITCHES, SENSORS AND CONTROL DEVICES THAT BECOME ABANDONED AS PART OF THE WORK SHALL BE
- . CONTRACTOR SHALL FIELD VERIFY ALL LOCATIONS OF MECHANICAL AND PLUMBING EQUIPMENT THAT ARE REMOVED AS PART OF THIS WORK OR HAS BEEN PREVIOUSLY REMOVED BY OTHERS. ALL ABANDONED ELECTRICAL CONNECTIONS, WIRING, ACCESSIBLE CONDUIT, ETC. ARE TO BE REMOVED BACK TO SOURCE PANEL, COMPLETE AS REQUIRED.
- . CONTRACTOR SHALL CAREFULLY REMOVE ALL CLASSROOM LIGHTING FIXTURES AND CONTROLS (LABELED AND SHOWN AS 'ER'), AND RETURN TO OWNER.

SHEET NOTES

- EXISTING WIRE MOLD SURFACE RACEWAY TO BE REMOVED AS REQUIRED FOR COMPLETION OF NEW DROP CEILING. PROVIDE NEW CONDUIT ABOVE CEILING FOR 120Y POWER.
- EXISTING ROOF TOP UNIT TO BE REMOVED. DISCONNECT AND REMOVE CONDUIT AND WIRING BACK TO SOURCE PANEL. WHERE EXISTING CIRCUITRY MATCHES NEW CIRCUITING AND WIRING REQUIREMENTS PER NEW MECHANICAL EQUIPMENT SCHEDULE, EXISTING WIRING AND CONDUIT MAY BE REUSED TO RECONNECT NEW EQUIPMENT. VERIFY EXACT CONDITIONS AND REQUIREMENTS IN FIELD, COMPLETE AS REQUIRED.
- 3. EXISTING PULL BOX TO REMAIN.
- 4. REMOVE PORTION OF EXISTING WIRE MOLD SURFACE RACEWAY TO ACCOMMODATE NEW DOOR, PROVIDE NEW END CAP AS REQUIRED.
- 5. EXISTING MAINTENANCE BUILDING TO BE DEMOLISHED. DISCONNECT AND REMOVE EXISTING ELECTRICAL CONNECTIONS. VERIFY EXACT CONDITIONS AND REQUIREMENTS IN FIELD, COMPLETE AS REQUIRED.
- 6. EXISTING UNIT VENTILATOR TO BE REMOVED. DISCONNECT AND REMOVE EXISTING ELECTRICAL CONNECTION AS ~ PEOURED ~~
- . NOT USED

8. EXISTING SURFACE MOUNTED SPEAKER TO BE REMOVED AND RELOCATED TO NEW DROP CEILING. REVISE AND EXTEND EXISTING 120Y POWER CONNECTION AS REQUIRED. REFER TO TECHNOLOGY PLANS FOR ADDITIONAL INFORMATION.

. EXISTING PAYILION TO BE REMOVED AND RELOCATED. REMOVE AND RELOCATE EXISTING POWER AND LIGHTING

TO NEW LOCATION OF PAYILION. REFER TO CIVIL DRAWINGS FOR EXACT LOCATION OF NEW PAYILION.

GIBRALTAR


DESIGN ARCHITECTURE • ENGINEERING • INTERIOR DESIGN

(219) 924-8400 www.milliesengineeringgroup.com

ADDITIONS, RENOVATIONS, AND RELATED

CROWN POINT COMMUNITY SCHOOL CORPORATION CROWN POINT, INDIANA

WORK

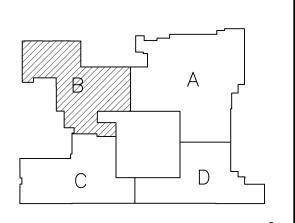

FIRST FLOOR KEY PLAN GIBRALTAR DESIGN

9102 N. Meridian St., Ste. 300 ndianapolis, IN 46260 Homepage www.GibraltarDesign.com Email info@GibraltarDesign.com

Phone 317.580.5777 Fax 317.580.5778 COORDINATED

DRAWN BY CHECKED BY

THE CONCEPTS, DESIGNS, PLANS, DETAILS, ETC, SHOWN ON THIS DOCUMENT ARE THE PROPERTY OF GIBRALTAR DESIGN AND WERE CREATED FOR USE ON THIS SPECIFIC PROJECT. NONE OF THIS INFORMATION SHALL BE USED BY ANY PERSON OR FIRM FOR ANY PURPOSE WITHOUT THE EXPRESS WRITTEN CONSENT OF GIBRALTAR DESIGN. THE OWNER MAY RETAIN COPIES FOR INFORMATION AND REFERENCE IN CONNECTION ONLY WITH THIS PROJECT

MARK DATE ISSUED FOR AD-1 | 03/30/23 | ADDENDUM NO. 01AD-2 | 04/06/23 | ADDENDUM NO. 02AD-3 | 04/10/23 | ADDENDUM NO. 03


UNIT "B" ELECTRICAL FIRST FLOOR DEMOLITION PLAN

WINFIELD ELEMENTARY SCHOOL 2023 ADDITIONS, RENOVATIONS, AND RELATED WORK



ED102

UNIT "B" ELECTRICAL FIRST FLOOR DEMOLITION PLAN SCALE: 1/8" = 1'-0"

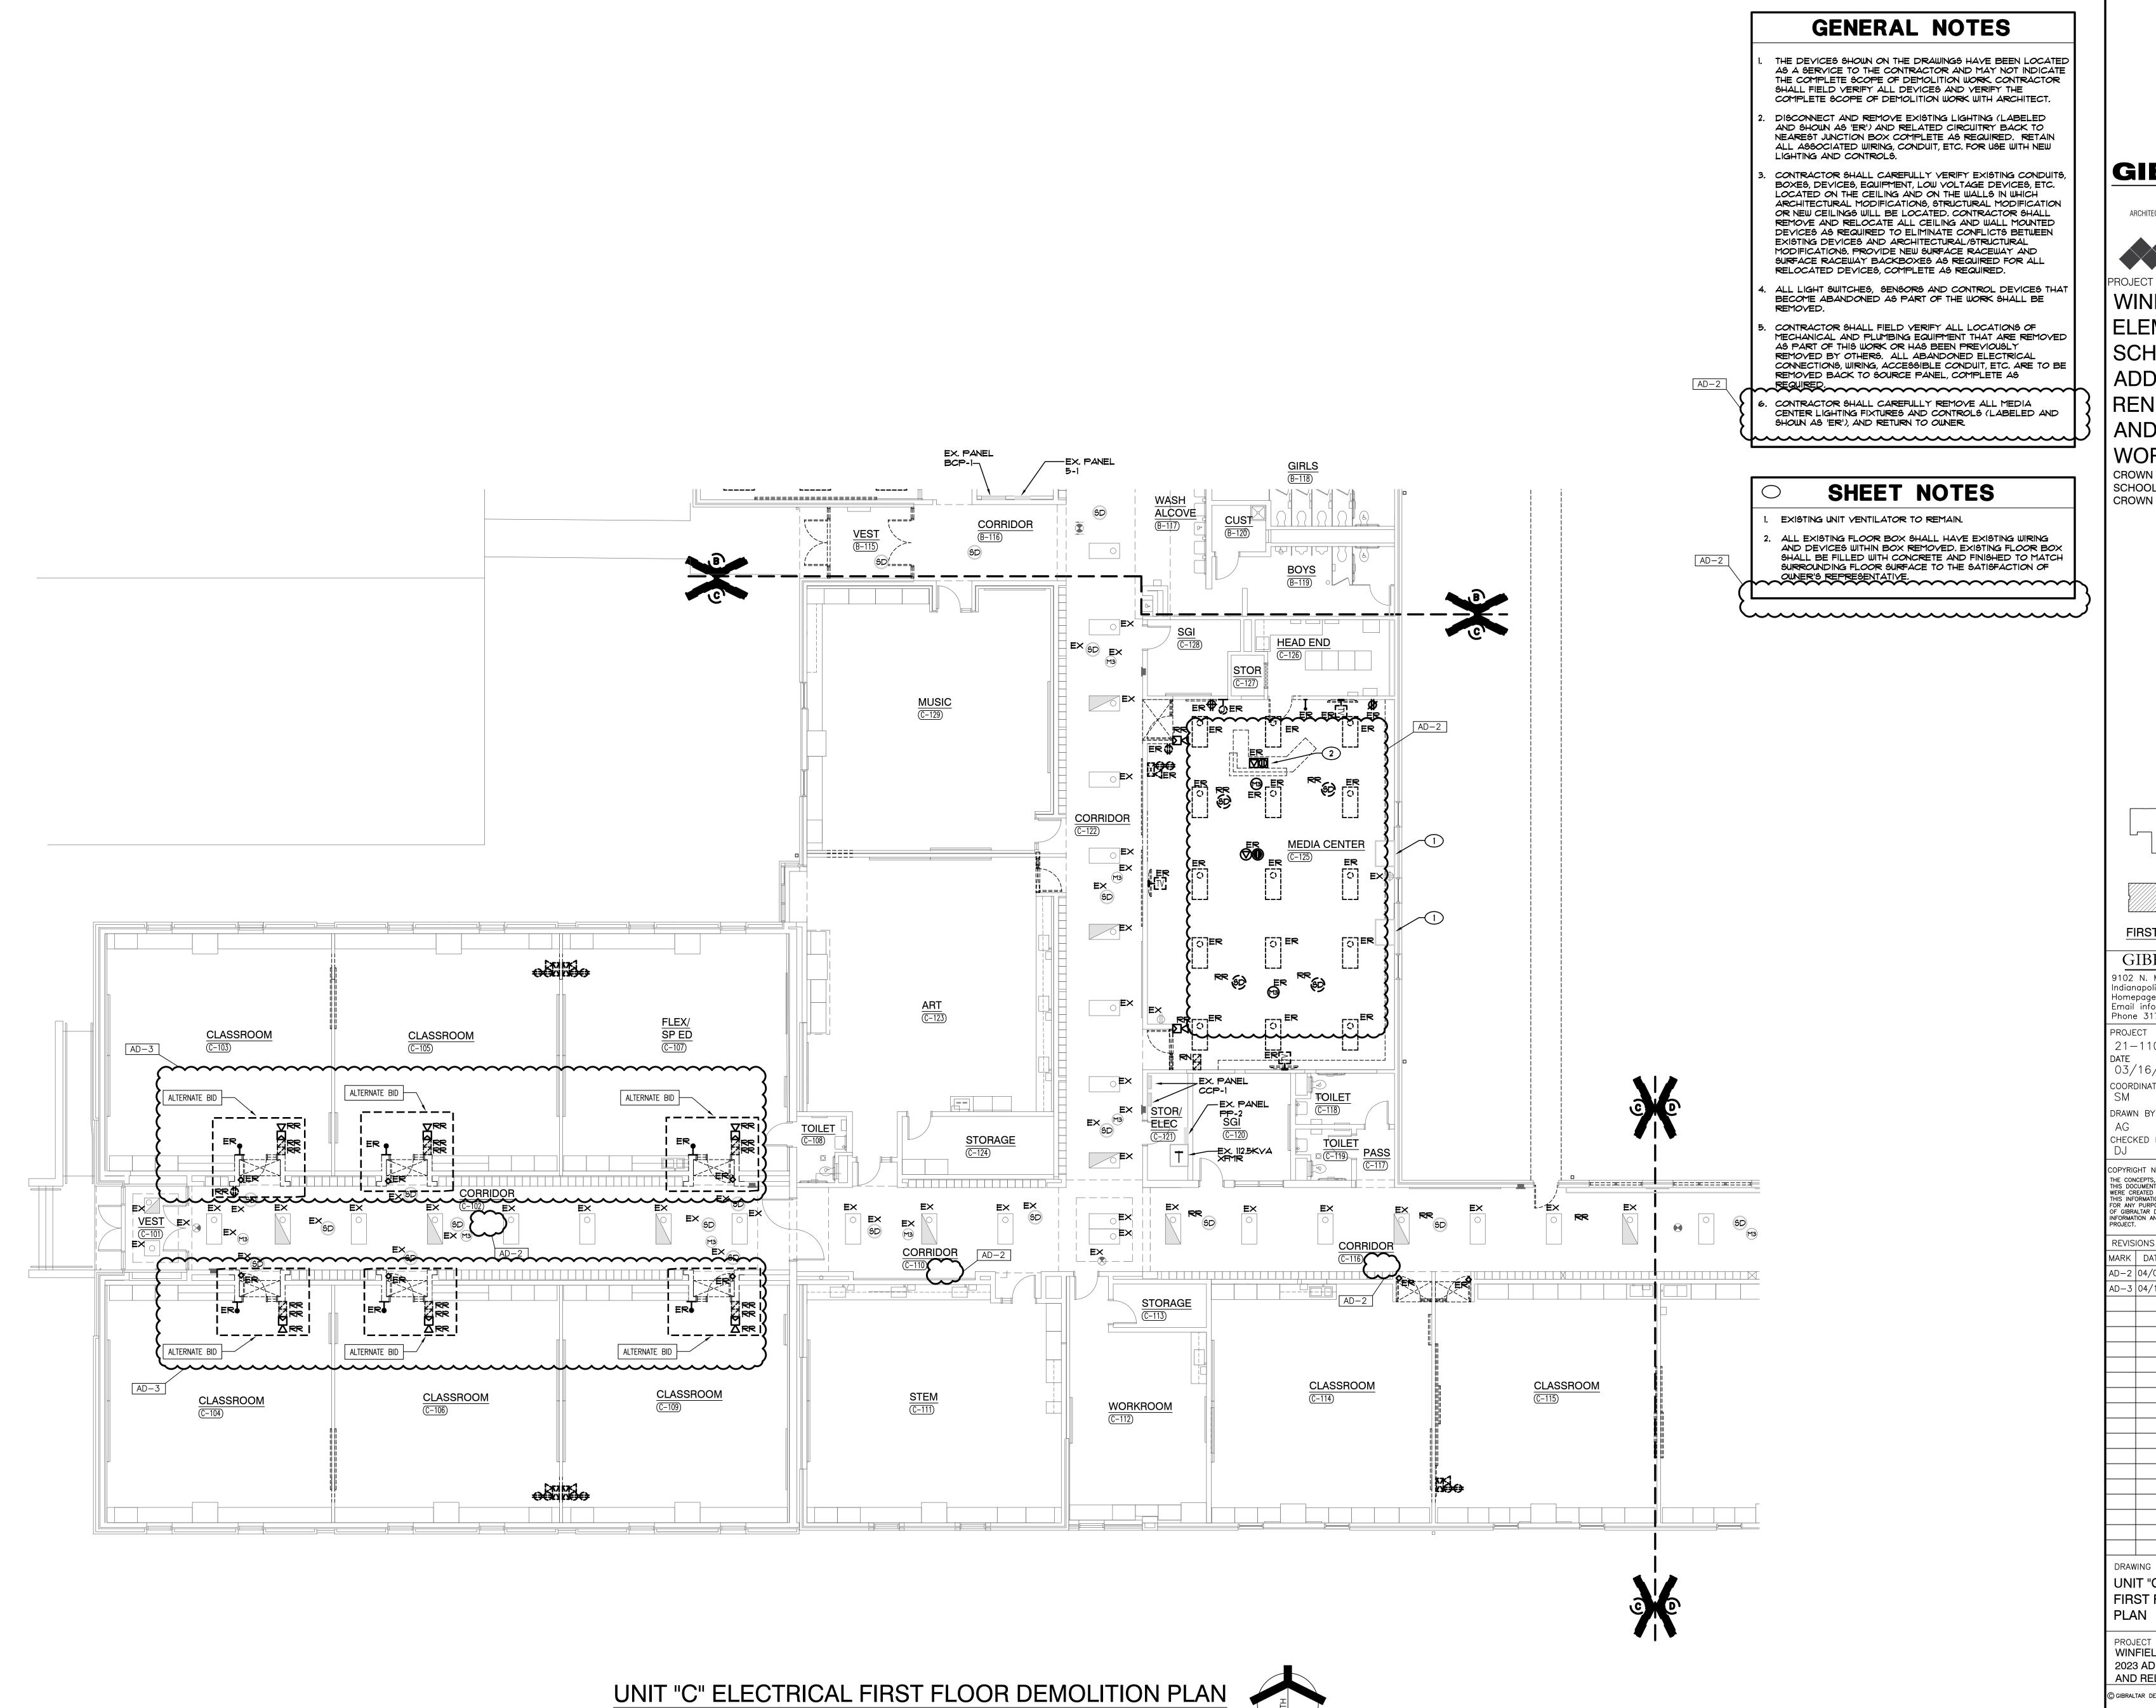

GIBRALTAR DESIGN ARCHITECTURE • ENGINEERING • INTERIOR DESIGN

> (219) 924-8400 www.milliesengineeringgroup.com

ELEMENTARY ADDITIONS, AND RELATED

CROWN POINT COMMUNITY SCHOOL CORPORATION CROWN POINT, INDIANA

FIRST FLOOR KEY PLAN GIBRALTAR DESIGN

9102 N. Meridian St., Ste. 300 Indianapolis, IN 46260 Homepage www.GibraltarDesign.com Email info@GibraltarDesign.com Phone 317.580.5777 Fax 317.580.5778

COORDINATED

THE CONCEPTS, DESIGNS, PLANS, DETAILS, ETC, SHOWN ON THIS DOCUMENT ARE THE PROPERTY OF GIBRALTAR DESIGN AND WERE CREATED FOR USE ON THIS SPECIFIC PROJECT. NONE OF THIS INFORMATION SHALL BE USED BY ANY PERSON OR FIRM FOR ANY PURPOSE WITHOUT THE EXPRESS WRITTEN CONSENT OF GIBRALTAR DESIGN. THE OWNER MAY RETAIN COPIES FOR INFORMATION AND REFERENCE IN CONNECTION ONLY WITH THIS PROJECT.

MARK DATE ISSUED FOR AD-2 | 04/06/23 | ADDENDUM NO. 02AD-3 | 04/10/23 | ADDENDUM NO. 03

UNIT "C" ELECTRICAL FIRST FLOOR DEMOLITION PLAN

WINFIELD ELEMENTARY SCHOOL 2023 ADDITIONS, RENOVATIONS, AND RELATED WORK

ED103

GENERAL NOTES

- THE DEVICES SHOWN ON THE DRAWINGS HAVE BEEN LOCATED AS A SERVICE TO THE CONTRACTOR AND MAY NOT INDICATE THE COMPLETE SCOPE OF DEMOLITION WORK, CONTRACTOR SHALL FIELD VERIFY ALL DEVICES AND VERIFY THE COMPLETE SCOPE OF DEMOLITION WORK WITH ARCHITECT.
- DISCONNECT AND REMOVE EXISTING LIGHTING (LABELED AND SHOWN AS 'ER') AND RELATED CIRCUITRY BACK TO NEAREST JUNCTION BOX COMPLETE AS REQUIRED. RETAIN ALL ASSOCIATED WIRING, CONDUIT, ETC. FOR USE WITH NEW LIGHTING AND CONTROLS.
- CONTRACTOR SHALL CAREFULLY VERIFY EXISTING CONDUITS, BOXES, DEVICES, EQUIPMENT, LOW YOLTAGE DEVICES, ETC. LOCATED ON THE CEILING AND ON THE WALLS IN WHICH ARCHITECTURAL MODIFICATIONS, STRUCTURAL MODIFICATION OR NEW CEILINGS WILL BE LOCATED. CONTRACTOR SHALL REMOVE AND RELOCATE ALL CEILING AND WALL MOUNTED DEVICES AS REQUIRED TO ELIMINATE CONFLICTS BETWEEN EXISTING DEVICES AND ARCHITECTURAL/STRUCTURAL MODIFICATIONS. PROVIDE NEW SURFACE RACEWAY AND SURFACE RACEWAY BACKBOXES AS REQUIRED FOR ALL RELOCATED DEVICES, COMPLETE AS REQUIRED.
- . ALL LIGHT SWITCHES, SENSORS AND CONTROL DEVICES THAT BECOME ABANDONED AS PART OF THE WORK SHALL BE REMOVED.
- 5. CONTRACTOR SHALL FIELD VERIFY ALL LOCATIONS OF MECHANICAL AND PLUMBING EQUIPMENT THAT ARE REMOVED AS PART OF THIS WORK OR HAS BEEN PREVIOUSLY REMOVED BY OTHERS. ALL ABANDONED ELECTRICAL CONNECTIONS, WIRING, ACCESSIBLE CONDUIT, ETC. ARE TO BE REMOVED BACK TO SOURCE PANEL, COMPLETE AS REQUIRED.
- . CONTRACTOR SHALL CAREFULLY REMOVE ALL CLASSROOM LIGHTING FIXTURES AND CONTROLS (LABELED AND SHOWN AS 'ER'), AND RETURN TO OWNER.

SHEET NOTES

- EXISTING WIRE MOLD SURFACE RACEWAY TO BE REMOVED AS REQUIRED FOR COMPLETION OF NEW DROP CEILING. PROVIDE NEW CONDUIT ABOVE CEILING FOR 120Y POWER
- 2. EXISTING PULL BOX TO REMAIN.
- REFER TO TECHNOLOGY PLANS FOR ADDITIONAL INFORMATION.

3. EXISTING SURFACE MOUNTED SPEAKER TO BE REMOVED AND RELOCATED TO NEW DROP CEILING. REVISE AND EXTEND EXISTING 120Y POWER CONNECTION AS REQUIRED.

FIRST FLOOR KEY PLAN GIBRALTAR DESIGN 9102 N. Meridian St., Ste. 300

GIBRALTAR

DESIGN

ARCHITECTURE • ENGINEERING • INTERIOR DESIGN

PROJECT

WINFIELD

ELEMENTARY

RENOVATIONS,

AND RELATED

CROWN POINT COMMUNITY SCHOOL CORPORATION

CROWN POINT, INDIANA


ADDITIONS,

(219) 924-8400

www.milliesengineeringgroup.com

Indianapolis, IN 46260
Homepage www.GibraltarDesign.com
Email info@GibraltarDesign.com
Phone 317.580.5777 Fax 317.580.5778

DRAWN B'

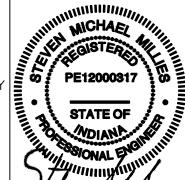

THE CONCEPTS, DESIGNS, PLANS, DETAILS, ETC, SHOWN ON THIS DOCUMENT ARE THE PROPERTY OF GIBRALTAR DESIGN AND WERE CREATED FOR USE ON THIS SPECIFIC PROJECT. NONE OF THIS INFORMATION SHALL BE USED BY ANY PERSON OR FIRM FOR ANY PURPOSE WITHOUT THE EXPRESS WRITTEN CONSENT OF GIBRALTAR DESIGN. THE OWNER MAY RETAIN COPIES FOR INFORMATION AND REFERENCE IN CONNECTION ONLY WITH THIS PROJECT.


MARK DATE ISSUED FOR AD-2 | 04/06/23 | ADDENDUM NO. 02AD-3 | 04/10/23 | ADDENDUM NO. 03

UNIT "D" ELECTRICAL FIRST FLOOR DEMOLITION

WINFIELD ELEMENTARY SCHOOL 2023 ADDITIONS, RENOVATIONS, AND RELATED WORK

GIBRALTAR DESIGN SHEET

ED104

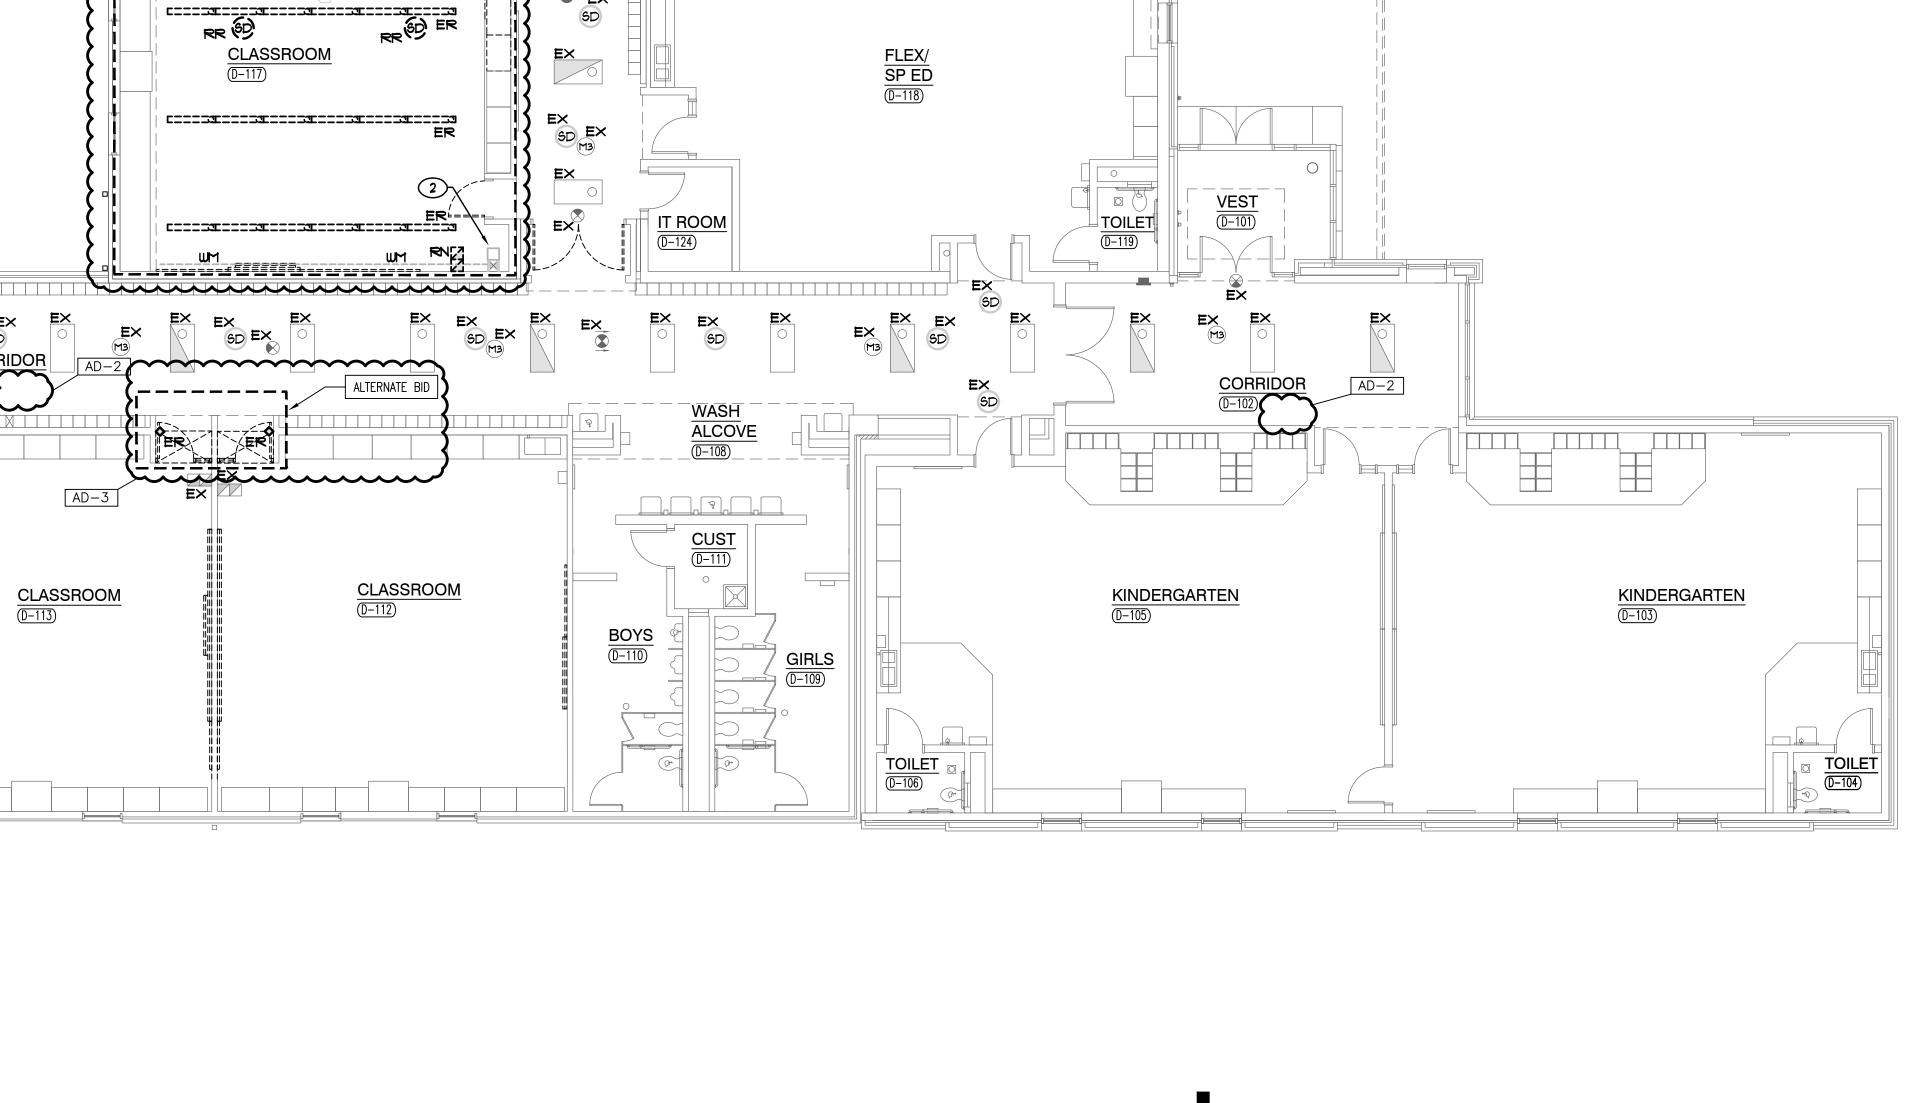

KINDERGARTEN

ALTERNATE BID

CLASSROOM

CLASSROOM

Ε×

GENERAL NOTES CIRCUIT ALL EMERGENCY LIGHTING FIXTURES AND EXIT SIGNS WITH AN 'E' PREFIX TO EX. PANEL EM-L UNLESS OTHERWISE NOTED. CIRCUIT NUMBERS ARE ARBITRARY AND ARE ONLY SHOWN TO INDICATE CIRCUITING REQUIREMENTS. NEW CIRCUIT BREAKERS SHALL MATCH THE MAKE, MODEL AND WITHSTAND RATING OF THE EXISTING PANELBOARD. VERIFY EXACT CONDITIONS AND REQUIREMENTS IN FIELD. 2. EMERGENCY SENSING LEADS SHALL BE CONNECTED TO CONSTANT HOT FEEDS FROM NORMAL LIGHTING IN ROOM. THIS FEED SHALL BE TAKEN AHEAD OF ANY EMERGENCY SHUTDOWNS, RELAYS, CONTACTORS OR SWITCHES. GIBRALTAR 3. REFER TO ARCHITECTURAL REFLECTED CEILING PLAN FOR EXACT LOCATION OF ALL CEILING MOUNTED LIGHT 4. ROUTE CONDUIT AS TIGHT TO THE EXPOSED CEILINGS AND STRUCTURE AS POSSIBLE TO MAXIMIZE CEILING SPACE. 5. YERIFY TEACHING SURFACE WITH OWNER'S REPRESENTATIVE IN FIELD PRIOR TO INSTALLATION AND ADJUST SWITCHING TO PROPERLY ILLUMINATE TEACHING SURFACE. CAREFULLY COORDINATE FINAL SWITCHING WITH FINAL FURNITURE PLANS PROJECT AND TEACHING WALL LOCATIONS. SHEET NOTES RECONNECT NEW LIGHTING FIXTURES IN THIS SPACE TO EXISTING LIGHTING CIRCUITRY AND NEW SWITCHING DEVICES, COMPLETE AS REQUIRED, MAXIMUM 1400W PER 120 VOLT CIRCUIT. WHERE NECESSARY, DUE TO LIMITATIONS IN THE EXISTING CIRCUITRY, THIS CONTRACTOR SHALL FURNISH AND INSTALL 20A-1 POLE CIRCUIT BREAKERS AS REQUIRED IN EXISTING SPACE OF EXISTING PANEL, AND EXTEND 2 #12 AND 1 *12 GRD IN 3/4" CONDUIT COMPLETE AS REQUIRED. EX. PANEL VERIFY CONDITIONS AND REQUIREMENTS IN FIELD. BCP-I-RECONNECT NEW EMERGENCY LIGHTING FIXTURES TO EXISTING EMERGENCY LIGHTING CIRCUITRY AND NEW SWITCHING DEVICES, COMPLETE AS REQUIRED, MAXIMUM 1400W PER 120 YOLT CIRCUIT. PROVIDE UL924 RELAY DEVICE AS REQUIRED TO ACCOMPLISH REQUIRED EMERGENCY SWITCHING, WHERE NECESSARY, DUE TO LIMITATIONS IN THE EXISTING CIRCUITRY, THIS CONTRACTOR SHALL FURNISH AND INSTALL 20A-1 POLE CIRCUIT BREAKERS AS REQUIRED IN EXISTING SPACE OF EXISTING EMERGENCY PANEL, AND EXTEND 2 #12 AND 1 #12 GRD IN 3/4" CONDUIT COMPLETE AS REQUIRED. VERIFY CONDITIONS AND REQUIREMENTS IN FIELD. EX EX COORDINATED DRAWN BY TOILET PASS PLAN


DESIGN ARCHITECTURE • ENGINEERING • INTERIOR DESIGN

(219) 924-8400

www.milliesengineeringgroup.com

WINFIELD **ELEMENTARY** RENOVATIONS, AND RELATED

CROWN POINT COMMUNITY SCHOOL CORPORATION CROWN POINT, INDIANA

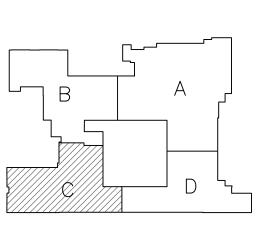

FIRST FLOOR KEY PLAN GIBRALTAR DESIGN

9102 N. Meridian St., Ste. 300 Indianapolis, IN 46260 Homepage www.GibraltarDesign.com Email info@GibraltarDesign.com Phone 317.580.5777 Fax 317.580.5778

THE CONCEPTS, DESIGNS, PLANS, DETAILS, ETC, SHOWN ON THIS DOCUMENT ARE THE PROPERTY OF GIBRALTAR DESIGN AND WERE CREATED FOR USE ON THIS SPECIFIC PROJECT. NONE OF THIS INFORMATION SHALL BE USED BY ANY PERSON OR FIRM FOR ANY PURPOSE WITHOUT THE EXPRESS WRITTEN CONSENT OF GIBRALTAR DESIGN. THE OWNER MAY RETAIN COPIES FOR INFORMATION AND REFERENCE IN CONNECTION ONLY WITH THIS PROJECT.

MARK DATE ISSUED FOR AD-2 | 04/06/23 | ADDENDUM NO. 02AD-3 | 04/10/23 | ADDENDUM NO. 03

UNIT "C" ELECTRICAL FIRST FLOOR LIGHTING

WINFIELD ELEMENTARY SCHOOL 2023 ADDITIONS, RENOVATIONS, AND RELATED WORK

EL103


| ALTERNATE BID |-

CLASSROOM

CLASSROOM

ALTERNATE BID

ALTERNATE BID

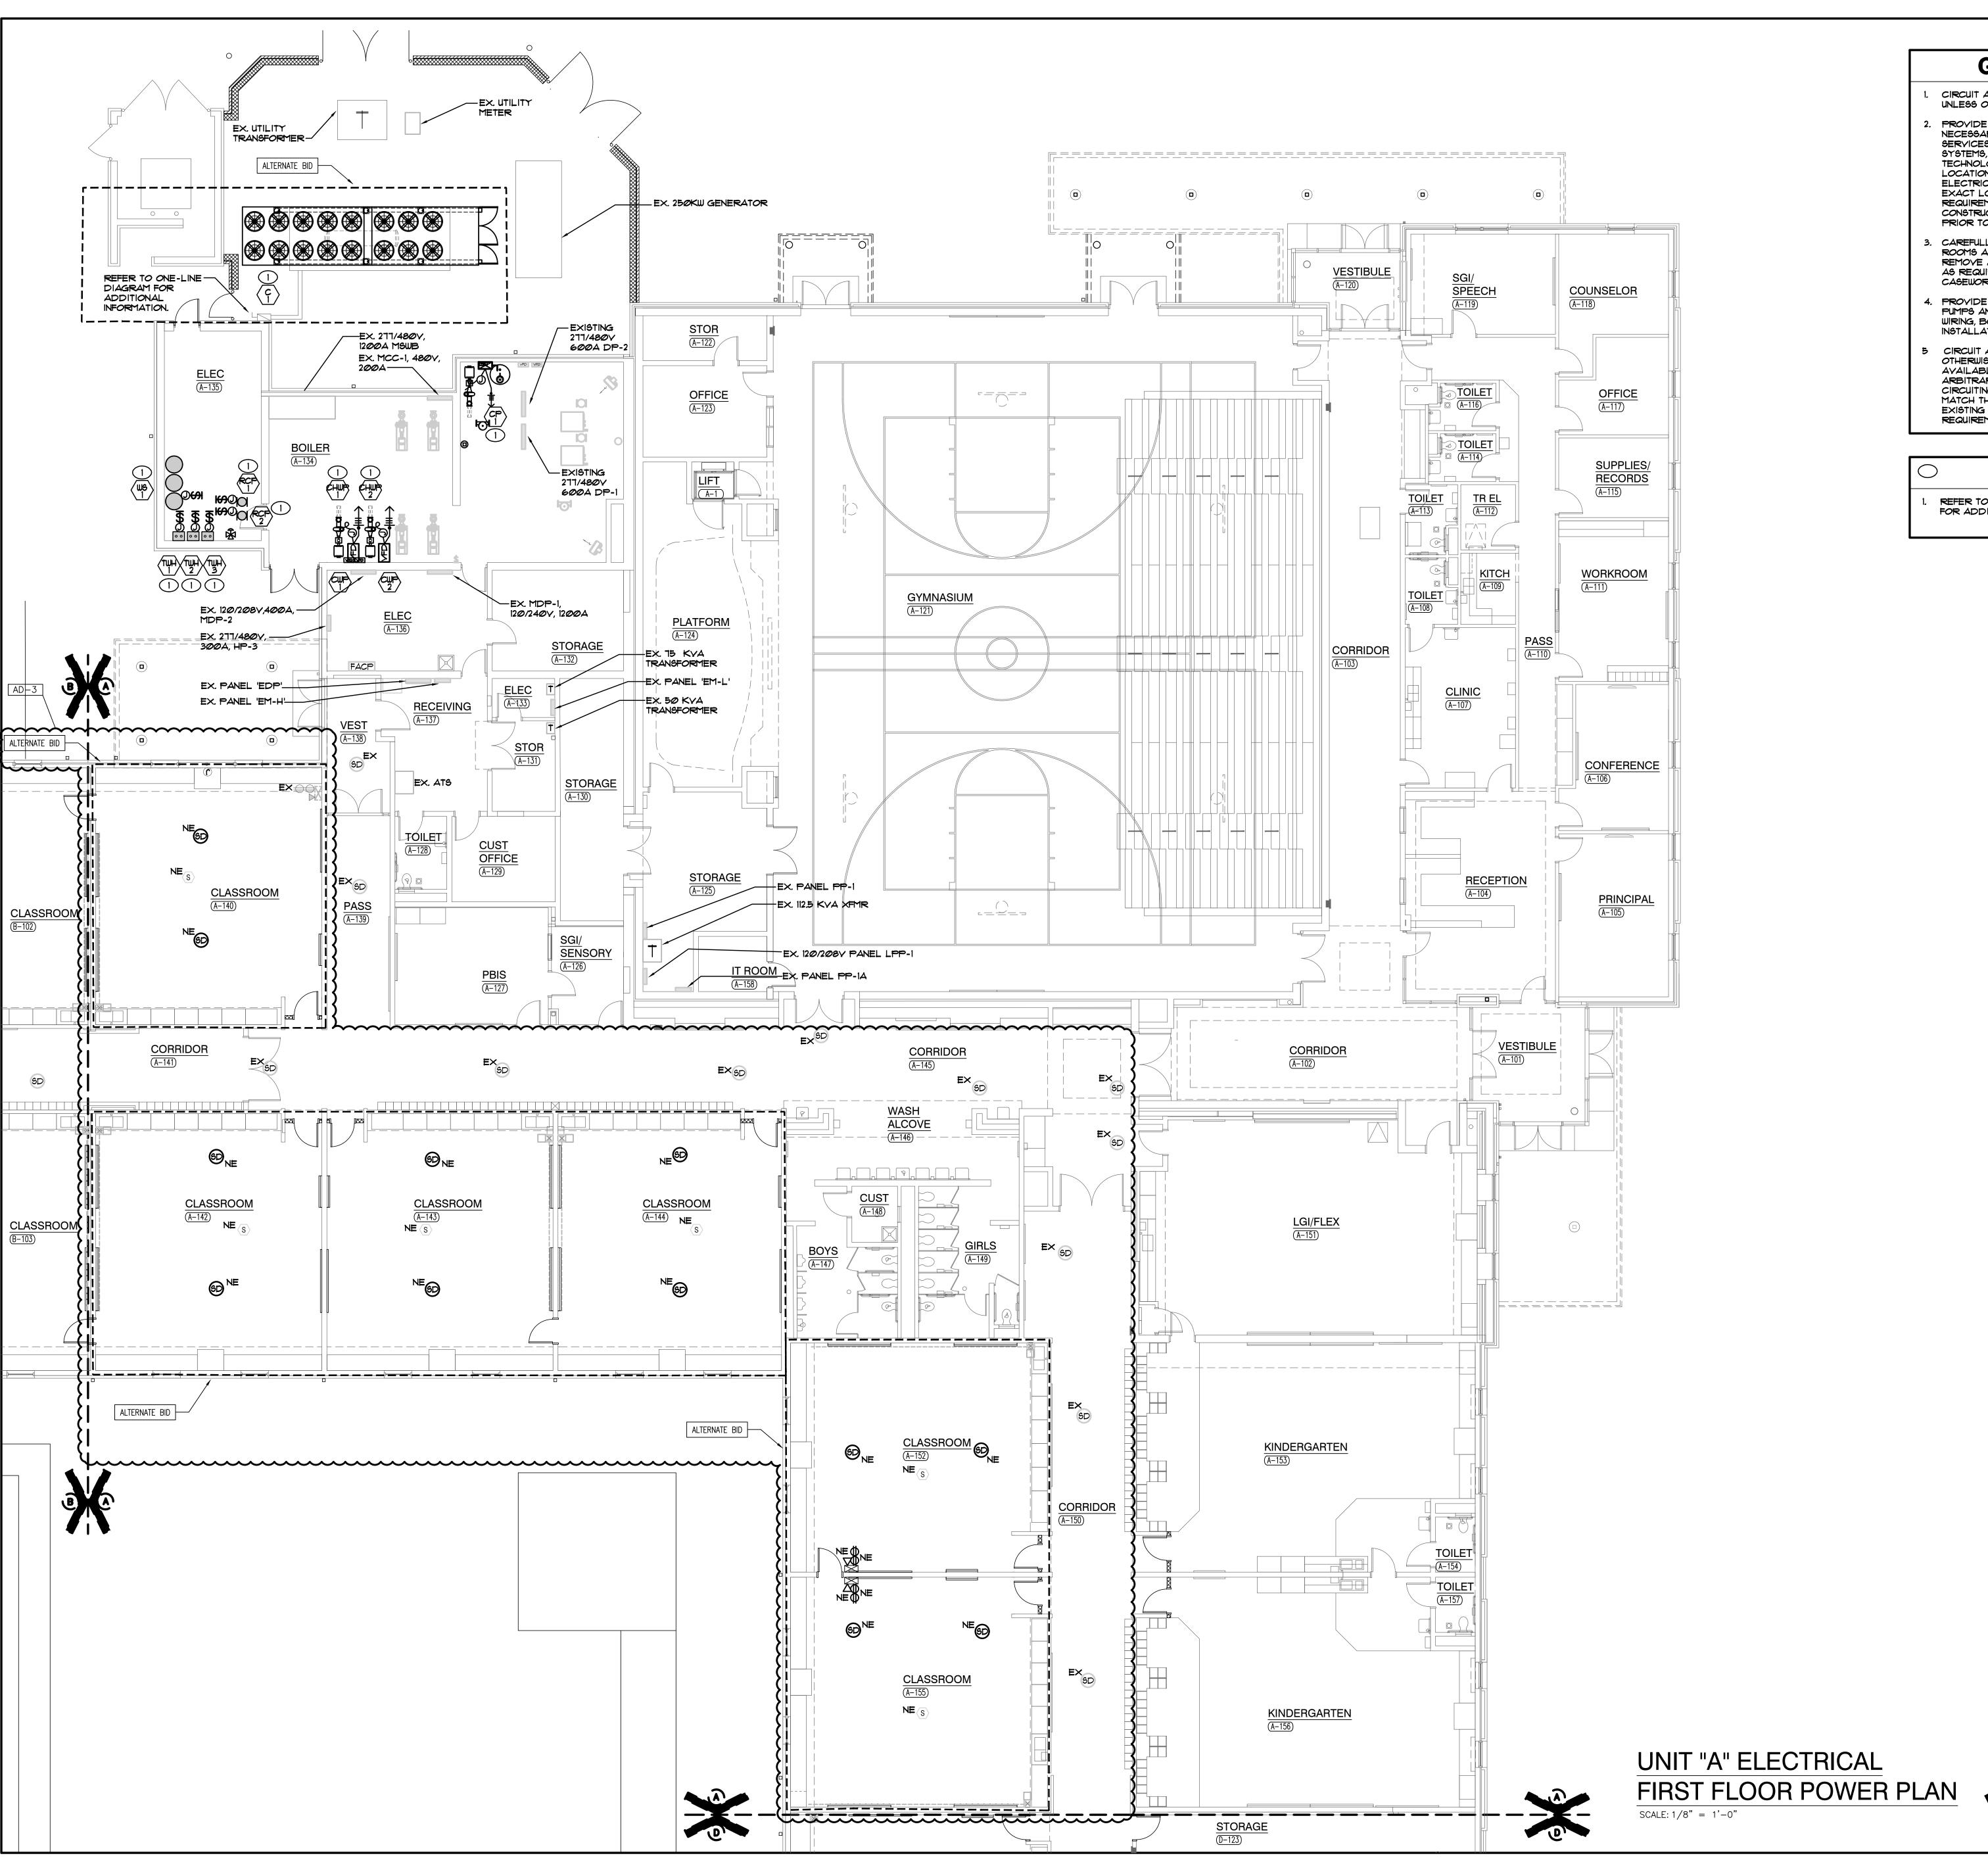



- CIRCUIT ALL DEVICES TO EXISTING PANEL INDICATED UNLESS OTHERWISE NOTED.
- PROVIDE ALL LABOR AND MATERIAL TO PROVIDE THE NECESSARY ROUGH-INS, RACEWAYS AND ELECTRICAL SERVICES FOR ALL OF THE ACCESS CONTROL, SOUND SYSTEMS, TECHNOLOGY SYSTEMS AND EQUIPMENT. SEE TECHNOLOGY DRAWINGS AND SPECIFICATIONS FOR LOCATIONS OF DEVICES/EQUIPMENT, MOUNTING HEIGHTS AND ELECTRICAL REQUIREMENTS. COORDINATE AND VERIFY EXACT LOCATIONS OF ALL OF THESE ROUGH-INS AND REQUIREMENTS WITH TECH DYNE, ARCHITECT, OWNER, CONSTRUCTION MANAGER AND DIVISION 27 CONTRACTOR PRIOR TO ROUGHING-IN.
 - CAREFULLY REVIEW EXISTING CONDUITS AND DEVICES IN ROOMS ALONG WITH DRAWINGS TO REVIEW FOR CONFLICTS. REMOVE AND RELOCATE CONDUIT, DEVICES, BOXES, ETC. AS REQUIRED TO ACCOMMODATE ARCHITECTURAL AND CASEWORK REVISIONS IN ROOMS, COMPLETE AS REQUIRED.
- PROVIDE ALL INTERCONNECTIONS AS REQUIRED BETWEEN PUMPS AND VFD UNITS. PROVIDE ADDITIONAL CONDUIT, WIRING, BOXES, ETC. FOR A COMPLETE AND PROPER INSTALLATION.
- CIRCUIT ALL DEVICES TO EXISTING PANEL PP-1 UNLESS OTHERWISE NOTED. UTILIZE EXISTING CAPACITY MADE AYAILABLE BY DEMOLITION. CIRCUIT NUMBERS ARE ARBITRARY AND ARE ONLY SHOWN TO INDICATE CIRCUITING REQUIREMENTS. NEW CIRCUIT BREAKERS SHALL MATCH THE MAKE, MODEL AND WITHSTAND RATING OF THE EXISTING PANELBOARD. VERIFY EXACT CONDITIONS AND REQUIREMENTS IN FIELD.

SHEET NOTES

REFER TO MECHANICAL EQUIPMENT CONNECTION SCHEDULE FOR ADDITIONAL CIRCUITING AND WIRING INFORMATION.



GIBRALTAR

DESIGN ARCHITECTURE • ENGINEERING • INTERIOR DESIGN

(219) 924-8400

PROJECT WINFIELD **ELEMENTARY** SCHOOL 2023 ADDITIONS, RENOVATIONS,

AND RELATED WORK

CROWN POINT COMMUNITY SCHOOL CORPORATION CROWN POINT, INDIANA

FIRST FLOOR KEY PLAN GIBRALTAR DESIGN

9102 N. Meridian St., Ste. 300 Indianapolis, IN 46260
Homepage www.GibraltarDesign.com
Email info@GibraltarDesign.com
Phone 317.580.5777 Fax 317.580.5778

03/16/23

COORDINATED DRAWN BY CHECKED B'

THE CONCEPTS, DESIGNS, PLANS, DETAILS, ETC, SHOWN ON THIS DOCUMENT ARE THE PROPERTY OF GIBRALTAR DESIGN AND WERE CREATED FOR USE ON THIS SPECIFIC PROJECT. NONE OF THIS INFORMATION SHALL BE USED BY ANY PERSON OR FIRM FOR ANY PURPOSE WITHOUT THE EXPRESS WRITTEN CONSENT OF GIBRALTAR DESIGN. THE OWNER MAY RETAIN COPIES FOR INFORMATION AND REFERENCE IN CONNECTION ONLY WITH THIS PROJECT.


MARK DATE ISSUED FOR AD-3 04/10/23 ADDENDUM NO. 03

UNIT "A" ELECTRICAL FIRST FLOOR POWER

WINFIELD ELEMENTARY SCHOOL 2023 ADDITIONS, RENOVATIONS, AND RELATED WORK

Α

GIBRALTAR DESIGN SHEET **EP101**

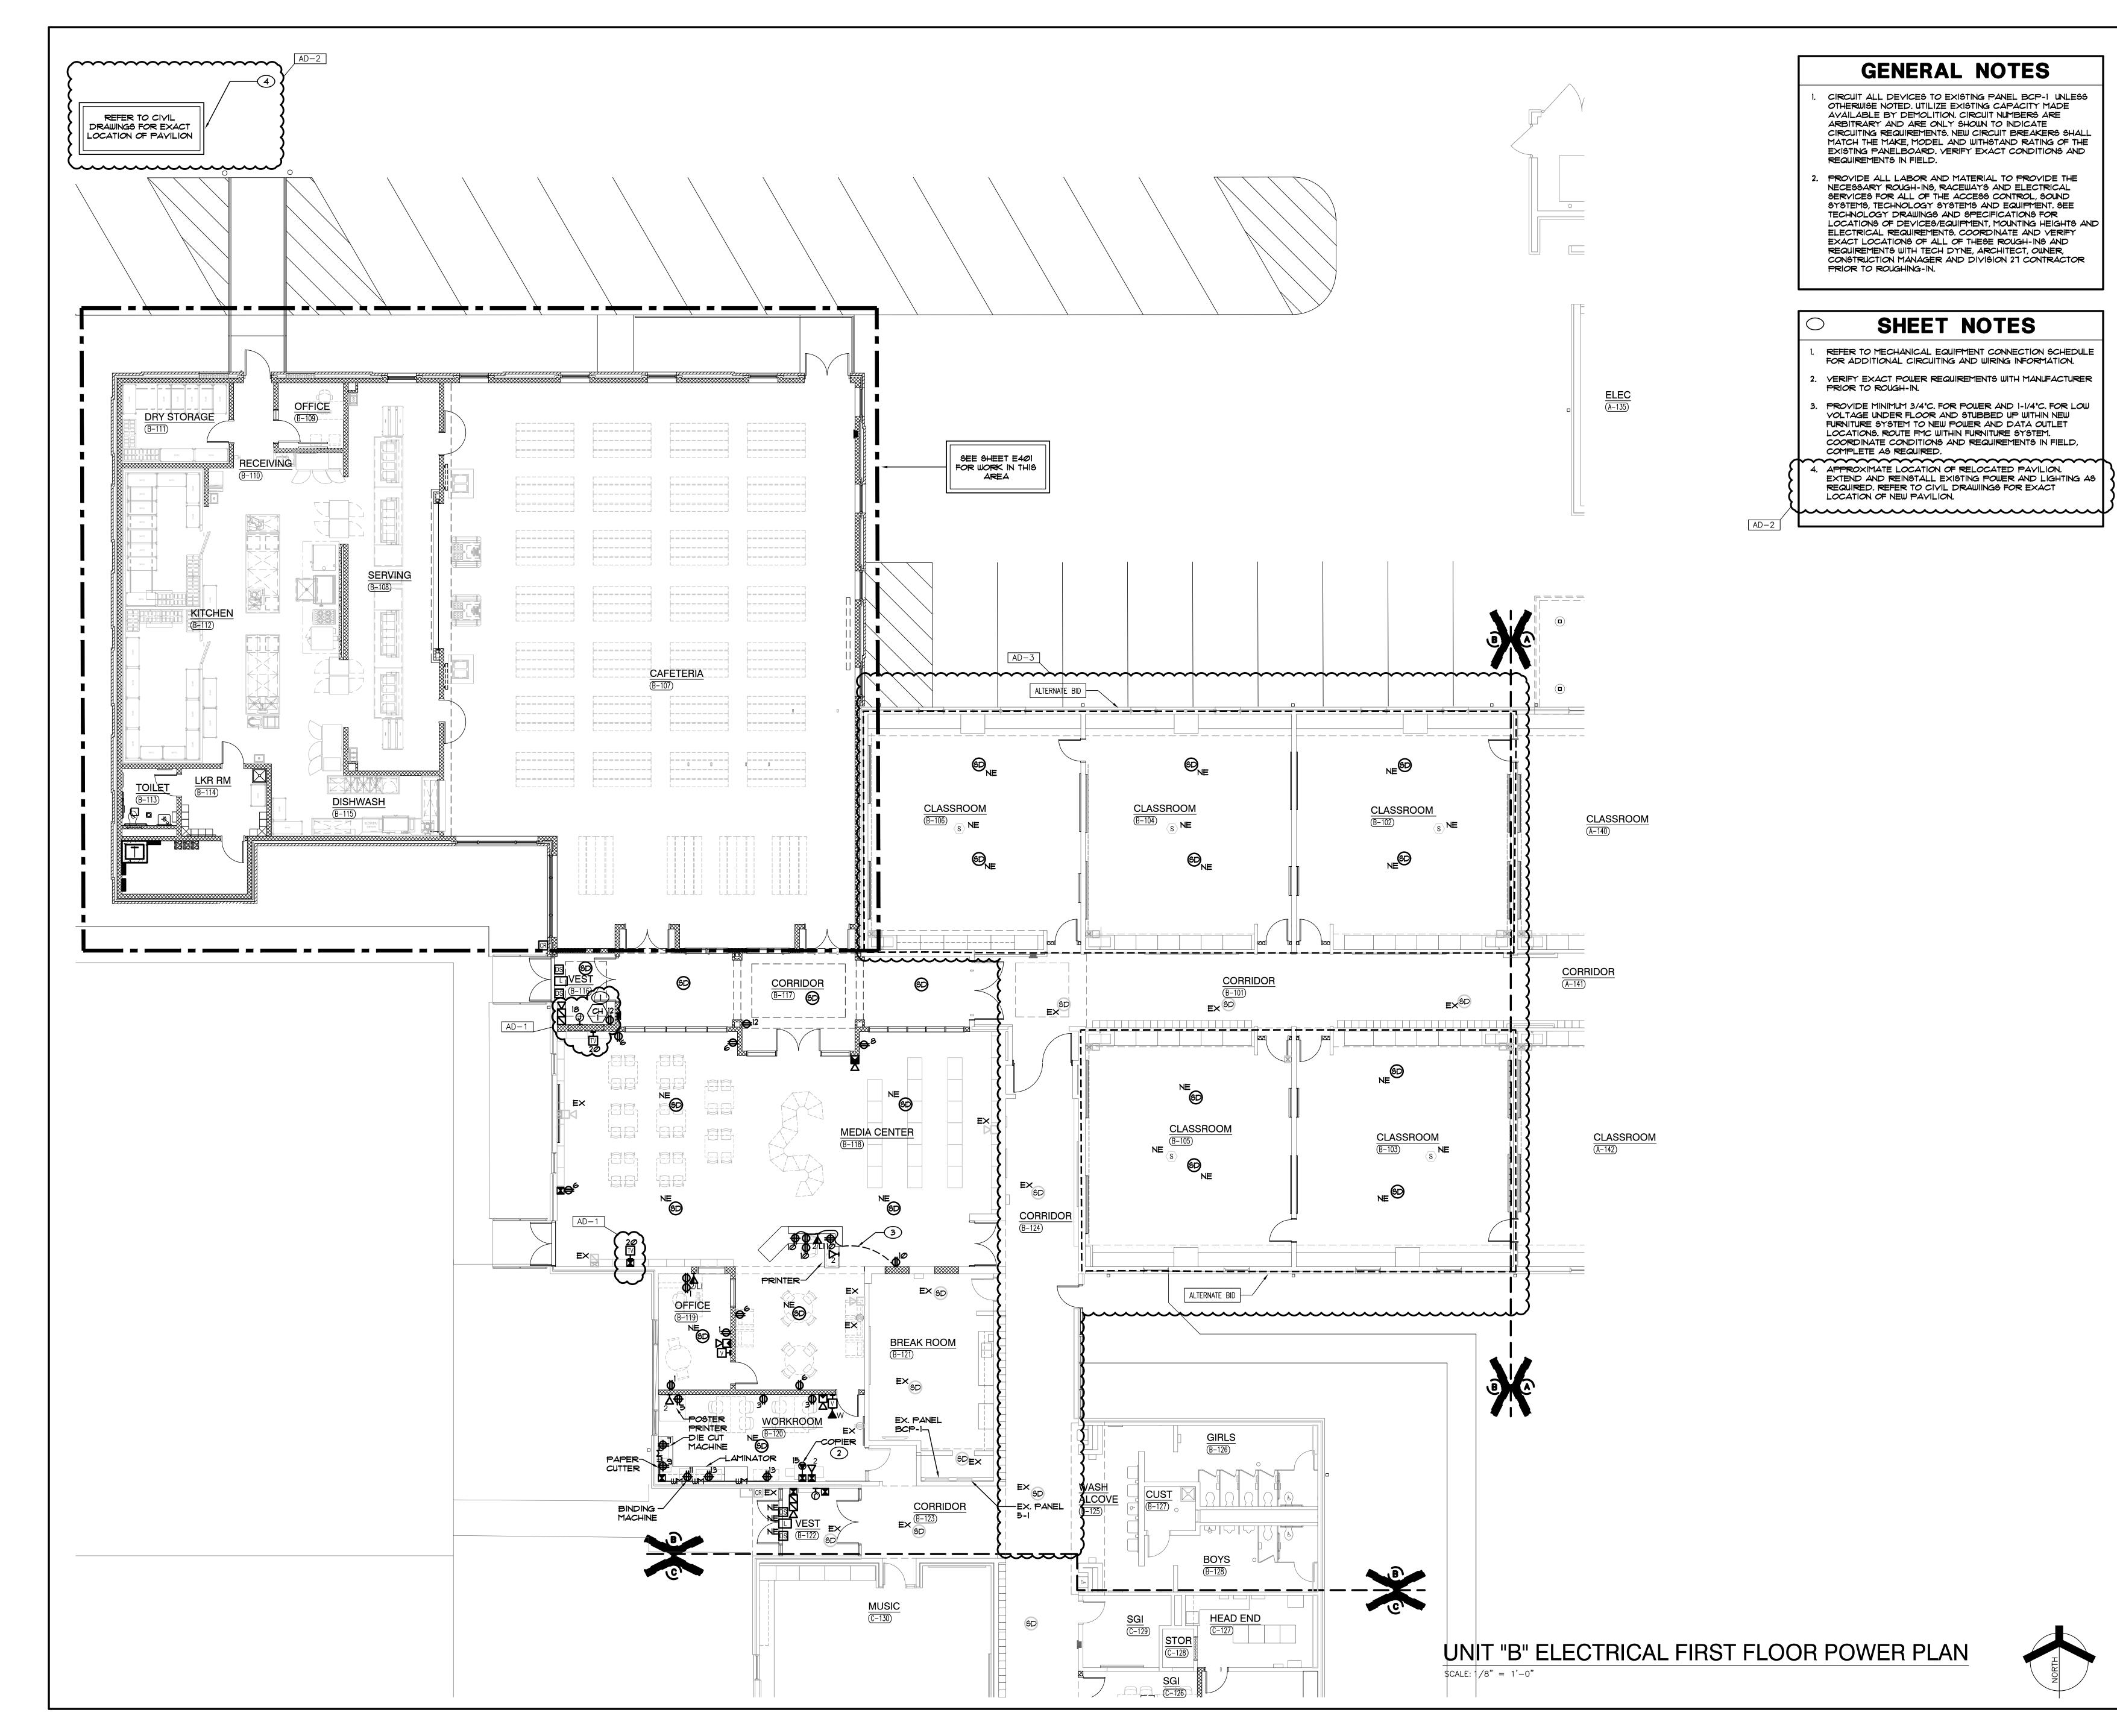



GIBRALTAR

DESIGN

ARCHITECTURE • ENGINEERING • INTERIOR DESIGN

ENGINEERING GROU (219) 924-8400 www.milliesengineeringgroup

WINFIELD
ELEMENTARY
SCHOOL 2023
ADDITIONS,
RENOVATIONS,
AND RELATED

CROWN POINT COMMUNITY SCHOOL CORPORATION CROWN POINT, INDIANA

FIRST FLOOR KEY PLAN

GIBRALTAR DESIGN

9102 N. Meridian St., Ste. 300 Indianapolis, IN 46260 Homepage www.GibraltarDesign.com Email info@GibraltarDesign.com Phone 317.580.5777 Fax 317.580.577

PROJECT

21-110

DATE

03/16/23

COORDINATED BY

SM

DRAWN BY

STATE OF STA

COPYRIGHT NOTICE:

THE CONCEPTS, DESIGNS, PLANS, DETAILS, ETC, SHOWN ON THIS DOCUMENT ARE THE PROPERTY OF GIBRALTAR DESIGN AND WERE CREATED FOR USE ON THIS SPECIFIC PROJECT. NONE OF THIS INFORMATION SHALL BE USED BY ANY PERSON OR FIRM FOR ANY PURPOSE WITHOUT THE EXPRESS WRITTEN CONSENT OF GIBRALTAR DESIGN. THE OWNER MAY RETAIN COPIES FOR INFORMATION AND REFERENCE IN CONNECTION ONLY WITH THIS PROJECT.

REVISIONS

MARK DATE ISSUED FOR

AD-1 03/30/23 ADDENDUM NO. 01

AD-2 04/06/23 ADDENDUM NO. 02

AD-1 03/30/23 ADDENDUM NO. 01
AD-2 04/06/23 ADDENDUM NO. 02
AD-3 04/10/23 ADDENDUM NO. 03

DRAWING

UNIT "B" ELECTRICAL FIRST FLOOR POWER PLAN

PROJECT
WINFIELD ELEMENTARY SCHOOL
2023 ADDITIONS, RENOVATIONS,
AND RELATED WORK

B

EP102

GENERAL NOTES

- CIRCUIT ALL DEVICES TO EXISTING PANEL PP-2 UNLESS OTHERWISE NOTED. UTILIZE EXISTING CAPACITY MADE AVAILABLE BY DEMOLITION. CIRCUIT NUMBERS ARE ARBITRARY AND ARE ONLY SHOWN TO INDICATE CIRCUITING REQUIREMENTS. NEW CIRCUIT BREAKERS SHALL MATCH THE MAKE, MODEL AND WITHSTAND RATING OF THE EXISTING PANELBOARD. VERIFY EXACT CONDITIONS AND REQUIREMENTS IN FIELD.
- PROVIDE ALL LABOR AND MATERIAL TO PROVIDE THE NECESSARY ROUGH-INS, RACEWAYS AND ELECTRICAL SERVICES FOR ALL OF THE ACCESS CONTROL, SOUND SYSTEMS, TECHNOLOGY SYSTEMS AND EQUIPMENT. SEE TECHNOLOGY DRAWINGS AND SPECIFICATIONS FOR LOCATIONS OF DEVICES/EQUIPMENT, MOUNTING HEIGHTS AND ELECTRICAL REQUIREMENTS. COORDINATE AND VERIFY EXACT LOCATIONS OF ALL OF THESE ROUGH-INS AND REQUIREMENTS WITH TECH DYNE, ARCHITECT, OWNER, CONSTRUCTION MANAGER AND DIVISION 27 CONTRACTOR PRIOR TO ROUGHING-IN.


SHEET NOTES

REFER TO MECHANICAL EQUIPMENT CONNECTION SCHEDULE FOR ADDITIONAL CIRCUITING AND WIRING INFORMATION.



PROJECT WINFIELD ELEMENTARY SCHOOL 2023 ADDITIONS, RENOVATIONS, AND RELATED WORK

CROWN POINT COMMUNITY SCHOOL CORPORATION CROWN POINT, INDIANA

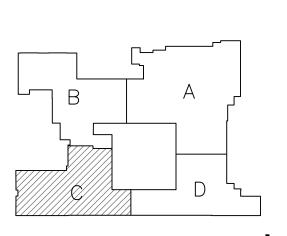

FIRST FLOOR KEY PLAN GIBRALTAR DESIGN

9102 N. Meridian St., Ste. 300 Indianapolis, IN 46260 Homepage www.GibraltarDesign.com Email info@GibraltarDesign.com Phone 317.580.5777 Fax 317.580.5778

COORDINATED

DRAWN BY


THE CONCEPTS, DESIGNS, PLANS, DETAILS, ETC, SHOWN ON THIS DOCUMENT ARE THE PROPERTY OF GIBRALTAR DESIGN AND WERE CREATED FOR USE ON THIS SPECIFIC PROJECT. NONE OF THIS INFORMATION SHALL BE USED BY ANY PERSON OR FIRM FOR ANY PURPOSE WITHOUT THE EXPRESS WRITTEN CONSENT OF GIBRALTAR DESIGN. THE OWNER MAY RETAIN COPIES FOR INFORMATION AND REFERENCE IN CONNECTION ONLY WITH THIS PROJECT.

REVIS	IONS							
MARK	DATE	ISSUED FOR						
AD-1	03/30/23	ADDENDUM NO. 01						
AD-3	04/10/23	ADDENDUM NO. 03						

UNIT "C" ELECTRICAL FIRST FLOOR POWER PLAN

WINFIELD ELEMENTARY SCHOOL 2023 ADDITIONS, RENOVATIONS, AND RELATED WORK

EP103

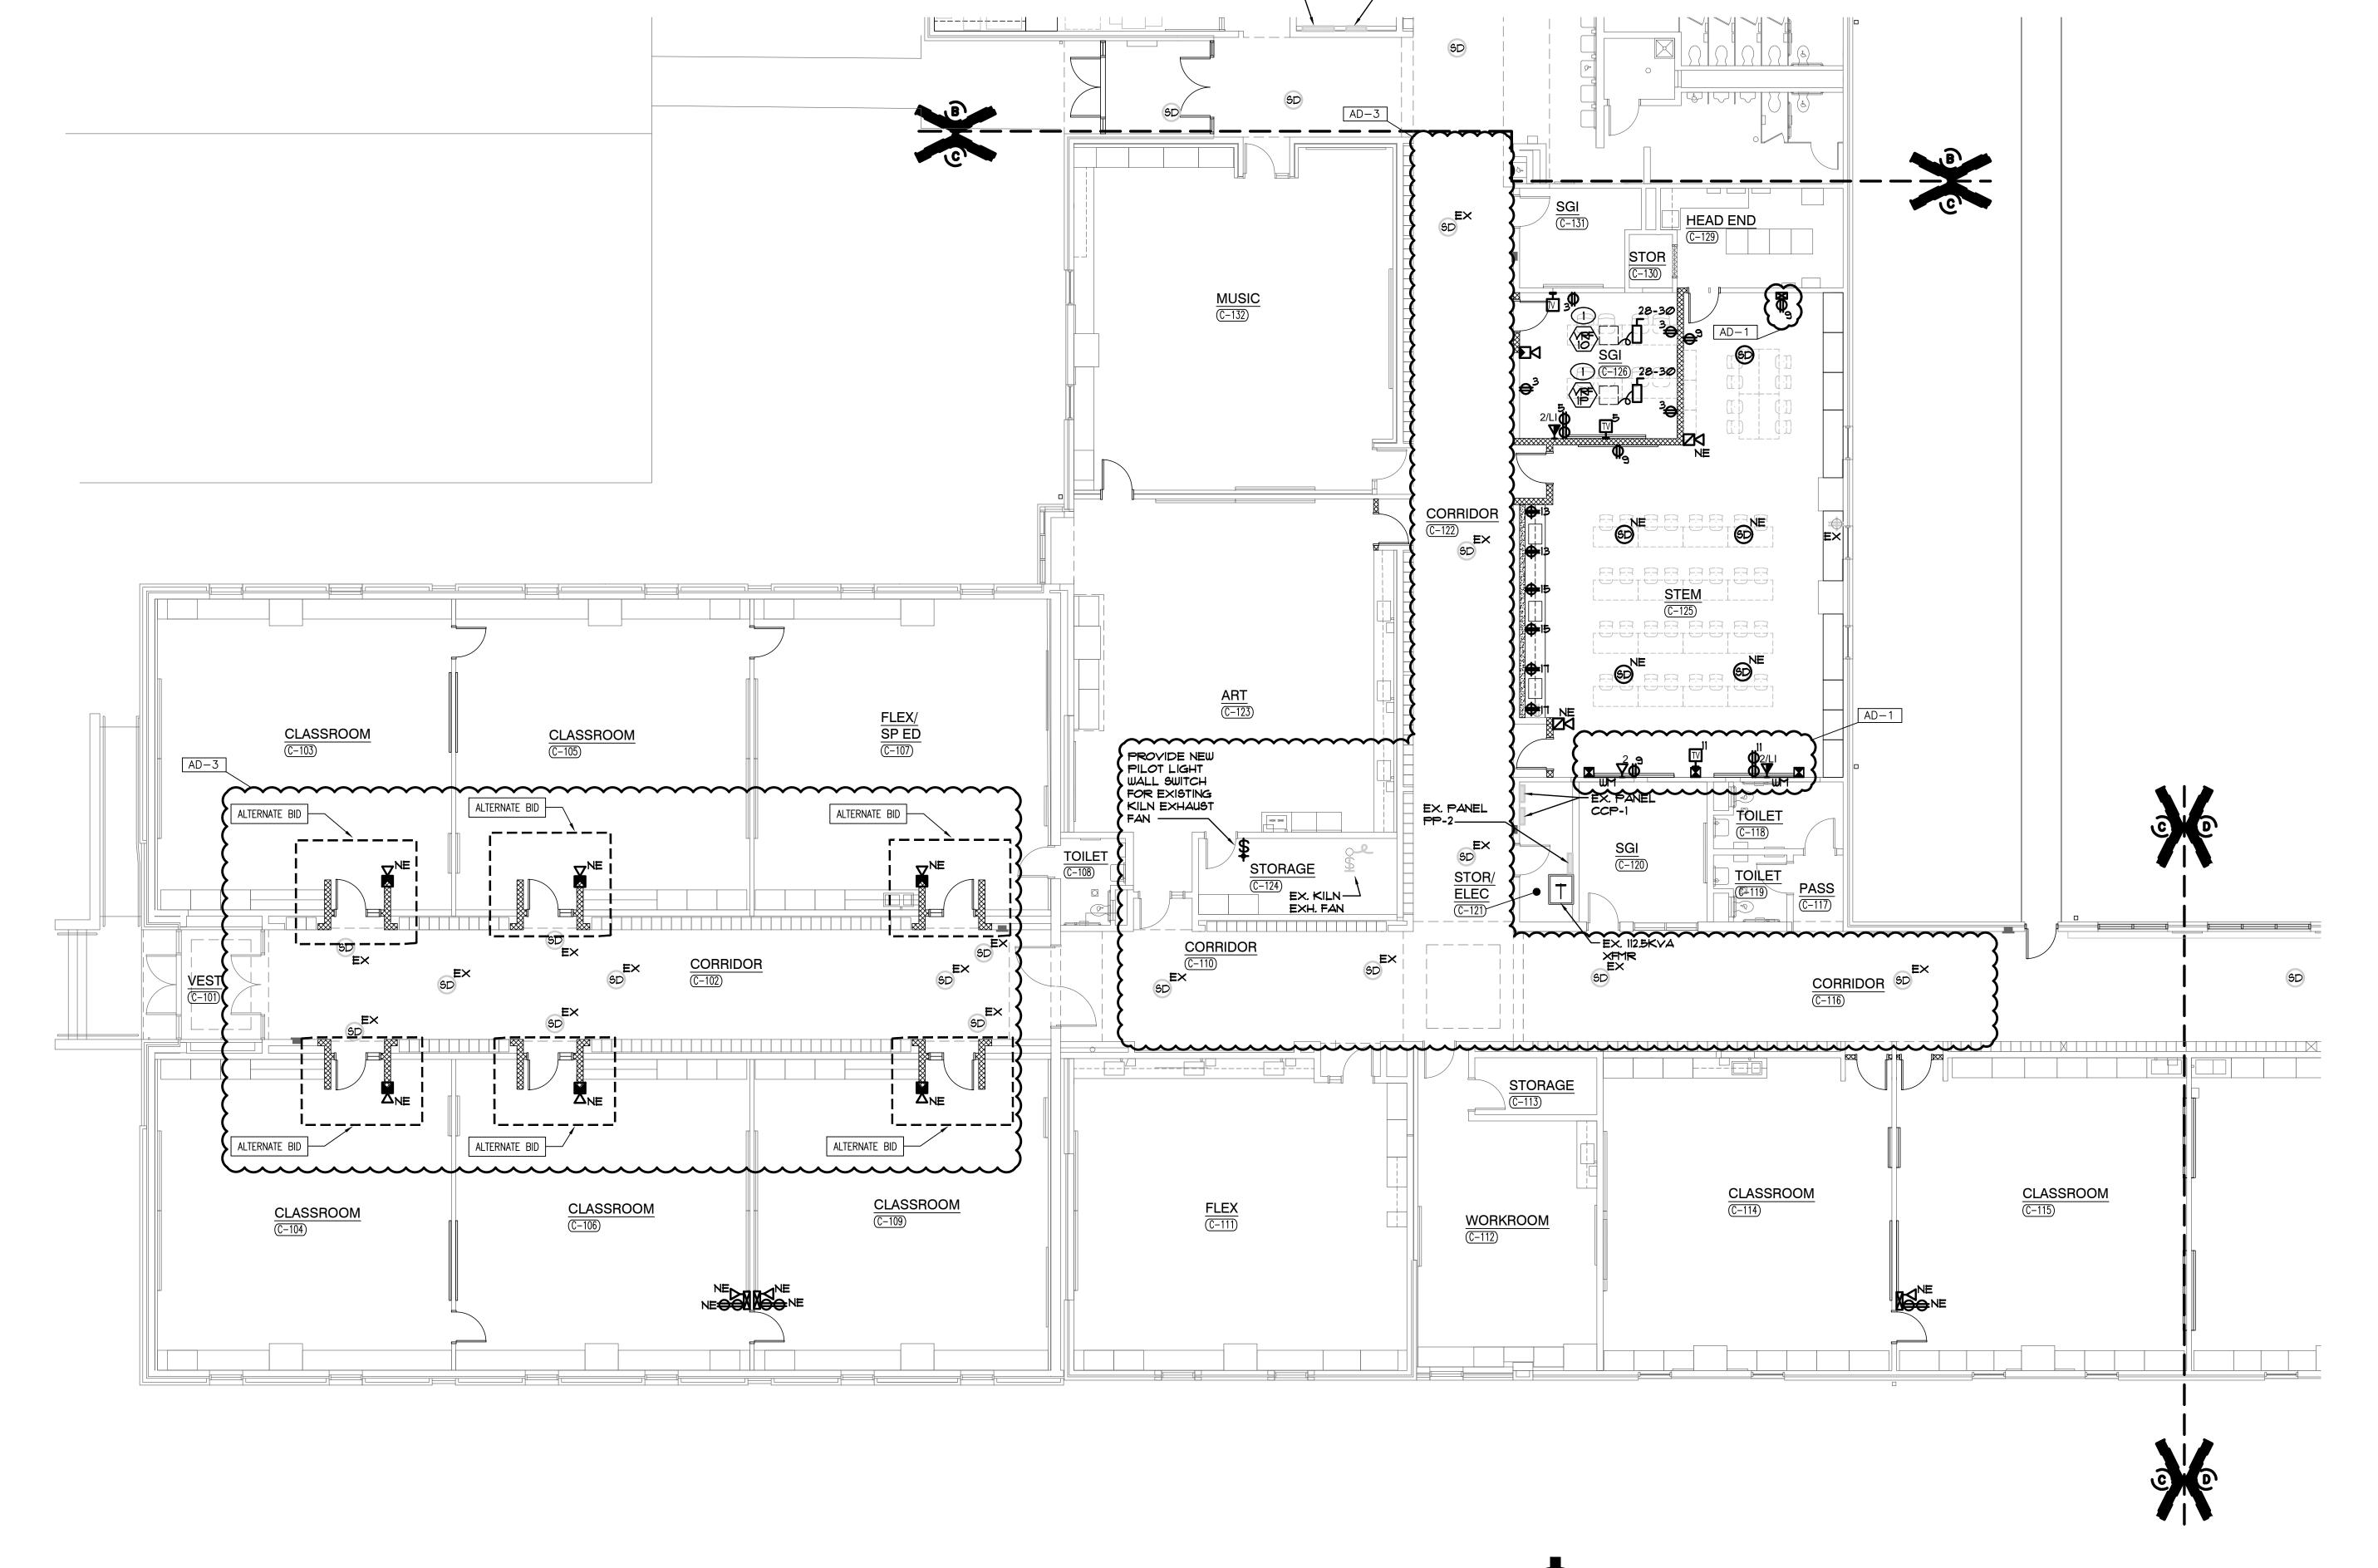

EX. PANEL BCP-I-

GENERAL NOTES

- MADE AVAILABLE BY DEMOLITION. CIRCUIT NUMBERS ARE ARBITRARY AND ARE ONLY SHOWN TO INDICATE CIRCUITING REQUIREMENTS. NEW CIRCUIT BREAKERS SHALL MATCH THE MAKE, MODEL AND WITHSTAND RATING OF THE EXISTING PANELBOARD. VERIFY EXACT CONDITIONS AND REQUIREMENTS IN FIELD.
- NECESSARY ROUGH-INS, RACEWAYS AND ELECTRICAL SERVICES FOR ALL OF THE ACCESS CONTROL, SOUND SYSTEMS, TECHNOLOGY SYSTEMS AND EQUIPMENT. SEE TECHNOLOGY DRAWINGS AND SPECIFICATIONS FOR LOCATIONS OF DEVICES/EQUIPMENT, MOUNTING HEIGHTS AND ELECTRICAL REQUIREMENTS. COORDINATE AND VERIFY EXACT LOCATIONS OF ALL OF THESE ROUGH-INS AND REQUIREMENTS WITH TECH DYNE, ARCHITECT, OWNER, CONSTRUCTION MANAGER AND DIVISION 27 CONTRACTOR PRIOR TO ROUGHING-IN.

SHEET NOTES

REFER TO MECHANICAL EQUIPMENT CONNECTION SCHEDULE FOR ADDITIONAL CIRCUITING AND WIRING INFORMATION.

- CIRCUIT ALL DEVICES TO EXISTING PANEL PP-2 UNLESS OTHERWISE NOTED. UTILIZE EXISTING CAPACITY
- PROVIDE ALL LABOR AND MATERIAL TO PROVIDE THE




(219) 924-8400 www.milliesengineeringgroup.com

WINFIELD ELEMENTARY SCHOOL 2023 ADDITIONS, RENOVATIONS, AND RELATED WORK

PROJECT

CROWN POINT COMMUNITY SCHOOL CORPORATION CROWN POINT, INDIANA

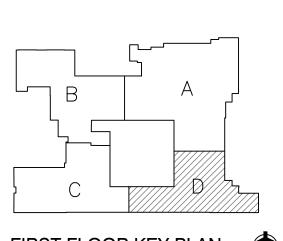

FIRST FLOOR KEY PLAN GIBRALTAR DESIGN

9102 N. Meridian St., Ste. 300 Indianapolis, IN 46260 Homepage www.GibraltarDesign.com Email info@GibraltarDesign.com Phone 317.580.5777 Fax 317.580.5778

COORDINATED

DRAWN BY

THE CONCEPTS, DESIGNS, PLANS, DETAILS, ETC, SHOWN ON THIS DOCUMENT ARE THE PROPERTY OF GIBRALTAR DESIGN AND WERE CREATED FOR USE ON THIS SPECIFIC PROJECT. NONE OF THIS INFORMATION SHALL BE USED BY ANY PERSON OR FIRM FOR ANY PURPOSE WITHOUT THE EXPRESS WRITTEN CONSENT OF GIBRALTAR DESIGN. THE OWNER MAY RETAIN COPIES FOR INFORMATION AND REFERENCE IN CONNECTION ONLY WITH THIS PROJECT.

MARK DATE ISSUED FOR AD-3 | 04/10/23 | ADDENDUM NO. 03

UNIT "D" ELECTRICAL FIRST FLOOR POWER

WINFIELD ELEMENTARY SCHOOL 2023 ADDITIONS, RENOVATIONS, AND RELATED WORK

GIBRALTAR DESIGN SHEET





IT ROOM


CLASSROOM


L-----

ALTERNATE BID

CLASSROOM



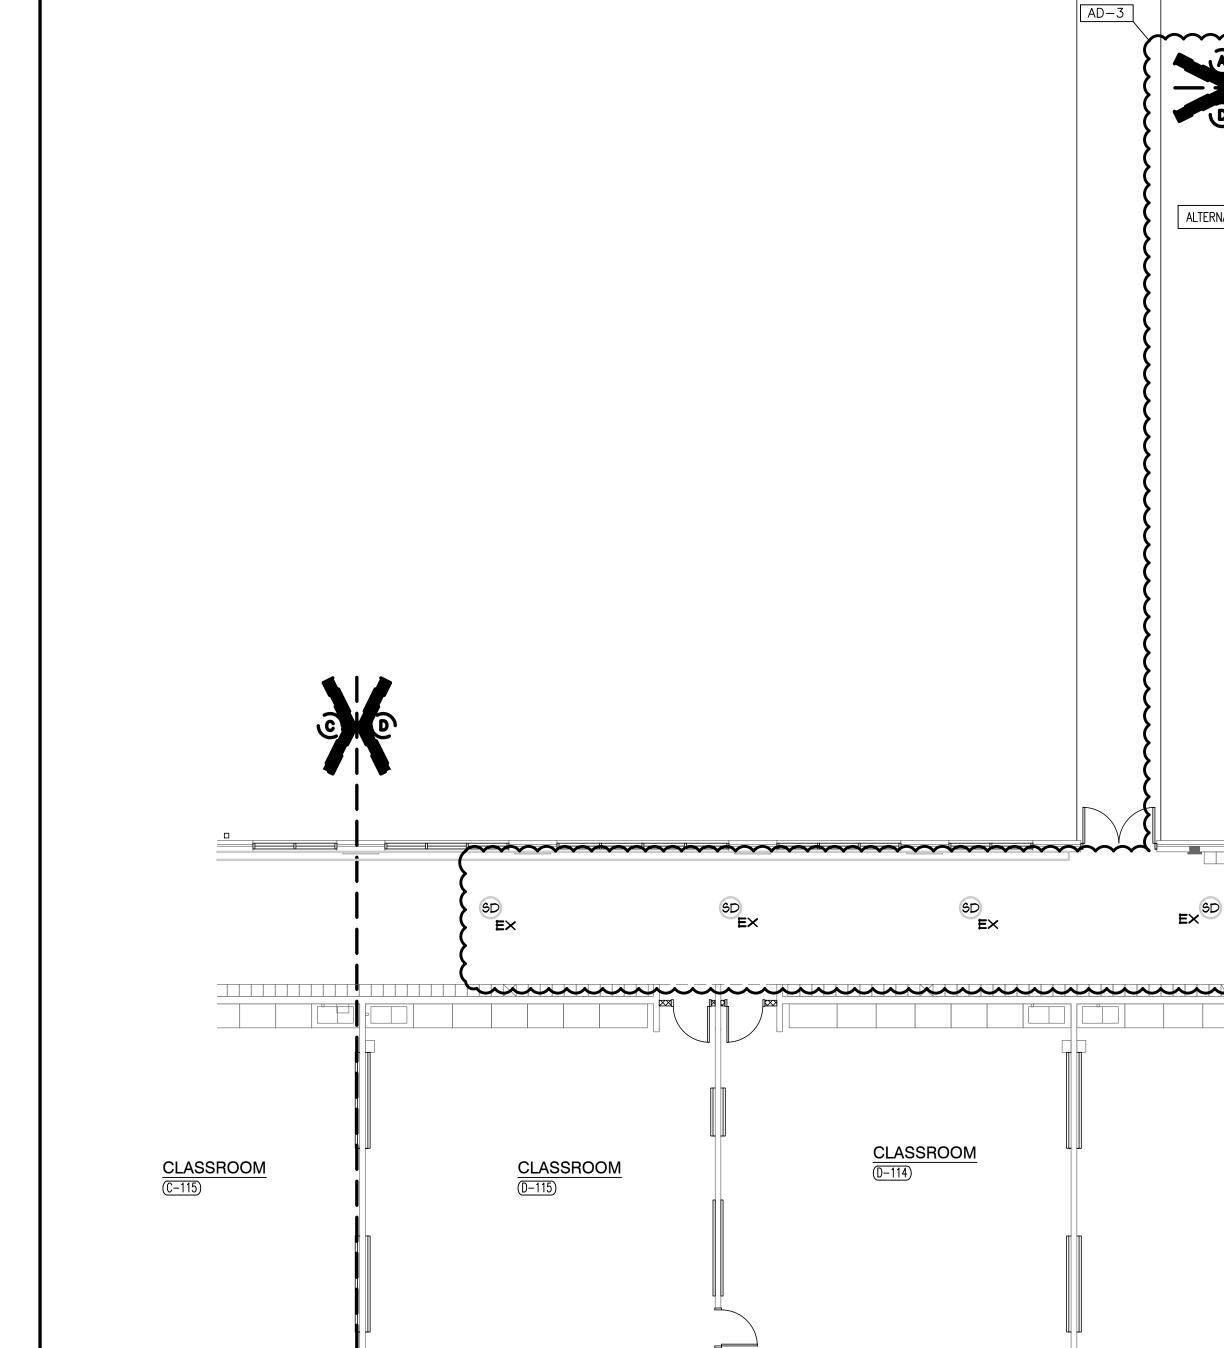

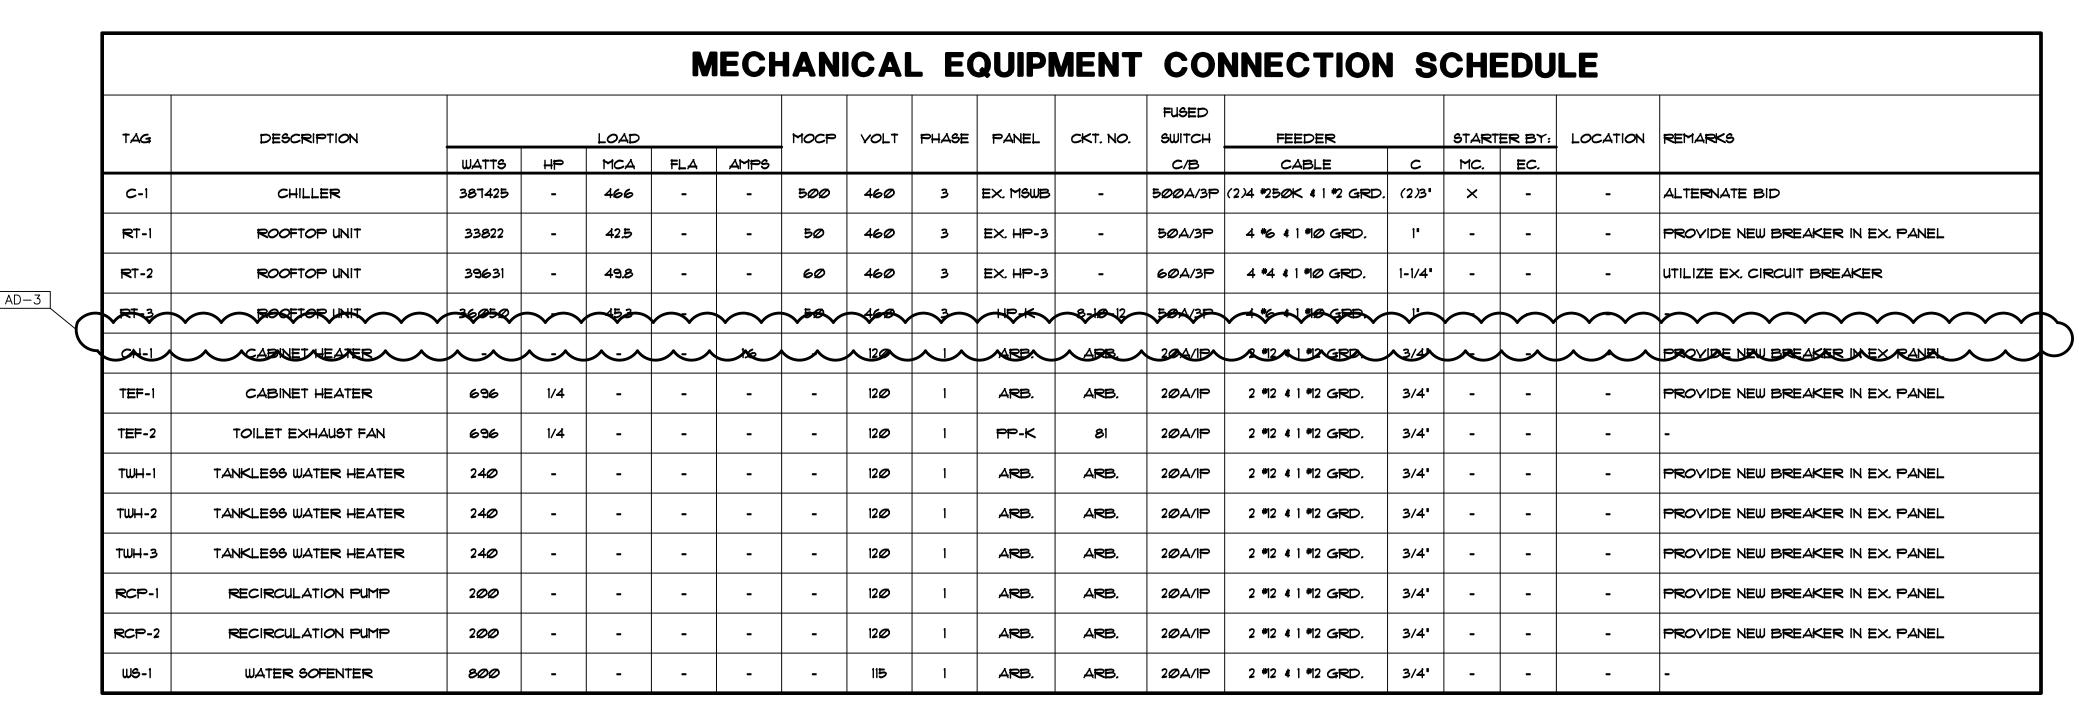

						4D E		MENI.	T CC	MMECTIC		90	WEF		
					PUN		.QUIP	MICIA		NNECTIO	JN	36	ПЕЬ	JULE	
TAG	DESCRIPTION	LOAD HP		MOCP	VOLT	PHASE	PANEL	CKT. NO.	FUSED SWITCH	FEEDER	FEEDER		ED BY:	LOCATION	REMARKS
		WATTS							C/B	CABLE	С	MC.	EC.		
CP-1	CHILLER PUMP	11601	10	-	460	3	EX. MCC-1	-	25A/3P	4 40 \$1 40 GRD.	3/4'	-	-	-	PROVIDE NEW FUSED SWITCH IN EX. MCC-1
CWP-1	CHILLED WATER PUMP	17400	15	-	460	3	EX. MCC-1	-	40A/3P	4 *8 \$ 1 *10 GRD.	3/4"	ı	-	-	PROVIDE NEW FUSED SWITCH IN EX. MCC-1
CWP-2	CHILLED WATER PUMP	17400	15	-	460	3	EX. MCC-1	-	40A/3P	4 *8 \$ 1 *10 GRD.	3/4'	-	-	-	PROVIDE NEW FUSED SWITCH IN EX. MCC-1

TOTAL KW: 215.0 ENCLOSURE: NEMA-1							SE:	3¢			YOLTA	AGE:	277 / 48Ø
MOUNTING: SURFACE		BUSSI	NG: COF	PER		FAU	_T Cl	JRRENT	RATING	:	22K	AIC	MCB(AMPS): 400
EEDER: 4*500 4 1 *	3 GRD	- 3-1/2	<u>'C</u>			LOC	ATIC	N: MECH	1 B-114/	7			
		C/B LOAD							LOAD			/B	
LOAD DESCRIPTION	TRIP	POLE	Дф	B¢	Сф	CCT	. NO.	Дф	B¢	Cþ	TRIP	POLE	LOAD DESCRIPTION
TG UNIT B	20	1	4400			1	2	31,999			175		
TG UNIT B	20	1		4400		3	4		33,361				112.5 KVA XFMR
SPARE	20	1				5	6			36,369		3	
PARE	20	1				٦	8	12Ø17			50	_	
SPARE	20	1				9	10		12Ø17				RT-3
SPARE	20	1				11	12			12017		3	
BPACE						13	14	18444			85		
BPACE						15	16		18444				DW BOOSTER HEATER
BPACE						IΤ	18			18444		3	
SPACE						19	20	4350			20		
BPACE						21	22		4350				DW BLOWER DRYER
BPACE						23	24			4350		3	
BPACE						25	26						SPACE
PACE						27	28						SPACE
PACE						29	30						SPACE
BPACE						31	32						SPACE
BPACE						33	34						SPACE
BPACE						35	36						SPACE
PACE						37	38						SPACE
BPACE						39	40						SPACE
BPACE						41	42						SPACE
	-	•	4400	4400	Ø		•	66810	68172	TIISØ			-

TOTAL KW: 1.4	OSURE:	NEM	4- 1	PHA	SE:	3¢			YOLT,	VOLTAGE: 120 / 208			
MOUNTING: SURFACE		BUSSII	NG: CC	PPER		FAU	_T Cl	IRREN	RATIN	NG: 22,0	000	AIC	MCB(AMPS): 60
FEEDER: 4 *6 4 1 *10 G	RD	1'C.				LOC	ATIO	N: MEC	CH B-11	4 A			
	(C/B		LOAD)				LOAD			C/B	
LOAD DESCRIPTION	TRIP	POLE	AV	BA	Co	CCT	. NO.	Дф	B♦	C¢	TRIP	POLE	LOAD DESCRIPTION
PROJECTOR	20	1	600			1	2				20	1	SPARE
PROJECTOR SCREEN	20	1		800		3	4				20	1	SPARE
	10					5	6				20	1	SPARE
SPARE	20	1				٦	8				20	1	SPARE
SPARE	20	1				9	10				20	1	SPARE
SPARE	20	1				11	12				20	1	SPARE
SPARE	20	1				13	14				20	1	SPARE
SPARE	20	1				15	16				20	1	SPARE
SPARE	20	1				17	18				20	1	SPARE
SPACE						19	20						SPACE
SPACE						21	22						SPACE
SPACE						23	24						SPACE
•			600	800	Ø		•	0	Ø	Ø			•
		0.0.0		J					J	A =	600		
										B=	800		

			OSURE:	NEM	۸_1 I	EDLI A	SE:	34			YOLT.	16E	120 / 208
OTAL KW: 1036 10UNTING: SURFACED					7-1				T 50 A T IN	IC. 22 C			MLO(AMPS): 400
EEDER: 4# 500 4 1 #3	CPD.	•	NG: CC	PPER					T RATIN CH B-II:			AIC	1-1LO(A1-1P-97: 4000
TEDER: 4" 900 4 1 "3		<u>- 3-1/2</u> C/B	-	LOAD			, A HC			+ 🕰		C/B	T
LOAD DESCRIPTION		POLE	Дф	Bø	Cø	CCT	. NO.	Дф	LOAD B¢	Сф	_	POLE	LOAD DESCRIPTION
REC - LOCKER AREA	20	1	800	DY	CY	1	2	385	D+	<u> </u>	20	IFOLE	LOAD DESCRIPTION
65 - DRYER	30	'	000	2496		3	4		385		-20		#19 - GARBAGE DISP.
		2		2 100	2496	5	6		700	385		3	
65 - WASHER	20		1920			7	8	1920			20	1	#14 - ISLAND WORKTABLE
REC - OFFICE D-118	20	1	1022	1000		9	10	1022	1920		20	1	#14 - ISLAND WORKTABLE
24 - ICE MAKER	20	1			1380	11	12			1920	20	1	#14 - ISLAND WORKTABLE
DR2 - CONY.	20	1	1920			13	14	1920			20	1	#14 - ISLAND WORKTABLE
26 - MICROWAYE	20	1		1608		15	16		1920		20	1	#17 - ISLAND WORKTABLE
DRI - DRY STORAGE	20	1			1920	17	18			1920	20	1	#17 - ISLAND WORKTABLE
16 - HAND SINK	20	1	720			19	20	1920			20	1	#17 - ISLAND WORKTABLE
54 - DISH EF	20	1		768		21	22		1920		20	1	#17 - ISLAND WORKTABLE
EXTERIOR RECEPS	20	1			400	23	24			1200	20	1	*30 - EXHAUST HOOD
	20	II.	385			25	26	812			2Ø		*28 - HEATED CABINET
49 - GARBAGE DISP.				385		27	28		812			2	
		3			385	29	30			840	20	1	*29 - FRIDGE
68 - MILK COOLER	20	1	324			31	32	1560			20		*35 - COMBIOYEN
69 - HOT SERY, CTR.	20	1		1920		33	34		1560			2	
70 - DROP-IN HOT/COL	D 2Ø				1498	35	36			1560	20		*35 - COMBIOYEN
		2	1498			37	38	1560				2	
71 - SELF SERVE	20	1		720		39	40		1200		2Ø	1	*37 - TILT SKILLET
72 - COLD SERVE CTR.	20	1			1920	41	42			948	20	1	*40 - CONVECTION OVEN
73 - DROP-IN COLD	20	1	1020			43	44	948			2Ø	1	*40 - CONVECTION OVEN
74 - DROP-IN HOT/COLI	20	1		720		45	46		600		20	1	#31 - FIRE SUPP SYS.
75 - DRY GOODS CTR.	20	1			1920	4 ⊤	48			840	20	1	*29 - FRIDGE
76 - ICE CREAM FRZ.	20	1	240			49	50	812			20		*28 - HEATED CABINET
85 - DRY GOODS CTR.	20	1		1920		5	52		812			2	
82 - COLD SERVE CTR	20	1			1920	53	54			600	20	1	KEC CONTROL PANEL
83 - DROP-IN COLD	20	1	1020			5	56	720			20	1	#16 - HAND SINK
84 - SELF SERVE	20	1		720		57	58		720		20	1	#16 - HAND SINK
79 - HOT SERY, CTR.	20	1			1920	59	60			600	20	1	REC - SERVING AREA
80 - DROP-IN HOT/COL	D 2Ø		1498			61	62	800			20	1	TY'S - SERVING AREA
		2		1498		63	64		800		20	1	REC - SERVING AREA
81 - DROP-IN COLD	20	1			720	65	66			1200	20	1	O.H. ROLLING GRILL
78 - MILK COOLER	20	1	324			67	68	1920			20	1	*DRI - CAFE
87 - POS	20	1 1		1920		69	70		800		20	1	TV'S - CAFE
87 - POS	20	1	ļ		1920	71	72	L		1920	20	1	*DRI - CAF?
42 - FRIDGE	20	1 1	1008			73	74	2101			35		
REC - CAF?	20	1 1		1200		75	76		2101				*34 - MAKEUP AIR UNIT
REC - CAF?	20	1	<u> </u>		1000	77	35	<u> </u>		2101		3	
41 - FRIDGE	20	1	1008	4.5.1		79	80	936			20		
	20	1 1		696		81	82	ļ	936	936		3	*33 - COOKING EF
TEF-1 DATA CABINET	20			l .	1200	83	84						



DESIGN
ARCHITECTURE • ENGINEERING • INTERIOR DESIGN



WINFIELD
ELEMENTARY
SCHOOL 2023
ADDITIONS,
RENOVATIONS,
AND RELATED
WORK

CROWN POINT COMMUNITY SCHOOL CORPORATION CROWN POINT, INDIANA

GIBRALTAR DESIGN
9102 N. Meridian St., Ste. 300
Indianapolis, IN 46260
Homepage www.GibraltarDesign.com
Email info@GibraltarDesign.com

Phone 317.580.5777 Fax 317.580.5778

PROJECT
21-110
DATE
03/16/23
COORDINATED BY
SM
DRAWN BY
AG

PE12000317

STATE OF
VOIANIANIA

COPYRIGHT NOTICE:

THE CONCEPTS, DESIGNS, PLANS, DETAILS, ETC, SHOWN ON THIS DOCUMENT ARE THE PROPERTY OF GIBRALTAR DESIGN AN WERE CREATED FOR USE ON THIS SPECIFIC PROJECT. NONE OF THIS INFORMATION SHALL BE USED BY ANY PERSON OR FIRM

THE CONCEPTS, DESIGNS, PLANS, DETAILS, ETC, SHOWN ON THIS DOCUMENT ARE THE PROPERTY OF GIBRALTAR DESIGN AND WERE CREATED FOR USE ON THIS SPECIFIC PROJECT. NONE OF THIS INFORMATION SHALL BE USED BY ANY PERSON OR FIRM FOR ANY PURPOSE WITHOUT THE EXPRESS WRITTEN CONSENT OF GIBRALTAR DESIGN. THE OWNER MAY RETAIN COPIES FOR INFORMATION AND REFERENCE IN CONNECTION ONLY WITH THIS PROJECT.

KEVI2	IONS	
MARK	DATE	ISSUED FOR
AD-1	03/30/23	ADDENDUM NO. 01
AD-3	04/10/23	ADDENDUM NO. 03

DRAWING

ELECTRICAL SCHEDULES

PROJECT
WINFIELD ELEMENTARY SCHOOL
2023 ADDITIONS, RENOVATIONS,

© GIBRALTAR DESIGN SHEET

E-601

Monday, 4/10/2023 — 2:36 PM — LAST SAVED BY:AGIDC K:\2022\2210190 CROWN POINT WINFIELD ELEMENTARY\3

AND RELATED WORK

Copyright © 2023 Millies Engineering Group