ADDENDUM NO. 02

February 16, 2024

ZCS-ZCHS Stadium Locker Building & Concrete Repairs, ZMS Tennis Courts and Eagle Elementary Building Demolition & Playground Renovation 1000 Mulberry St.

Zionsville, IN, 46077

TO: ALL BIDDERS OF RECORD

This Addendum forms a part of and modifies the Bidding Requirements, Contract Forms, Contract Conditions, the Specifications, and the Drawings dated January 22, 2024, by Fanning Howey (Architect). Acknowledge receipt of the Addendum in the space provided on the Bid Form. Failure to do so may subject the Bidder to disqualification.

This Addendum consists of Pages ADD 2-1 through ADD 2 - 1 and attached Addendum No. 2 from Fanning Howey dated February 16, 2024 for **Zionsville Middle School 223144.00** consisting of 1 page and 2 Drawings.

1. Zionsvile Community High School Stadium Locker Building Addition and Renovation

A. Two (2) drawings sheets PD1A and PP1A are being reissued. They are the same version as what was issued in Addendum 01, however they appeared unreadable because of formatting problems. The drawings sheets included in this Addendum 02 shall supersede previous sheets.

END OF ADDENDUM

COPYRIGHT 2023 BY FANNING/HOWEY ASSOCIATES, INC. **DEMOLITION PLAN NOTES** EXISTING SHOWER VALVE, SHOWER DRAIN AND ASSOCIATED PIPING TO BE REMOVED COMPLETE. CAP SHOWER DRAIN WASTE PIPING BELOW FINISHED FLOOR AND PATCH CONCRETE FLOOR. 2 EXISTING FLOOR DRAIN TO BE REMOVEDCOMPLETE. CAP WASTE PIPING BELOW FINISHED FLOOR AND PATCH CONCRETE FLOOR. B EXISTING WATER COOLER AND ASSOCIATED PIPING TO BE REMOVED COMPLETE. CAP WASTE PIPING BELOW FINISHED FLOOR AND PATCH CONCRETE FLOOR. EXISTING WASHFOUNTAIN AND ASSOCIATED PIPING TO BE REMOVED COMPLETE. CAP WASTE PIPE BELOW FINISHED FLOOR AND PATCH CONCRETE FLOOR. 5 EXISTING URNIAL AND ASSOCIATED PIPING TO BE REMOVED COMPLETE. 6 EXISTING WATER CLOSET TO BE REMOVED COMPLETE. 7 EXISTING HOSE BIB TO BE REMOVED COMPLETE. 8 EXISTING FIXTURE/DRAIN TO REMAIN. 9 EXISTING WATER HEATER TO BE REMOVED COMPLETE. (1) 1,000 GALLON HORIZONTAL STORAGE TANK, (3) GAS-FIRED BOILERS AND ASSOCIATED PIPING. 10 EXISTING HOT WATER CIRCULATING PUMP TO REMAIN. 11 EXISTING THERMOSTATIC MIXING VALVE TO REMAIN. 12 EXISTING PRESSURE BOOSTER PUMP AND EXPANSION TANK TO REMAIN. **ADDITION AND** 13 EXISTING HOT WATER EXPANSION TANK TO BE REMOVED COMPLETE. 14 EXISTING SIMPLEX WATER SOFTENER TO BE REMOVED COMPLETE. 15 EXISTING IRRIGATION BOOSTER PUMP TO REMAIN. RENOVATION 16 EXISTING IRRIGATION MAIN TO REMAIN. 17 EXISTING IRRIGATION WATER METER AND BACKFLOW PREVENTER TO REMAIN. 18 EXISTING 6" DOMESTIC WATER SERVICE TO REMAIN. 19 EXISTING DOMESTIC WATER METERS (2 STACKED) AND BACKFLOW PREVENTERS (2) TO REMAIN. 20 4" DOMESTIC COLD WATER MAIN TO REMAIN. 21 EXISTING 4" DOMESTIC COLD WATER SUPPLY TO ADJACENT BUILDING TO REMAIN. 22 EXISTING 1" DOMESTIC COLD WATER SUPPLY TO EXTERIOR HOSE BIBS TO REMAIN. 23 EXISTING 4" IRRIGARION SYSTEM SUPPLY TO REMAIN. 24 SEE DOMESTIC WATER PIPING SCHEMATIC ON DRAWING P502. 25 REMOVE EXISTING 3" VENT LINE THRU ROOF. PATCH HOLE IN ROOF TO RECEIVE NEW ROOFING.

ZIONSVILLE **COMMUNITY HIGH** SCHOOL STADIUM LOCKER BUILDING

> 900 MULBERRY ST. ZIONSVILLE IN, 46077

ZIONSVILLE COMMUNITY SCHOOLS



ARCHITECT

HOWEY

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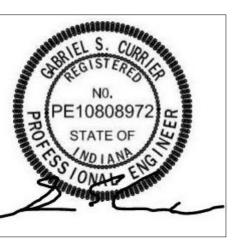


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LOCATION **EXISTING** CONCESSIONS BUILDING **KEY PLAN**

CONSTRUCTION DOCUMENTS





DRAWN BY: LP PROJECT NUMBER: 223139.00

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1	1	Addendum #1	02/14/2024
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DEMOLITION FIRST FLOOR PLUMBING PLAN

PD1A



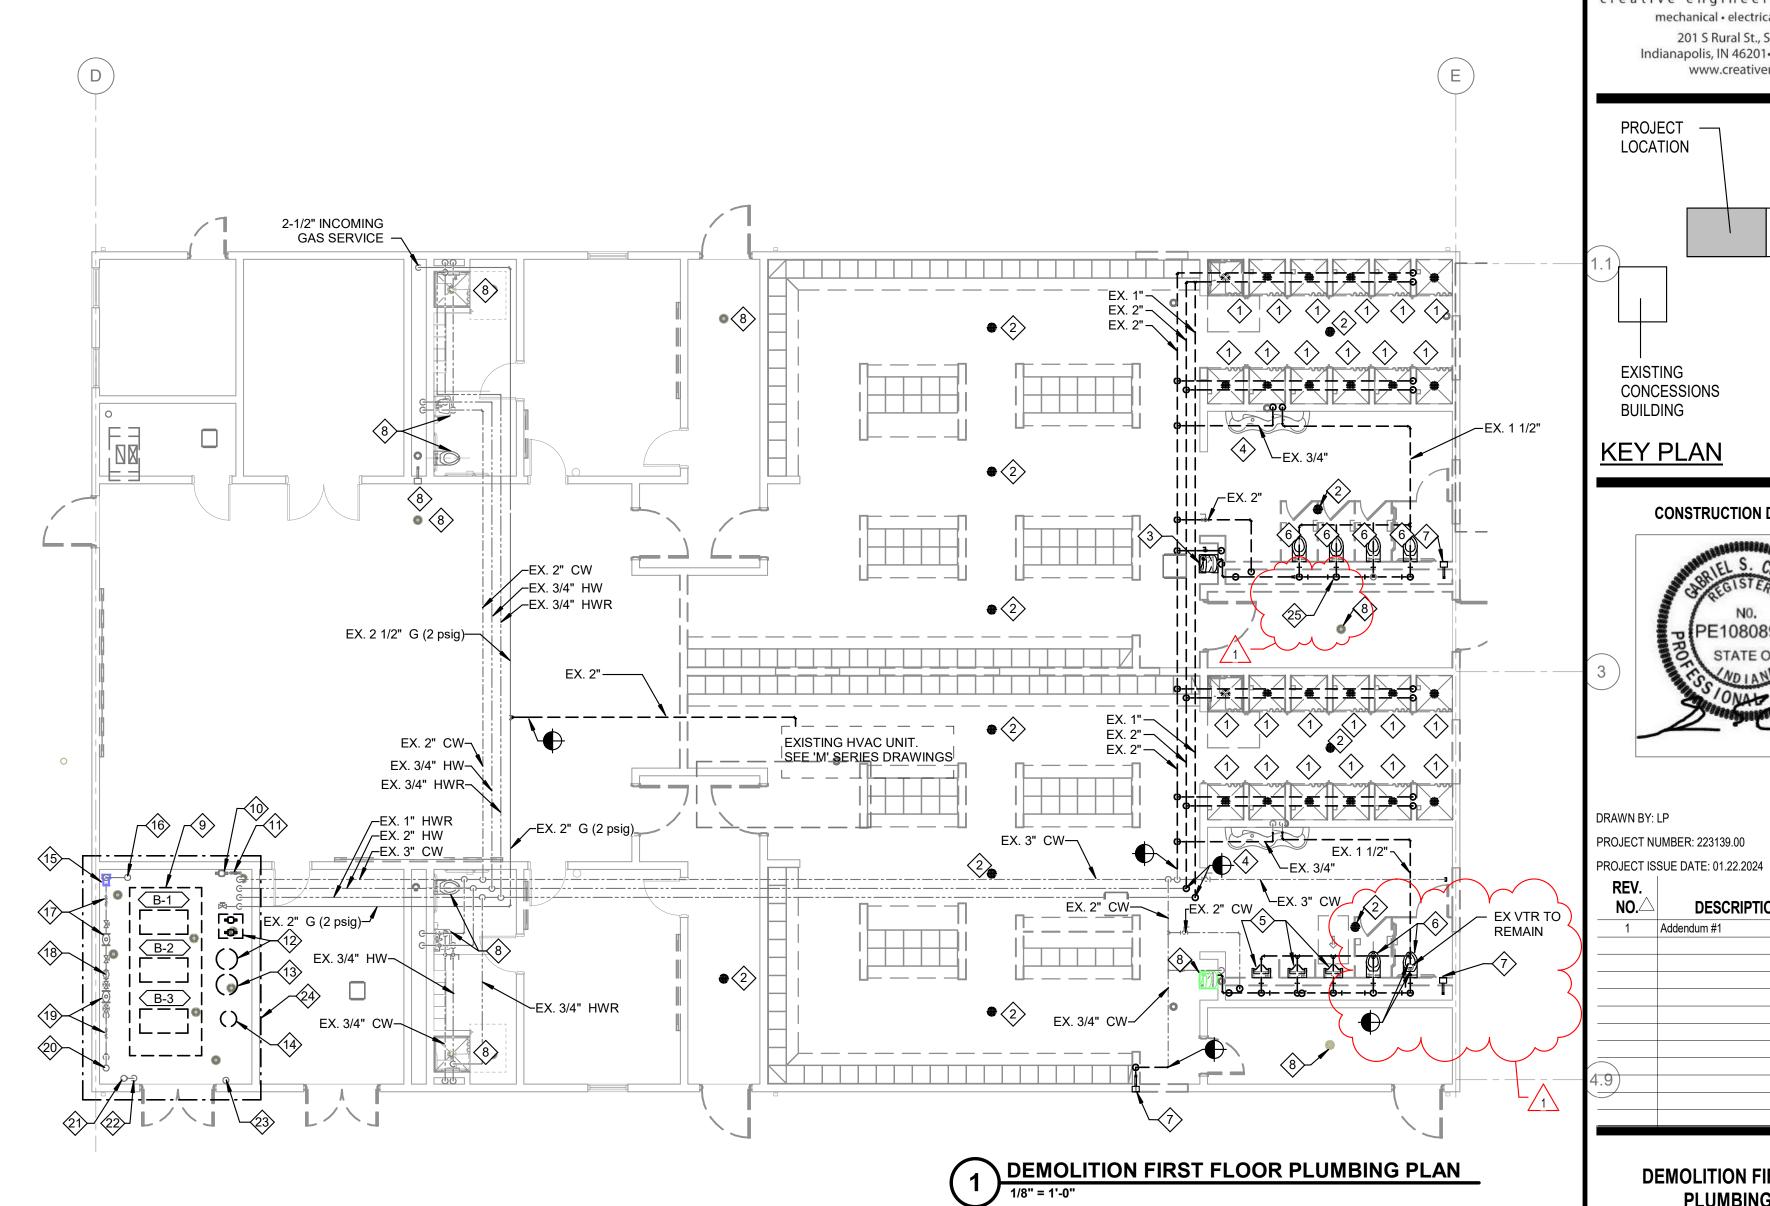

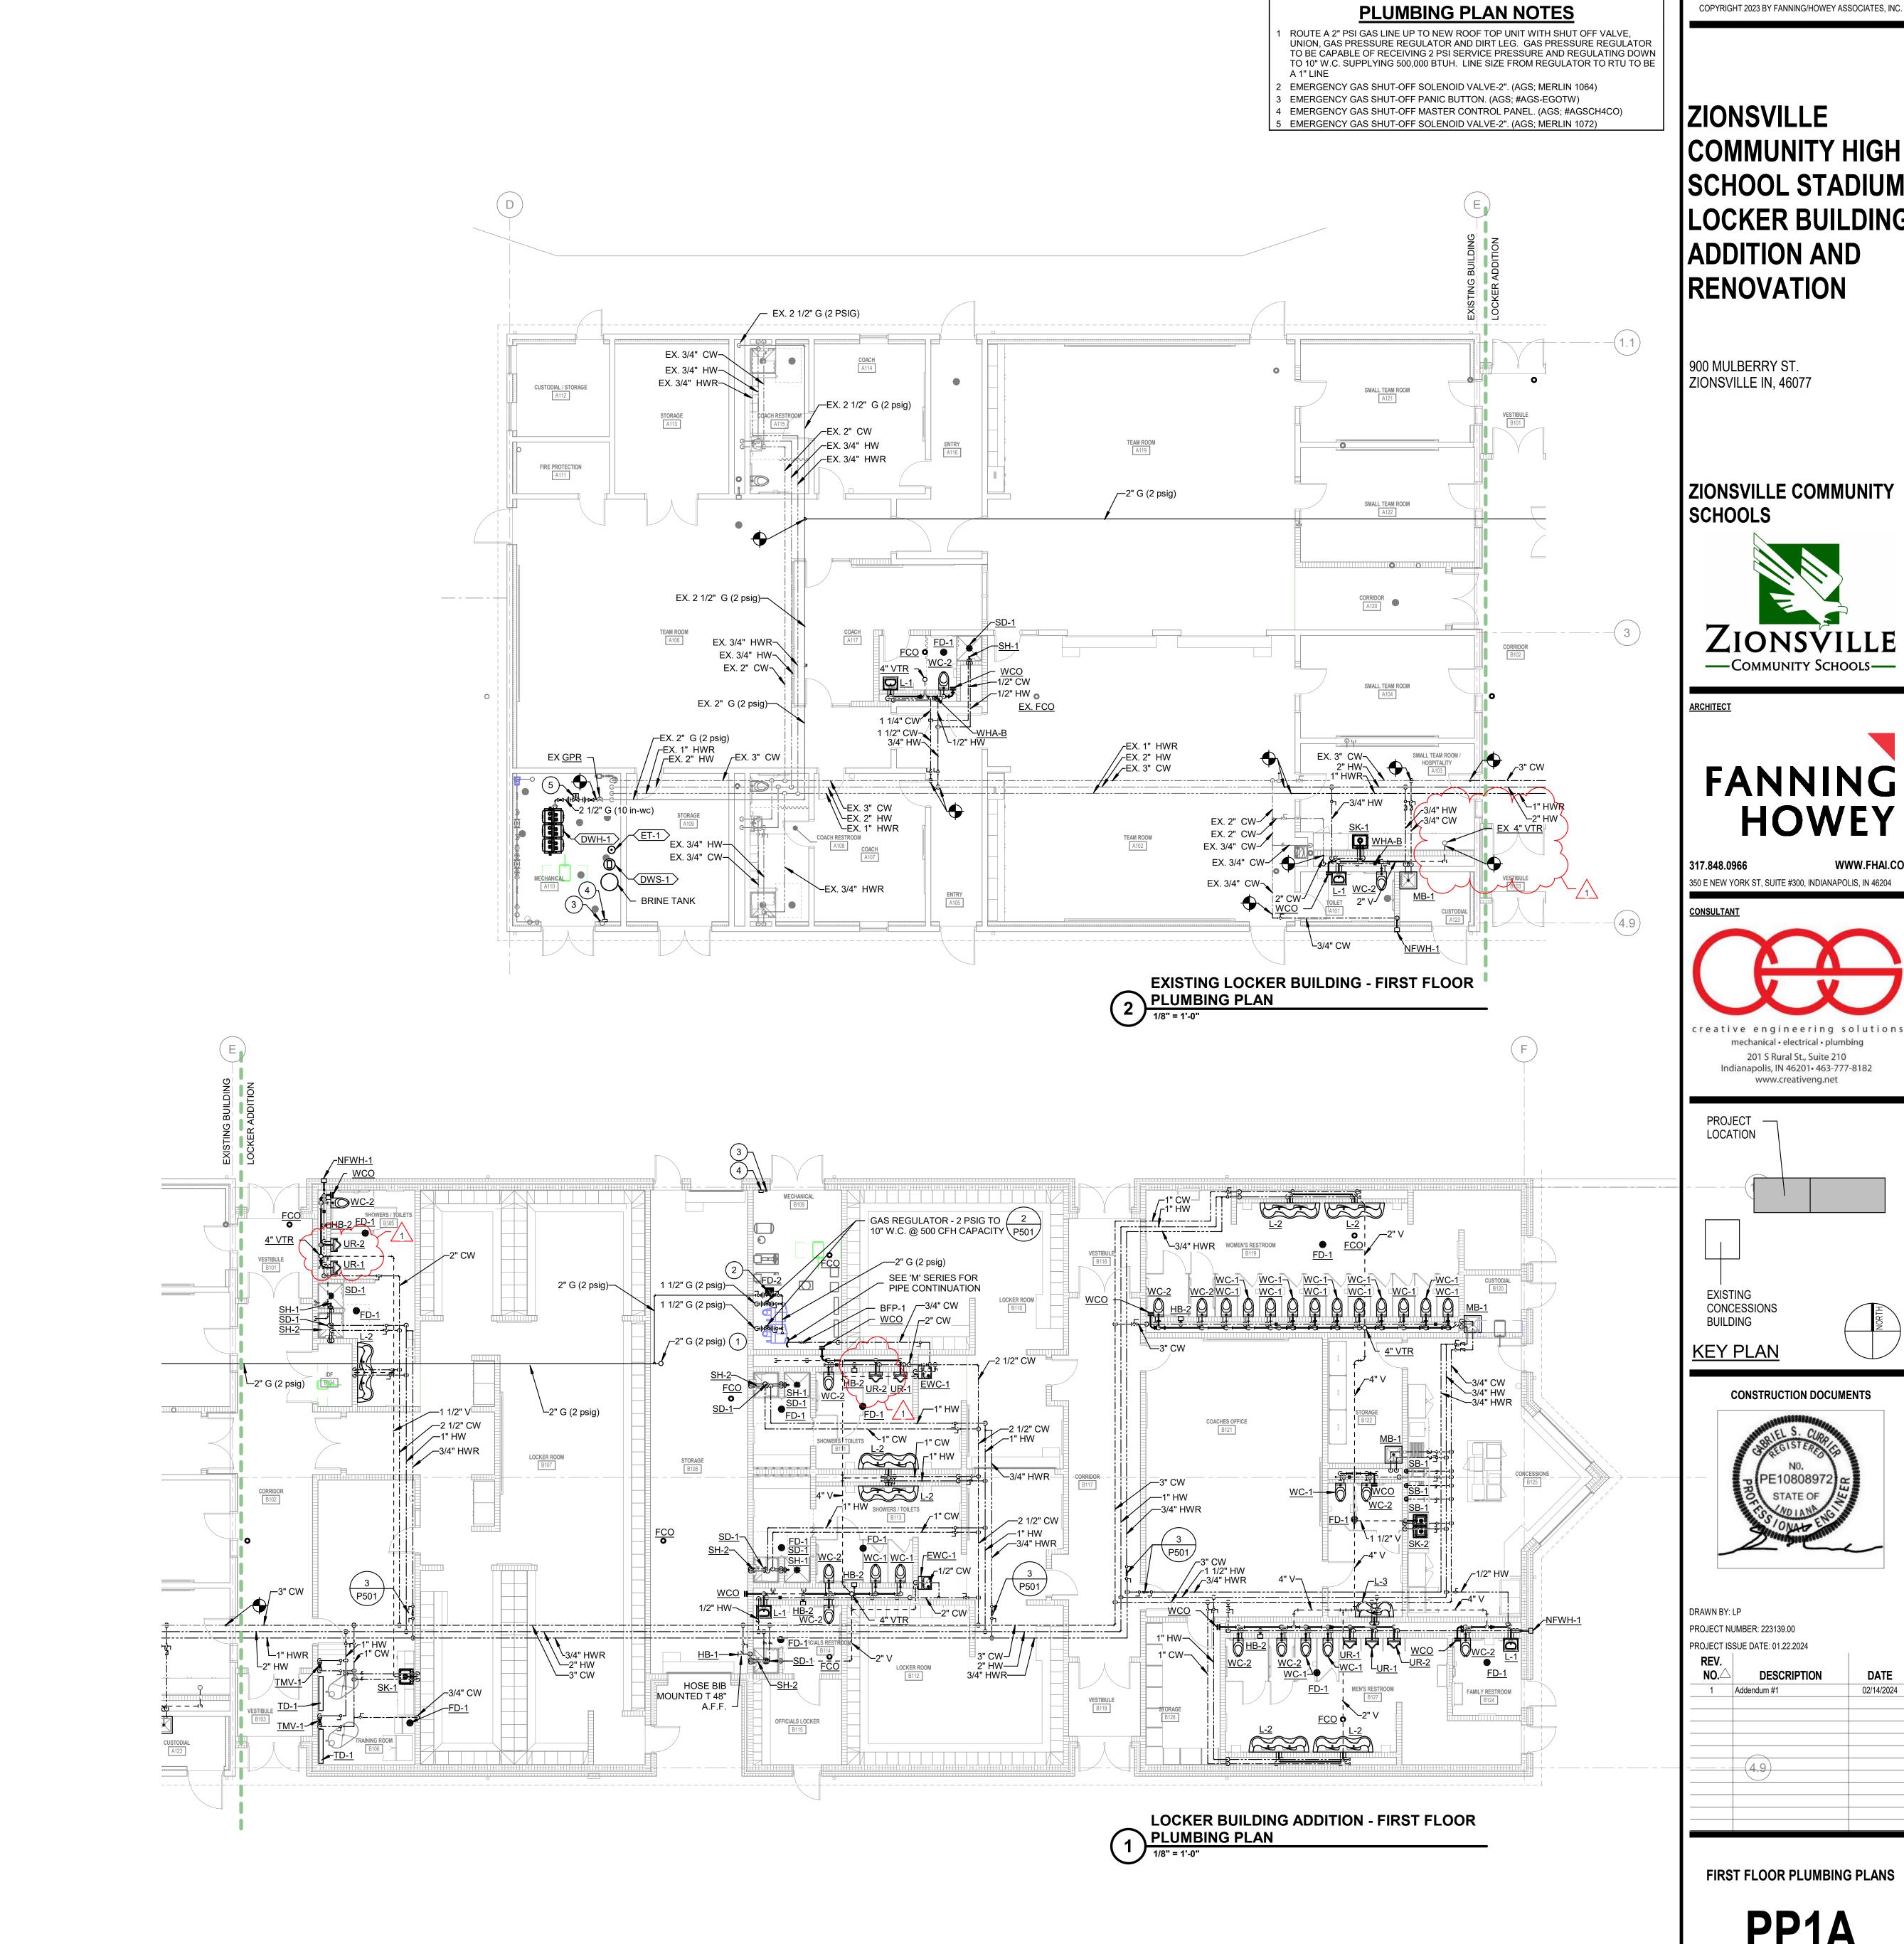
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COMMUNITY HIGH SCHOOL STADIUM LOCKER BUILDING



HOWEY



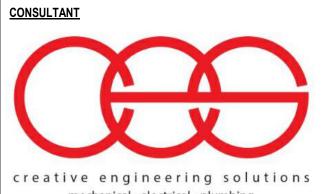

REV. NO.△	DESCRIPTION	DATE
1	Addendum #1	02/14/2024
	(4.9)	

ADDENDUM NO. 2

Zionsville Middle School – Tennis Complex Renovation

Zionsville Community Schools Zionsville, Indiana

Project No. 223144.00

Index of Contents

Addendum No. 2, 2 items, 1 page Revised Drawing Sheets: G4.00 and G4.01

Date: February 16, 2024

FANNING/HOWEY ASSOCIATES, INC. ARCHITECTS/ENGINEERS/CONSULTANTS

TO: ALL BIDDERS OF RECORD

ADDENDUM NO. 2 to Drawings and Project Manual, dated January 22, 2024, for Zionsville Community Schools, 900 Mulberry Street, Zionsville, Indiana; as prepared by Fanning/Howey Associates, Inc., Indianapolis, Indiana. This Addendum shall hereby be and become a part of the Contract Documents the same as if originally bound thereto.

The following clarifications, amendments, additions, revisions, changes, and modifications change the original Contract Documents only in the amount and to the extent hereinafter specified in this Addendum.

Each bidder shall acknowledge receipt of this Addendum in his proposal or bid.

NOTE: Bidders are responsible for becoming familiar with every item of this Addendum. (This includes miscellaneous items at the very end of this Addendum.)

RE: ALL BIDDERS

ITEM NO. 1. PROJECT MANUAL, SECTION 03 38 16 – UNBONDED POST-TENSIONED CONCRETE

- A. Replace Part 2, Article 5., A., as follows:
 - "A. Concrete shall have a compressive strength of not less than 5,000 psi after twenty-eight (28) days. Ready mixed concrete shall be mixed and delivered according to ASTM C94 Specifications for ready-mixed concrete with a 4 inch maximum slump. The concrete mix shall be designed to minimize shrinkage by limiting water and cement content and by using well graded course aggregate. Mix design as follows (final mix design shall be subject to review of delegated design structural engineer for the work of this section):
 - 1. Compressive Strength: 5000 psi after twenty-eight (28) days.
 - Cement Type I or IA Cement should conform to one of the Standard Specifications for Portland Cement. ASTM C150 OR Specifications for Blending Hydraulic Cements, ASTM C595, excluding slag Cements Types S and SA.
 - 3. Cement Preferred : Class S 5000 psi mix with no air voids follow written directions from PT manuf.
 - 4. Air Entrainment by total volume of concrete shall be 5 percent to 7 percent for 1 inch maximum size coarse aggregate.
 - 5. Aggregate should conform to standard specifications for Concrete Aggregates ASTM C33. For concrete work that is 5 inches thick, the nominal size of the course aggregate should not exceed 1 inch.
 - 6. Do not use fly ash or other additives.
 - 7. Do not use curing compounds."

ITEM NO. 2. REVISED DRAWING SHEETS

A. Drawing Sheets: G4.00 and G4.01 have been revised, dated 02/16/24, and are included with and hereby made a part of this Addendum. These Drawings supersede the original documents.

END OF ADDENDUM




PRE-BID REQUEST FOR INTERPRETATION/CLARIFICATION LOG					
Project No.	RFI#	Date Received	Request for Interpretation Item	Dwg./Spec.	Response
ADDENDUM N	O. 01				
223144.00	1	2/1/24	Substitution Request for Tennis Court Color Coating Surfacing System; proposed substitution - Plexipave, DecoColor, ICP Building Solutions Group	32 18 26	Substitution Approved
223144.00	2	2/9/24	 There are different Post diameters listed for the 10' Chain link fence on the Courts. Could you please advise which is correct? Detail 9/G4.00 – 4" Terminal Post, 4" Line Post Note 5 / G1.00 – 4" Terminal Post, 3" Line Post In the specs – 5" Terminal Post, 3" Line Post There is a difference in Post embedment between drawings and specs. Could you please advise which is correct? Plans Detail 8/4.00 – 54" Embedment on all Posts Specs – 34" embedment for line post c. 60" embedment for Terminal/Gate Post 		Please follow the information listed within the Project Manual for both items pertaining to new fencing post diameters and embedment depths. Refer to Addendum No. 2.
ADDENDUM N	O. 02	1			,
			DET 4/G4.01 thickened slab for center strap anchor section does not have a dimension on the width of the thickened slab		1.Refer to Addendum 2 drawing. 2.Refer to Addendum 2 drawing.
			2. For the underslab vapor barrier is it 2 layers of 10 mil DET 5/G4.01 or 1 layer of 20 mil & 1 layer of 6 mil DET 4/G4.01		3.Refer to Addendum 2 drawing.4.Sidewalks must be 6" thick.
			3. DET 1/G4.00 mono curb & walk doesn't have a depth dimension for the mono curb		5.Refer to Addendum 2 drawing.
			4. Can the sidewalk go to 4" instead of 6"		6.Refer to Addendum 1 drawing.

223144.00 Page 1



5. Can we go to fiber mesh instead of wire mesh in the sidewalk	7.FOLLOW DIRECTIONS OF PT MANUF CLASS S 5000 PSI MIX WITH NO AIR VOIDS
6. DET 8/G4.00 post base does not have a	IS SPECIFIED AND DESIRED).
depth dimension for the concrete footing	
7. Can get a more detailed specification with	
an exact mix for the PT concrete? The	
spec mentions a 4000 PSI mix but no	
water cement ratio. Specs say to	
reference CIP concrete specs where	
Class C & S could apply. Class C has air	
and is only 4000 PSI but then Class C is	
a 5000 PSI mix. The PT concrete can't	
have air in it so is the 5000 PSI mix	
desired?	


223144.00 Page 2

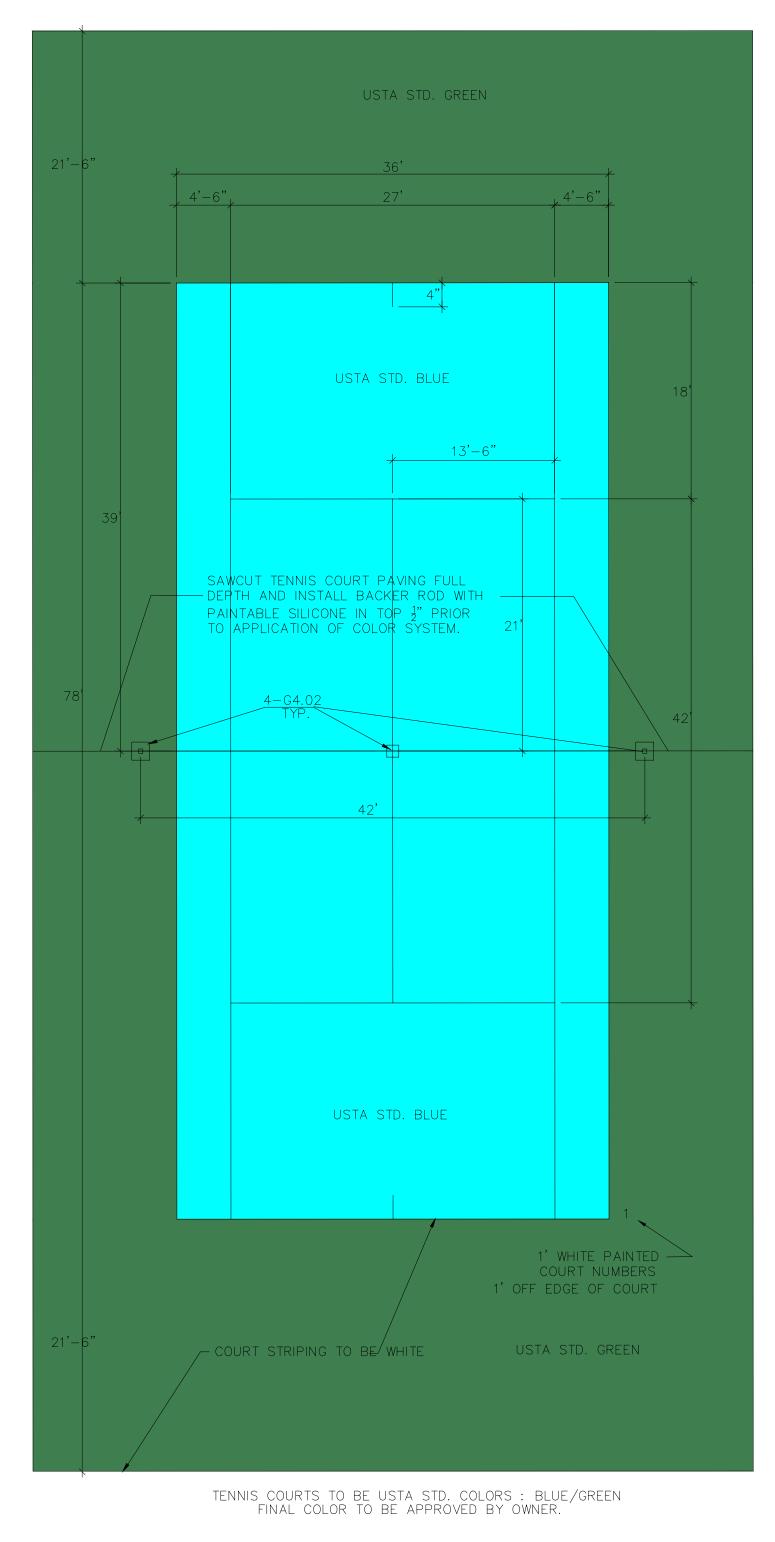



GENERAL NOTES


- NOTES:


 1. TENNIS NET/POSTS: PROVIDE 6 SETS, REFER TO DETAIL 7 ON SHT. G4.01 REFER TO PROJECT MANUAL 11 68 33 ATHLETIC FIELD EQUIPMENT. POSTS ARE TO HAVE INTERIOR WIND MECHANISM, 3" SQ POSTS. EACH NET IS TO HAVE AN ADJUSTABLE CENTER STRAP. EACH COURT IS TO HAVE 1 SCORE REPORTER AND 1 TRASH RECEPTACLE, MOUNTED ON THE NET POSTS AT EACH COURT.
- A. EQUIPMENT AS MANUFACTURED BY DOUGLAS (PHONE 1-800-553-8907) "PREMIER 3" SQUARE POST; "TN-50" NET; "SR-357" SCORE REPORTER; "COURT ORDER UNIT"; "OMP-9R" WINDSCREEN WITH "TR-50" TIE-RAP FASTENERS.
- 2. REFER TO SPEC SECTION 32 18 26 TENNIS COURT SURFACING FOR TENNIS COURT PAINTING SYSTEM.
- 3. PAINT A 12" HIGH COURT NUMBER AT EACH COURT. (SOUTHEAST CORNER). FINAL LOCATION OF NUMBERS TO BE PER OWNERS DIRECTIONS.
- 4. PERIMETER FENCE AROUND TENNIS COURTS; ALL FENCING
 TO RECEIVE WINDSCREEN (RED) FINAL COLOR TO BE SELECTED
 BY OWNER PRIOR TO CONSTRUCTION POST TO RECEIVE
 WINDSCREEN ARE TO HAVE POST FOOTING 18" DIA. X 5'-0" DEEP
 AND ARE TO BE ONE OF THE FOLLOWING:
 A. 5" DIA. SCH 40 PIPE, SPACED 10'-0" O.C. MAX.
 B. 4" DIA. SCH 40 PIPE, SPACED 8'-0" O.C. MAX.
- 5. PAINT A 2' HIGH COURT LOGO "Z' BETWEEN EACH COURT. FINAL LOCATION OF LOGO, STYLE, COLORS AND PLACEMENT TO BE PER OWNERS DIRECTIONS.

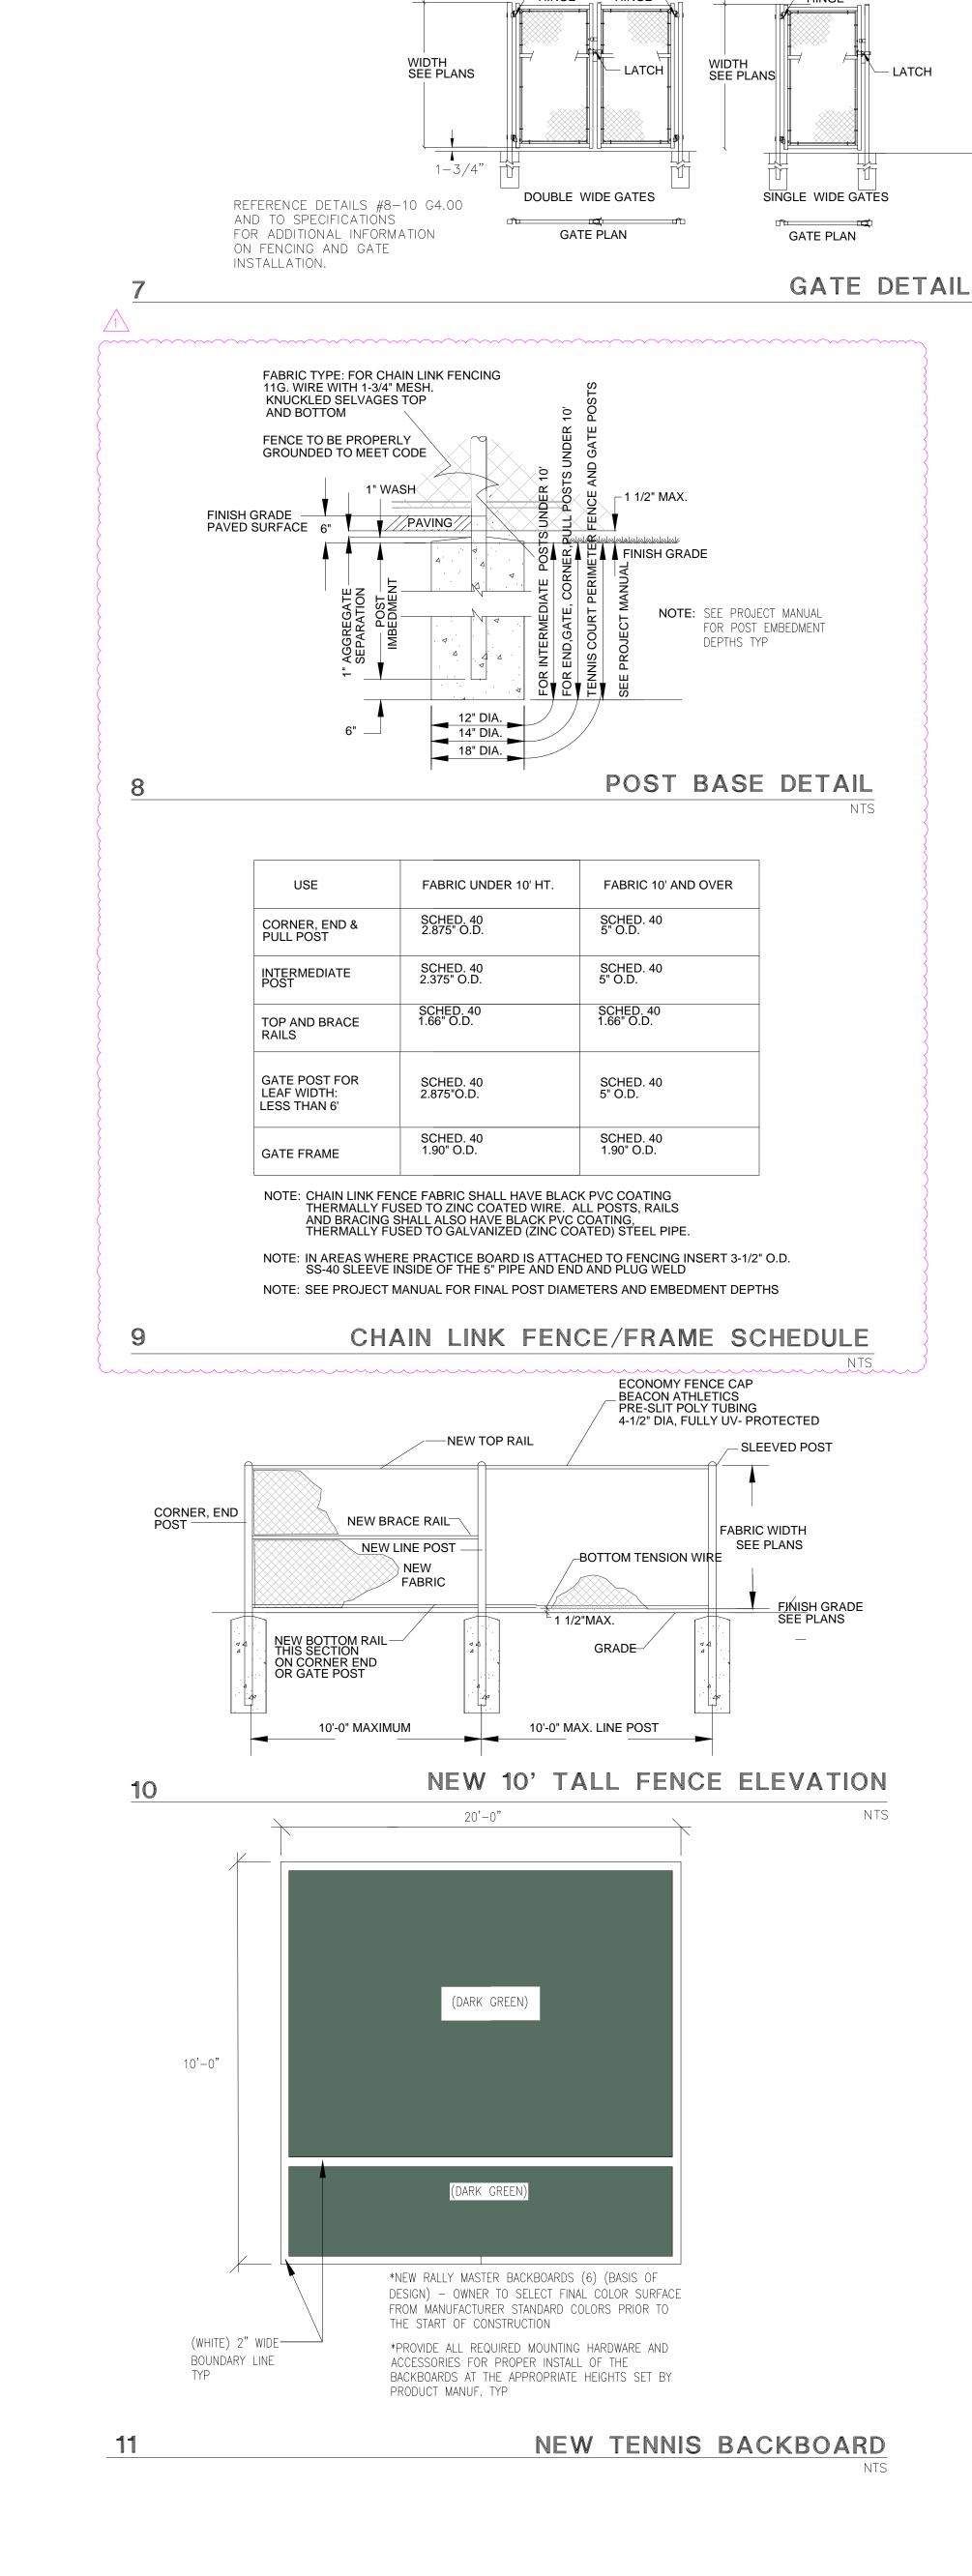


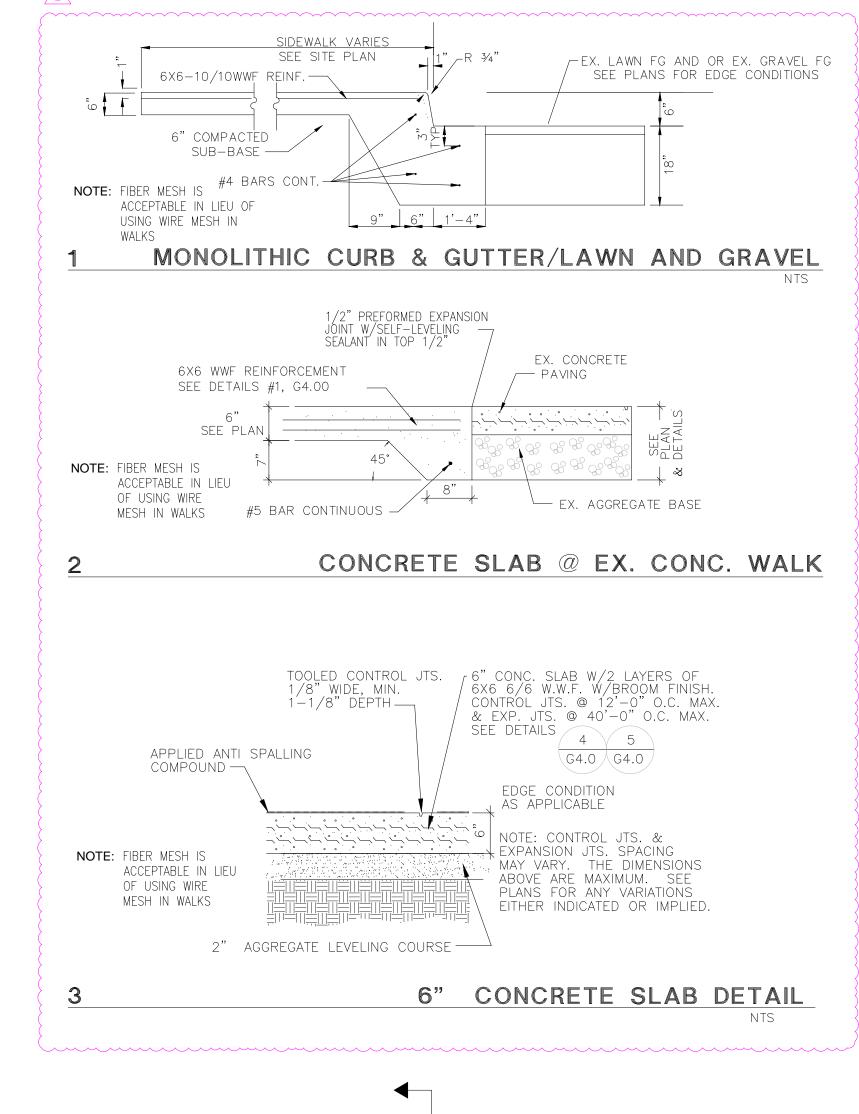

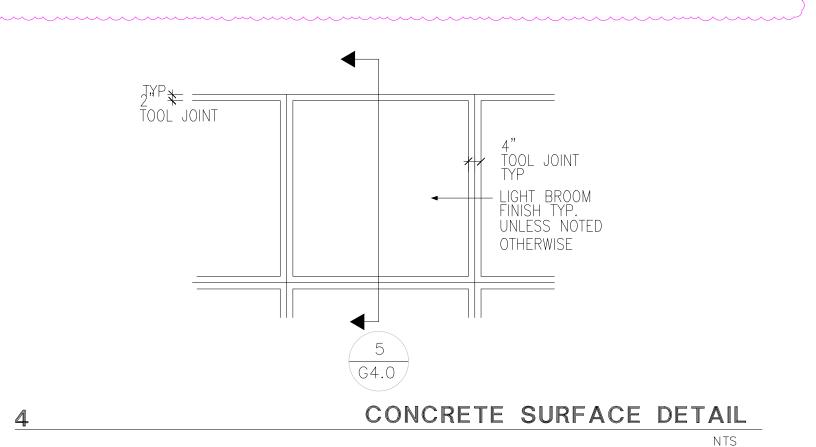

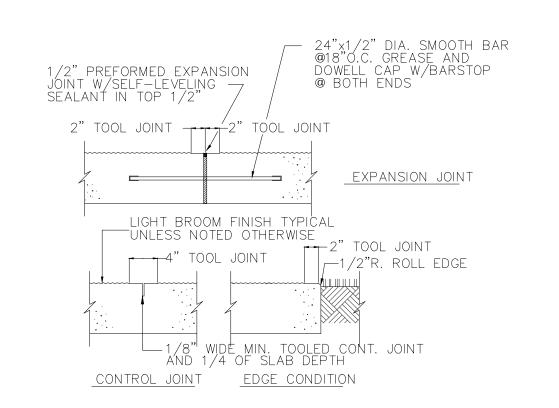

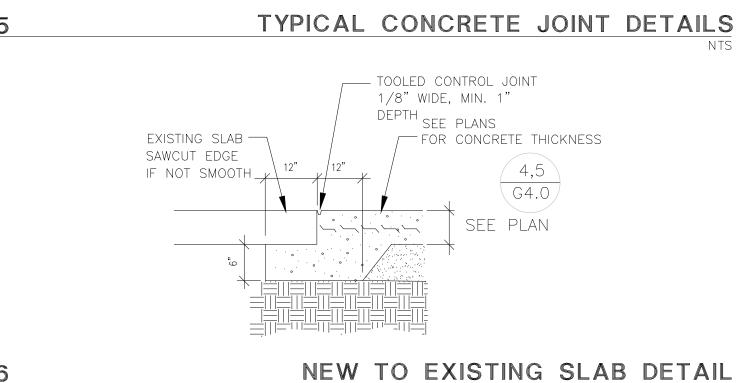

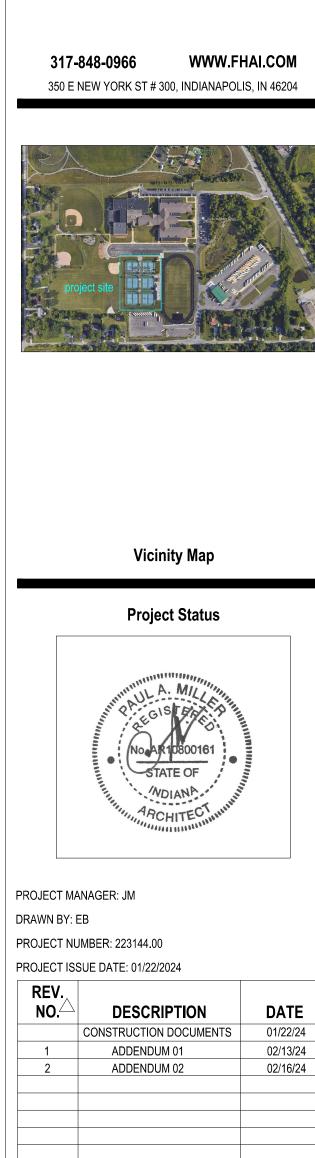

SITE DETAILS

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ZIONSVILLE

RENOVATION

MIDDLE SCHOOL

TENNIS COMPLEX

ZIONSVILLE MIDDLE SCHOOL

900 FORD RD, ZIONSVILLE, IN 46077

ZIONSVILLE COMMUNITY

ZIONSVILLE


—Community Schools—


FANNING


HOWEY

SCHOOLS ZIONSVILLE,

INDIANA

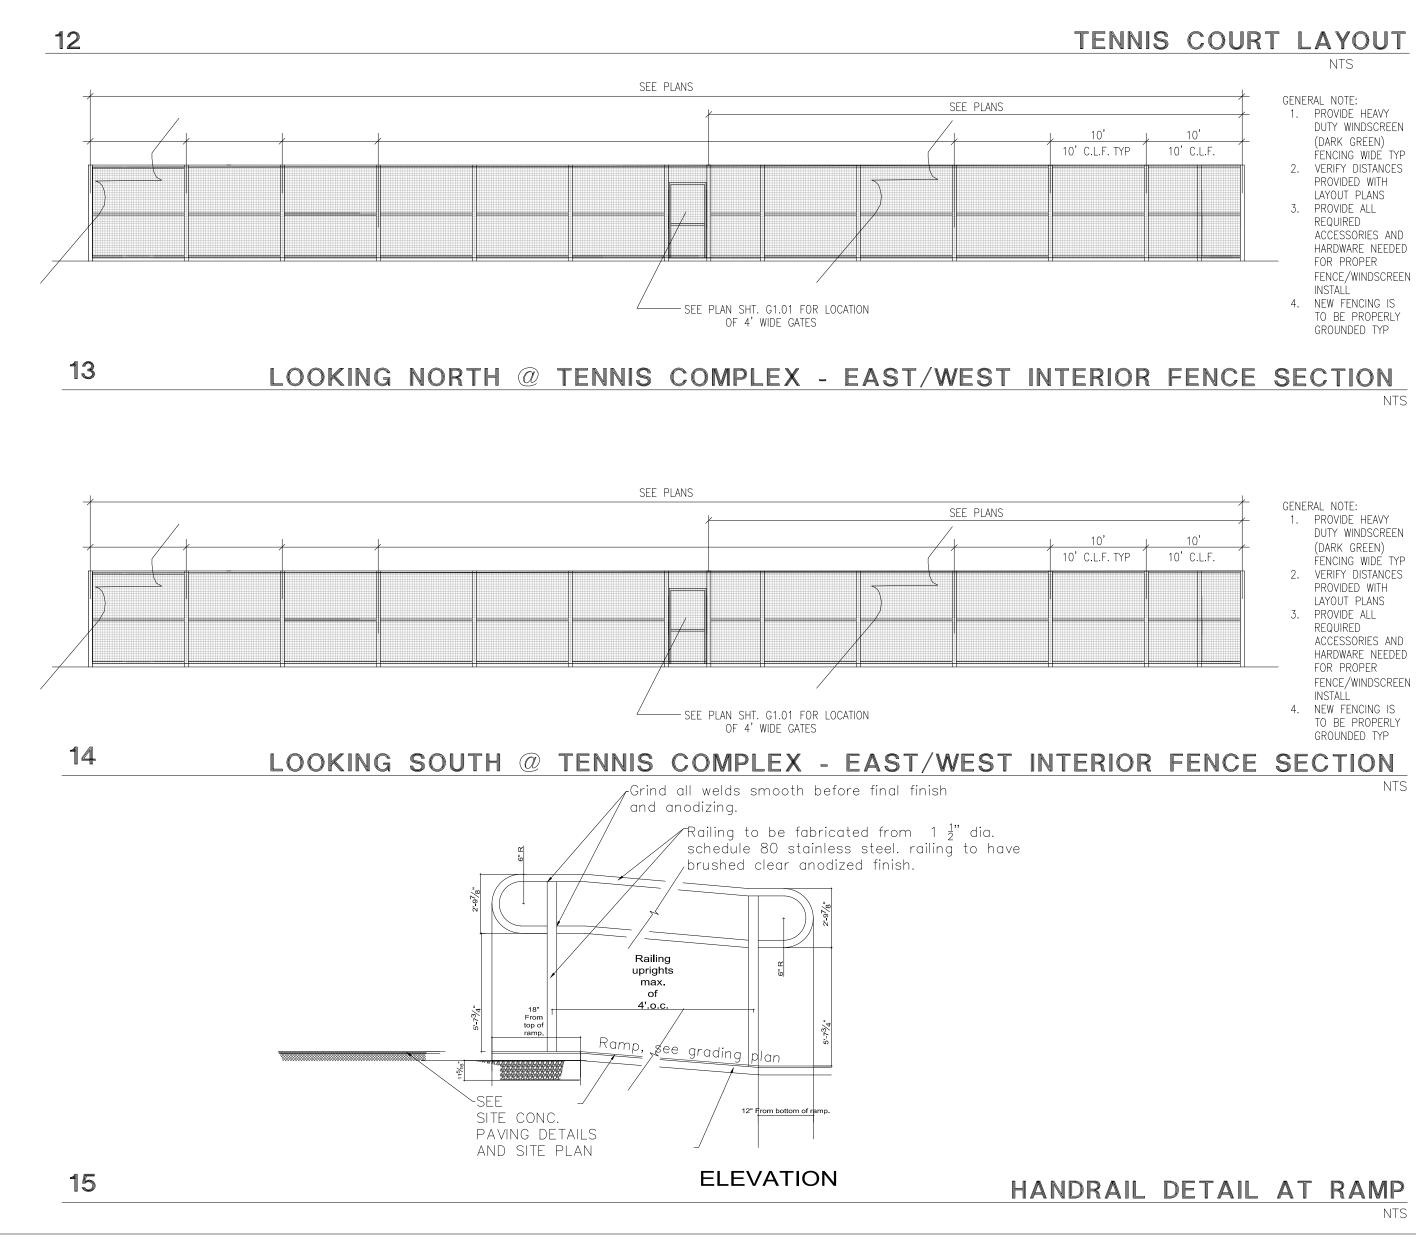


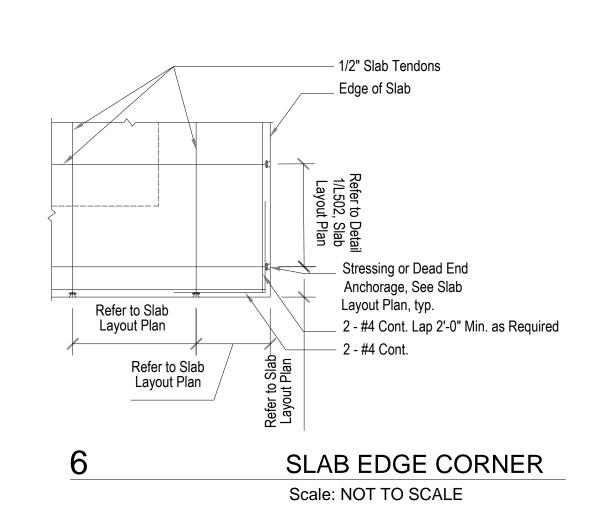


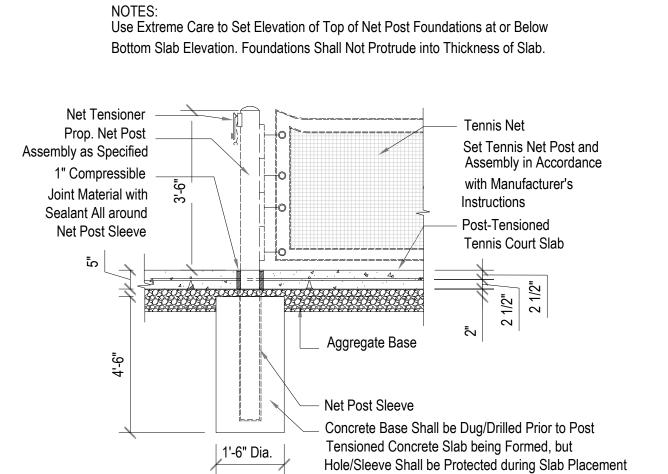



NET POST AND ANCHOR SECTION Scale: NOT TO SCALE

or Post Installed After Slab has been Placed.

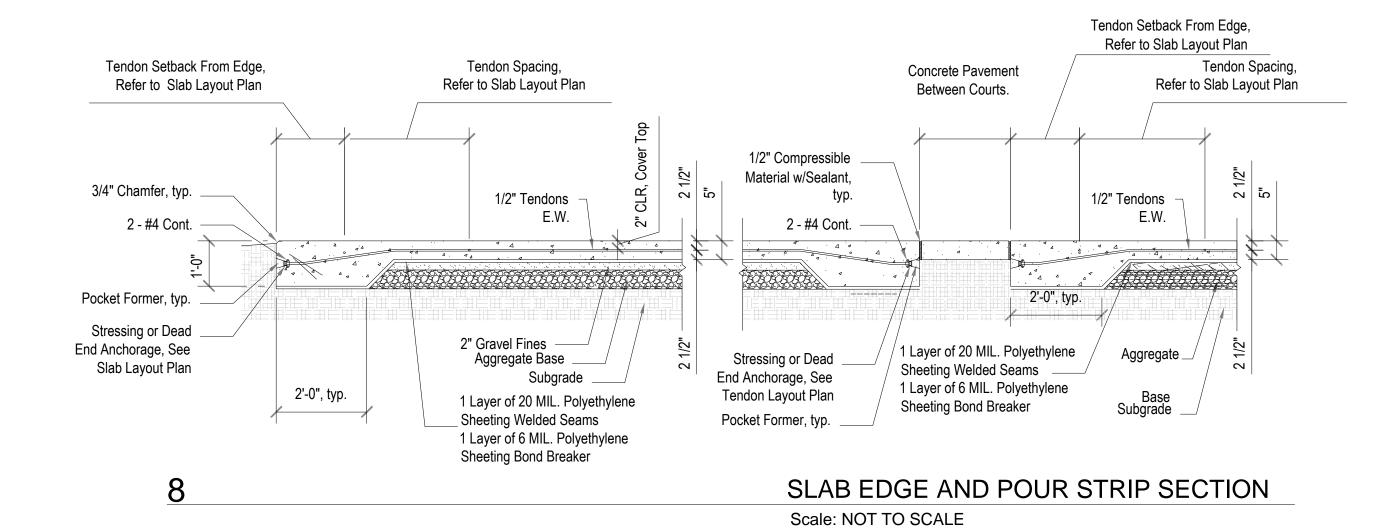

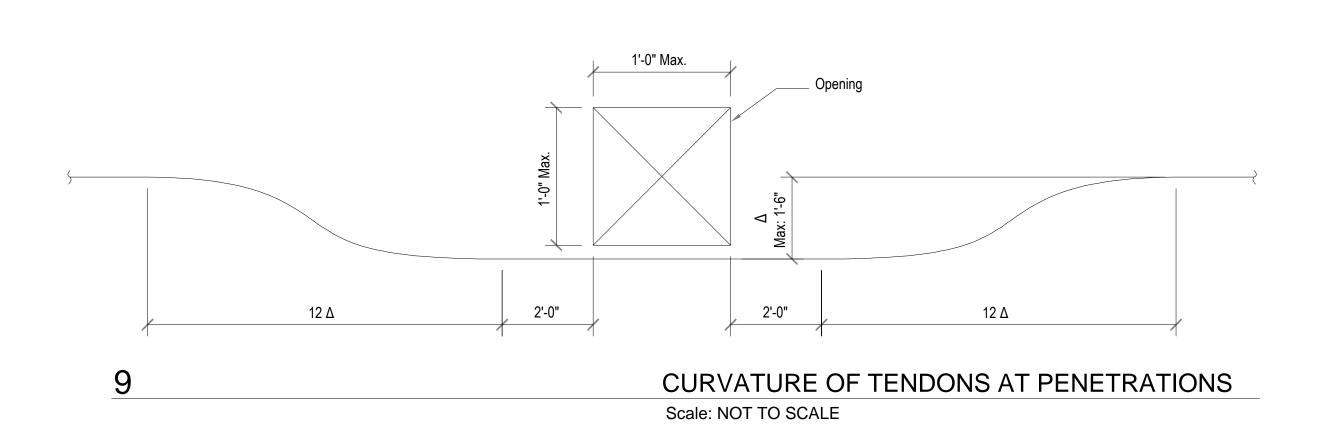


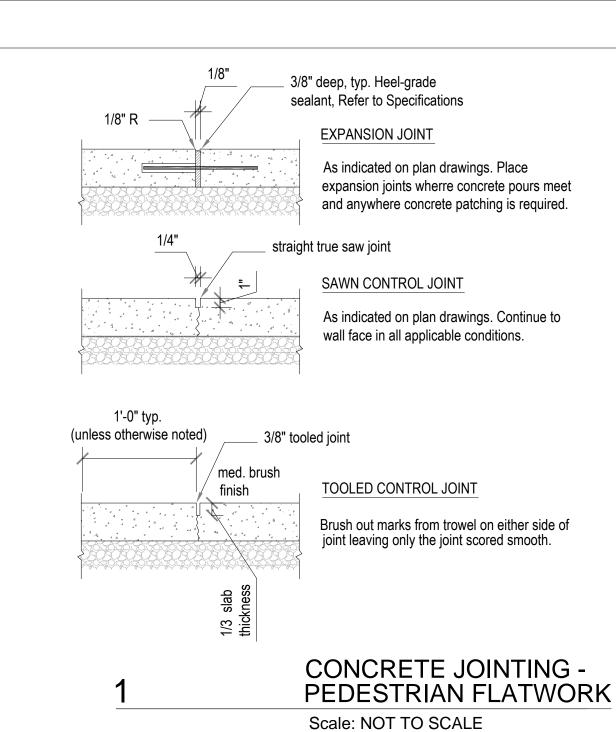

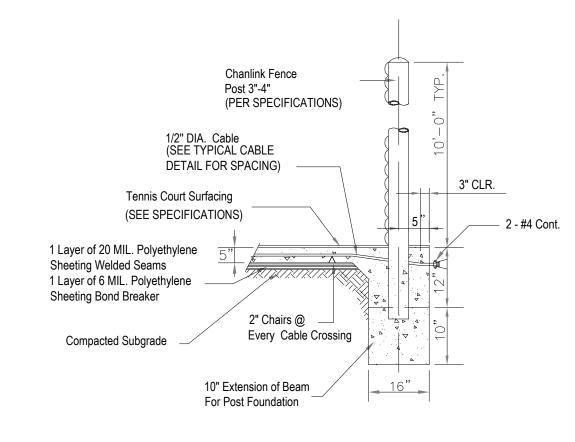


PERIMETER BEAM & FENCE POST DETAIL

Scale: NOT TO SCALE

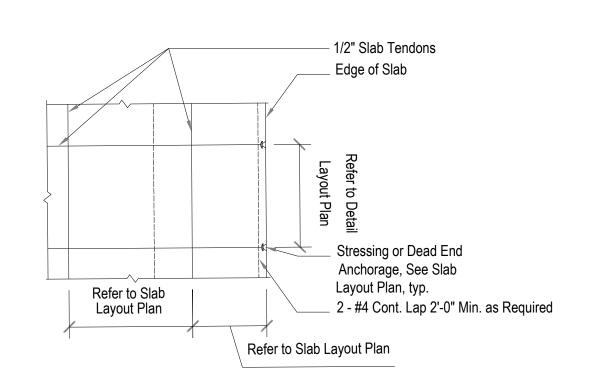

3 SLAB EDGE
Scale: NOT TO SCALE

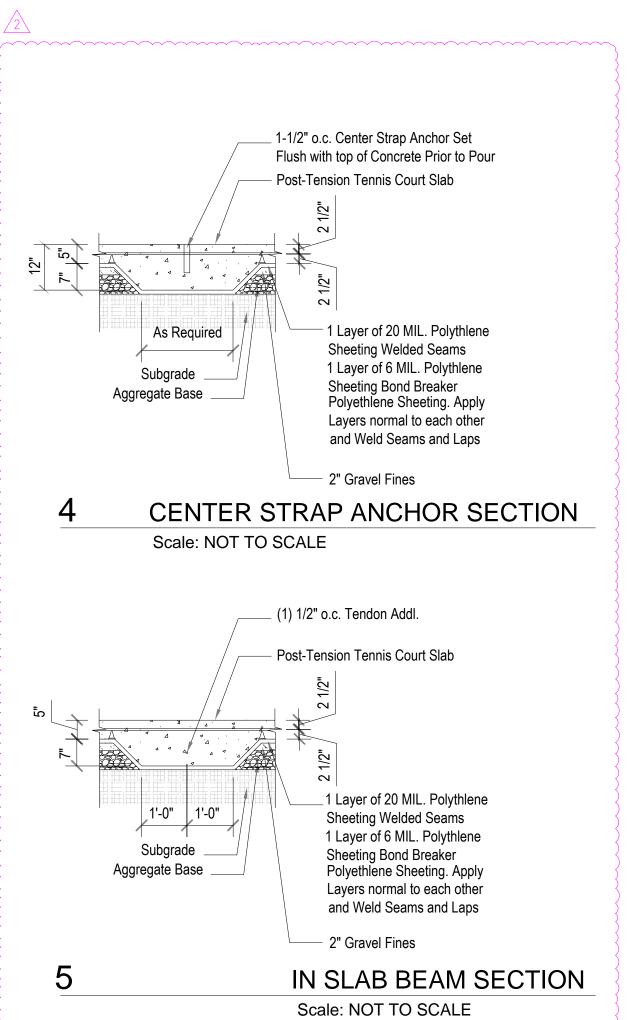

ZIONSVILLE MIDDLE SCHOOL TENNIS COMPLEX

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ZIONSVILLE MIDDLE SCHOOL 900 FORD RD, ZIONSVILLE, IN 46077

RENOVATION

ZIONSVILLE COMMUNITY SCHOOLS ZIONSVILLE, INDIANA




ARCHITECT

FANNING HOWEY

317-848-0966 WWW.FHAI.COM350 E NEW YORK ST # 300, INDIANAPOLIS, IN 46204



Vicinity Map

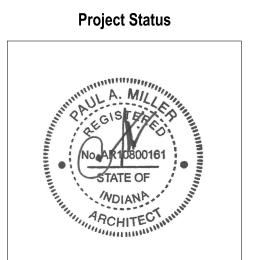

PROJECT MANAGER: JM

DRAWN BY: EB

PROJECT NUMBER: 223144.00

PROJECT ISSUE DATE: 01/22/2024

REV. NO.△	DESCRIPTION	DATE
	CONSTRUCTION DOCUMENTS	01/22/24
2	ADDENDUM 02	02/16/24

PTC / TENNIS SITE DETAILS

G4.01