

01/17/2025

DATE


OWNER KALAMAZOO I SCHOOLS

DEMO

CENTRAL

TAZOO CENTE SCHOOL TICS PROJEC


SHEET NUMBE C 102 23623.00

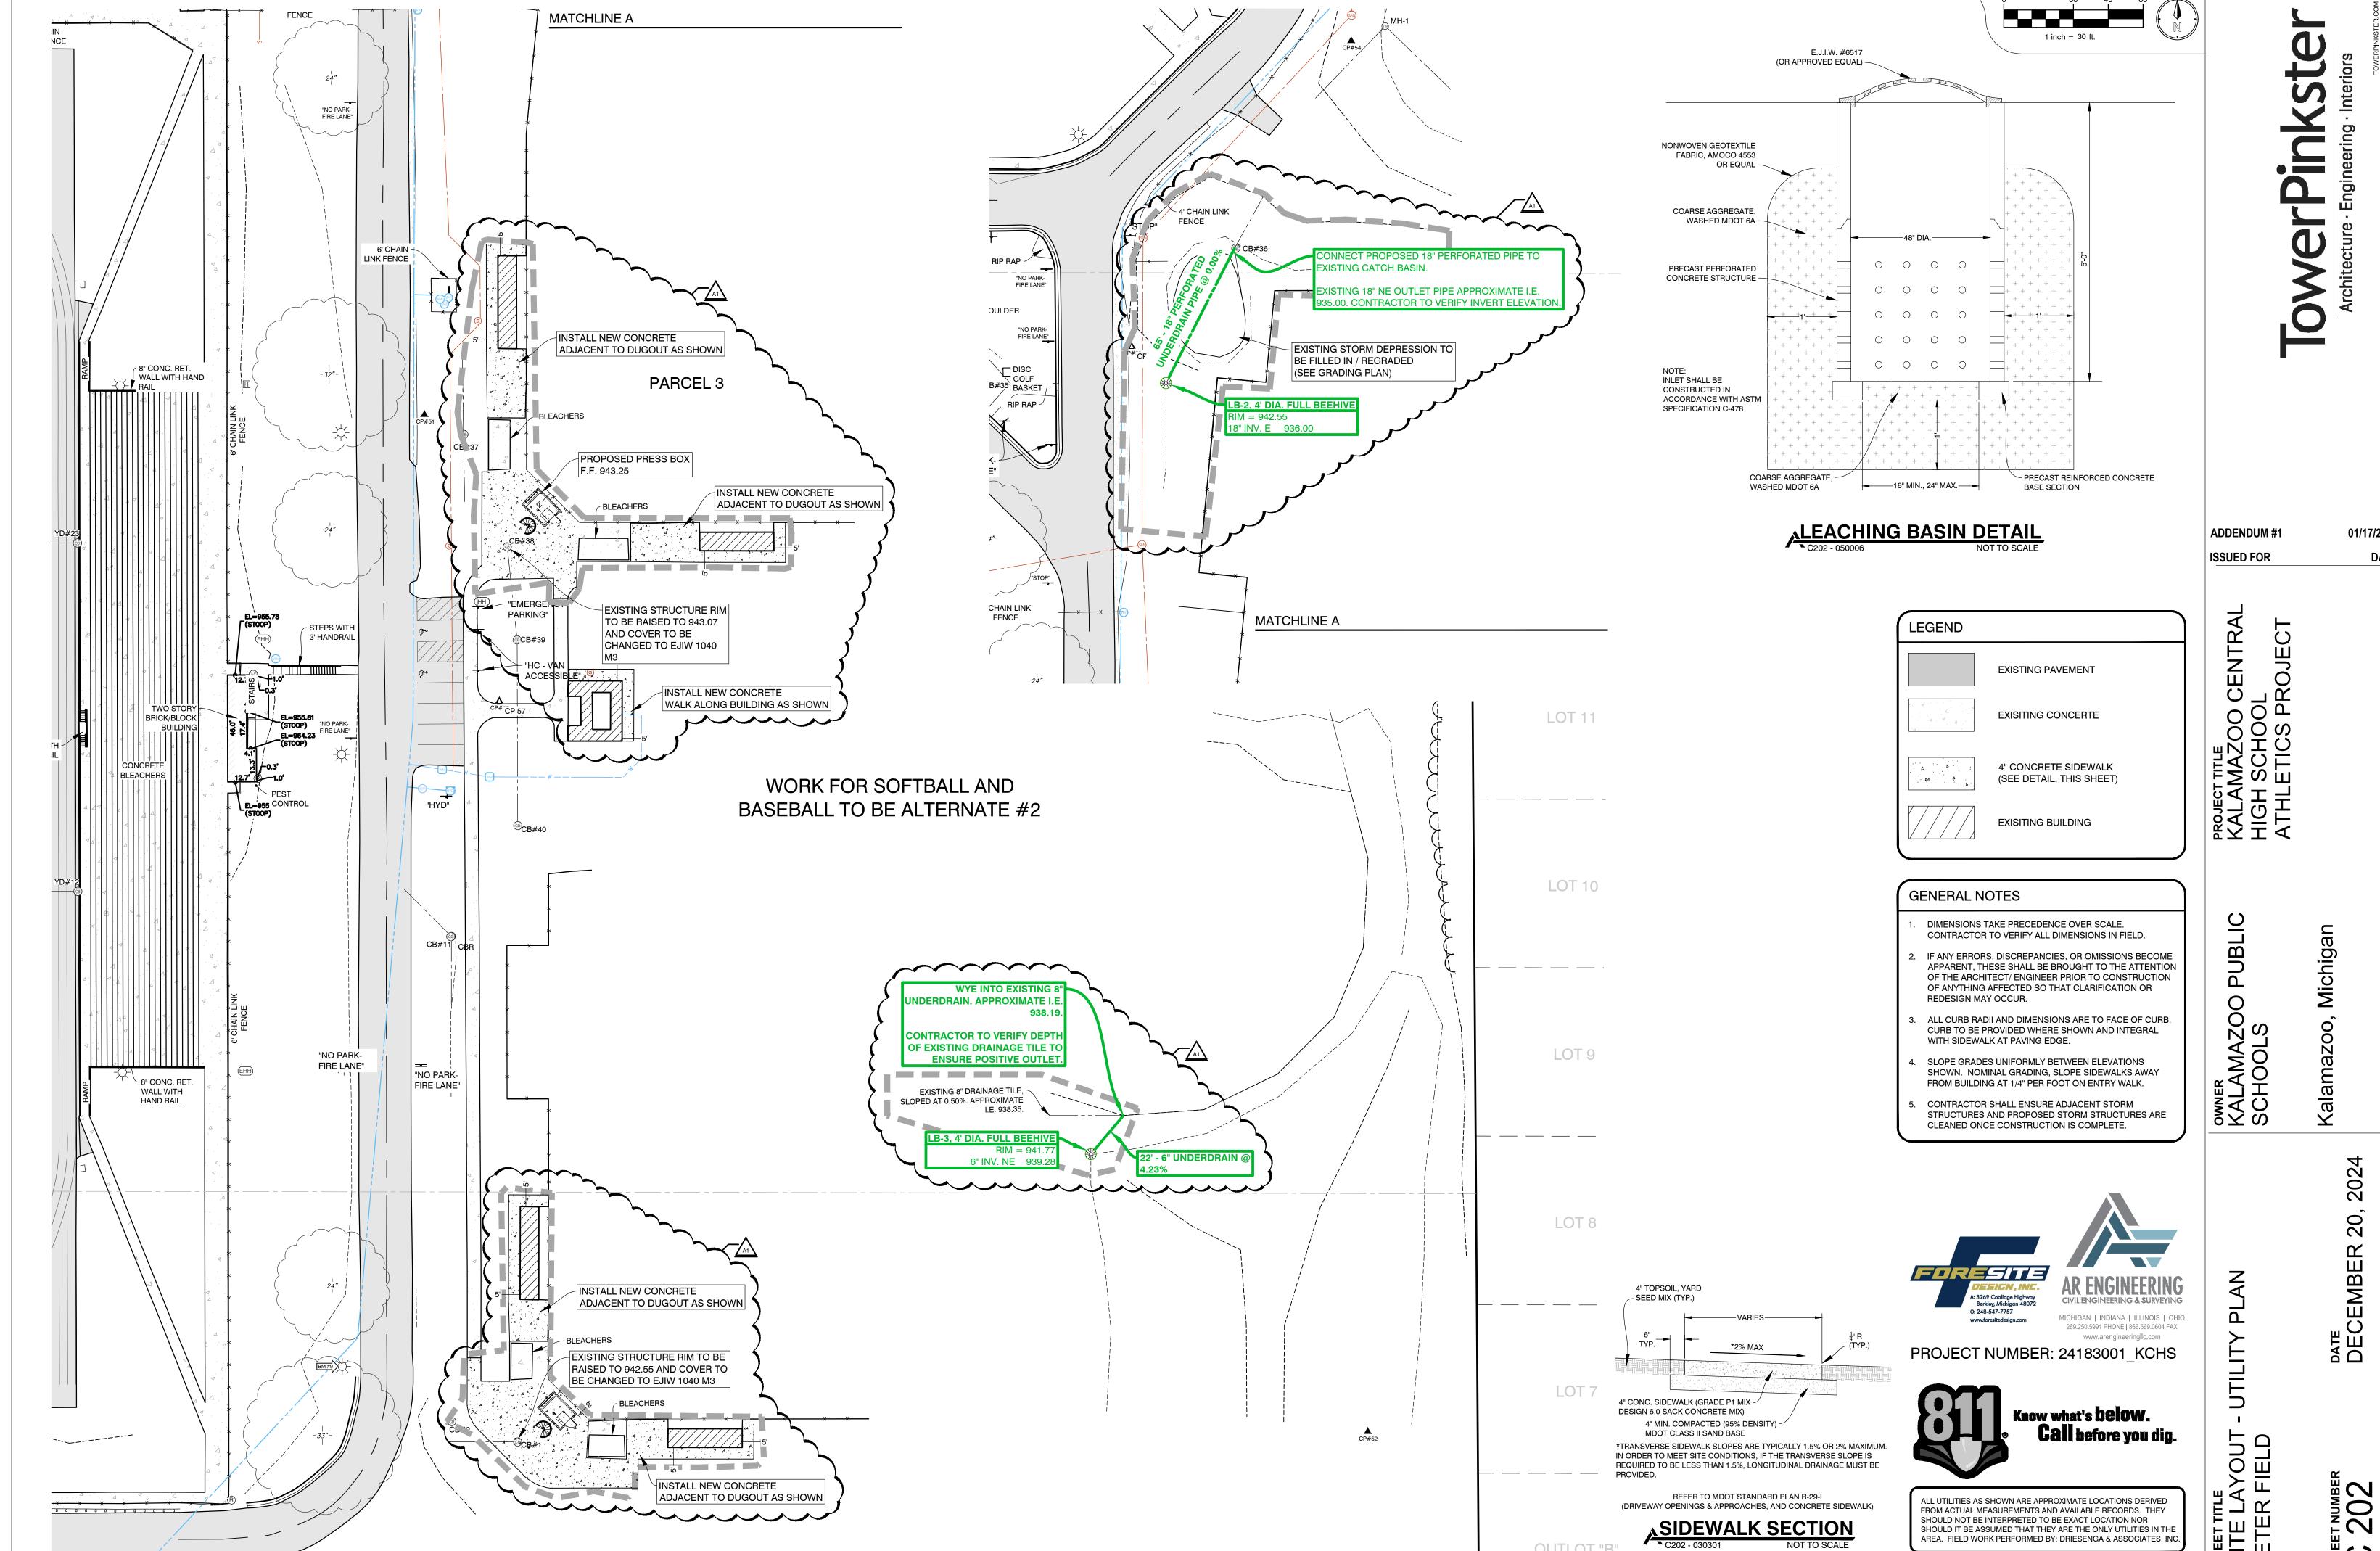

01/17/2025 DATE

SHOULD NOT BE INTERPRETED TO BE EXACT LOCATION NOR SHOULD IT BE ASSUMED THAT THEY ARE THE ONLY UTILITIES IN THE AREA. FIELD WORK PERFORMED BY: DRIESENGA & ASSOCIATES, INC.

OUTLOT "B"

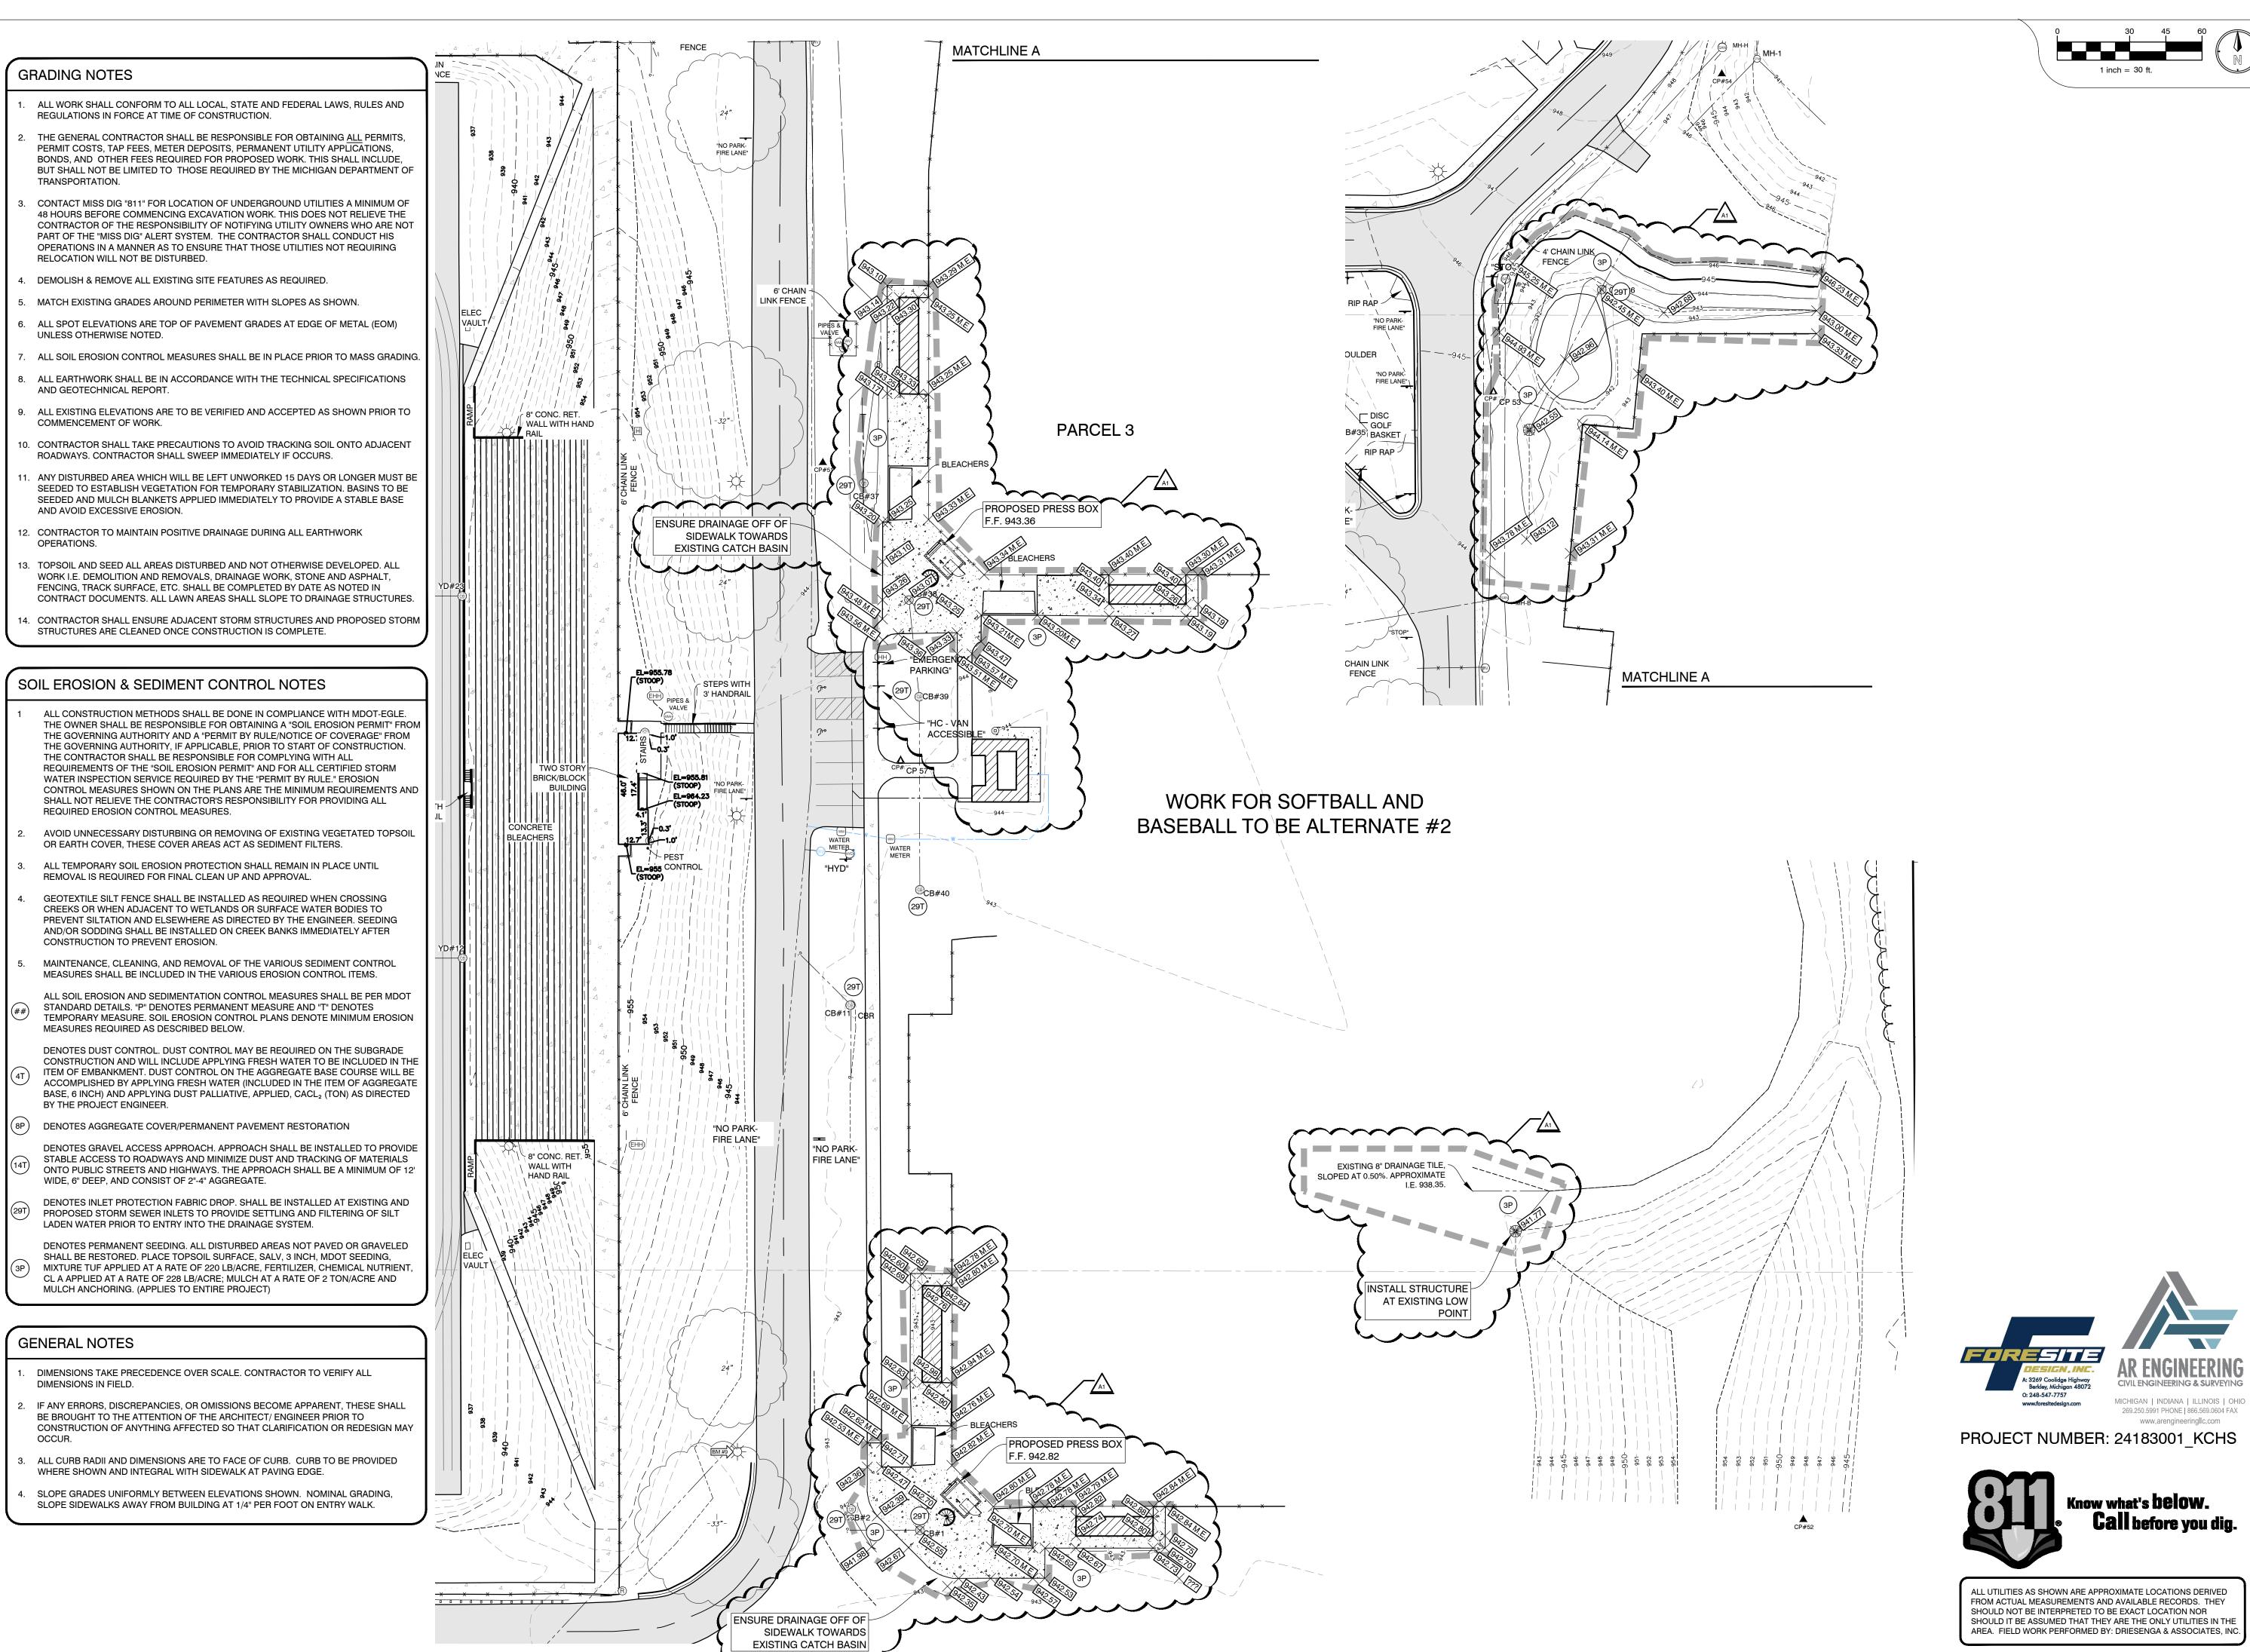

Tower Pinkstel

Architecture · Engineering · Interiors

ADDENDUM #1 01/17/2025
ISSUED FOR DATE

OO CENTRAL OOL S PROJECT

KALAMAZOO CE HIGH SCHOOL

OO PUBLIC

Kalamazoo Mic


Kalamaz

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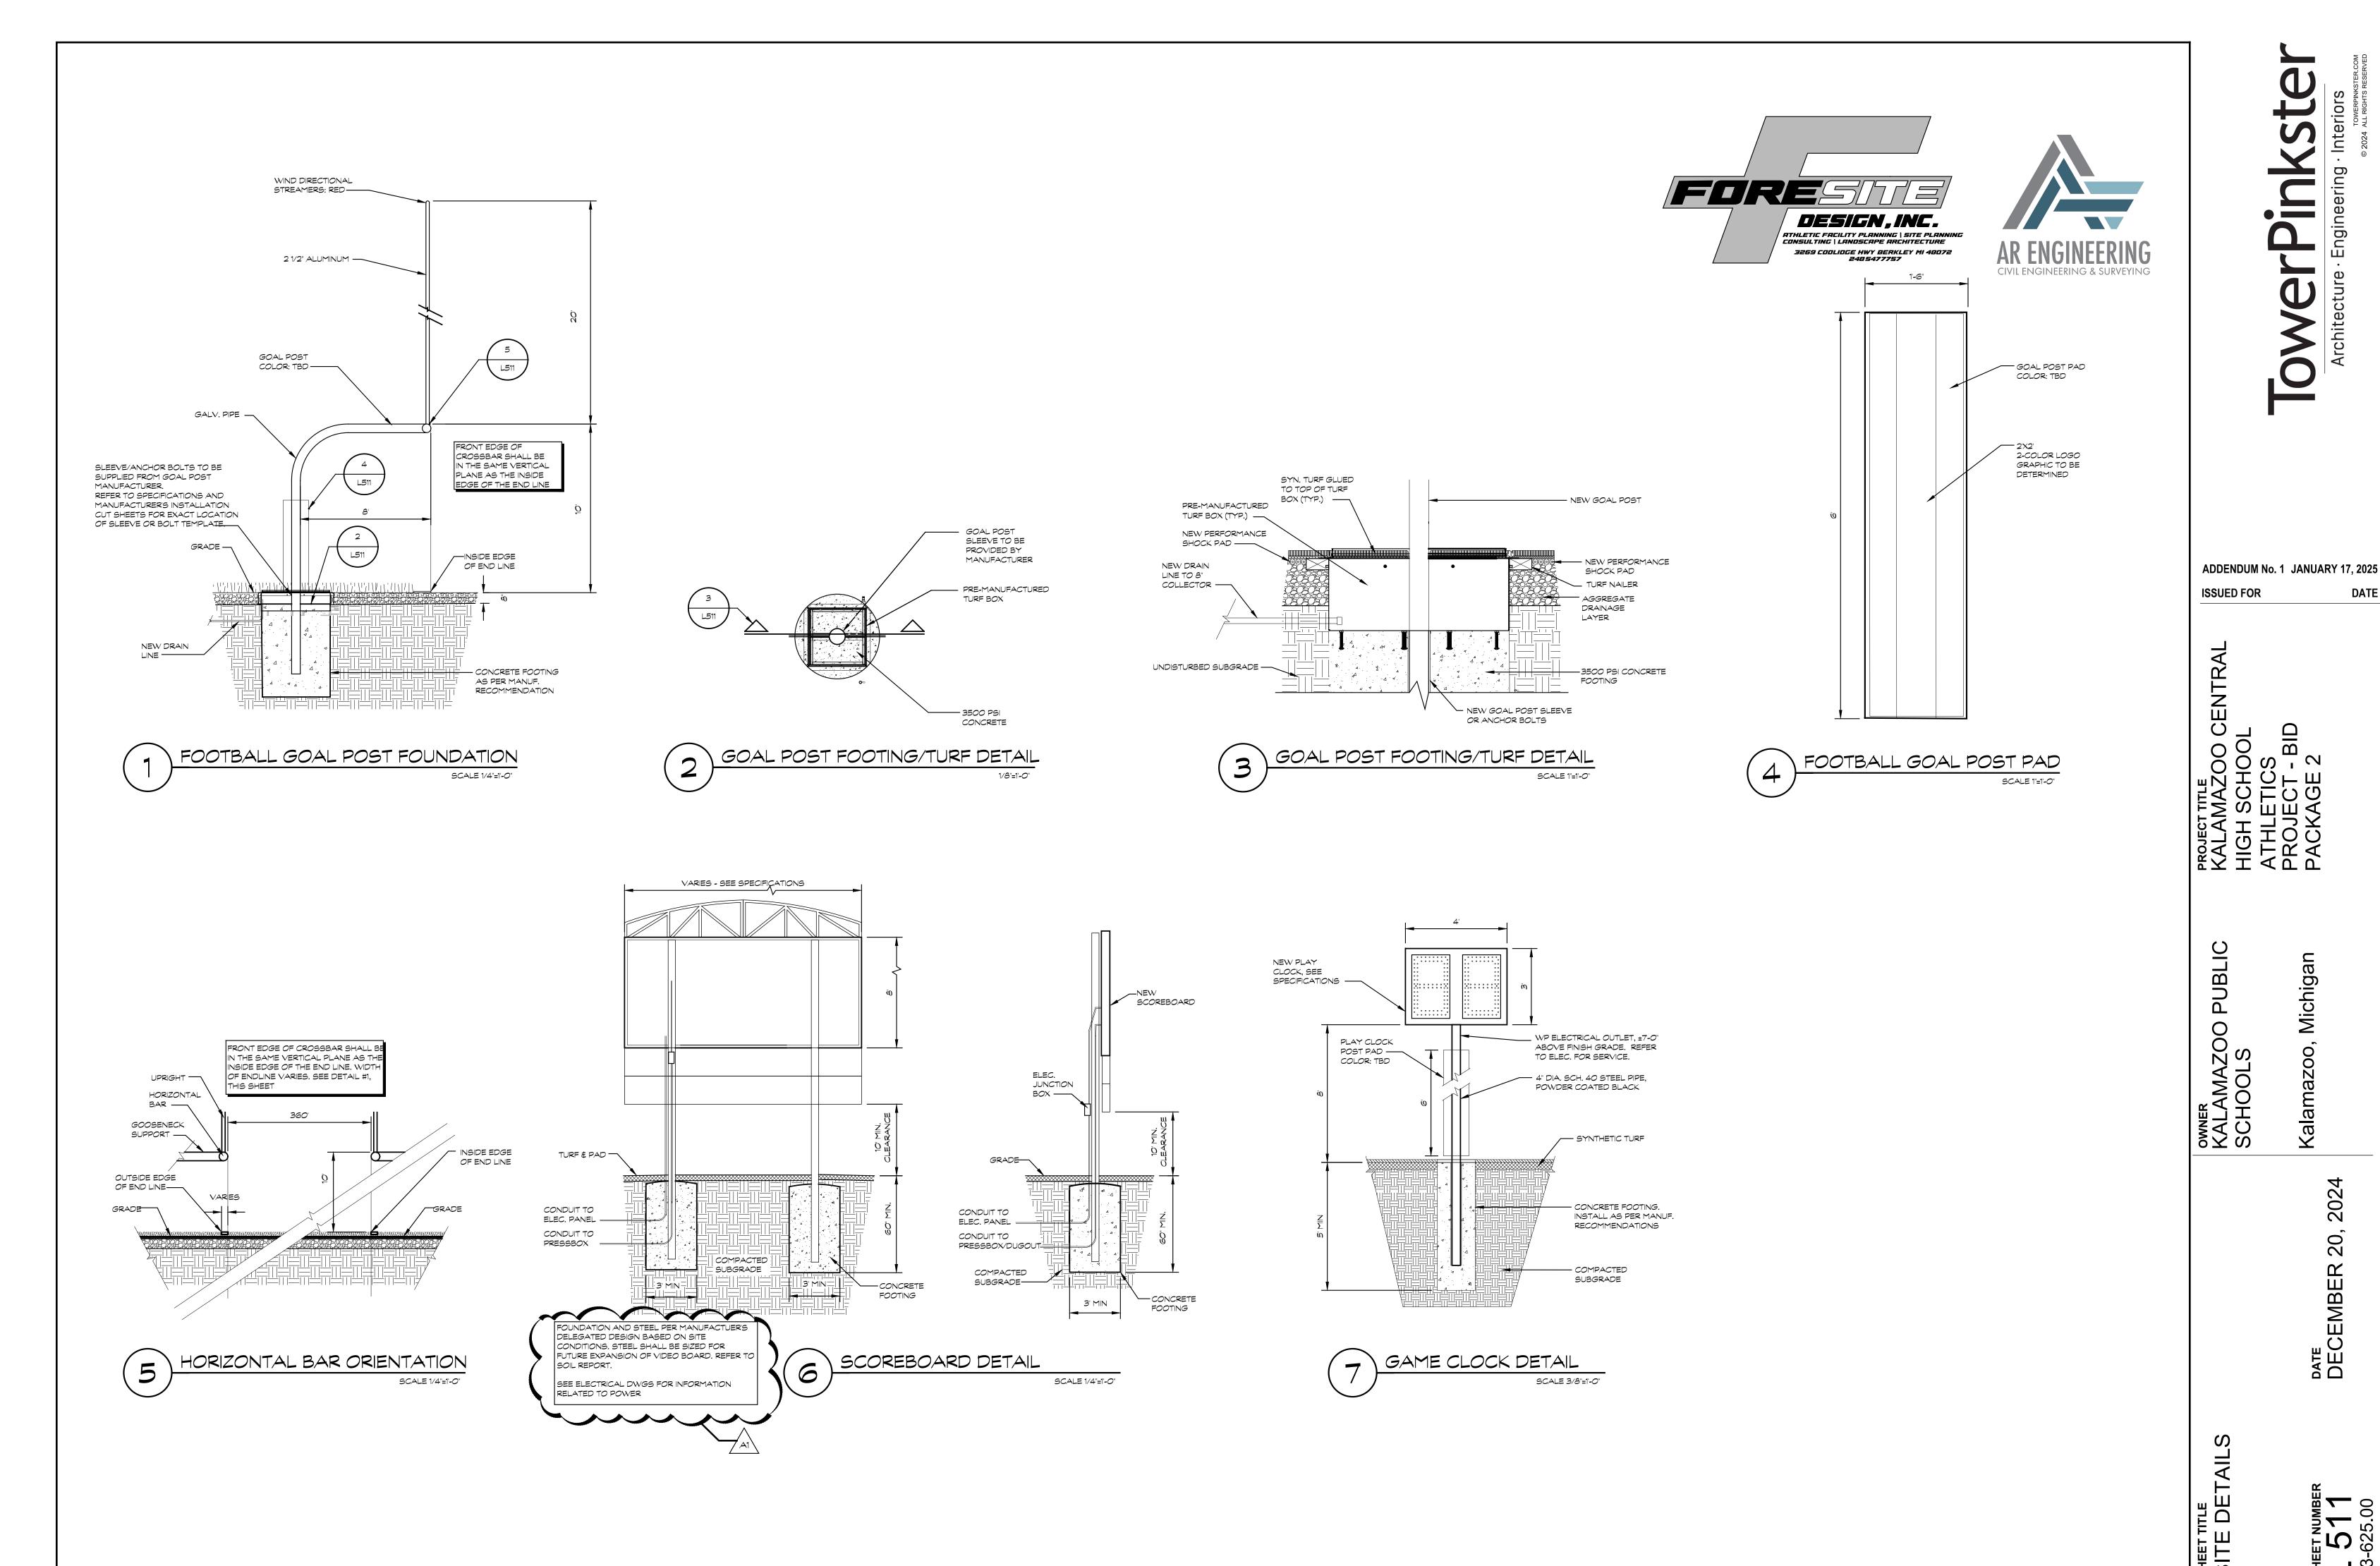
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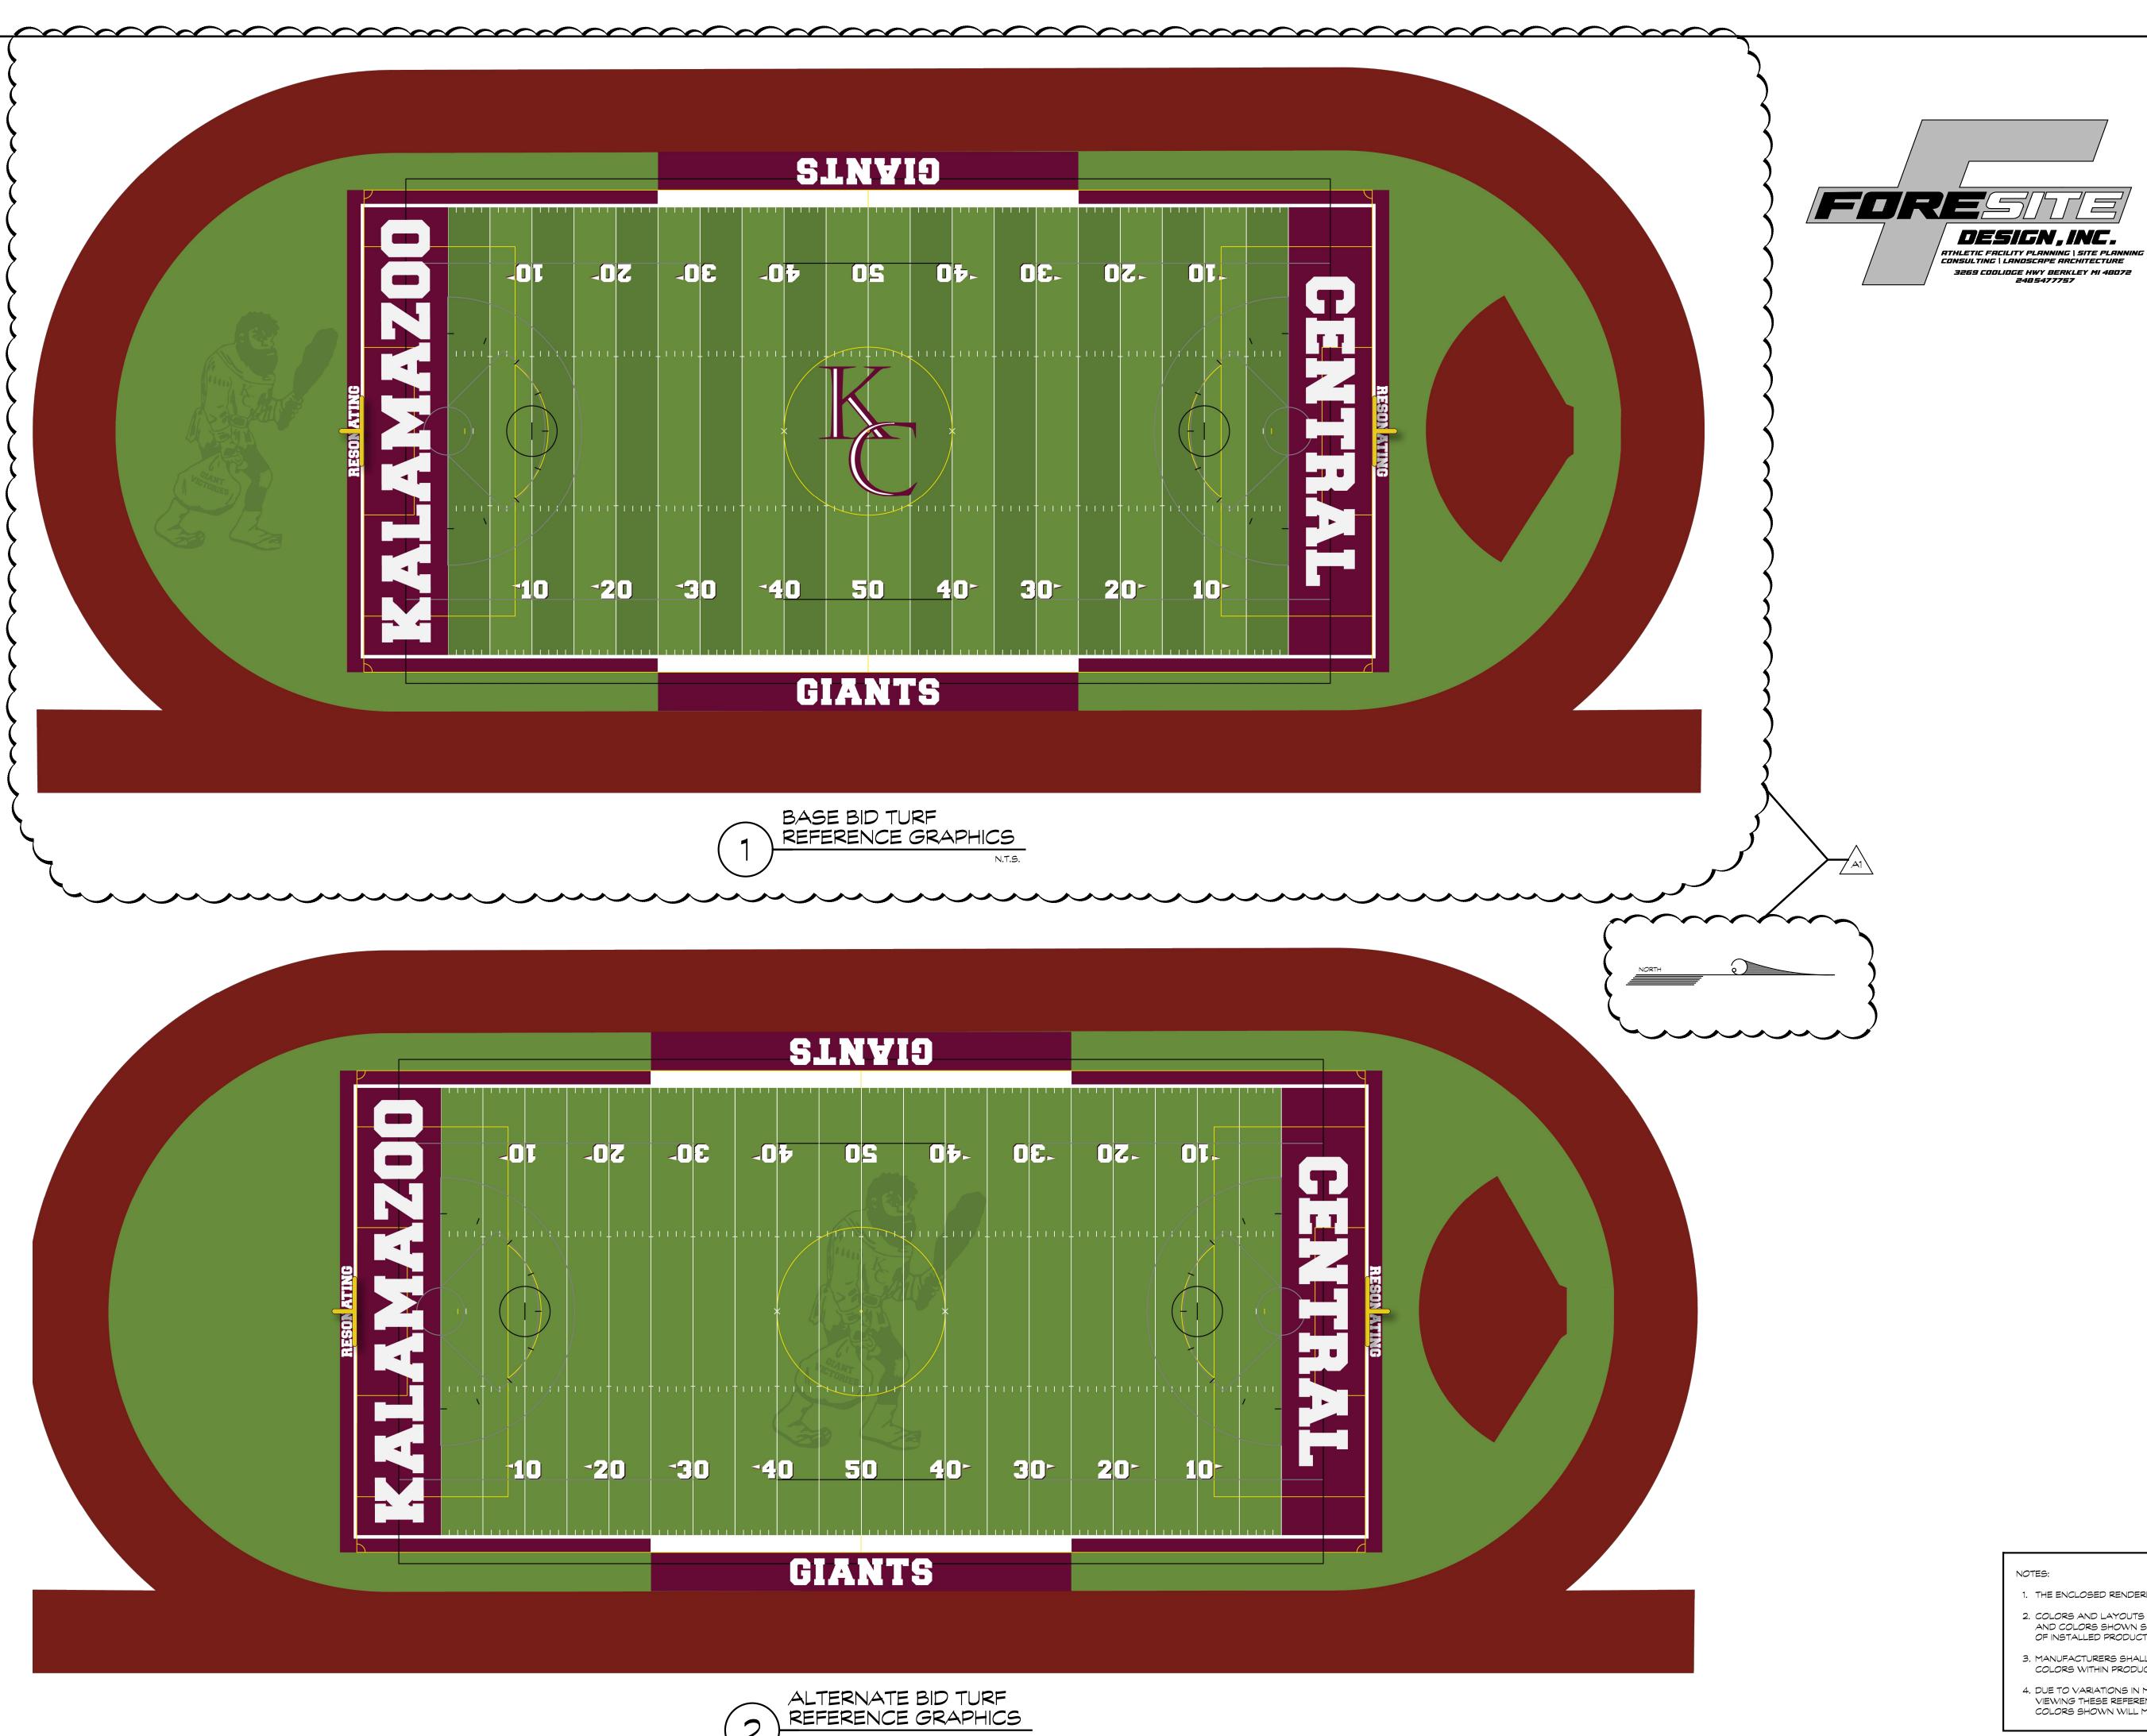
ETER FIELD

 $\begin{array}{c} \text{SHEET NUMBER} \\ C 302 \\ 23623.00 \end{array}$



ADDENDUM No. 1 JANUARY 17, 2025

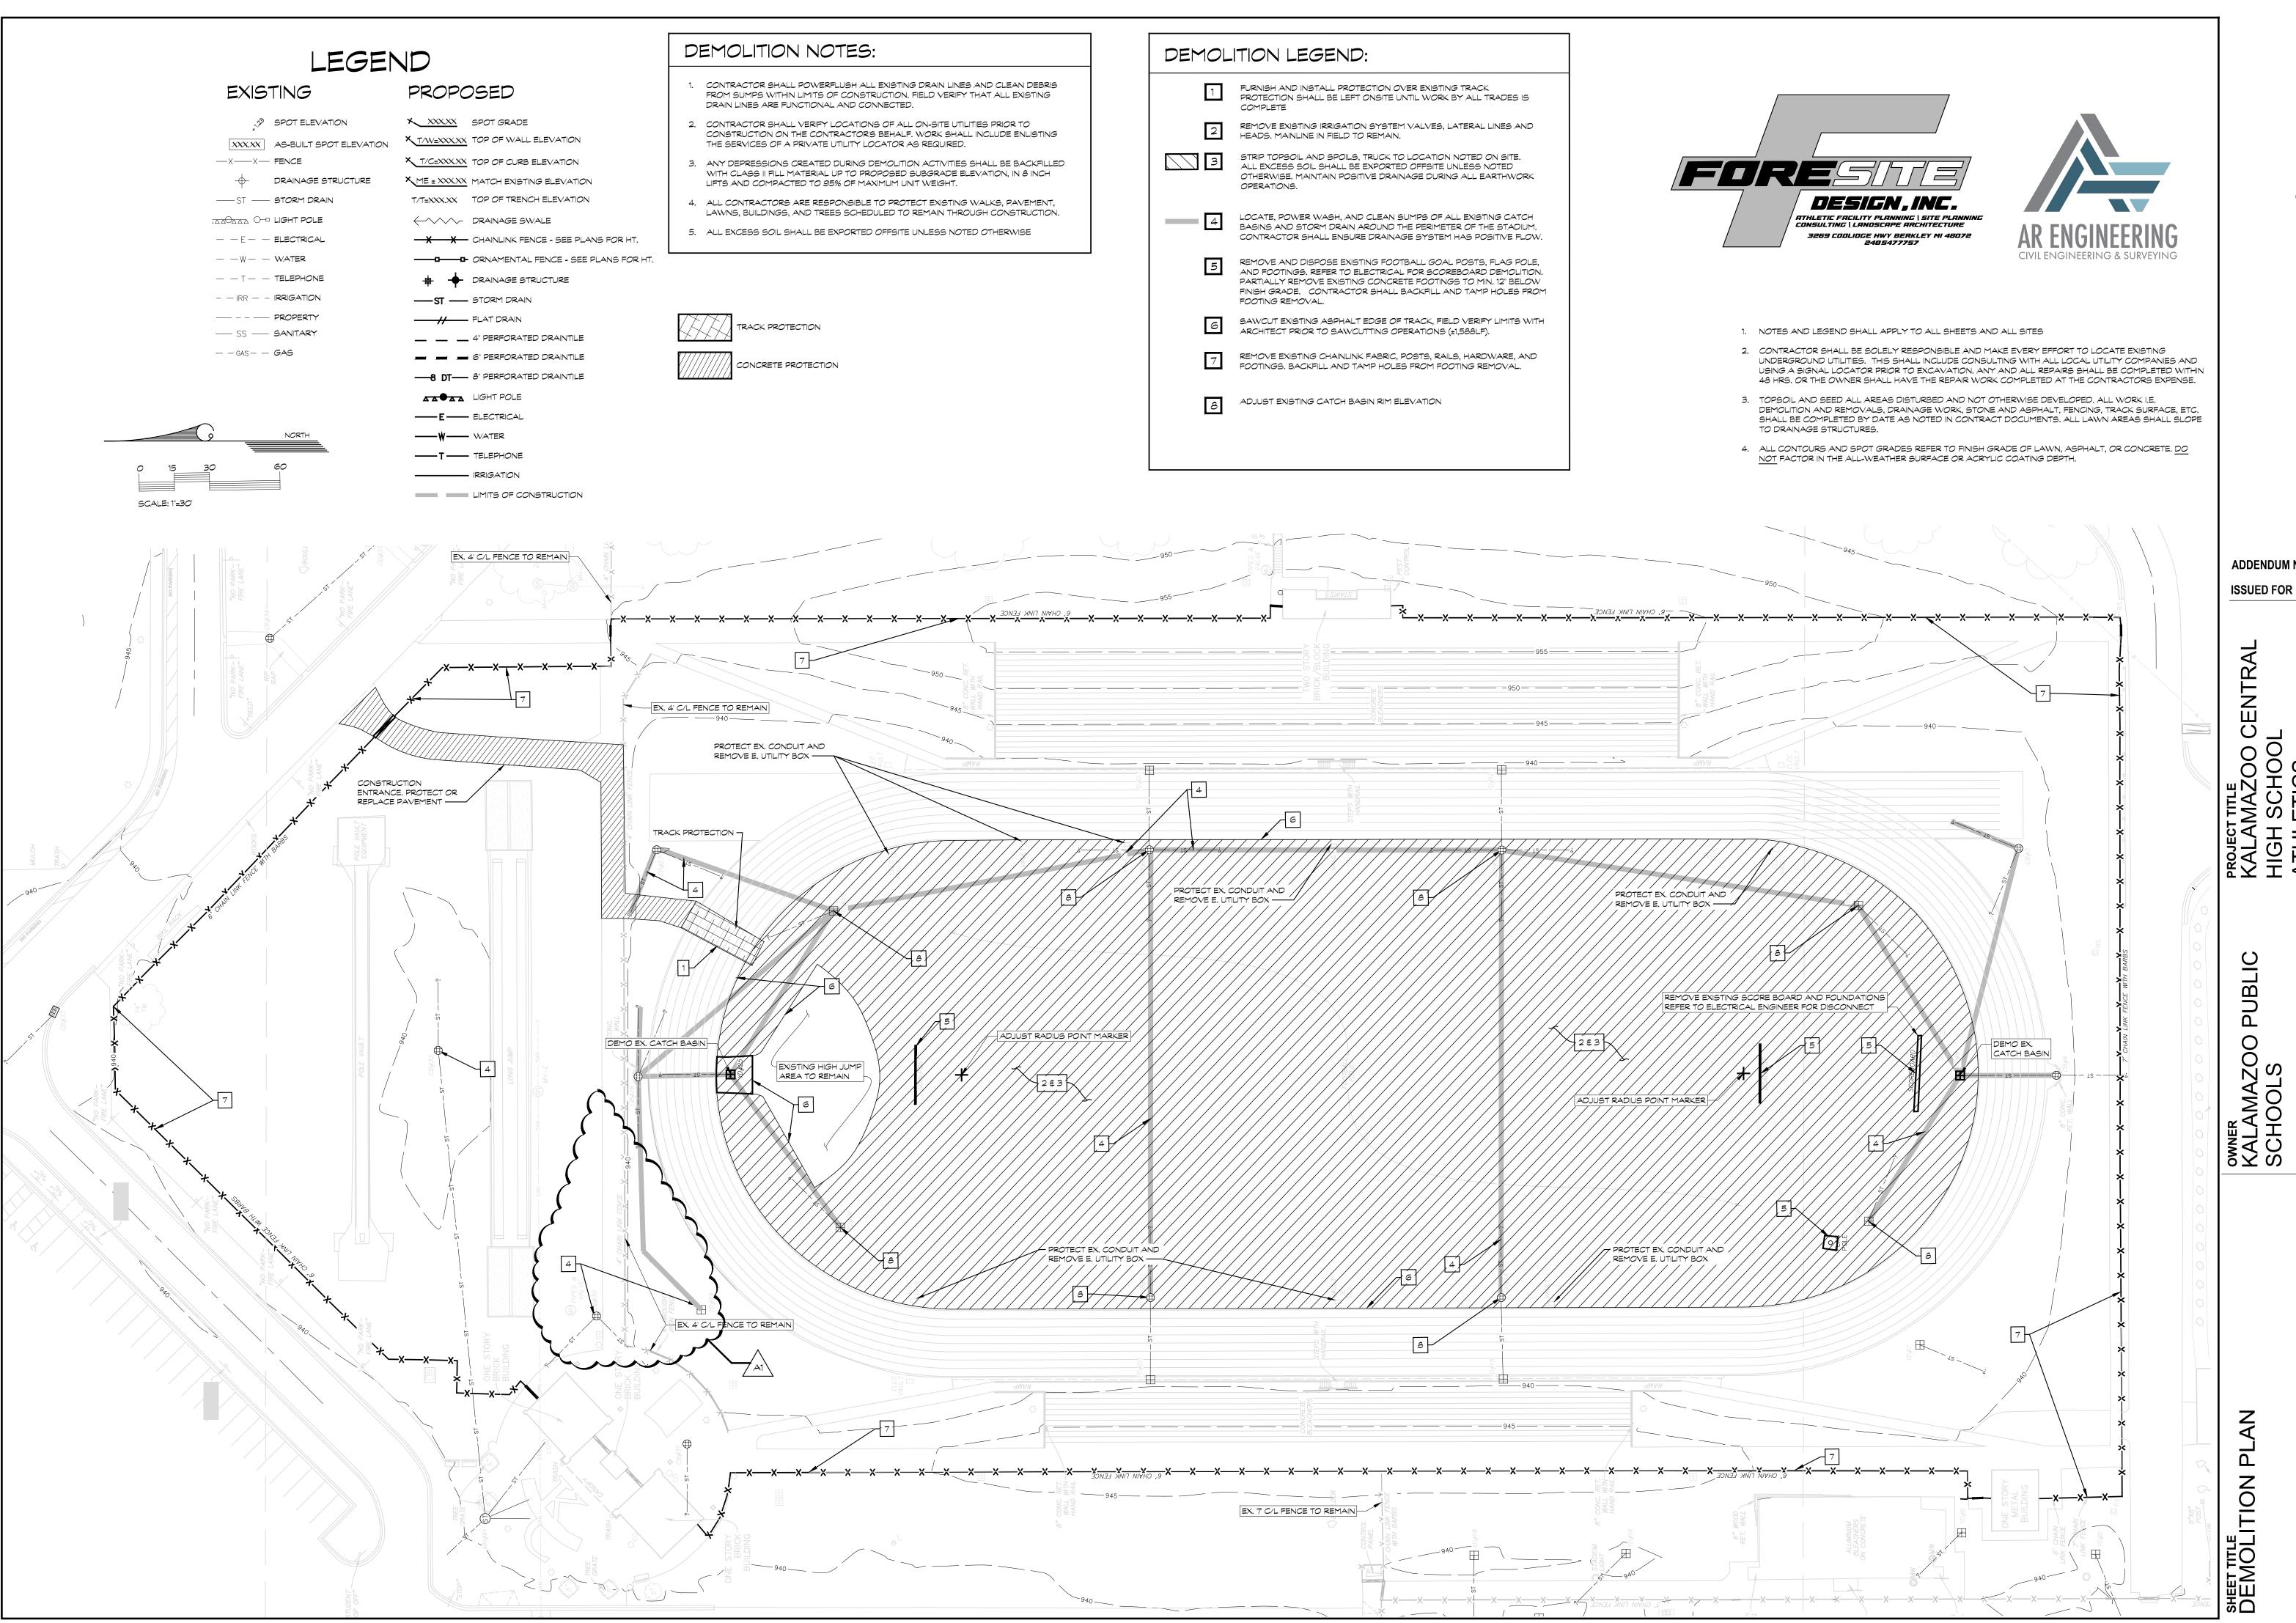



ADDENDUM No. 1 JANUARY 17, 2025

ISSUED FOR

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NOTES:


1. THE ENCLOSED RENDERINGS ARE FOR REFERENCE PURPOSES ONLY.

COLORS AND LAYOUTS SHOWN REPRESENT GRAPHICAL INTENT ONLY AND COLORS SHOWN SHALL NOT BE REGARDED AS ACTUAL COLORS OF INSTALLED PRODUCTS.

3. MANUFACTURERS SHALL INCORPORATE STANDARD MANUFACTURER

4. DUE TO VARIATIONS IN MONITOR AND PRINTER SETTINGS WHEN VIEWING THESE REFERENCE SHEETS, THERE IS NO GUARANTEE THAT COLORS SHOWN WILL MATCH COLOR OF INSTALLED PRODUCT.

COLORS WITHIN PRODUCTION.

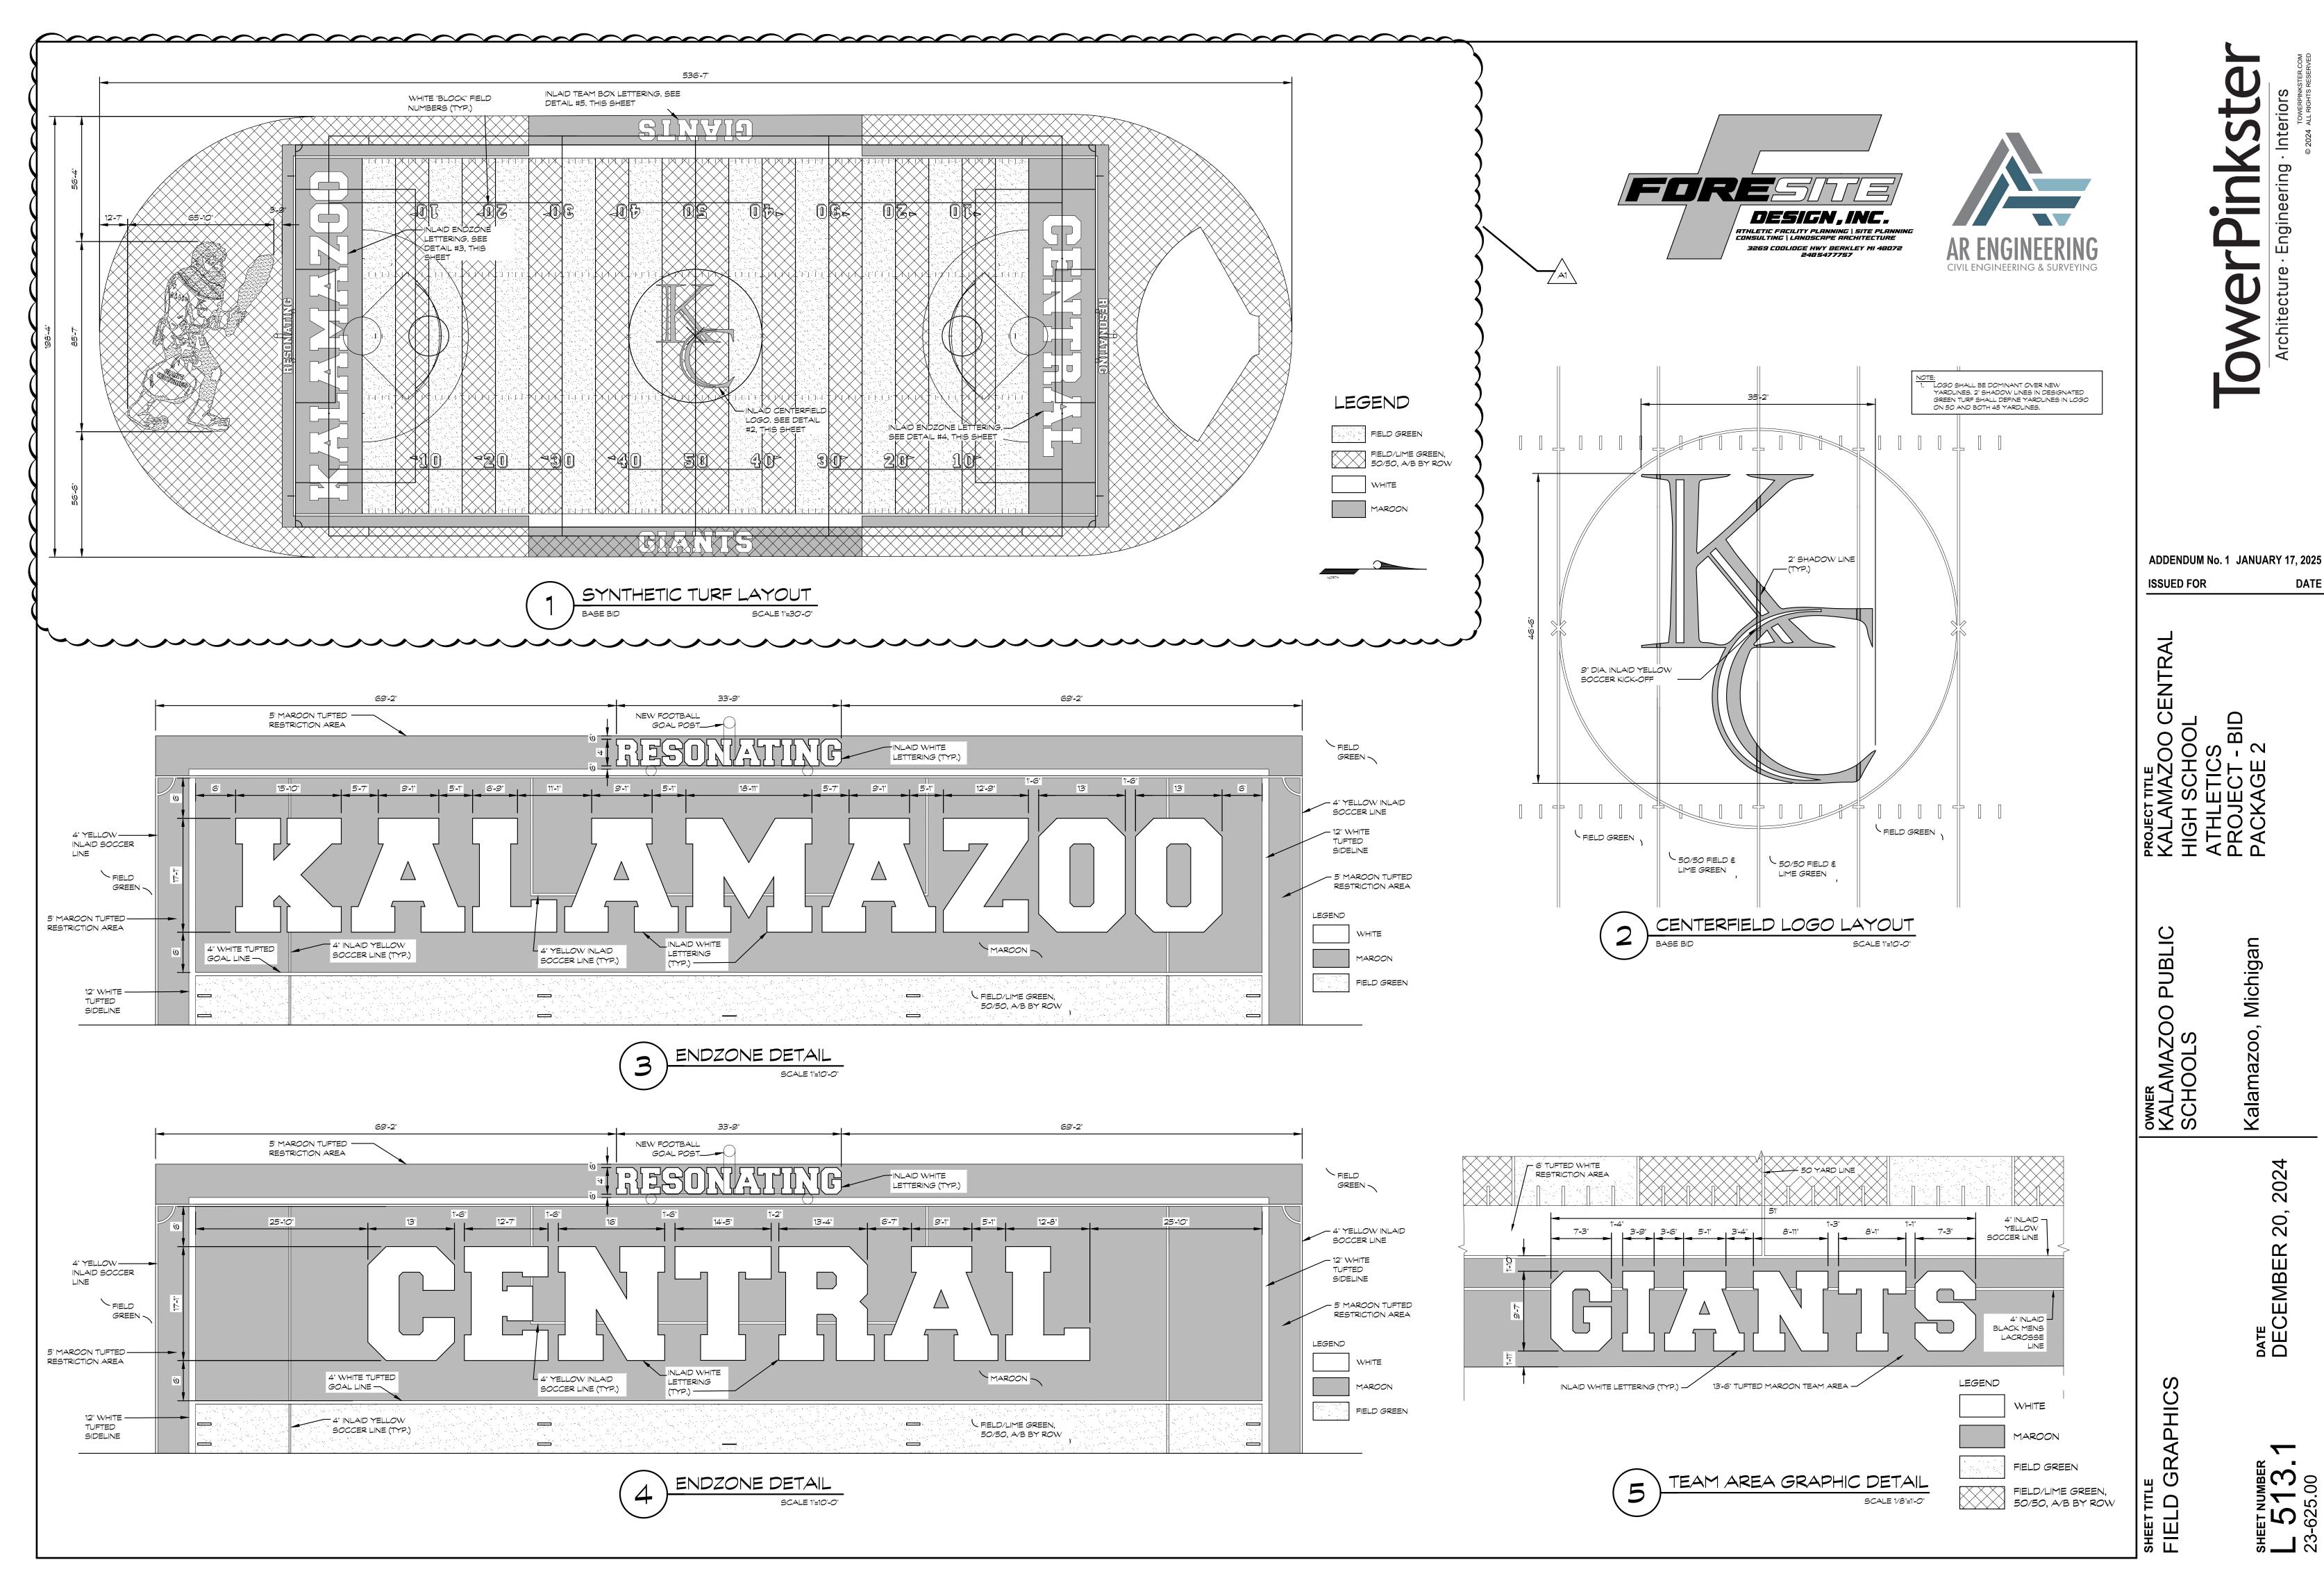

DATE

SHEET NUMBER 23-625.00

PROVIDE 18" CRUSHED STONE
DRAINAGE UNDER BOX HAND HOLE

HALL BE QUAZITE BY HUBBELL

ALL HAND HOLES SHALL BE QUAZITE BY HUBBELL


LOCATIONS INDICATED ON DRAWINGS ARE
DIAGRAMMATICAL. COORDINATE FINAL LOCATIONS
WITH OWNER PRIOR TO INSTALLATION.

- 12" x 12" PC1212BA12 OPEN BOTTOM
 PC1212CA0012 COVERS W/ "COMMUNICATIONS" FOR ALL COMM HAND HOLES
 PC1212CA0017 COVERS W/ "ELECTRIC" FOR ALL
- 17" x 30" PD1730BA18 OPEN BOTTOM
 PG1730HH0012 COVERS W/ "COMMUNICATIONS"

ELECTRICAL HAND HOLES.

FOR ALL COMM HAND HOLES

• PG1730HH0017 COVERS W/ "ELECTRIC" FOR ALL ELECTRICAL HAND HOLES.

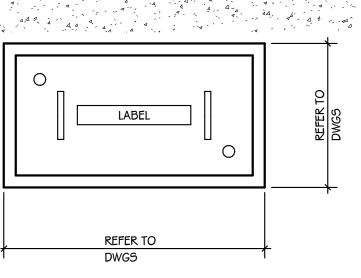

HAND HOLE DETAIL

SCOREBOARD REAR ELEVATION

- WWW/W/W/W/W/W/W/W/

∠ BACK OF

/ MODULE

JUNCTION -

BOX

LOCATION

SCOREBOARD 7

— 4 #8, 2 #8 GND. 1" C.

CIRCUIT BREAKER

/─3 #8, 1 #8 GND. 1" C.


─ 30/3 NFD

NEMA 3R

/-- SQUARE D QO LOAD CENTER

SINGLE PHASE, 40A MLO, 2 POLE

NEMA 3R. PROVIDE WITH (2) 20/1 GFI

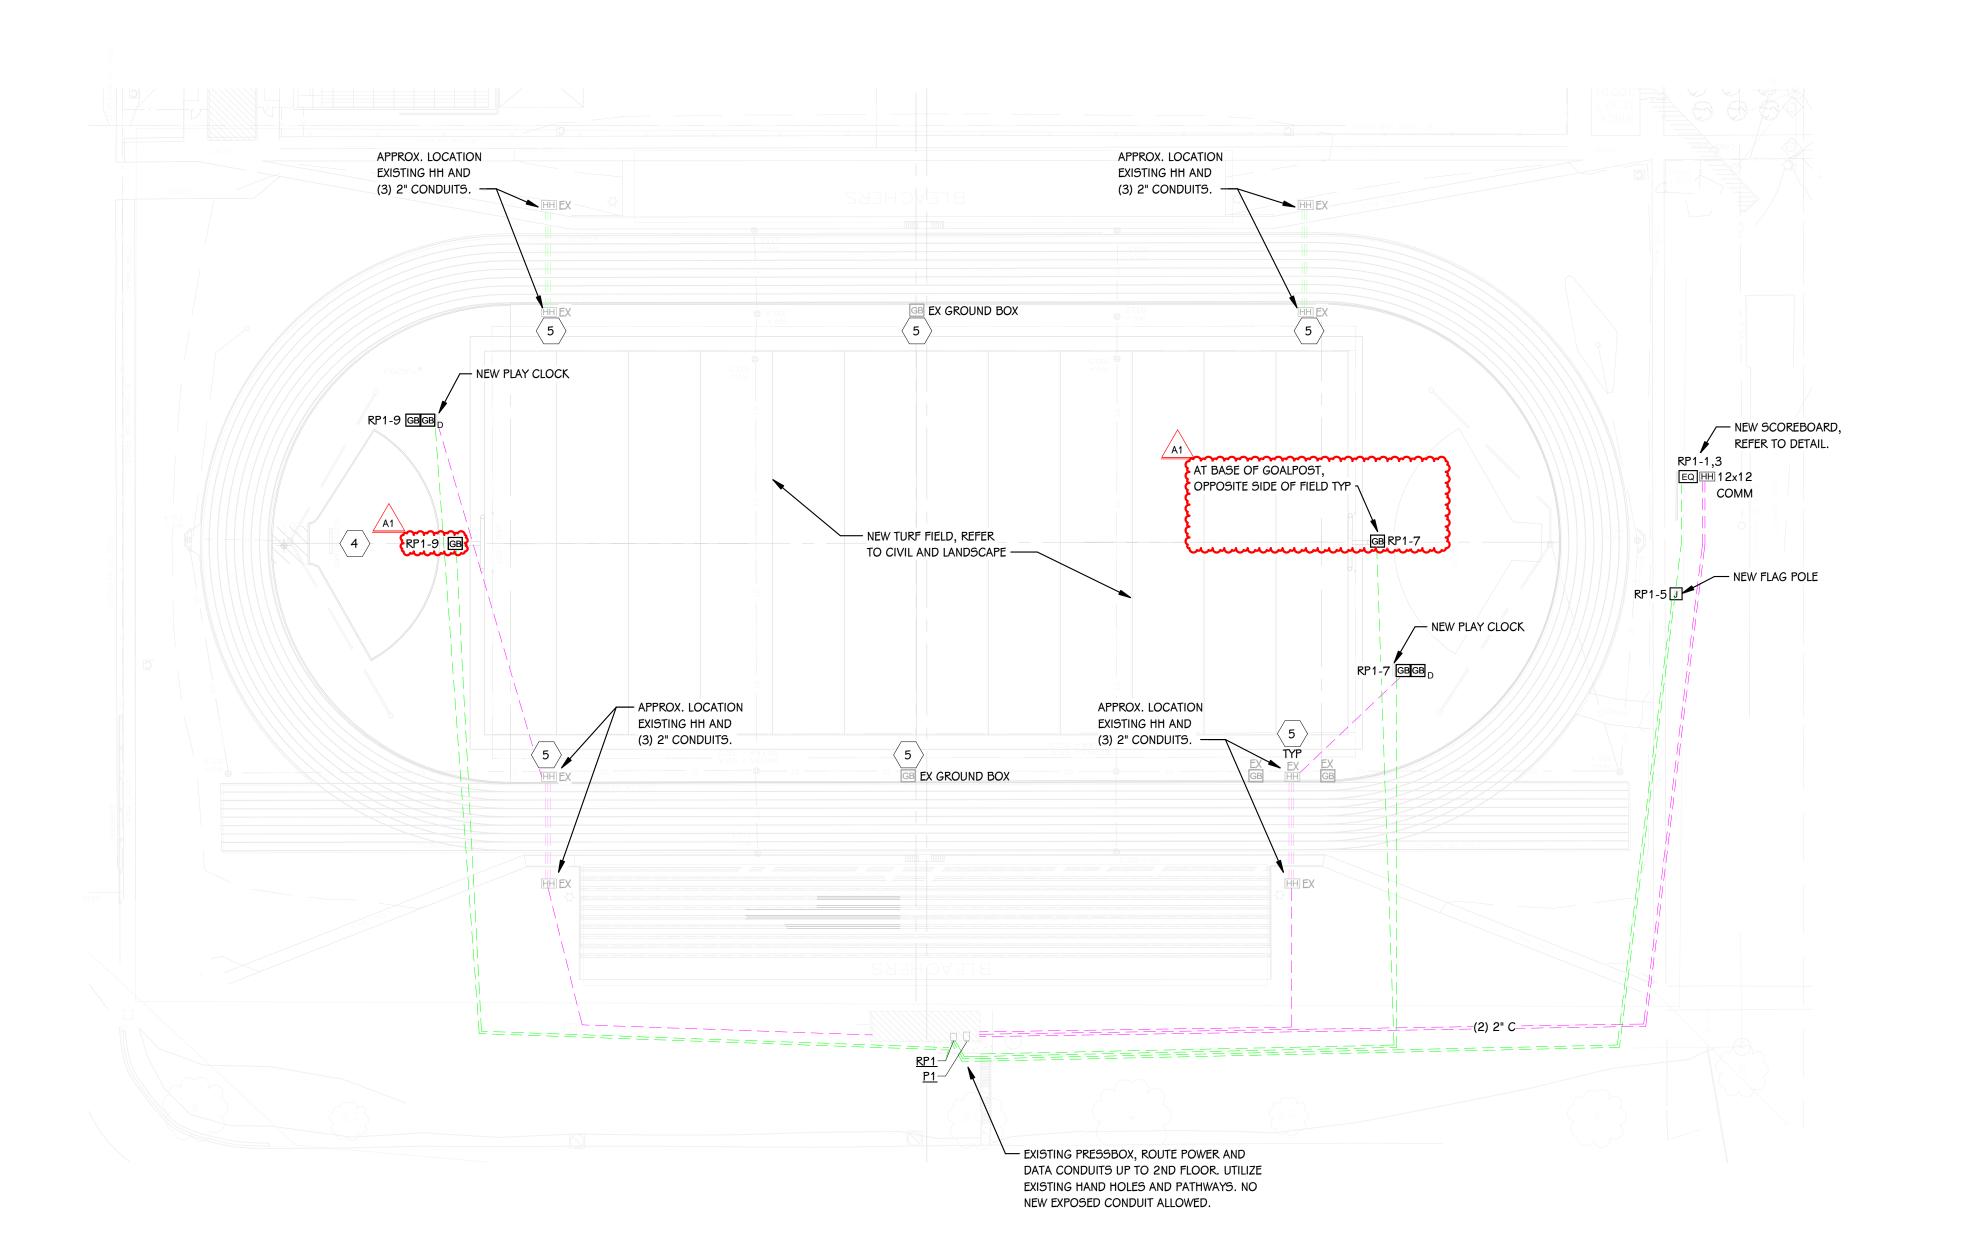

ELECTRICAL SITE PLAN - FOOTBALL FIELD

1" = 40'-0"

ADDENDUM #1 01/17/2025

11#1

DATE

ISSUED FOR

REMOVE ELECTRICAL CONNECTION TO EXISTING SCOREBOARD ALONG WITH ALL ASSOCIATED CONDUIT AND WIRE BACK TO SOURCE. RETAIN ANY CODE COMPLIANT CONDUIT ENTERING / EXITING THE ELECTRICAL ROOM.

CONDUIT ROUTING SHOW IN DIAGRAMMATICAL. MAINTAIN MINIMUM 12" SEPARATION

FOR EACH PRESS BOX, INTERCEPT EXISTING BANK OF 10 CONDUITS FOR POWER AND

SOUND SYSTEM. CUT BACK, REWORK AS REQUIRED, AND EXTEND CONDUITS TO NEW PRESS BOX. PROVIDE ALL NEW WIRING BACK TO PANEL, NO SPLICES OR JUNCTION

RECESS BACKBOX AND PROVIDE INTERMATIC LOW-PROFILE EXTRA-DUTY PLASTIC IN-USE WEATHERPROOF COVER, SINGLE-GANG MODEL #WP7000X. COLOR TO MATCH PAINT.

PROVIDE NEW 20A/1P BREAKER IN EXISTING PANELBOARD. STUB CONDUIT OUT OF BUILDING AT 24" ABOVE GRADE WITH LB, TRENCH OR DIRECTIONALLY BORE TO NEW BAND TOWER LOCATION. INSTALL RECEPTACLES ON BAND TOWER, COORDINATE FINAL

LOCATION IN FIELD WITH OWNER PRIOR TO INSTALLATION. REFER TO DETIAL.

BETWEEN LOW VOLTAGE CONDUIT AND LINE VOLTAGE CONDUITS.

BOXES SHALL BE ALLOWED BETWEEN PANEL AND PRESS BOX.

ELECTRICAL - SITE - KEYED NOTES

COORDINATE INSTALLATION WITH MASON.

5 REINSTALL EXISTING GROUND BOXES IN NEW TURF FIELD. RAISE TO NEW FIELD ELEVATION; REWORK CONDUIT AS REQUIRED.

THIS DRAWING SHEET IS INTENDED TO BE PLOTTED IN

COLOR. IF THIS TEXT APPEARS IN BLACK AND WHITE, IT IS PLOTTED INCORRECTLY. DISCARD AND OBTAIN

AN ACCURATE DRAWING

2" DATA CONDUIT W/ PULL ROPE

UNLESS NOTED OTHERWISE.

1" POWER CONDUIT UNLESS

NOTED OTHERWISE.

RALAMAZOO CENTRAL HIGH SCHOOL ATHLETICS PROJECT

S-S

Kalamazoo, Mic

DECEMBER 20, 2024

ELECTRICAL SITE FIELD

HEET NUMBER **104**