

# ZIONSVILLE COMMUNITY HIGH SCHOOL ATHLETIC LOCKER ROOMS ADDITION AND RENOVATION

1000 MULBERRY STREET  
ZIONSVILLE, INDIANA 46077

ZIONSVILLE COMMUNITY SCHOOLS



ZIONSVILLE COMMUNITY SCHOOLS

ARCHITECT



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350 EAST NEW YORK ST. STE 300  
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CIVIL ENGINEER



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Indianapolis, IN 46268  
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www.tlf-engineers.com

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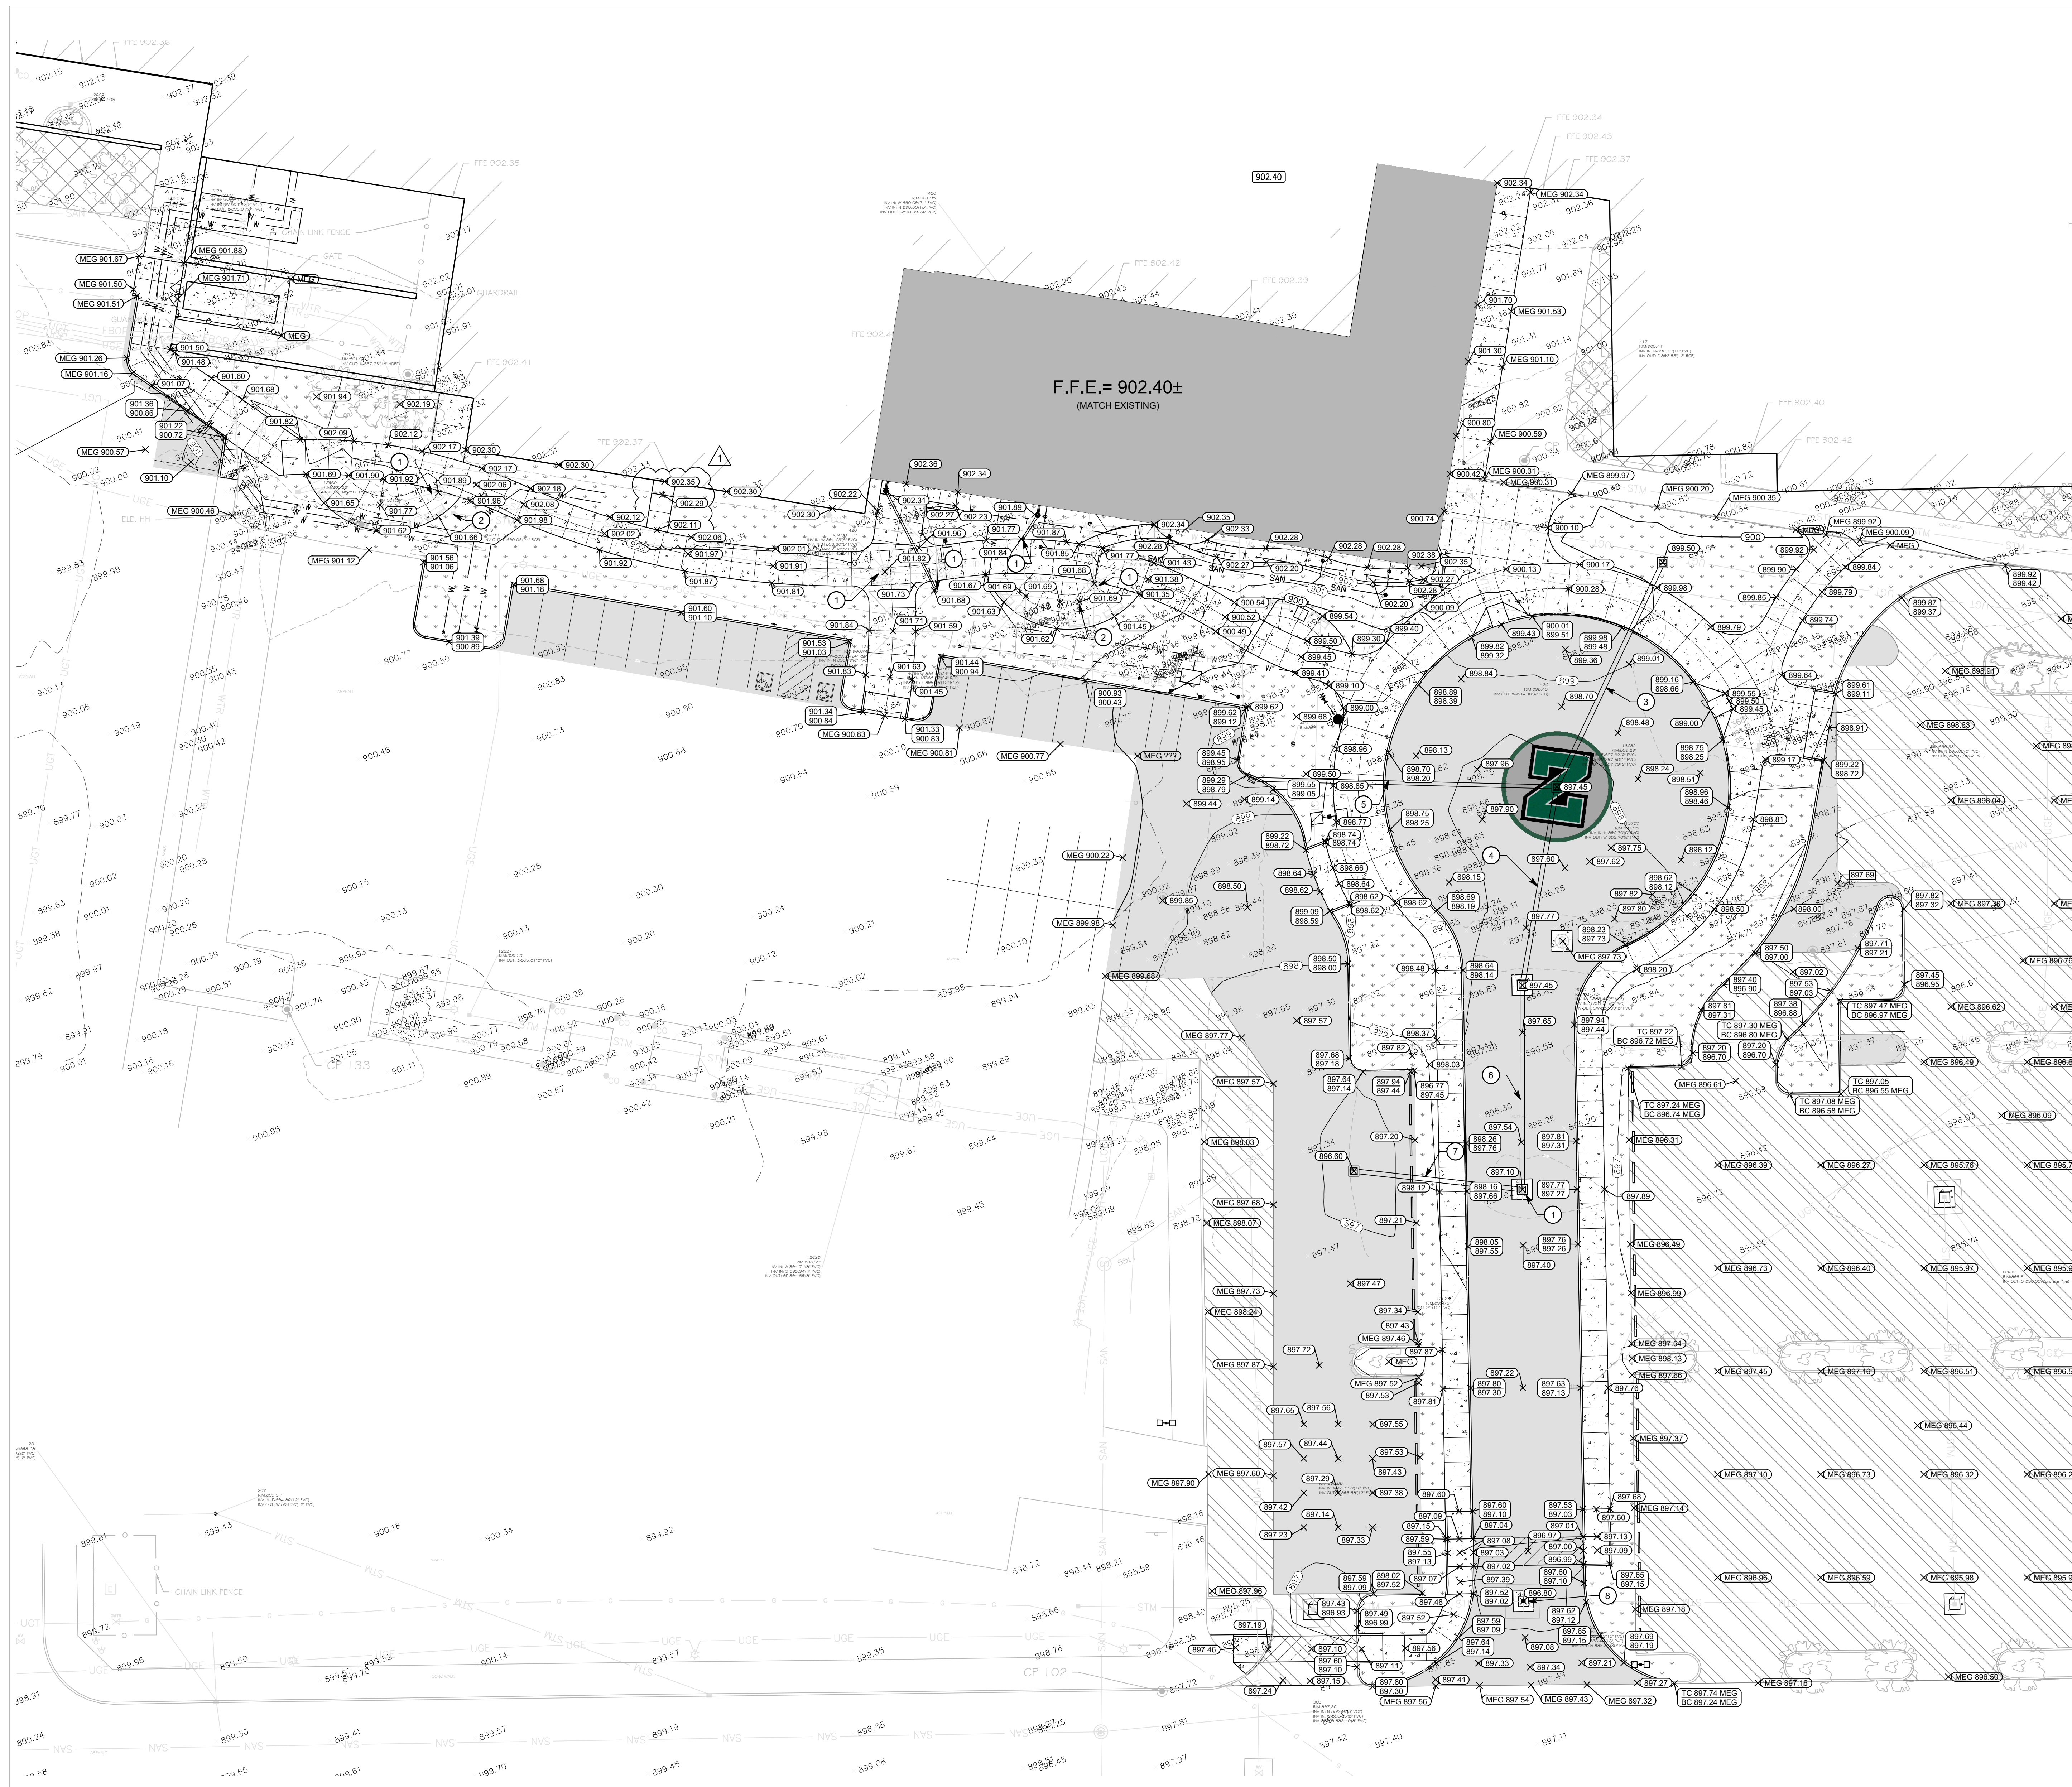


PROJECT MANAGER: DBS  
DRAWN BY: CDL  
PROJECT NUMBER: 224018.00 (TLF JOB #2024-090)  
PROJECT ISSUE DATE: 01.21.2025

REV. NO.	DESCRIPTION	DATE
1	ADDENDUM #1	02-11-2025

GRADING PLAN

G2-00



### GENERAL NOTES

- SEE DRAWING C001 FOR GENERAL NOTES AND ADDITIONAL LEGEND.
- TOPOGRAPHIC CONDITIONS AND EXISTING UTILITIES SHOWN WERE PROVIDED BY SCHNEIDER GEOMATICS. THE ENGINEER MAKES NO GUARANTEES THAT THE UNDERGROUND UTILITIES SHOWN COMPRISE ALL SUCH UTILITIES IN THE AREA, EITHER IN SERVICE OR ABANDONED.
- CONTRACTOR SHALL VERIFY ALL EXISTING CONDITIONS IN THE PROJECT AREA INCLUDING UNDERGROUND UTILITY CONDITIONS, LOCATION AND DEPTH PRIOR TO ANY OTHER SITE CONSTRUCTION. REPORT ANY DISCREPANCIES TO THE ENGINEER.

### GRADING KEYNOTES

- ADJUST EXISTING TO PROPOSED GRADE.
- CHANGE EXISTING CASTING TO SOLID CASTING NEENAH R-1772.
- 72 LF OF 12" RCP @ 1.04% SLOPE
- 59 LF OF 15" RCP @ 1.14% SLOPE
- 89LF OF 12" RCP @ 1.13% SLOPE
- 60LF OF 15" RCP @ 1.14% SLOPE
- 50 LF OF 12" RCP @ 1.01% SLOPE

### GRADING PLAN LEGEND

- EXISTING SPOT ELEVATION
- MATCH EXISTING GRADE
- TOP OF CURB
- BOTTOM OF CURB
- EDGE OF PAVEMENT
- EXISTING CONTOUR W/ ELEVATION
- PROPOSED CONTOUR W/ ELEVATION
- PROPOSED SPOT ELEVATION
- PROPOSED CURB ELEVATION

### CAUTION !!

THE LOCATIONS OF ALL EXISTING UNDERGROUND UTILITIES SHOWN ON THE PLAN ARE BASED UPON ABOVE GROUND EVIDENCE (INCLUDING, BUT NOT LIMITED TO, MANHOLES, INLETS, VALVES, AND MARKS MADE UPON THE GROUND BY OTHERS) AND ARE SPECULATIVE IN NATURE. THERE MAY ALSO BE OTHER EXISTING UNDERGROUND UTILITIES FOR WHICH THERE IS NO ABOVE GROUND EVIDENCE OR FOR WHICH NO ABOVE GROUND EVIDENCE WAS OBSERVED. THE EXACT LOCATIONS OF EXISTING UNDERGROUND UTILITIES SHALL BE VERIFIED BY CONTRACTOR PRIOR TO ANY AND ALL CONSTRUCTION.



Know what's below.  
Call before you dig.  
Call 811 or 1-800-345-5544 Before You Begin Any Digging Project.  
Call 48 hours or 2 working days before you dig.  
It's Fast, It's Easy and It's the Law in the State of Indiana!







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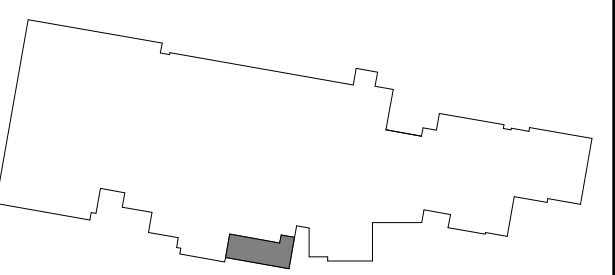
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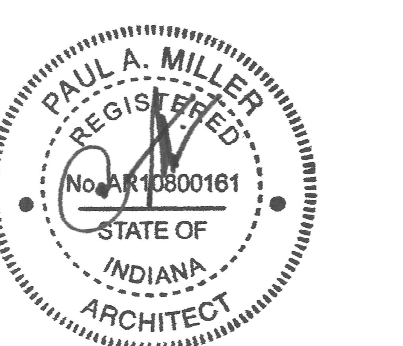


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KEY PLAN

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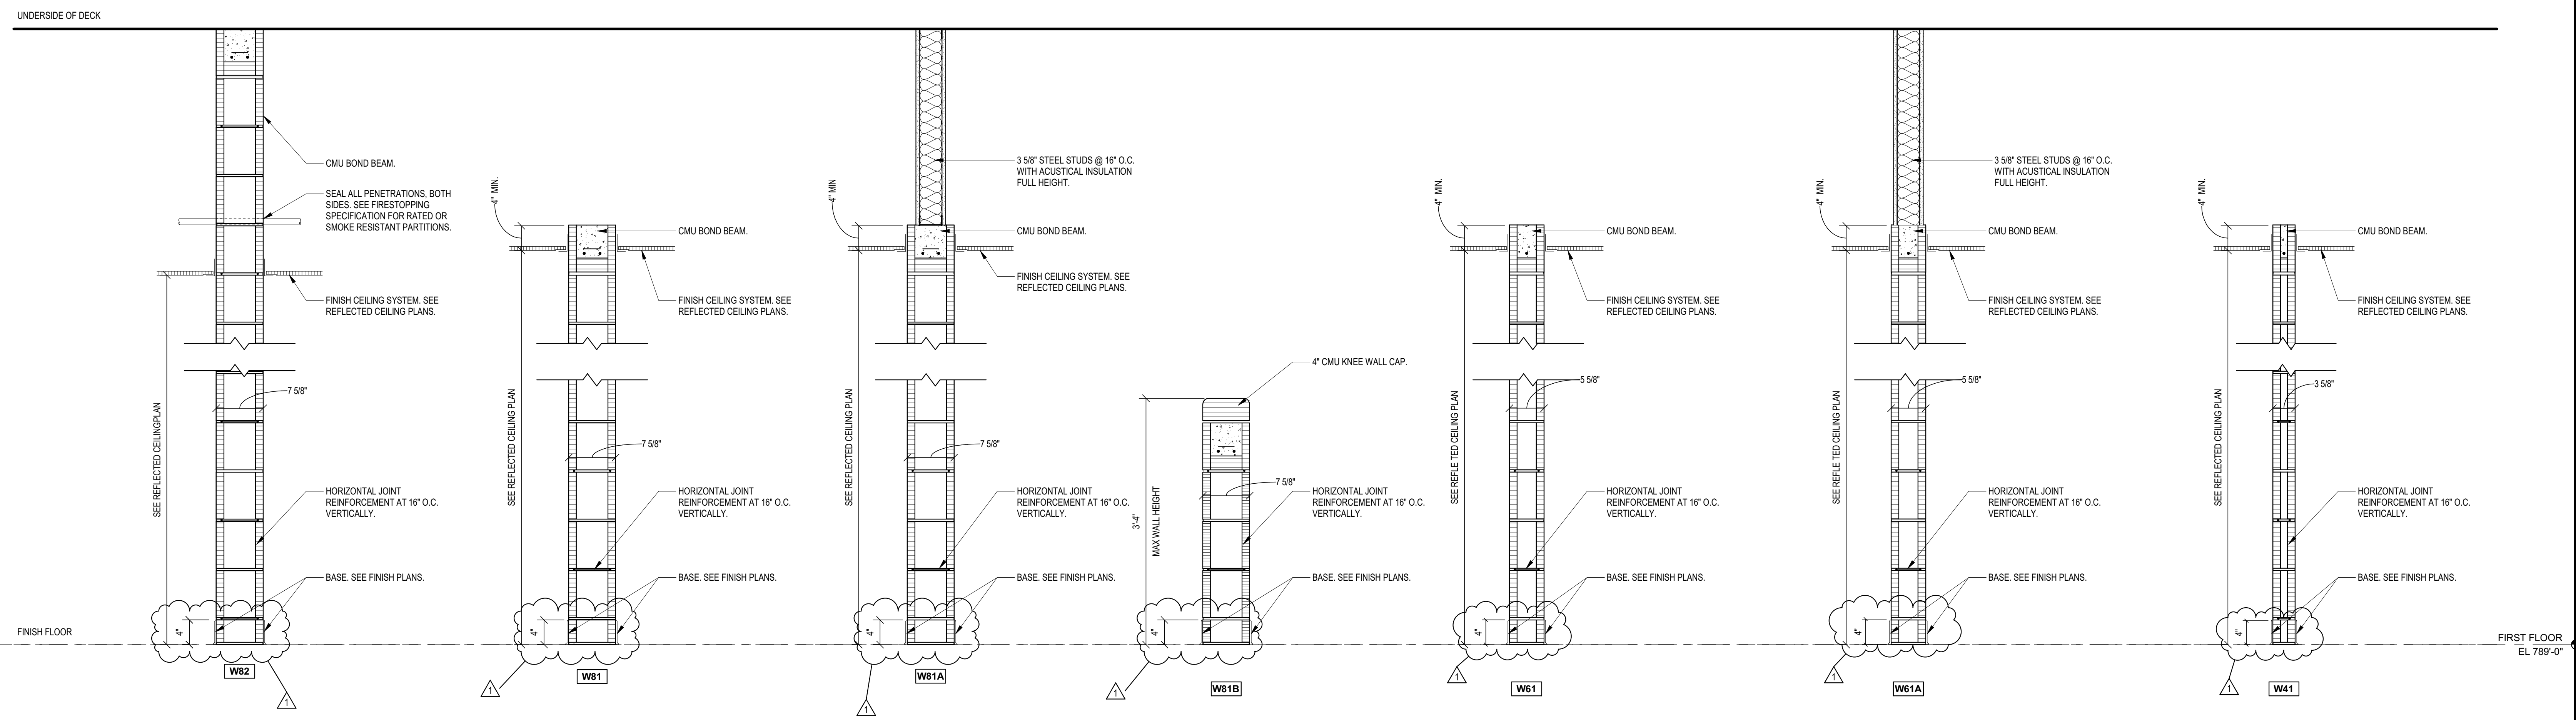


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WALL TYPES & DETAILS

## A-00



**WALL TYPES**

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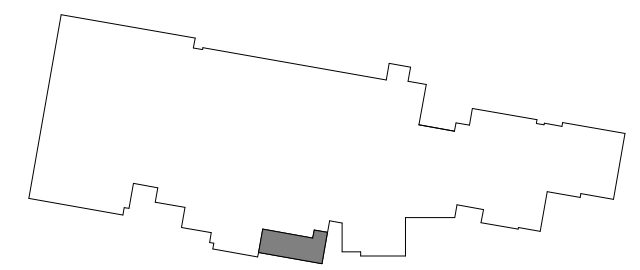


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CODE PLANS

AP-01

### BUILDING CODE INFORMATION

- BUILDING DESCRIPTION: EXISTING 9-12 SCHOOL - BUILDING ADDITION
- APPLICABLE CODE: 2012 INTERNATIONAL BUILDING CODE - INDIANA BUILDING CODE, 2014 EDITION (675 IAC 13-2-6)  
2012 INTERNATIONAL FIRE CODE - INDIANA FIRE CODE, 2014 EDITION (675 IAC 22-2)  
2012 INTERNATIONAL MECHANICAL CODE - INDIANA MECHANICAL CODE, 2014 EDITION (675 IAC 18-1.6)  
2012 INTERNATIONAL PLUMBING CODE - INDIANA PLUMBING CODE, 2011 EDITION (675 IAC 16-1.4)  
2012 INTERNATIONAL ELECTRICAL CODE - INDIANA ELECTRICAL CODE, 2009 EDITION (NFA TO 2008) (675 IAC 17-1.8)  
INDIANA ENERGY CONSERVATION CODE 2010 (ASHRAE 90.1, 2007 AMENDED) (675 IAC 15-4)  
2010 ADA STANDARDS FOR ACCESSIBLE DESIGN

- BUILDING AREA AND HEIGHT

- OCCUPANCY/USE GROUP: E - EDUCATION
- CONSTRUCTION TYPE: II B (601)
- AREA LIMITATION: UNLIMITED (507.4)
  - 1. ACTUAL AREA: 607,345 SF
  - LEVEL 1 TOTAL ADDITION: 11,041 SF
  - LEVEL 2 TOTAL ADDITION: 12,490 SF
  - EQUIPMENT PLATFORM ADDIT 4: 1,335 SF
- TOTAL GROSS SF: 632,121 SF

- HEIGHT LIMITATION: 4 STORY, 55'-0" (TABLE 503)
  - 1. HEIGHT MODIFICATIONS: 5 STORY, 75'-0" (504.2)
  - 2. ACTUAL HEIGHT: 3 STORY, 40'-0"

- USE AND OCCUPANCY CLASSIFICATION INDIANA BUILDING CODE CHAPTER 3  
E - EDUCATION

- PER 508.2, ACCESSORY OCCUPANCIES ARE AS FOLLOWS:
- TOTAL LEVEL 1 ADDITION & RENOVATION: 21,855 SF
  - LEVEL 1 ACCESSORY AREA: 2,175 SF
  - TOTAL LEVEL 2 ADDITION & RENOVATION: 13,408 SF
  - LEVEL 2 ACCESSORY AREA: 1,182 SF

ACCESSORY USE AREAS INDIANA BUILDING CODE SECTION 508.2  
ACCESSORY OCCUPANCIES ARE THOSE OCCUPANCIES SUBSIDIARY TO THE MAIN OCCUPANCY OF THE BUILDING OR PORTION THEREOF. AGGREGATE ACCESSORY OCCUPANCIES SHALL NOT OCCUPY MORE THAN 10% OF THE AREA OF THE STORY IN TABLE 503 WITHOUT HEIGHT AND AREA INCREASES IN ACCORDANCE WITH SECTIONS 504 AND 506 FOR SUCH ACCESSORY OCCUPANCIES (2012 INTERNATIONAL BUILDING CODE)

- TYPE OF CONSTRUCTION INDIANA BUILDING CODE CHAPTER 6 (SEE TABLE)

TYPE 11B  
FIRE SEPARATION DISTANCES INDIANA BUILDING CODE TABLE 602:  
REFER TO THE SITE PLAN DRAWINGS FOR LOCATION OF BUILDINGS/ ON SITE DISTANCES TO CLOSEST INTERIOR LOT LINES, TO THE CENTER OF A STREET, ALLEY OR PUBLIC WAY, OR TO AN IMAGINARY LINE BETWEEN TWO BUILDINGS ON THE SAME LOT.

- FIRE RESISTANCE RATED CONSTRUCTION INDIANA BUILDING CODE CHAPTER 7:  
REFER TO THE CODE PLANS FOR MAXIMUM AREAS OF EXTERIOR OPENINGS BASED ON THE FIRE SEPARATION DISTANCES.  
PENETRATIONS THROUGH FIRE-RESISTANCE-RATED ASSEMBLIES SHALL BE PROVIDED WITH FIRESTOPPING PER PROJECT MANUAL.  
CEILING AND FLOOR OPENINGS THROUGH NON-FIRE-RESISTANCE-RATED ASSEMBLIES SHALL BE PROVIDED WITH FIREBLOCKING PER PROJECT MANUAL.

- INTERIOR FINISHES TO COMPLY WITH INDIANA BUILDING CODE CHAPTER 8

- FIRE PROTECTION SYSTEMS INDIANA BUILDING CODE CHAPTER 9:  
THE ENTIRE SCHOOL IS PROVIDED WITH AN AUTOMATIC SPRINKLER SYSTEM. ADDITION AND RENOVATION AREAS ARE PROVIDED WITH AUTOMATIC SPRINKLER SYSTEM.

- MEANS OF EGRESS INDIANA BUILDING CODE CHAPTER 10:  
THE MEANS OF EGRESS REQUIREMENTS SHALL BE DETERMINED BY THE ACTUAL OR COMPUTED NUMBER OF OCCUPANTS WHOEVER IS THE LARGEST NUMBER. REFER TO THE CODE PLANS FOR ROOM OCCUPANT LOADS. AREAS OR ROOMS WITH 50 OR MORE OCCUPANTS SHALL BE PROVIDED WITH TWO OR MORE MEANS OF EGRESS. 500 OR MORE OCCUPANTS SHALL BE PROVIDED WITH THREE OR MORE MEANS OF EGRESS, AND 1000 OR MORE OCCUPANTS SHALL BE PROVIDED WITH FOUR OR MORE MEANS OF EGRESS.

- STRUCTURAL DESIGN LOADS:  
REFER TO STRUCTURAL DRAWINGS FOR CODE REQUIREMENTS

BUILDING DESIGNED FOR:  
708 STUDENTS AND 23 STAFF

CLASSIFICATION - KEY

Class	Abbreviation	Classification	Area Per Occupant	Occupancy (Gross or Net)
AC	AC	Accessory Storage Areas, Mechanical Equipment Rooms	300 SF	Gross
B	B	Business Areas	150 SF	Gross
EX	EX	Egress Areas	50 SF	Gross
L	L	Locker Rooms - Education	50 SF	Gross
U	U	Unoccupied	0 SF	Gross

EQUIPMENT

- FEC FIRE EXTINGUISHER CABINET
- AED AUTOMATED EXTERNAL DEFIBRILLATOR

BUILDING

- INDICATED AREA NOT IN PROJECT (EXISTING SPRINKLERED)
- INDICATES AREA OF RENOVATION (SPRINKLERED)
- INDICATES AREA OF ADDITION (SPRINKLERED)
- PATH OF TRAVEL

ACTUAL OCCUPANT SERVED  
MAXIMUM OCCUPANT SERVED BY EXIT  
ACTUAL OCCUPANT SERVED (INTERIOR)

ROOM NUMBER  
OCCUPANCY CLASSIFICATION - REFER TO KEY  
CALCULATED MAXIMUM OCCUPANT LOAD

165 ACT  
680 CAP  
XX

OUTSIDE AIR FILM R=0.17  
ANCHORED BRICK VENEER R=0.44  
AIR SPACE R=0.92  
2" RIGID CAVITY WALL INSULATION R=12.0  
VAPOR/PERMEABLE FLUID APPLIED MEMBRANE AIR BARRIER R=0.0  
INSIDE AIR FILM R=0.88  
R = 15.32  
U = 1/R = 0.065

TYPICAL EXTERIOR CAVITY WALL ASSEMBLY (8" CMU)

CODE PLAN LEGEND

ROOM LEGEND - FIRST FLOOR

ROOM LEGEND - SECOND FLOOR

PLUMBING FIXTURE COUNTS

BUILDING DESIGNED FOR (708) STUDENTS AND (23) STAFF

PLUMBING FIXTURE COUNTS

USER GROUP	NUMBER OF USERS	USER PER GENDER	WATER CLOSETS		LAVATORIES		DRINKING FTNS.		SERVICE SINKS	
			REQUIRED	PROVIDED	REQUIRED	PROVIDED	REQUIRED	PROVIDED	REQUIRED	PROVIDED
EDUCATIONAL (E)	(708)	[354] M, [354] F	1/50 = 8	13 W.C. 2 URNL	1/50 = 8	[11]	1/100 = 8	[8]	[1]	[2]
OFFICE (B)	(23)	[12] M, [12] F	1/50 = 1	3 W.C.	1/80 = 1	[3]	1/100 = 1	[2]	N/A	N/A

ROOM LEGEND - FIRST FLOOR

ROOM NO.	OWNER ROOM NO.	ROOM NAME	AREA (SF)	Ceiling Height
A101	C9	CORRIDOR	1,376 SF	8'-0"
A102	C8 LAUNDRY	LAUNDRY	515 SF	N/A
A103	C6 MECH	MECHANICAL	697 SF	8'-0"
A104		VESTIBULE	46 SF	8'-0"
A105		VESTIBULE	60 SF	8'-0"
A106		OFFICE	193 SF	8'-0"
A107		LOCKERS	110 SF	8'-0"
A108		RESTROOM	70 SF	8'-0"
A109		VESTIBULE	129 SF	8'-0"
A110		STORAGE	19 SF	8'-0"
A111		RESTROOM	228 SF	8'-0"
A112		SHOWERS	127 SF	8'-0"
A113		LOCKERS	668 SF	8'-0"
A114		STORAGE	111 SF	8'-0"
A115		SERVICE SINK	34 SF	8'-0"
A116		REF RESTROOM	98 SF	8'-0"
A117		REF RESTROOM	99 SF	8'-0"
A118		STORAGE	66 SF	8'-0"
A119		VESTIBULE	46 SF	8'-0"
A120		VESTIBULE	60 SF	8'-0"
A121		OFFICE	237 SF	8'-0"
A122		LOCKERS	110 SF	8'-0"
A123		RESTROOM	70 SF	8'-0"
A124		VESTIBULE	129 SF	8'-0"
A125		STORAGE	19 SF	8'-0"
A126		RESTROOM	228 SF	8'-0"
A127		SHOWERS	127 SF	8'-0"
A128		LOCKERS	668 SF	8'-0"
A129		STORAGE	110 SF	8'-0"
A130		CORRIDOR	1,707 SF	10'-0" / 8'-0"
A131		STORAGE	92 SF	8'-0"
A132		VESTIBULE	40 SF	8'-0"
A133		VESTIBULE	62 SF	8'-0"
A134		LOCKERS	215 SF	8'-0"
A135		RESTROOM	182 SF	8'-0"
A136		VESTIBULE	62 SF	8'-0"
A137		LOCKERS	216 SF	8'-0"
A138		RESTROOM	152 SF	8'-0"
A139		VESTIBULE	40 SF	8'-0"
A140		STORAGE	134 SF	8'-0"
A141		LOBBY	396 SF	10'-0"
A142		OPEN OFFICE	308 SF	9'-0"
A143		VESTIBULE	108 SF	10'-0"
A144		OFFICE	250 SF	10'-0"
A145		STORAGE	12 SF	10'-0"

ROOM LEGEND - SECOND FLOOR

ROOM NO.	OWNER ROOM NO.	ROOM NAME	AREA (SF)	Ceiling Height
A201		MULTIPURPOSE	8,618 SF	N/A
A202		RAMP 1	345 SF	9'-6"
A203		STORAGE	682 SF	N/A
A204		VESTIBULE	46 SF	9'-6"
A205		RAMP 2	317 SF	10'-0"
A206		CORRIDOR	310 SF	9'-0"
A207		LOCKERS	484 SF	9'-6"
A208		BATHROOM	112 SF	9'-0"
A209		STORAGE	399 SF	N/A
A210		EXISTING CORRIDOR	1,422 SF	N/A
A211		EXISTING CORRIDOR	1,219 SF	N/A
A212		SERVICE	50 SF	N/A
A213		IT CLOSET	31 SF	N/A
A214		EQUIPMENT PLATFORM	1,257 SF	N/A

PLUMBING FIXTURE COUNTS

USER GROUP	NUMBER OF USERS	USER PER GENDER	REQUIRED	PROVIDED	REQUIRED	PROVIDED	REQUIRED	PROVIDED	REQUIRED	PROVIDED
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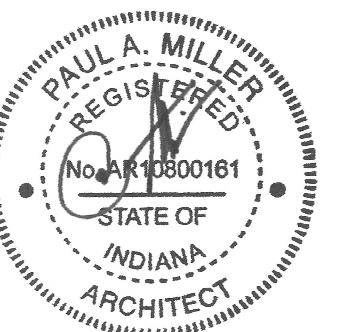
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### FIRST FLOOR ARCHITECTURAL PLAN

# A-11

### ARCHITECTURAL PLAN GENERAL NOTES

- A. ALL CMU WALLS THAT DO NOT LAY OUT IN FULL OR HALF LENGTH SHOULD BE BALANCED SO AS NOT TO HAVE ANY PIECES LESS THAN 4" IN SIZE EXPOSED TO VIEW.
- B. WHERE DISSIMILAR FLOOR MATERIALS MEET, THEY SHALL CROSS UNDER THE CENTERLINE OF THE DOOR, UNLESS NOTED OTHERWISE.
- C. THE BASE FLOOR ELEVATION INDICATED FOR THE PROJECT IS 100.07'. REFER TO SITE PLAN FOR CORRELATION TO USGS DATUM.
- D. ALL INTERIOR MASONRY WALLS THAT RUN TO UNDERSIDE OF DECK ABOVE SHALL HAVE A 2" JOINT (MIN. 0.4) THE DECK TO BE FILLED WITH FIRE STOPPING AT RATED WALLS PER PROJECT MANUAL, AND MINERAL WOOL AT THE NON-RATED WALLS, TO ALLOW FOR DEFLECTION.
- E. FOR TYPICAL COMMON JOINT DETAILS AND CONSTRUCTION MOVEMENT JOINT DETAILS REFER TO DETAILS ON SHEETS AS-01 & AS-02.
- F. ALL DIMENSIONS ON FLOOR PLANS ARE TO FINISH FACE OF CMU, CONCRETE, BRICK OR FINISH FACE OF GWS AT METAL STUD WALLS, UNLESS NOTED OTHERWISE. EXCEPTION: EXTERIOR METAL STUD WALLS ARE TO FACE OF METAL STUDS.
- G. HINGE SIDE DOOR LAMB AT WALLS WILL TYPICALLY BE LOCATED 4" MINIMUM FROM ADJACENT WALL UNLESS NOTED OTHERWISE.
- H. ALL EXPOSED CONCRETE MASONRY UNITS (CMU) CORNERS ARE TO BE BULLNOSE, EXCEPT AT WINDOW JAMB, BULKHEADS, WINDOW AND DOOR HEADS.
- I. SEE RELECTED CEILING PLANS FOR BULKHEAD LOCATIONS AND DETAIL REFERENCES.
- J. REFER TO ROOM FINISH SCHEDULE OR PLAN AND EQUIPMENT PLANS FOR LOCATION AND EXTENT OF FINISH FLOOR MATERIALS.
- K. PROVIDE WOOD BLOCKING AS REQUIRED, WITHIN METAL STUD WALLS FOR WALL MOUNTED ITEMS.
- L. REFER TO MASTER/CODE PLANS FOR CODE INFORMATION AND FIRE RATED WALL LOCATIONS.
- M. PROVIDE SPRAY FOAM INSULATION AND THERMAL BARRIER CONTINUOUS AT INTERSECTION OF EXTERIOR WALLS AND DECK.


### OVERALL FLOOR PLAN LEGEND

- W81 INDICATES WALL TYPE. REFER TO SHEET A-06 FOR WALL THICKNESS, HEIGHT, AND COMPOSITION. ALL UNTAGGED WALLS ARE TO BE W82 UNLESS NOTED OTHERWISE ON PLANS.
- ALL INTERIOR WALLS TO START WITH 4" CMU COARSING AT BASE, UNLESS NOTED OTHERWISE ON PLAN.
- 1 INFILL WALL OPENING AT REMOVED DOOR AND FRAME WITH CMU. REFER TO WALL TYPE FOR DETAILS.
- 2 NEW DOOR AND FRAME IN EXISTING WALL OPENING AT END.
- 3 NEW WALL MOUNTED 1 1/2" DIAMETER ALUMINUM HANDRAIL.
- 4 BACKFILL DEMOLISHED BRICK VENEER LOCATION WITH 6" CMU.
- 5 NEW DOORS AND FRAME IN EXISTING WALL OPENING (REVERSE SWINGS FROM EXISTING CONDITION).
- 6 INSTALL NEW STAIR AT DEMOLISHED LOUVER LOCATION. REFER TO WALL SECTION 20A-11.
- 7 NEW HANGING EQUIPMENT. REFER TO EQUIPMENT PLAN.
- 8 INSTALL 2" BUILDING EXPANSION JOINT WITH PREFORMED JOINT SEAL EXPANSION JOINT BETWEEN NEW AND EXISTING.
- 9 IDENTIFY EXISTING DOOR FRAME AS REQUIRED TO RECEIVE NEW UPDATED TECH DEVICES. SEE TECHNOLOGY SHEETS FOR ADDITIONAL DETAILS.
- 10 ADD CARD READER AND REQUIRED WIRING TO EXISTING DOOR AND FRAME.
- 11 SPARTITE SLIP-RESISTANT MESH OVER NEW DOOR LOCATOR. REFER TO INTERIOR SHEETS FOR DETAILS.
- 12 REINSTALL EXISTING STOREFRONT FRAMING AND GLAZING.
- 13 REPAINT EXISTING COLUMN AFTER COMPLETION OF CONSTRUCTION.
- 14 WALL TO REST WITH 4" CMU COARSING AT BASE.

### VERIFICATION NOTE

CONTRACTOR SHALL VERIFY ALL DIMENSIONS AND CLEARANCES AND ALL EXISTING FIELD CONDITIONS BEFORE STARTING CONSTRUCTION. COMMENCEMENT OF WORK CONSTITUTES ACCEPTANCE OF CONDITIONS.

SHOULD DIFFERENT CONDITIONS BE ENCOUNTERED, CONTACT THE ARCHITECT BEFORE PROCEEDING WITH WORK.

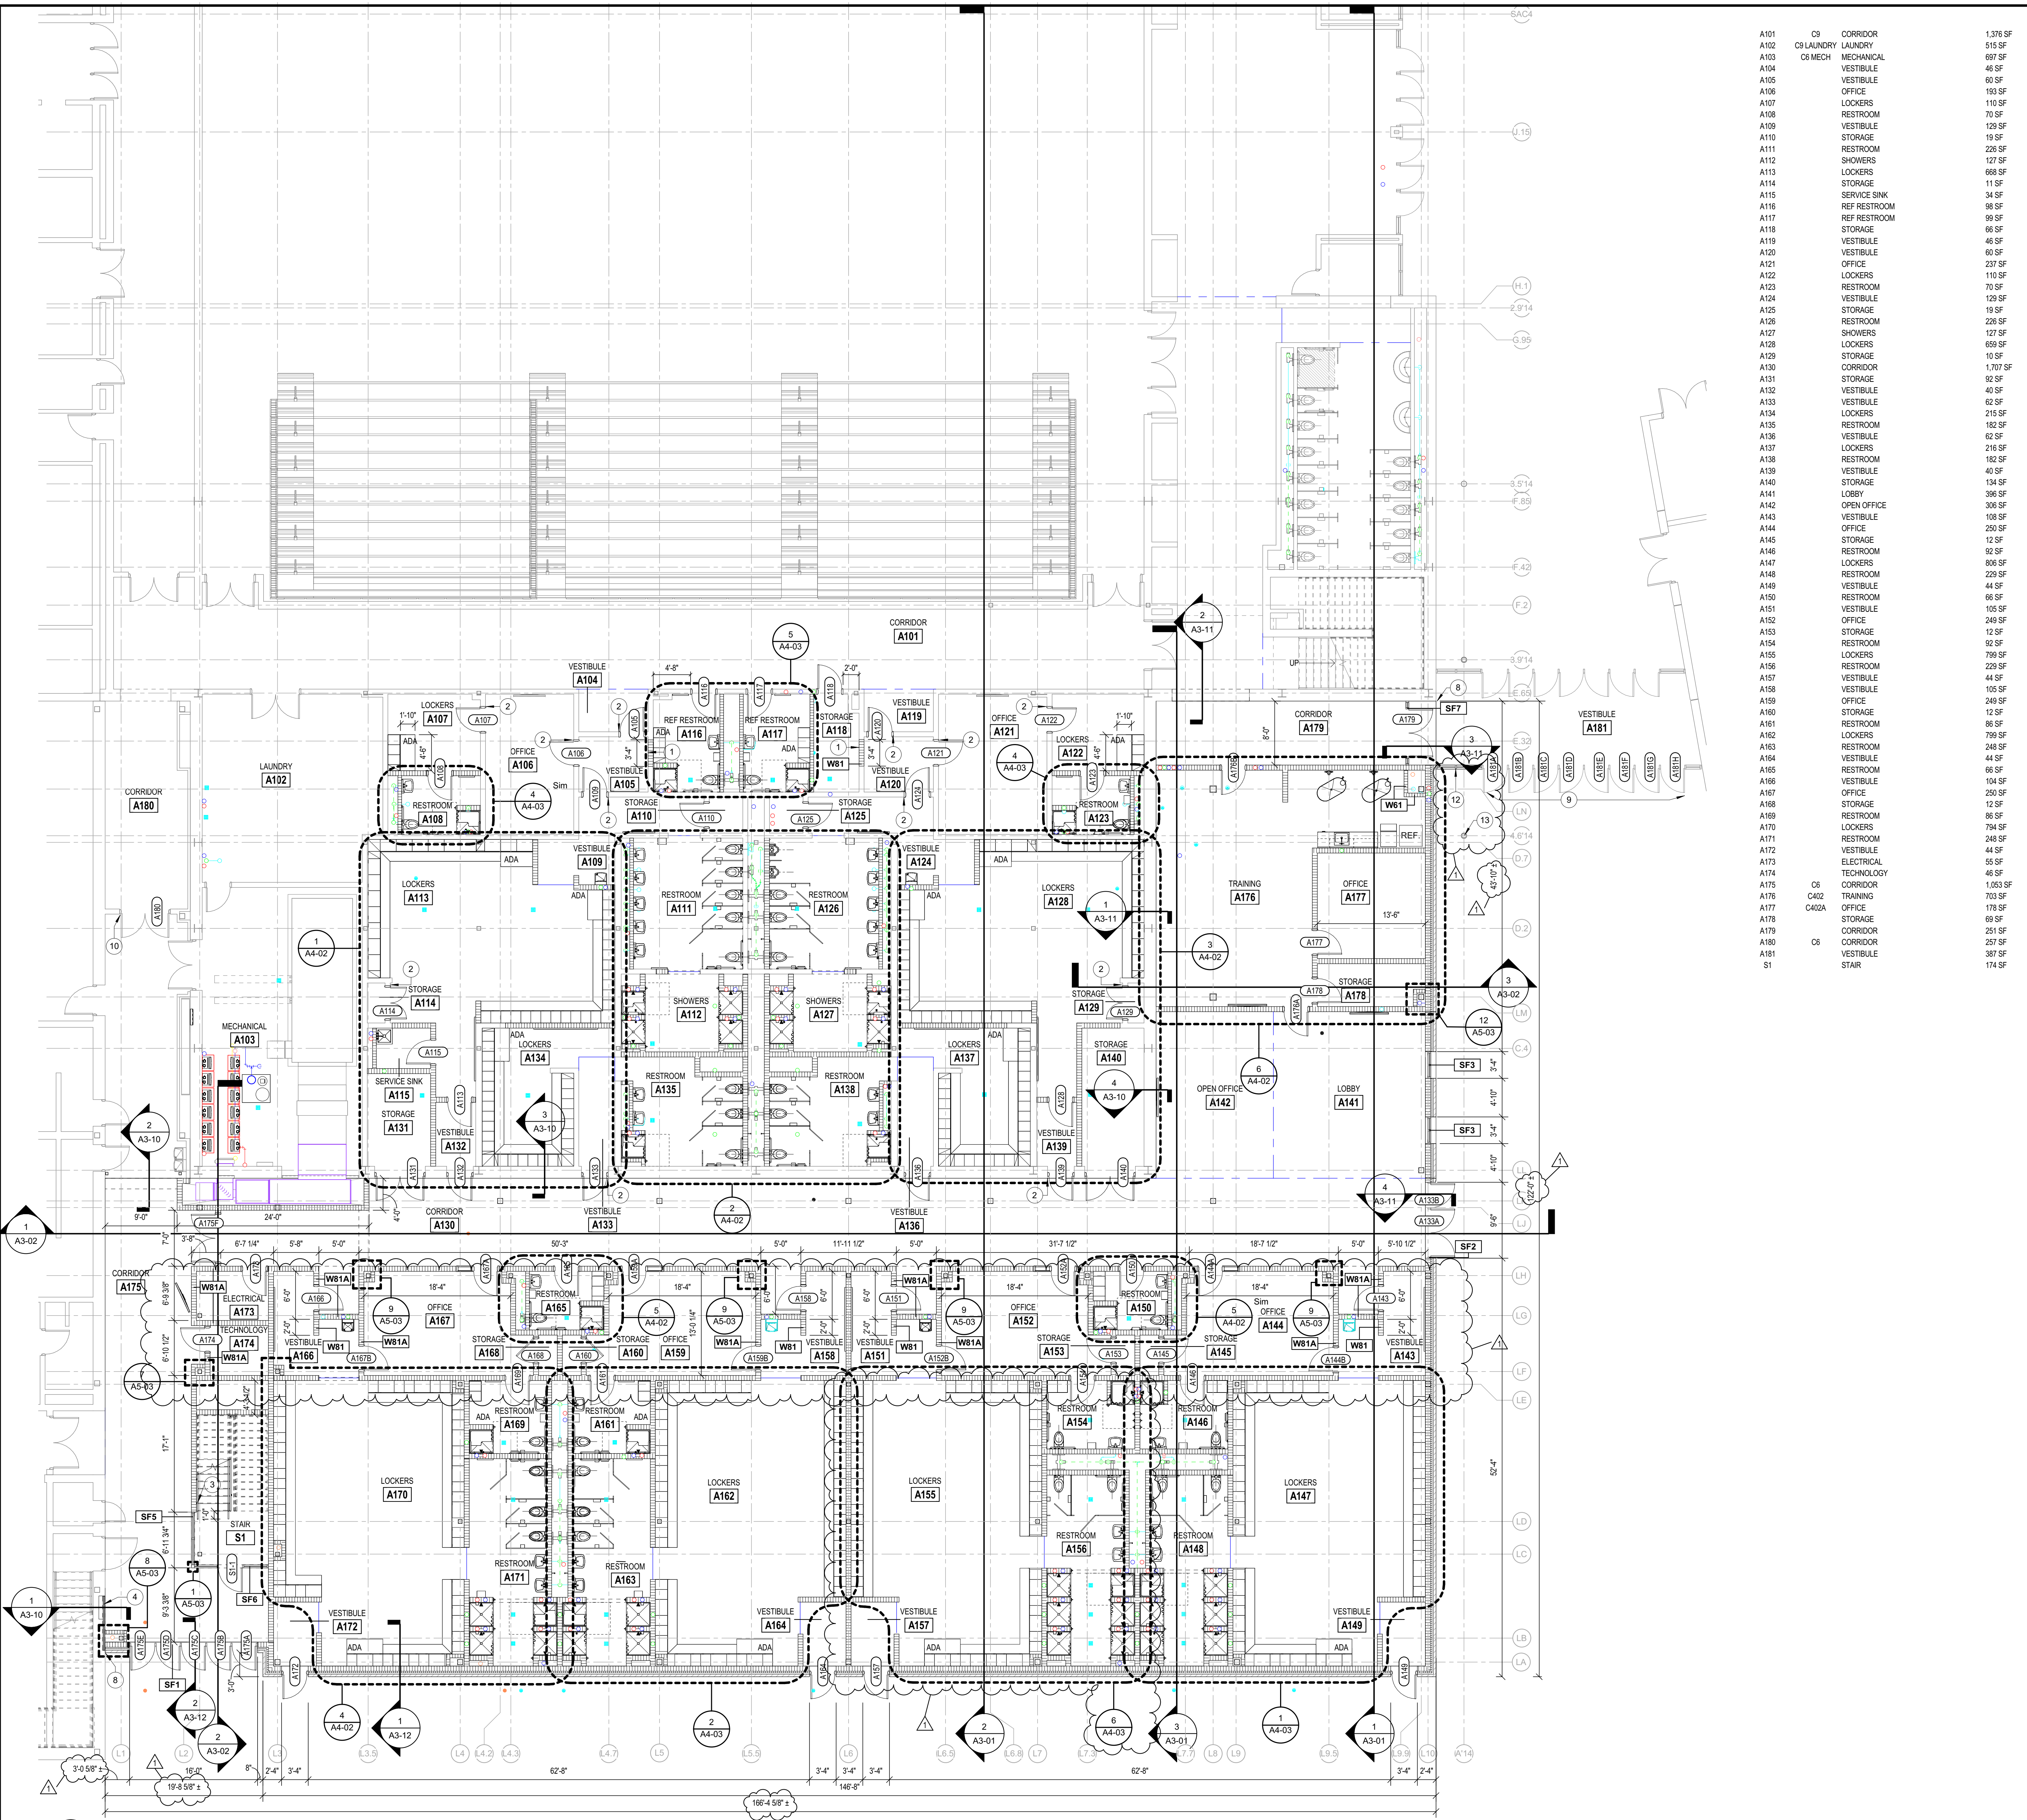

A101	C3	CORRIDOR	1,376 SF
A102	C3	LAUNDRY	516 SF
A103	C6	MECH	697 SF
A104		VESTIBULE	46 SF
A105		VESTIBULE	60 SF
A106		RESTROOM	163 SF
A107		LOCKERS	110 SF
A108		RESTROOM	70 SF
A109		VESTIBULE	129 SF
A110		STORAGE	19 SF
A111		RESTROOM	228 SF
A112		SHOWERS	127 SF
A113		LOCKERS	668 SF
A114		STORAGE	11 SF
A115		SERVICE SINK	34 SF
A116		REF RESTROOM	98 SF
A117		REF RESTROOM	99 SF
A118		STORAGE	66 SF
A119		VESTIBULE	46 SF
A120		OFFICE	80 SF
A121		LOCKERS	237 SF
A122		RESTROOM	110 SF
A123		VESTIBULE	70 SF
A124		STORAGE	129 SF
A125		RESTROOM	19 SF
A126		SHOWERS	228 SF
A127		LOCKERS	127 SF
A128		LOCKERS	659 SF
A129		STORAGE	10 SF
A130		CORRIDOR	1,707 SF
A131		STORAGE	92 SF
A132		VESTIBULE	40 SF
A133		LOCKERS	62 SF
A134		LOCKERS	215 SF
A135		RESTROOM	162 SF
A136		VESTIBULE	62 SF
A137		LOCKERS	216 SF
A138		RESTROOM	182 SF
A139		VESTIBULE	40 SF
A140		STORAGE	134 SF
A141		LOBBY	396 SF
A142		OPEN OFFICE	306 SF
A143		VESTIBULE	108 SF
A144		OFFICE	250 SF
A145		RESTROOM	12 SF
A146		RESTROOM	92 SF
A147		LOCKERS	806 SF
A148		RESTROOM	229 SF
A149		VESTIBULE	44 SF
A150		RESTROOM	66 SF
A151		VESTIBULE	105 SF
A152		OFFICE	249 SF
A153		STORAGE	12 SF
A154		RESTROOM	92 SF
A155		LOCKERS	799 SF
A156		RESTROOM	229 SF
A157		VESTIBULE	44 SF
A158		OFFICE	105 SF
A159		OFFICE	249 SF
A160		STORAGE	12 SF
A161		RESTROOM	134 SF
A162		LOCKERS	799 SF
A163		RESTROOM	248 SF
A164		VESTIBULE	44 SF
A165		RESTROOM	66 SF
A166		VESTIBULE	104 SF
A167		OFFICE	250 SF
A168		RESTROOM	12 SF
A169		RESTROOM	86 SF
A170		LOCKERS	794 SF
A171		RESTROOM	248 SF
A172		VESTIBULE	44 SF
A173		ELECTRICAL	55 SF
A174		TECHNOLOGY	46 SF
A175	C62	CORRIDOR	1,063 SF
A176	C02	TRAINING	703 SF
A177	C402A	OFFICE	178 SF
A178		STORAGE	69 SF
A179		CORRIDOR	251 SF
A180	C6	CORRIDOR	257 SF
A181		VESTIBULE	387 SF
S1		STAIR	174 SF

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### FIRST FLOOR ARCHITECTURAL PLAN

SCALE: 1/8" = 1'-0"







# ZIONSVILLE COMMUNITY HIGH SCHOOL ATHLETIC LOCKER ROOMS ADDITION AND RENOVATION

1000 MULBERRY STREET, ZIONSVILLE, IN 46077

ZIONSVILLE COMMUNITY SCHOOLS



ZIONSVILLE COMMUNITY SCHOOLS


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900 MULBERRY ST. ZIONSVILLE, IN 46077

KEY PLAN

ISSUED FOR BID



PROJECT MANAGER: JM  
DRAWN BY: Author  
PROJECT NUMBER: 224018.00  
PROJECT ISSUE DATE: 01/21/2025

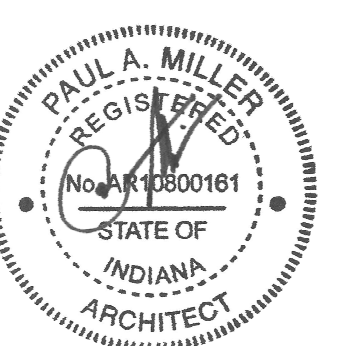REV. NO.	DESCRIPTION	DATE
1	ADDENDUM #1	02/11/2025

FIRST FLOOR REFLECTED CEILING PLAN

# AC-11

A101	C9	CORRIDOR	1,376 SF
A102	C9	LAUNDRY	915 SF
A103	C9	MECHANICAL	897 SF
A104	C9	VESTIBULE	46 SF
A105	C9	VESTIBULE	60 SF
A106	C9	OFFICE	193 SF
A107	C9	LOCKERS	116 SF
A108	C9	RESTROOM	70 SF
A109	C9	VESTIBULE	129 SF
A110	C9	STORAGE	19 SF
A111	C9	RESTROOM	226 SF
A112	C9	SHOWERS	127 SF
A113	C9	LOCKERS	668 SF
A114	C9	STORAGE	11 SF
A115	C9	SERVICE SINK	34 SF
A116	C9	REF RESTROOM	98 SF
A117	C9	REF RESTROOM	99 SF
A118	C9	STORAGE	66 SF
A119	C9	VESTIBULE	46 SF
A120	C9	VESTIBULE	60 SF
A121	C9	OFFICE	237 SF
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A130	C9	CORRIDOR	1,707 SF
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A132	C9	VESTIBULE	40 SF
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A172	C9	VESTIBULE	44 SF
A173	C9	ELECTRICAL	55 SF
A174	C9	TECHNOLOGY	46 SF
A175	C6	CORRIDOR	1,063 SF
A176	C42A	TRAINING	703 SF
A177	C402A	OFFICE	178 SF
A178	C6	STORAGE	89 SF
A179	C6	CORRIDOR	251 SF
A180	C6	CORRIDOR	257 SF
A181	C6	VESTIBULE	387 SF
S1		STAR	174 SF

**REFLECTED CEILING PLAN NOTES**

A. PROVIDE REVEAL DRYWALL TRIM AT ALL LOCATIONS WHERE GYPSUM WALL BOARD (GWB) ABUTS A DISSIMILAR MATERIAL. TYPICAL UNLESS NOTED OTHERWISE.

B. BULKHEAD FRAMING SHALL BE ATTACHED TO STRUCTURAL SUPPORTS AND NOT TO THE ROOF DECK.

**REFLECTED CEILING NOTES**

(ALL NOTES MAY NOT BE INDICATED ON THIS SHEET)

1. INSTALL NEW CEILING IN PLACED OF DEMOLISHED PORTION OF CEILING. CONNECT TO EXISTING CEILING GRID.

2. PROVIDE NEW EFS SOFFIT ASSEMBLY AS REQUIRED TO MATCH EXISTING SOFFIT REMOVED FOR CONSTRUCTION.

**REFLECTED CEILING PLAN LEGEND**

10'-4" INDICATES ELEVATION HEIGHT

XXXXXX INDICATES CEILING HEIGHT


X1 XXXXX INDICATES ACOUSTIC PANEL CEILING TYPE AND HEIGHT. REFER TO PROJECT MANUAL FOR TYPE

- LIGHT FIXTURE - REFER TO ELECTRICAL DRAWINGS
- LIGHT FIXTURE - REFER TO ELECTRICAL DRAWINGS
- LIGHT FIXTURE - REFER TO ELECTRICAL DRAWINGS
- CLOCK - REFER TO TECHNOLOGY DRAWINGS
- MECHANICAL DIFFUSER - REFER TO MECHANICAL DRAWINGS
- MECHANICAL RETURN AIR GRILLE - REFER TO MECHANICAL DRAWINGS
- CEILING MOUNTED MECHANICAL UNIT - REFER TO MECHANICAL DRAWINGS
- MECHANICAL UNIT HEATER - REFER TO MECHANICAL DRAWINGS
- RECESSED CEILING SPEAKER
- MOTION DETECTOR
- CEILING MOUNTED EXIT LIGHT
- CEILING MOUNTED CAMERA
- WIRELESS ACCESS POINT (WAP)
- CONTROL JOINT IN GYPSUM BOARD CEILING OR BULKHEAD
- SOUND REINFORCEMENT SPEAKER
- FIRE ALARM HEAT DETECTOR
- FIRE ALARM HORN STROBE
- FIRE ALARM SPEAKER STROBE
- FIRE ALARM STROBE
- FIRE ALARM SMOKE DETECTOR
- OCCUPANCY SENSOR
- ACOUSTICAL CEILING TILE (ACT)
- ACOUSTICAL CEILING TILE (ACT)
- GYPSUM WALL BOARD BULKHEAD / CEILING EXTERIOR FINISH SYSTEM (E.F.S.)
- EXTERIOR INSULATION FINISH SYSTEM (E.I.F.S.)
- INTERIOR FINISH SYSTEM (I.F.S.)
- EXTERIOR FINISH SYSTEM SOFFIT (EFS)

**VERIFICATION NOTE**

CONTRACTOR SHALL VERIFY ALL DIMENSIONS AND CLEARANCES AND ALL EXISTING FIELD CONDITIONS BEFORE STARTING CONSTRUCTION. COMMENCEMENT OF WORK CONSTITUTES ACCEPTANCE OF CONDITIONS.

SHOULD DIFFERENT CONDITIONS BE ENCOUNTERED, CONTACT THE ARCHITECT BEFORE PROCEEDING WITH WORK.

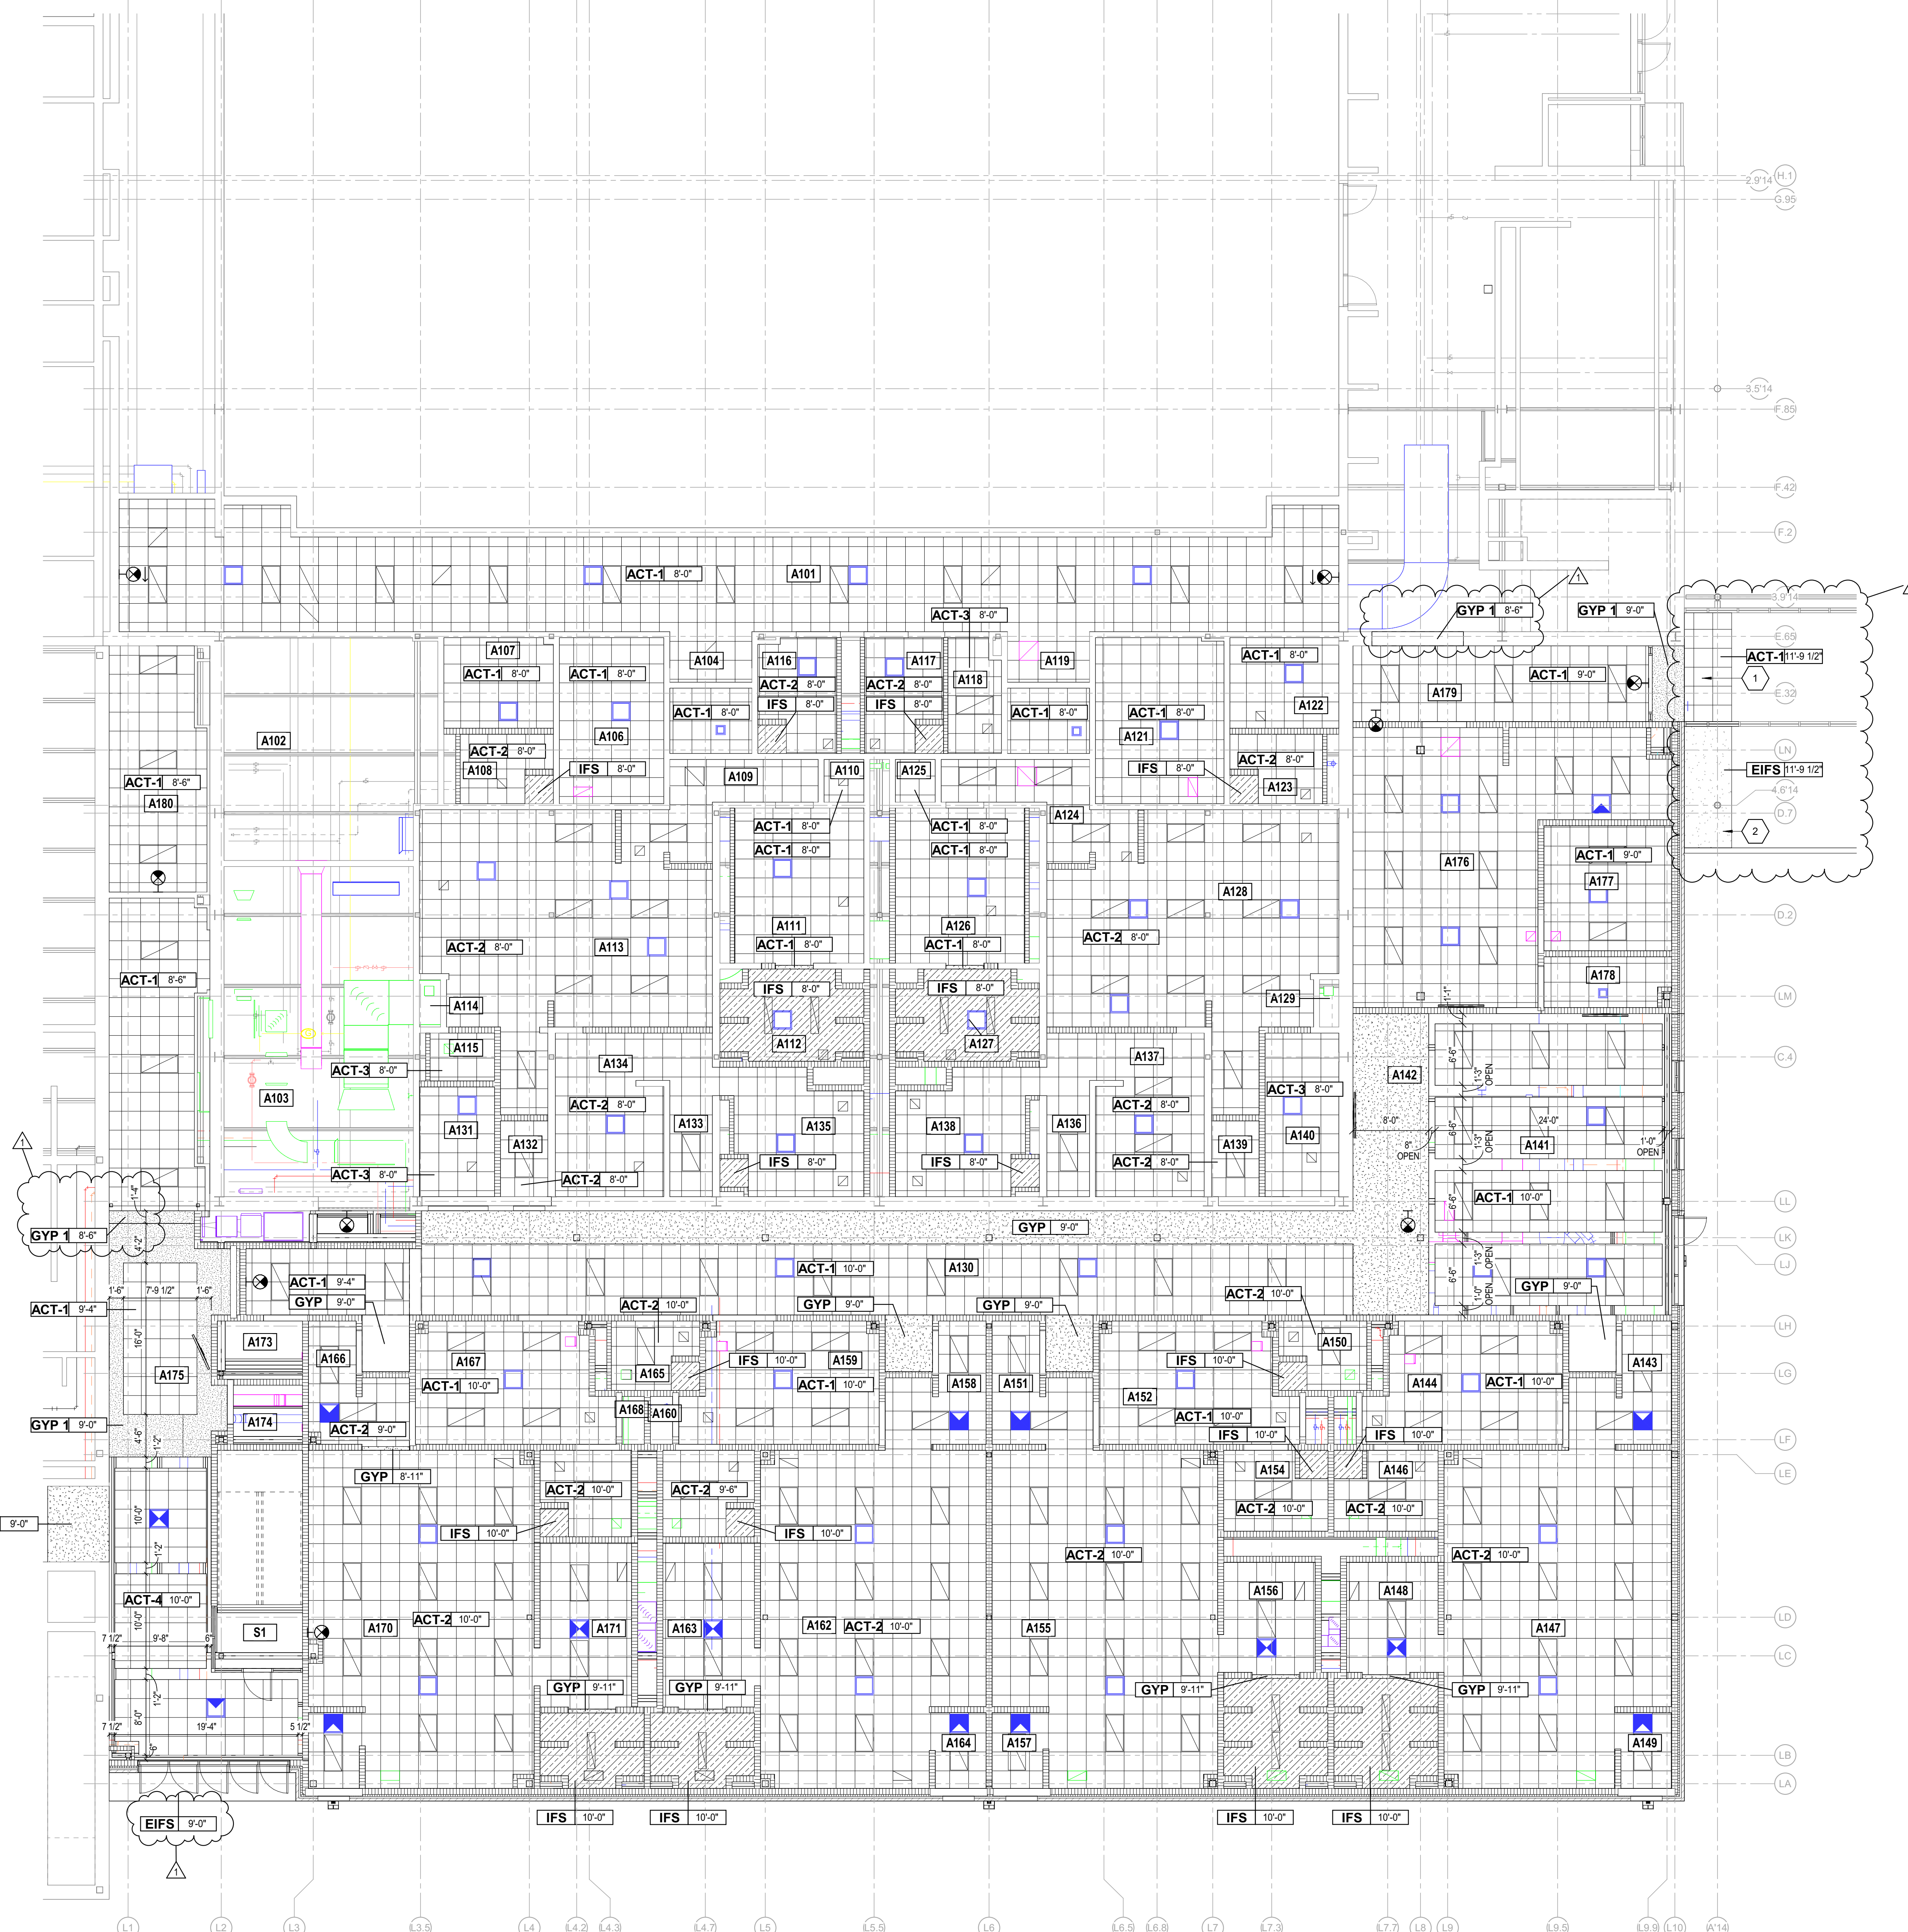

**1 FIRST FLOOR CEILING PLAN**  
SCALE: 1/8" = 1'-0"

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# ZIONSVILLE COMMUNITY HIGH SCHOOL ATHLETIC LOCKER ROOMS ADDITION AND RENOVATION

1000 MULBERRY STREET,  
ZIONSVILLE, IN 46077

ZIONSVILLE COMMUNITY SCHOOLS



ARCHITECT




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900 MULBERRY ST. ZIONSVILLE, IN 46077



## KEY PLAN

ISSUED FOR BID

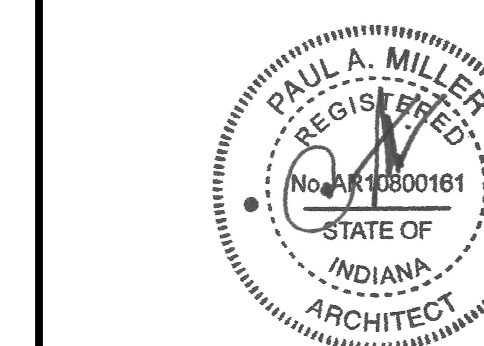

PROJECT MANAGER: JM

PROJECT NUMBER: 224018.00

PROJECT ISSUE DATE: 01/21/2025

REV. NO.	DESCRIPTION	DATE
1	ADDENDUM #1	02/11/2025

SECOND FLOOR REFLECTED CEILING PLAN

# AC-12

A201	MULTIPURPOSE	8,618 SF
A202	RAMP 1	345 SF
A203	STORAGE	482 SF
A204	VESTIBULE	46 SF
A205	RAMP 2	317 SF
A206	CORRIDOR	310 SF
A207	LOCKERS	464 SF
A208	BATHROOM	112 SF
A209	STORAGE	399 SF
A210	EXISTING CORRIDOR	1,422 SF
A211	EXISTING CORRIDOR	1,219 SF
A212	SERVICE	50 SF
A213	IT CLOSET	31 SF
S1	STAIR	174 SF

**REFLECTED CEILING PLAN NOTES**

A. PROVIDE REVEAL DRYWALL TRIM AT ALL LOCATIONS WHERE GYPSUM WALL BOARD (GWB) ABUTS A DISSIMILAR MATERIAL. TYPICAL UNLESS NOTED OTHERWISE.

B. BULKHEAD FRAMING SHALL BE ATTACHED TO STRUCTURAL SUPPORTS AND NOT TO THE ROOF DECK.

**REFLECTED CEILING NOTES**

(ALL NOTES MAY NOT BE INDICATED ON THIS SHEET)

1. INSTALL NEW CEILING IN PLACED OF DEMOLISHED PORTION OF CEILING. CONNECT TO EXISTING CEILING GRID.

2. PROVIDE NEW EIFS SOFFIT ASSEMBLY AS REQUIRED TO MATCH EXISTING SOFFIT REMOVED FOR CONSTRUCTION.


## REFLECTED CEILING PLAN LEGEND

- 10'-4" INDICATES ELEVATION HEIGHT
- XX-XX' INDICATES CEILING HEIGHT
- X1 XX-XX' INDICATES ACOUSTIC PANEL CEILING TYPE AND HEIGHT. REFER TO PROJECT MANUAL FOR TYPE.
- LIGHT FIXTURE - REFER TO ELECTRICAL DRAWINGS
- LIGHT FIXTURE - REFER TO ELECTRICAL DRAWINGS
- LIGHT FIXTURE - REFER TO ELECTRICAL DRAWINGS
- CLOCK - REFER TO TECHNOLOGY DRAWINGS
- MECHANICAL DIFFUSER - REFER TO MECHANICAL DRAWINGS
- MECHANICAL RETURN AIR GRILLE - REFER TO MECHANICAL DRAWINGS
- CEILING MOUNTED MECHANICAL UNIT - REFER TO MECHANICAL DRAWINGS
- MECHANICAL UNIT HEATER - REFER TO MECHANICAL DRAWINGS
- RECESSED CEILING SPEAKER
- MOTION DETECTOR
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- WIRELESS ACCESS POINT (WAP)
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- EXTERIOR FINISH SYSTEM SOFFIT (E.F.S.)

**VERIFICATION NOTE**

CONTRACTOR SHALL VERIFY ALL DIMENSIONS AND CLEARANCES AND ALL EXISTING FIELD CONDITIONS BEFORE STARTING CONSTRUCTION. COMMENCEMENT OF WORK CONSTITUTES ACCEPTANCE OF CONDITIONS.

SHOULD DIFFERENT CONDITIONS BE ENCOUNTERED, CONTACT THE ARCHITECT BEFORE PROCEEDING WITH WORK.

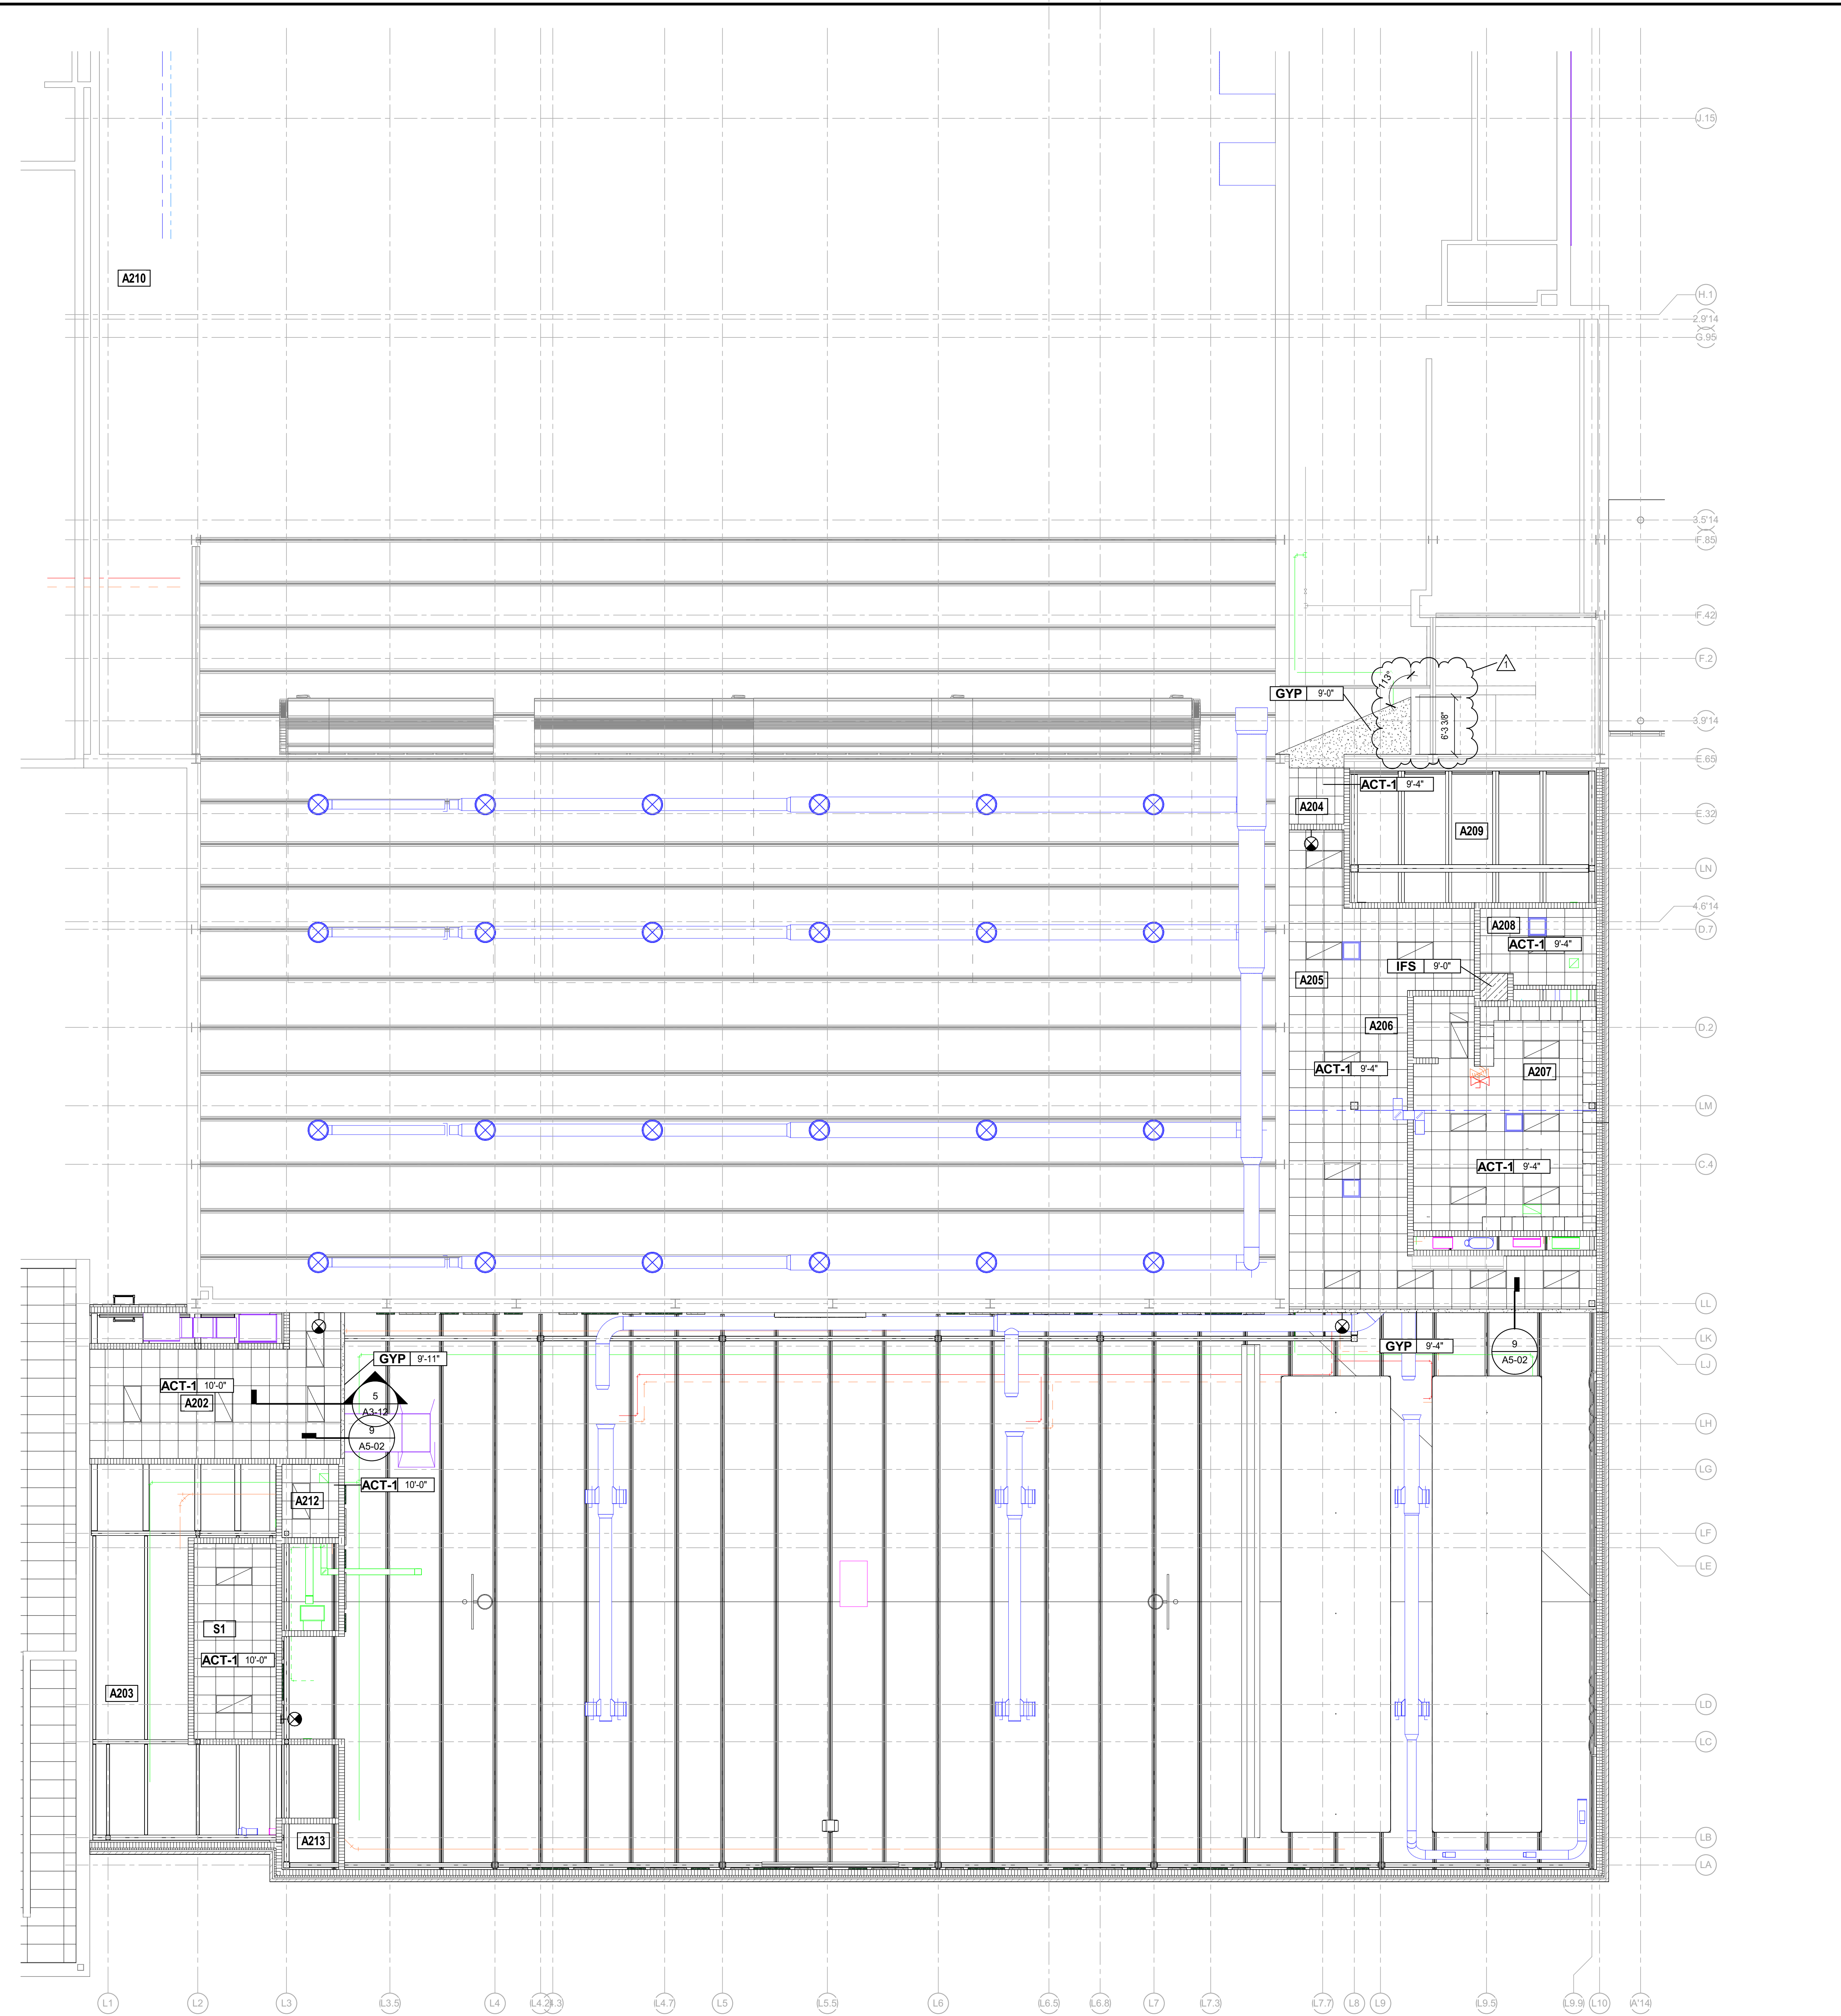

**1 114'-0" - 2ND FLOOR MP**  
SCALE: 1/8" = 1'-0"

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# ZIONSVILLE COMMUNITY HIGH SCHOOL ATHLETIC LOCKER ROOMS ADDITION AND RENOVATION

1000 MULBERRY STREET,  
ZIONSVILLE, IN 46077

ZIONSVILLE COMMUNITY SCHOOLS




ZIONSVILLE COMMUNITY SCHOOLS


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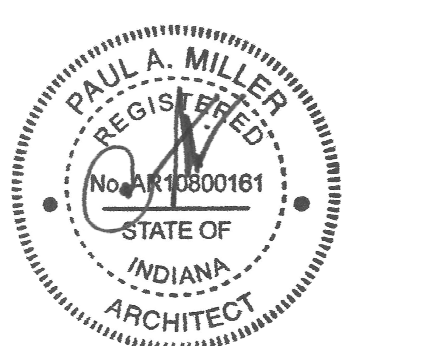
(800) 452-3573 WWW.FHAI.COM  
900 MULBERRY ST. ZIONSVILLE, IN 46077



KEY PLAN

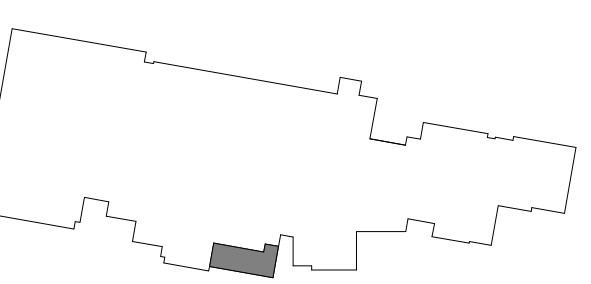

ISSUED FOR BID

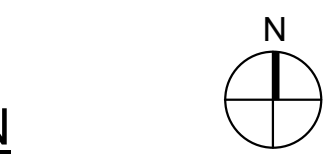

PROJECT MANAGER: JM

PROJECT NUMBER: 224018.00

PROJECT ISSUE DATE: 01/21/2025

REV. NO.	DESCRIPTION	DATE
1	ADDENDUM #1	02/11/2025

ROOF PLAN

AR-01


**ROOF PLAN GENERAL NOTES**

- ALL DETAILS SHOWN ARE FOR GENERAL INFORMATION. ALL FINAL FLASHING CONDITIONS SHALL BE THE RESPONSIBILITY OF THE ROOF INSTALLER AND SHALL MEET APPROVAL OF ROOF MANUFACTURER.
- ALL DETAIL MODIFICATIONS MUST HAVE SHOP DRAWINGS APPROVAL. CONTRACTOR SHALL INSPECT AND VERIFY ALL EXISTING FIELD CONDITIONS, CLEARANCES, AND DIMENSIONS BEFORE STARTING CONSTRUCTION. COMMENCEMENT OF WORK CONSTITUTES ACCEPTANCE OF EXISTING CONDITIONS. SHOULD DIFFERENT CONDITIONS BE ENCOUNTERED, CONTACT ARCHITECT BEFORE PROCEEDING WITH ANY FURTHER WORK.
- OPENINGS IN ROOF WILL BE CUT BY ROOF CONTRACTOR. MECHANICAL CONTRACTOR TO COORDINATE LOCATION OF OPENING IN ROOF WITH ROOF CONTRACTOR. CURB TO BE PROVIDED BY MECHANICAL CONTRACTOR AND INSTALLED BY ROOF CONTRACTOR.
- PROVIDE FLASHING AND SADDLES FOR ALL EQUIPMENT PROVIDED UNDER MECHANICAL.
- SADDLES AND TAPERED INSULATION SYMBOLS INDICATE DESIGN INTENT TO SLOPE TO DRAIN. CONTRACTOR SHALL PROVIDE SUBMITTAL DRAWINGS FOR TAPERED INSULATION AND SADDLES TO INSURE POSITIVE SLOPE. THE ROOF CONTRACTOR SHALL PROTECT ALL ROOF DRAINS, SCUPPERS, AND DOWNSPOUTS FROM DEBRIS CREATED DURING DEMOLITION AND CONSTRUCTION. THE ROOF CONTRACTOR SHALL INSPECT AND CLEAR ALL DRAINS, SCUPPERS, AND DOWNSPOUTS PRIOR TO COMPLETION OF WORK AND TO ENSURE THAT THEY ARE FREE OF DEBRIS AND ARE FUNCTIONING PROPERLY.
- MECHANICAL, ELECTRICAL AND PLUMBING INFORMATION SHOWN ON THIS PLAN IS GENERAL IN NATURE. REFER TO P, M AND E DRAWINGS FOR FURTHER INFORMATION AND COORDINATE ALL REQUIRED ROOF OPENINGS OR ROOF MOUNTED EQUIPMENT.

**ROOF PLAN NOTES**

(ALL NOTES MAY NOT BE INDICATED ON THIS SHEET)

- MEMBRANE ROOFING SYSTEM (ADHERED) ON 1/4" COVERED BOARD OVER ROOF INSULATION (4" BASE) ON VAPOR RETARDER OVER 8" SUBSTRATE BOARD ON SLOPING (1/4" / 1" FT MIN) DOUBLE PITCHED ACOUSTICAL METAL ROOF DECK.
- MEMBRANE ROOFING SYSTEM (ADHERED) ON 1/4" COVER BOARD OVER ROOF INSULATION (4" BASE) WITH TAPERED ROOF INSULATION (1/4" FT MIN), AS SHOWN, ON VAPOR RETARDER OVER 1/2" METAL ROOF DECK.
- 2" WIDE FIXED ALUMINUM ACCESS LADDER WITH PLATFORM OVER PARAPET, SIMILAR TO CREEK'S MODEL 903A.
- PROVIDE NEW ROOF MEMBRANE ASSEMBLY TO MATCH EXISTING ASSEMBLY REMOVED FOR CONSTRUCTION.
- PROVIDE NEW FLASHING AND COUNTERFLASHING ROOF TO TO WALL DETAIL SIMILAR TO 3A3-11.

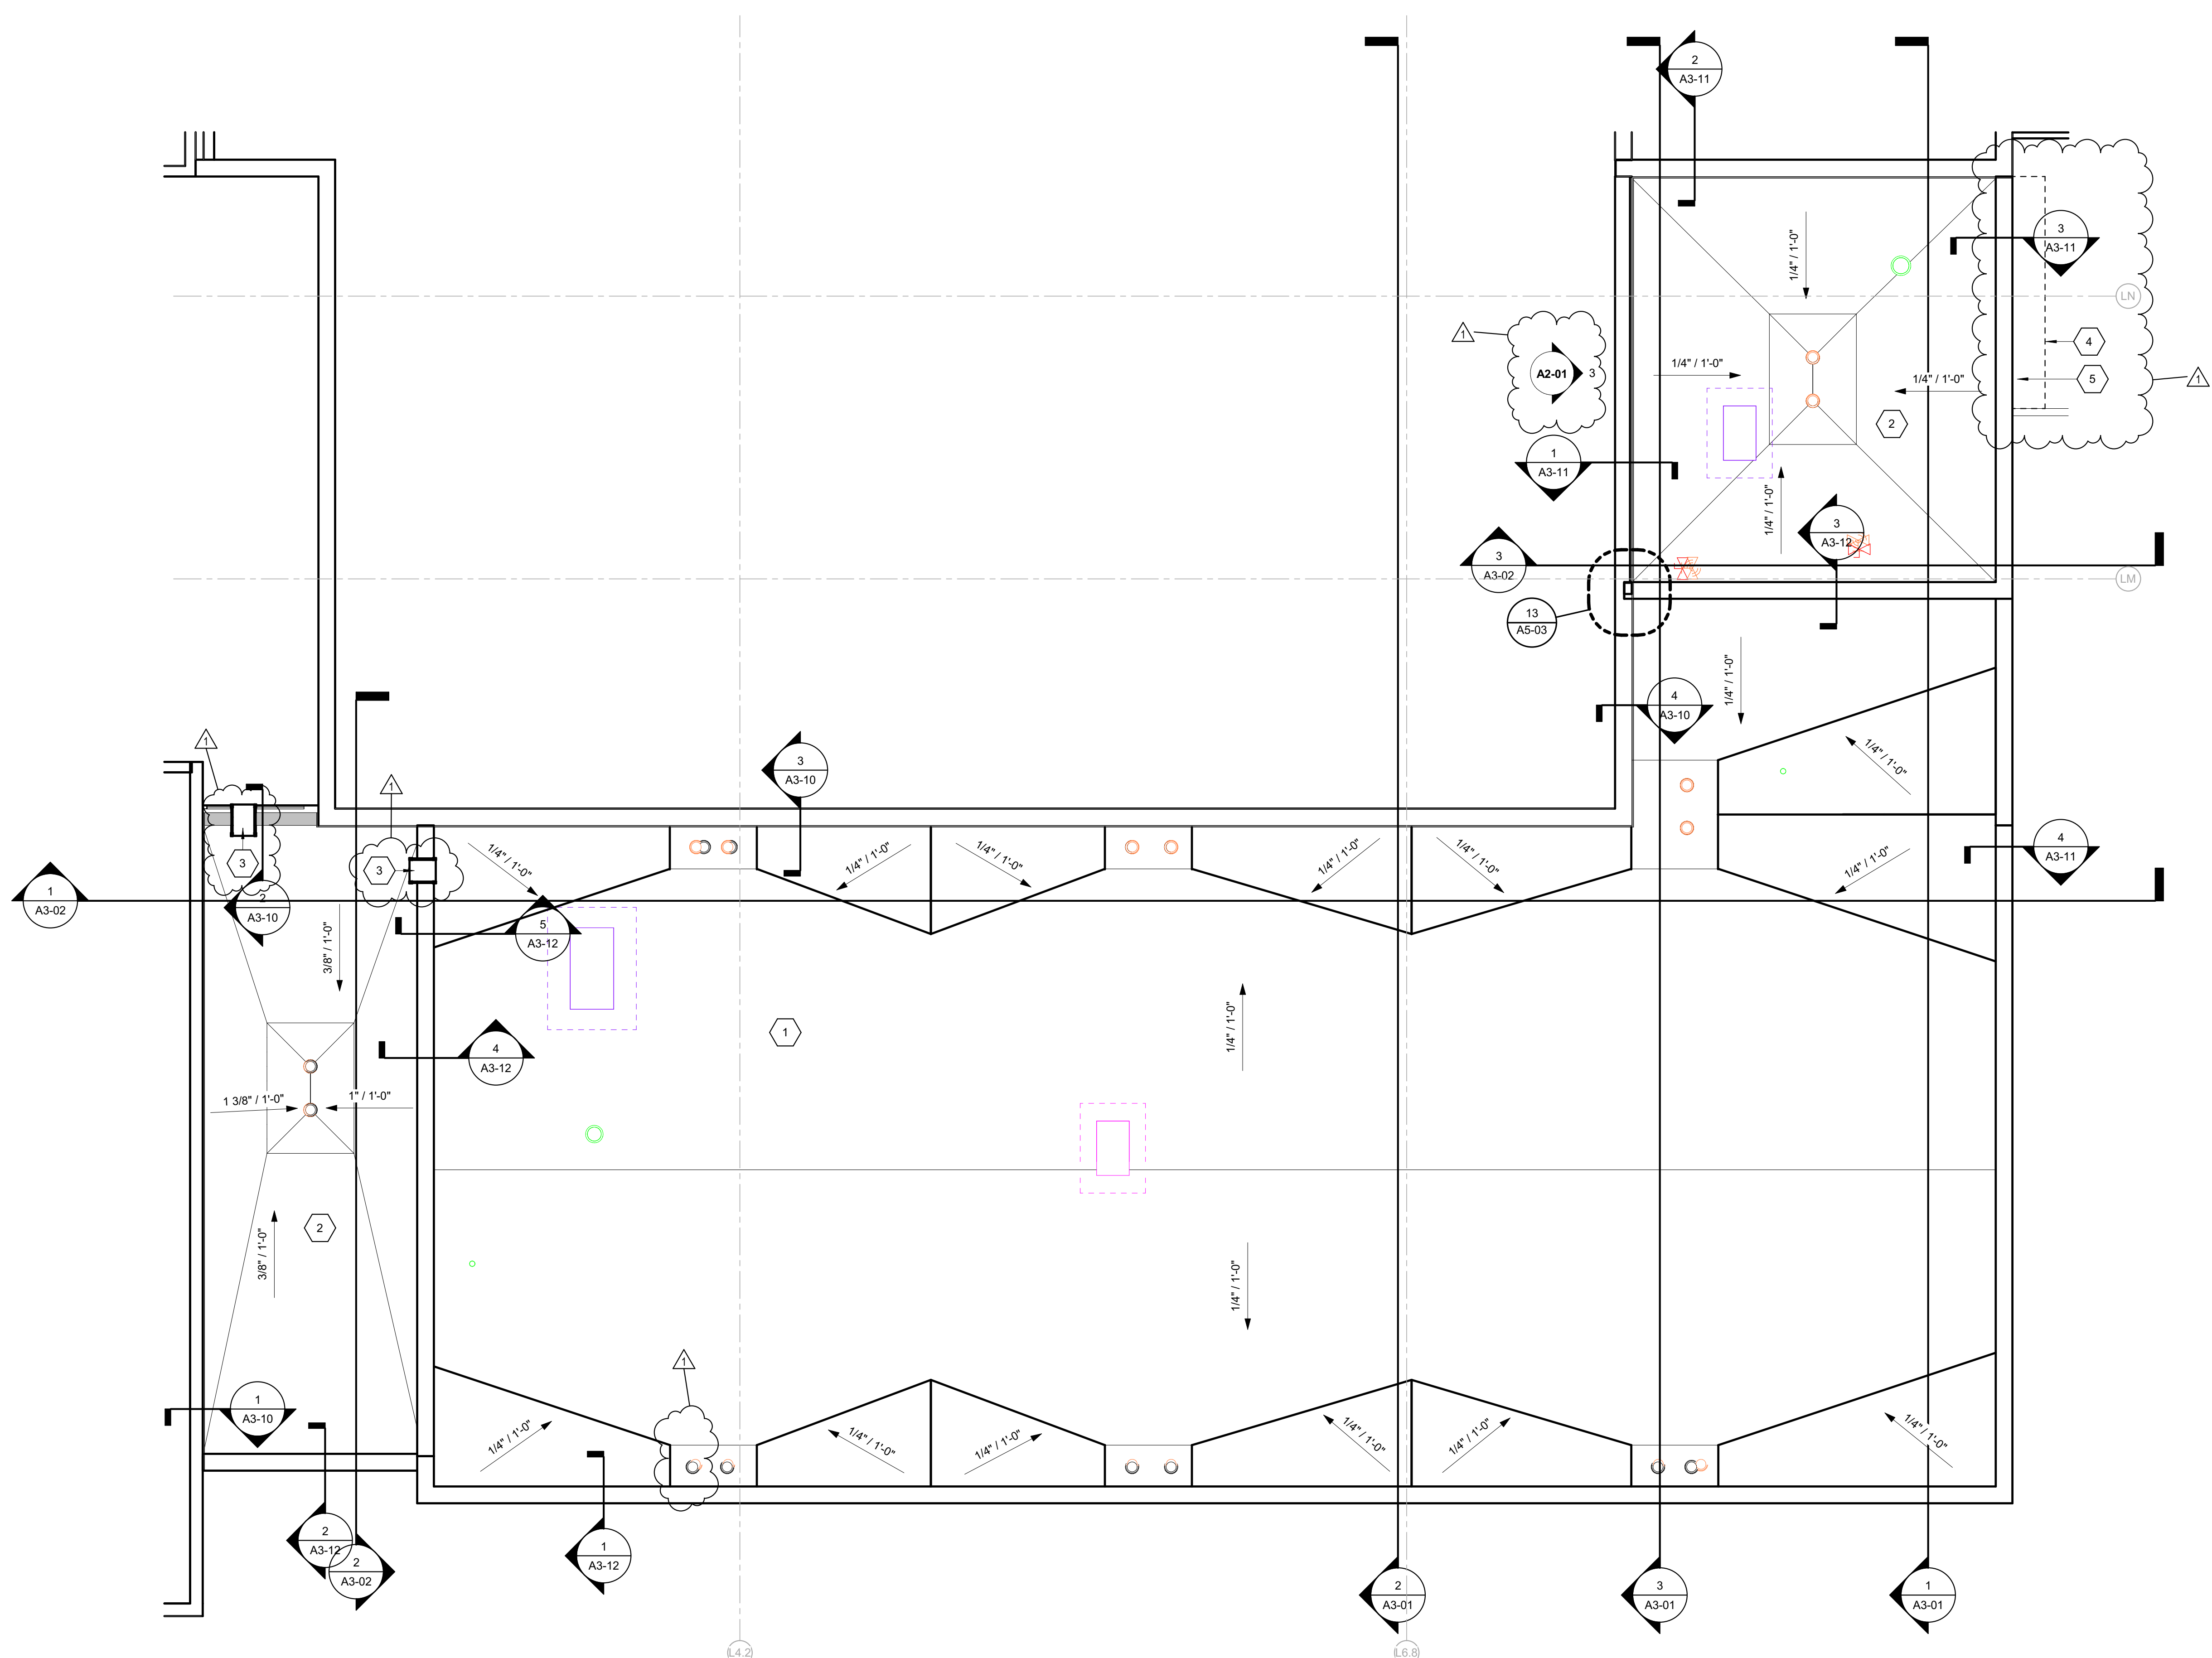

**ROOF PLAN LEGEND**

- INDICATES ROOF DRAIN (RD) AND OVERFLOW DRAIN (OD). (FLASH IN ACCORDANCE WITH ROOF MEMBRANE MANUFACTURER'S RECOMMENDATION). REFER TO DETAIL 7-A2.??
- INDICATES VENT STACK - REFER TO PLUMBING DRAWINGS AND 7-A2.??
- INDICATES FLUE - REFER TO MECHANICAL DRAWINGS AND 7-A2.??
- INDICATES MECHANICAL EQUIPMENT - REFER TO MECHANICAL DRAWINGS AND 7-A2.??
- INDICATES ROOF SLOPE
- INDICATES ROOF SADDLE - REFER TO PROJECT MANUAL.
- INDICATES EXPANSION JOINT - REFER TO ROOF PLAN AND WALL SECTIONS.
- INDICATES WALL LINE BELOW - REFER TO ARCHITECTURAL FLOOR PLANS
- INDICATES METAL DOWNSPOUT. REFER TO ROOF PLAN AND BUILDING ELEVATIONS FOR LOCATIONS
- INDICATES WALKWAY PADS - REFER TO PROJECT MANUAL.
- INDICATES ICE AND WATER SHIELD MEMBRANE FLASHING - REFER TO PROJECT MANUAL.

**VERIFICATION NOTE**

CONTRACTOR SHALL VERIFY ALL DIMENSIONS AND CLEARANCES AND ALL EXISTING FIELD CONDITIONS BEFORE STARTING CONSTRUCTION. COMMENCEMENT OF WORK CONSTITUTES ACCEPTANCE OF CONDITIONS.  
SHOULD DIFFERENT CONDITIONS BE ENCOUNTERED, CONTACT THE ARCHITECT BEFORE PROCEEDING WITH WORK.

**1 ARCHITECTURAL ROOF PLAN**  
SCALE: 1/8" = 1'-0"

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**ZIONSVILLE COMMUNITY HIGH SCHOOL ATHLETIC LOCKER ROOMS ADDITION AND RENOVATION**

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 ZIONSVILLE, IN 46077


ZIONSVILLE COMMUNITY SCHOOLS



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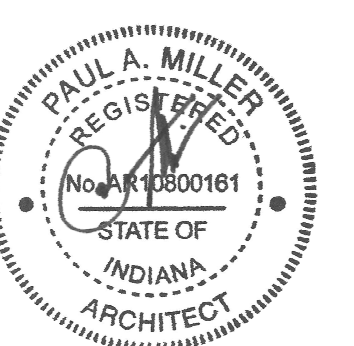


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KEY PLAN

ISSUED FOR BID

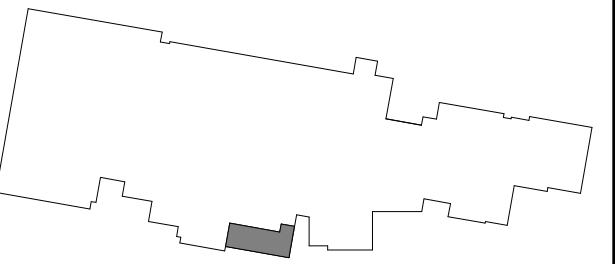


PROJECT MANAGER: JM  
 DRAWN BY: Author  
 PROJECT NUMBER: 224018.00  
 PROJECT ISSUE DATE: 01/21/2025

REV. NO.	DESCRIPTION	DATE
1	ADDENDUM #1	02/11/2025

**VERIFICATION NOTE**  
 CONTRACTOR SHALL VERIFY ALL DIMENSIONS AND CLEARANCES AND ALL EXISTING FIELD CONDITIONS BEFORE STARTING CONSTRUCTION. COMMENCEMENT OF WORK CONSTITUTES ACCEPTANCE OF CONDITIONS.  
 SHOULD DIFFERENT CONDITIONS BE ENCOUNTERED, CONTACT THE ARCHITECT BEFORE PROCEEDING WITH WORK.

BUILDING SECTIONS


**A3-01**

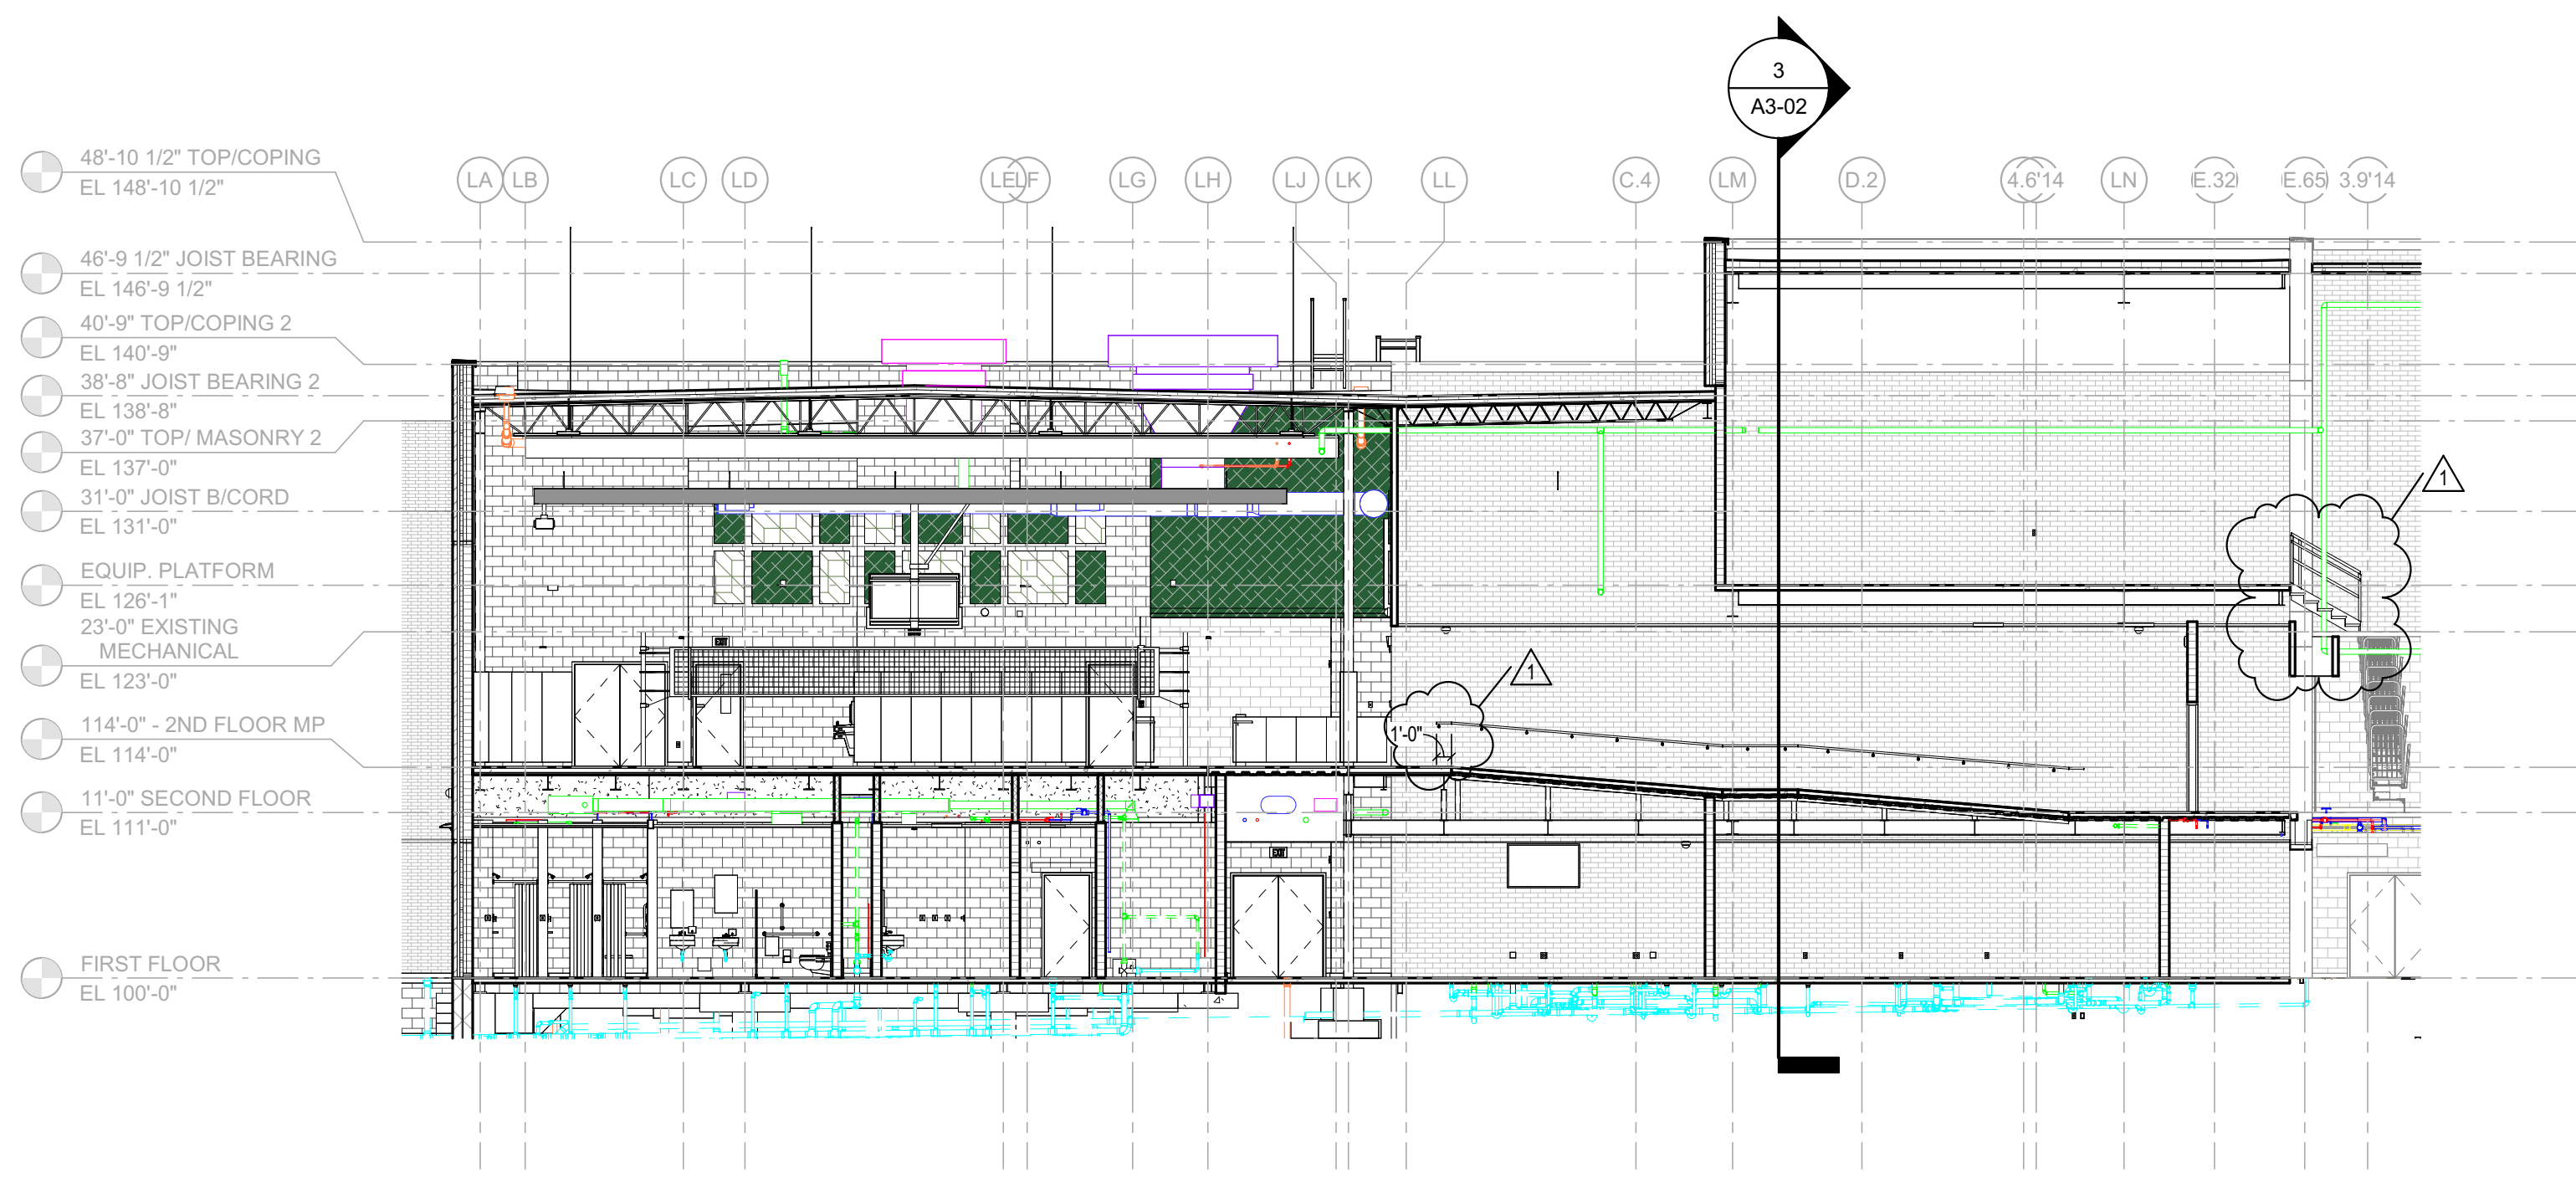

**3 BUILDING SECTION 3**  
 SCALE: 3/32" = 1'-0"



**2 BUILDING SECTION 2**  
 SCALE: 3/32" = 1'-0"

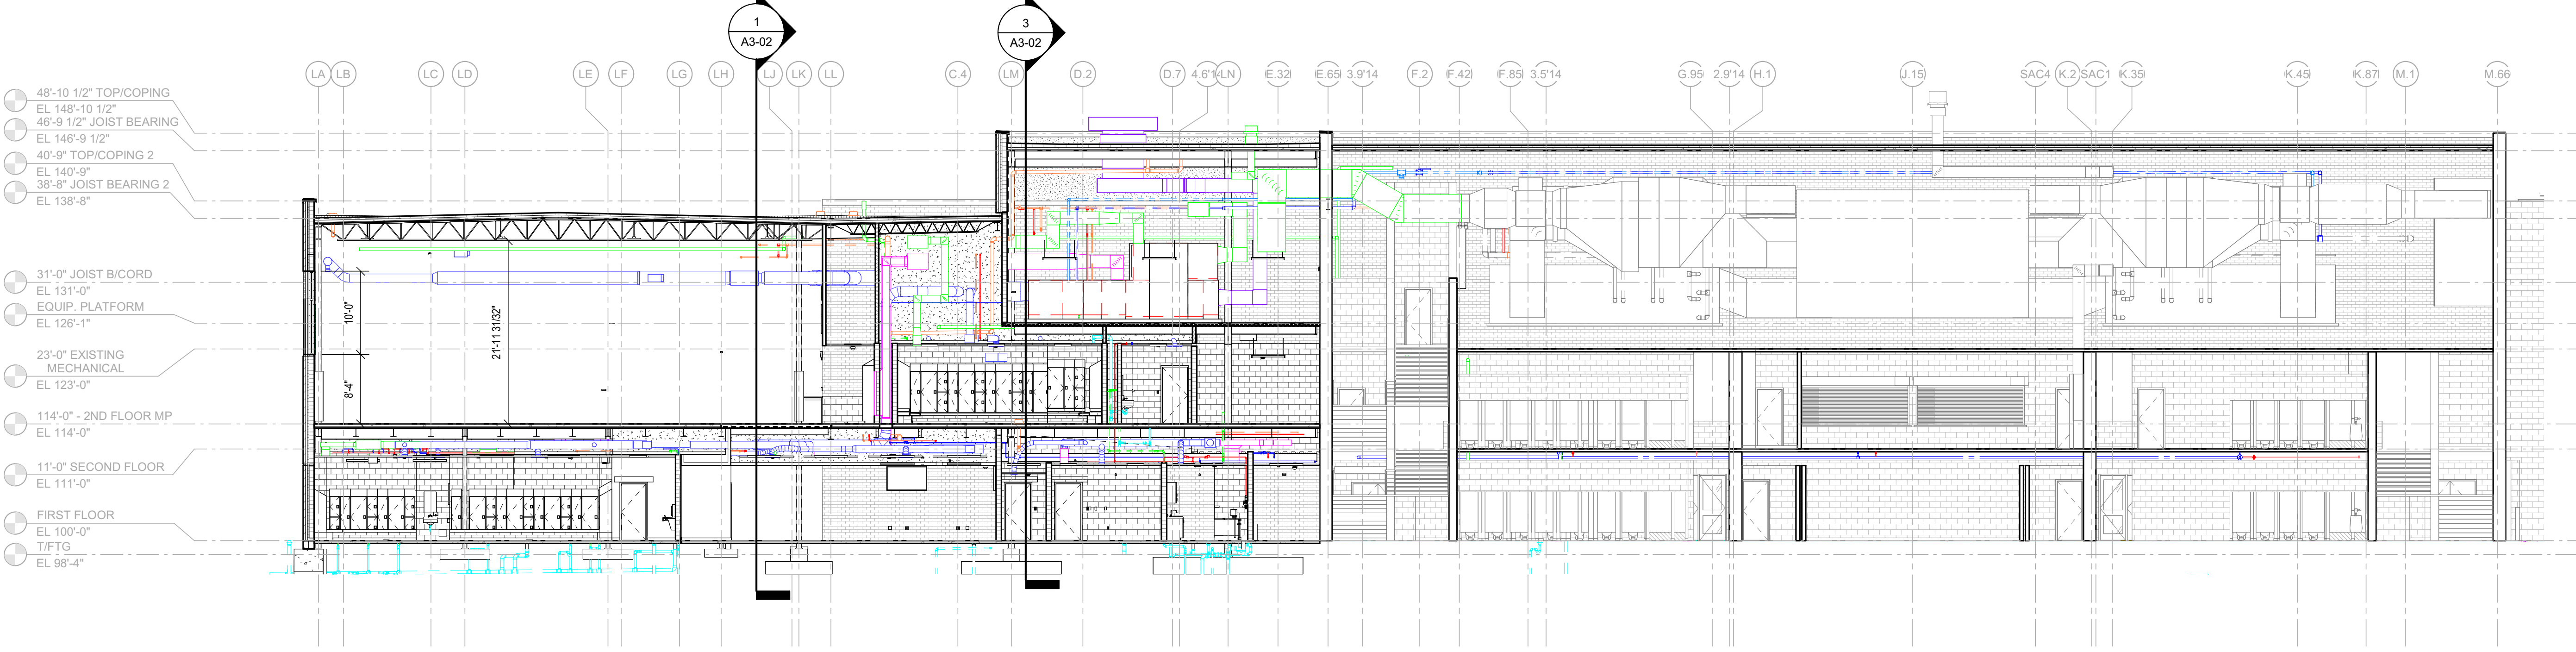

**1 BUILDING SECTION 1**  
 SCALE: 3/32" = 1'-0"

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(ALL NOTES MAY NOT BE INDICATED ON THIS SHEET)

BUILDING ELEVATION NOTES

(ALL NOTES MAY NOT BE INDICATED ON THIS SHEET)

- 1 FACE BRICK - COLOR C
- 2 FACE BRICK - COLOR A
- 3 BRICK BAND - COLOR B
- 4 METAL COPING
- 5 BRICK EXPANSION JOINT - REFER TO STAILS ON SHEET A5-02
- 6 ALIGN NEW BRICK BAND WITH EXISTING BRICK BAND
- 7 EIFS PANEL - MATCH EXISTING COLOR AT MAIN ENTRANCE
- 8 BRICK - EXISTING WALL
- 9 EIFS - COLOR A
- 10 ALUMINUM LADDER
- 11 ADA PUSH BUTTON - REFER TO ELECTRICAL DRAWINGS
- 12 BUILDING EXPANSION JOINT WITH PERFORMED JOINT SEALS
- 13 EXISTING CANOPY AND VESTIBULE CONSTRUCTION
- 14 BRICK BAND - COLOR B - CONTINUING VERTICAL, 1/3 BRICK WIDE CUT AT EACH ROW TO MAINTAIN BRICK BOND WITH OTHER BRICK
- 15 ALUMINUM FIXED LOUVER - FINISH COLOR TO MATCH ADJACENT BRICK
- 16 REINSTALL EXISTING COPING AFTER REINSTALLATION OF CANOPY STRUCTURE
- 17 PROVIDE NEW COLD FORMED METAL FRAMING AND EIFS FACADE IN THE AREA WHERE EXISTING CANOPY IS REMOVED SIMILAR TO DETAIL 02A3-12D
- 18 METAL COPING AT EIFS
- 19 EIFS

# ZIONSVILLE COMMUNITY HIGH SCHOOL ATHLETIC LOCKER ROOMS ADDITION AND RENOVATION

1000 MULBERRY STREET,  
ZIONSVILLE, IN 46077


ZIONSVILLE COMMUNITY SCHOOLS




ARCHITECT



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900 MULBERRY ST. ZIONSVILLE, IN 46077

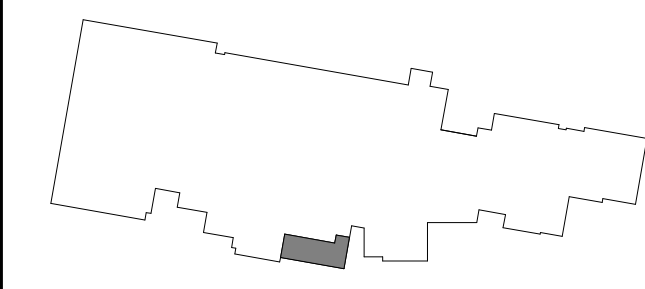

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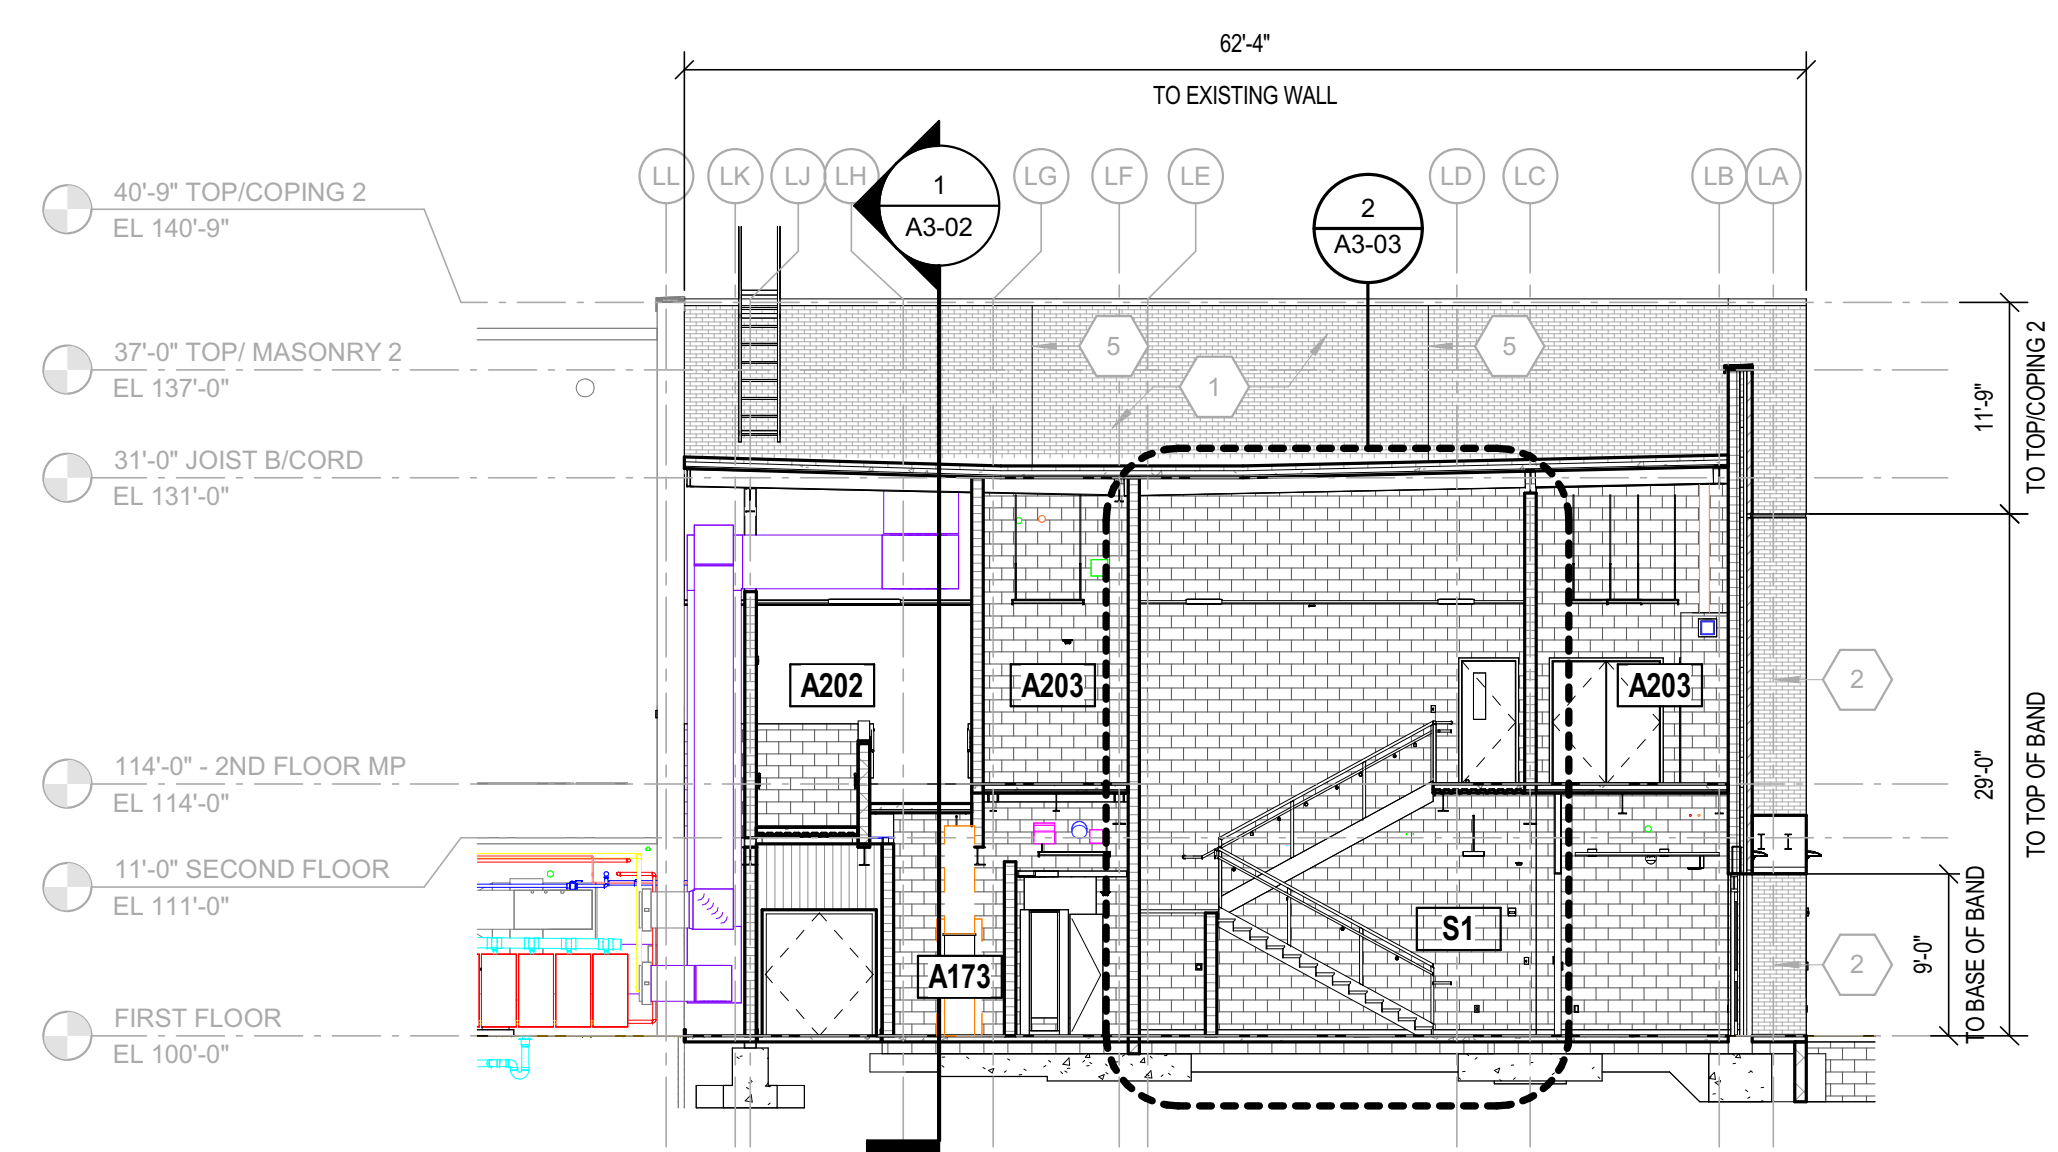
PROJECT MANAGER: JM  
DRAWN BY: Author  
PROJECT NUMBER: 224018.00  
PROJECT ISSUE DATE: 01/21/2025

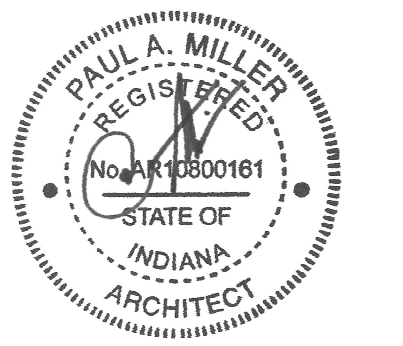REV. NO.	DESCRIPTION	DATE
1	ADDENDUM #1	02/11/2025


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SHOULD DIFFERENT CONDITIONS BE ENCOUNTERED, CONTACT THE ARCHITECT BEFORE PROCEEDING WITH WORK.

BUILDING SECTIONS


## A3-02



**2** BUILDING SECTION 5  
SCALE: 3/32" = 1'-0"

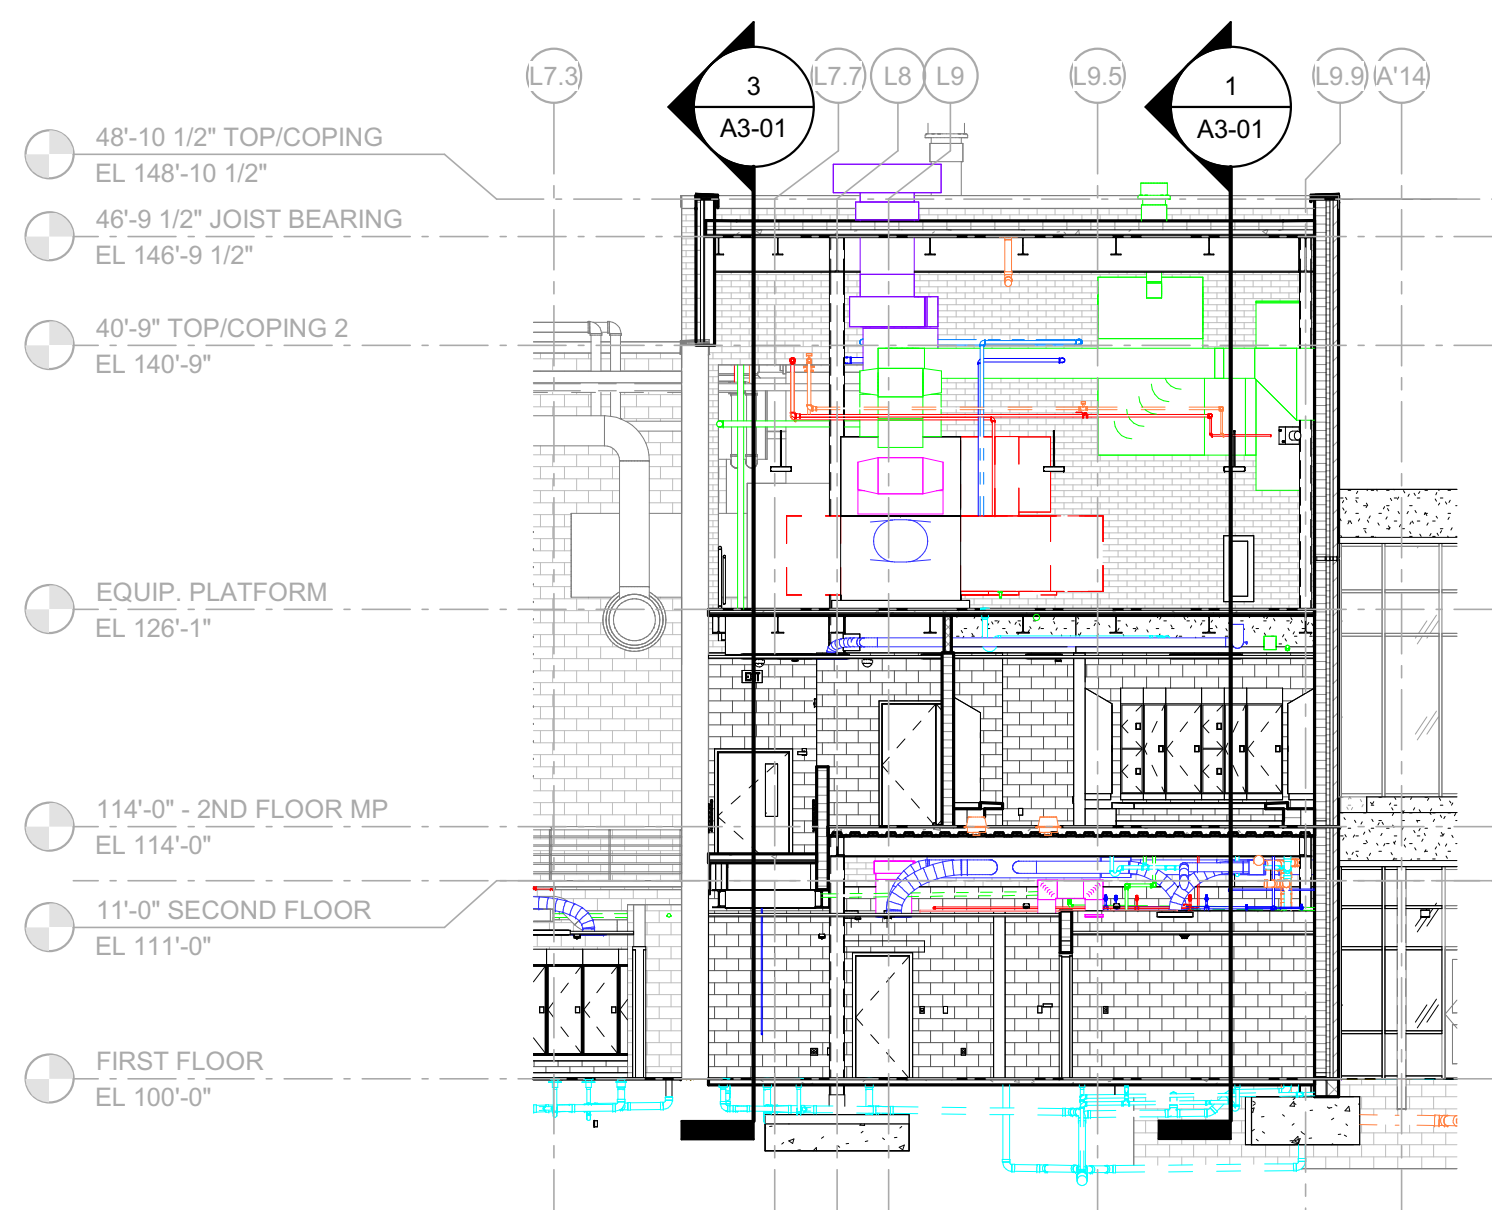

**3** BUILDING SECTION 6  
SCALE: 3/32" = 1'-0"

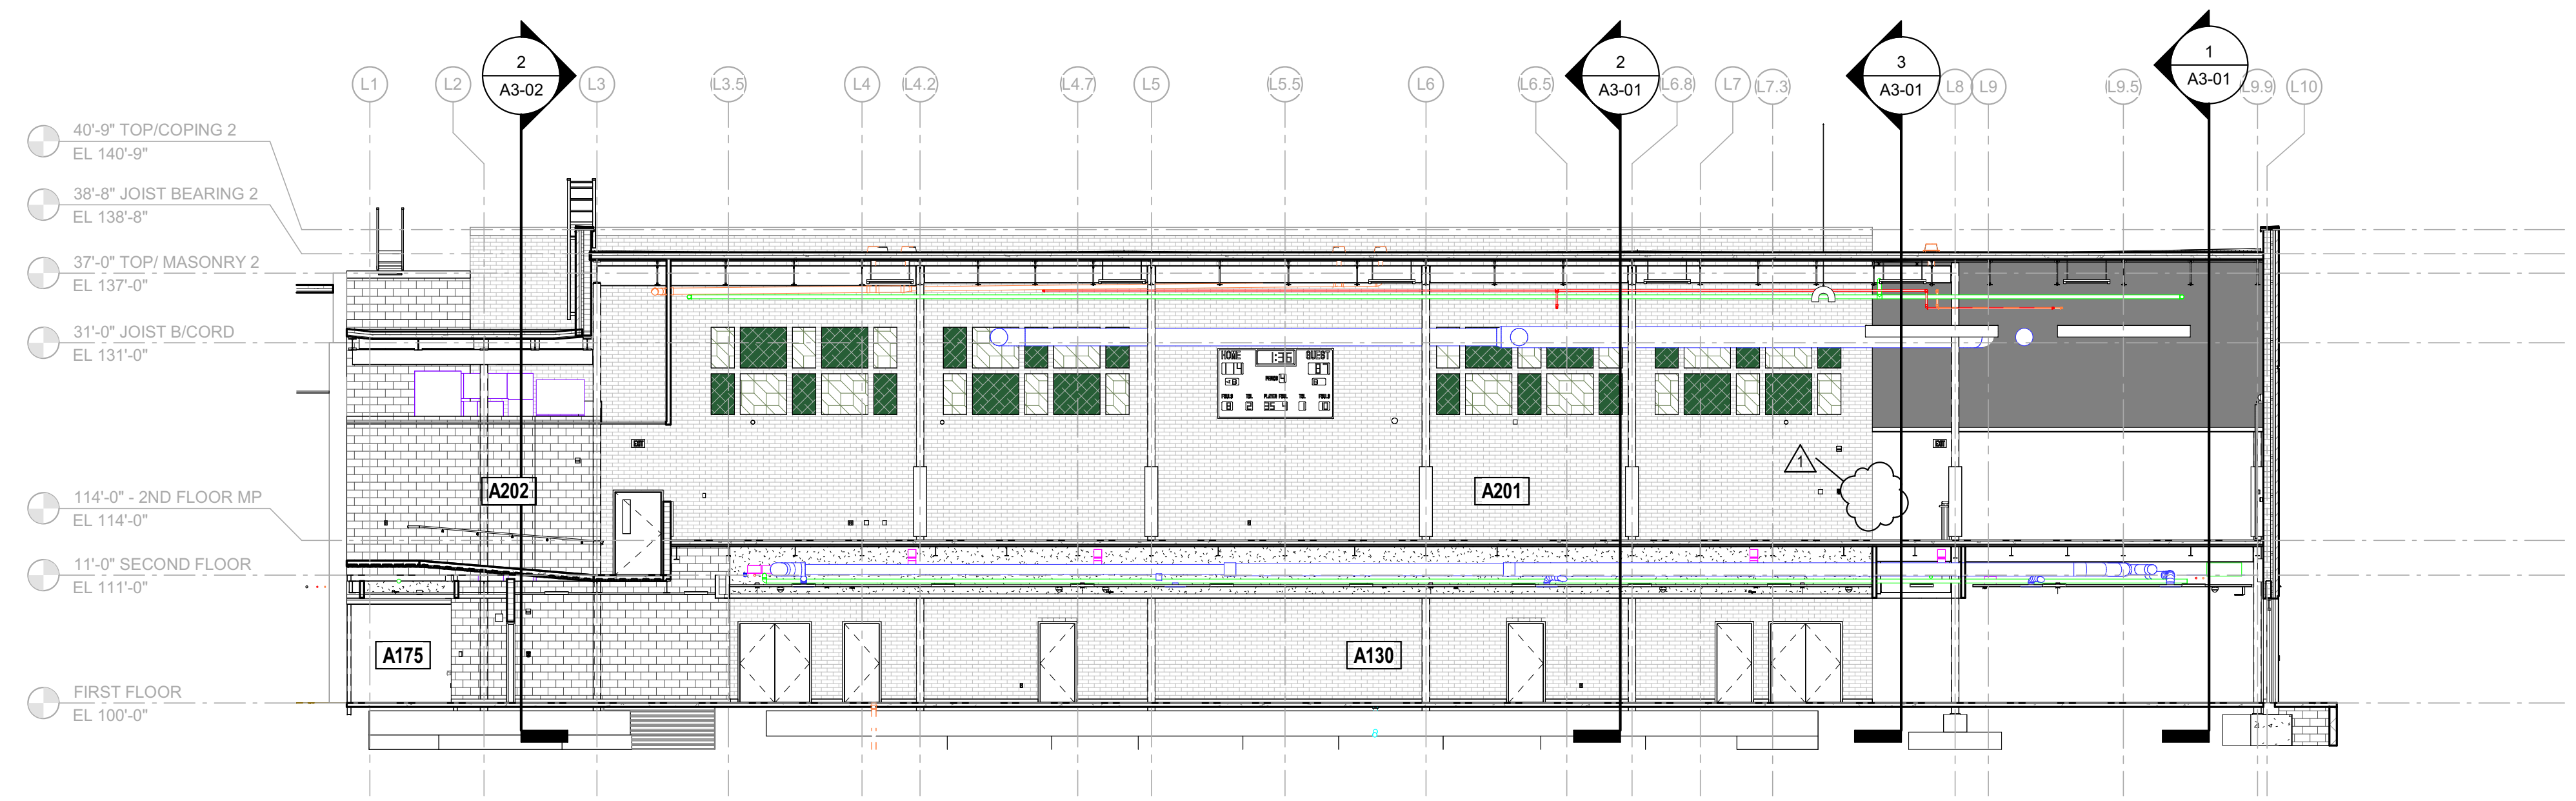

**1** BUILDING SECTION 4  
SCALE: 3/32" = 1'-0"

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# ZIONSVILLE COMMUNITY HIGH SCHOOL ATHLETIC LOCKER ROOMS ADDITION AND RENOVATION

1000 MULBERRY STREET,  
ZIONSVILLE, IN 46077

ZIONSVILLE COMMUNITY SCHOOLS



ARCHITECT




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KEY PLAN

ISSUED FOR BID




PROJECT MANAGER: JM  
DRAWN BY: Author  
PROJECT NUMBER: 224018.00  
PROJECT ISSUE DATE: 01/21/2025

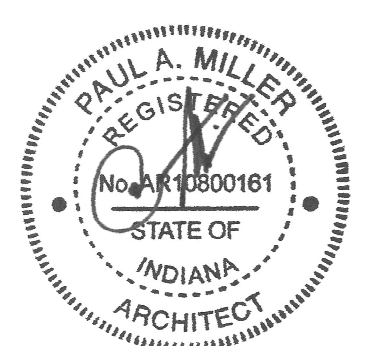
REV. NO.	DESCRIPTION	DATE
1	ADDENDUM #1	02/11/2025

VERTICAL CIRCULATION

## A3-03

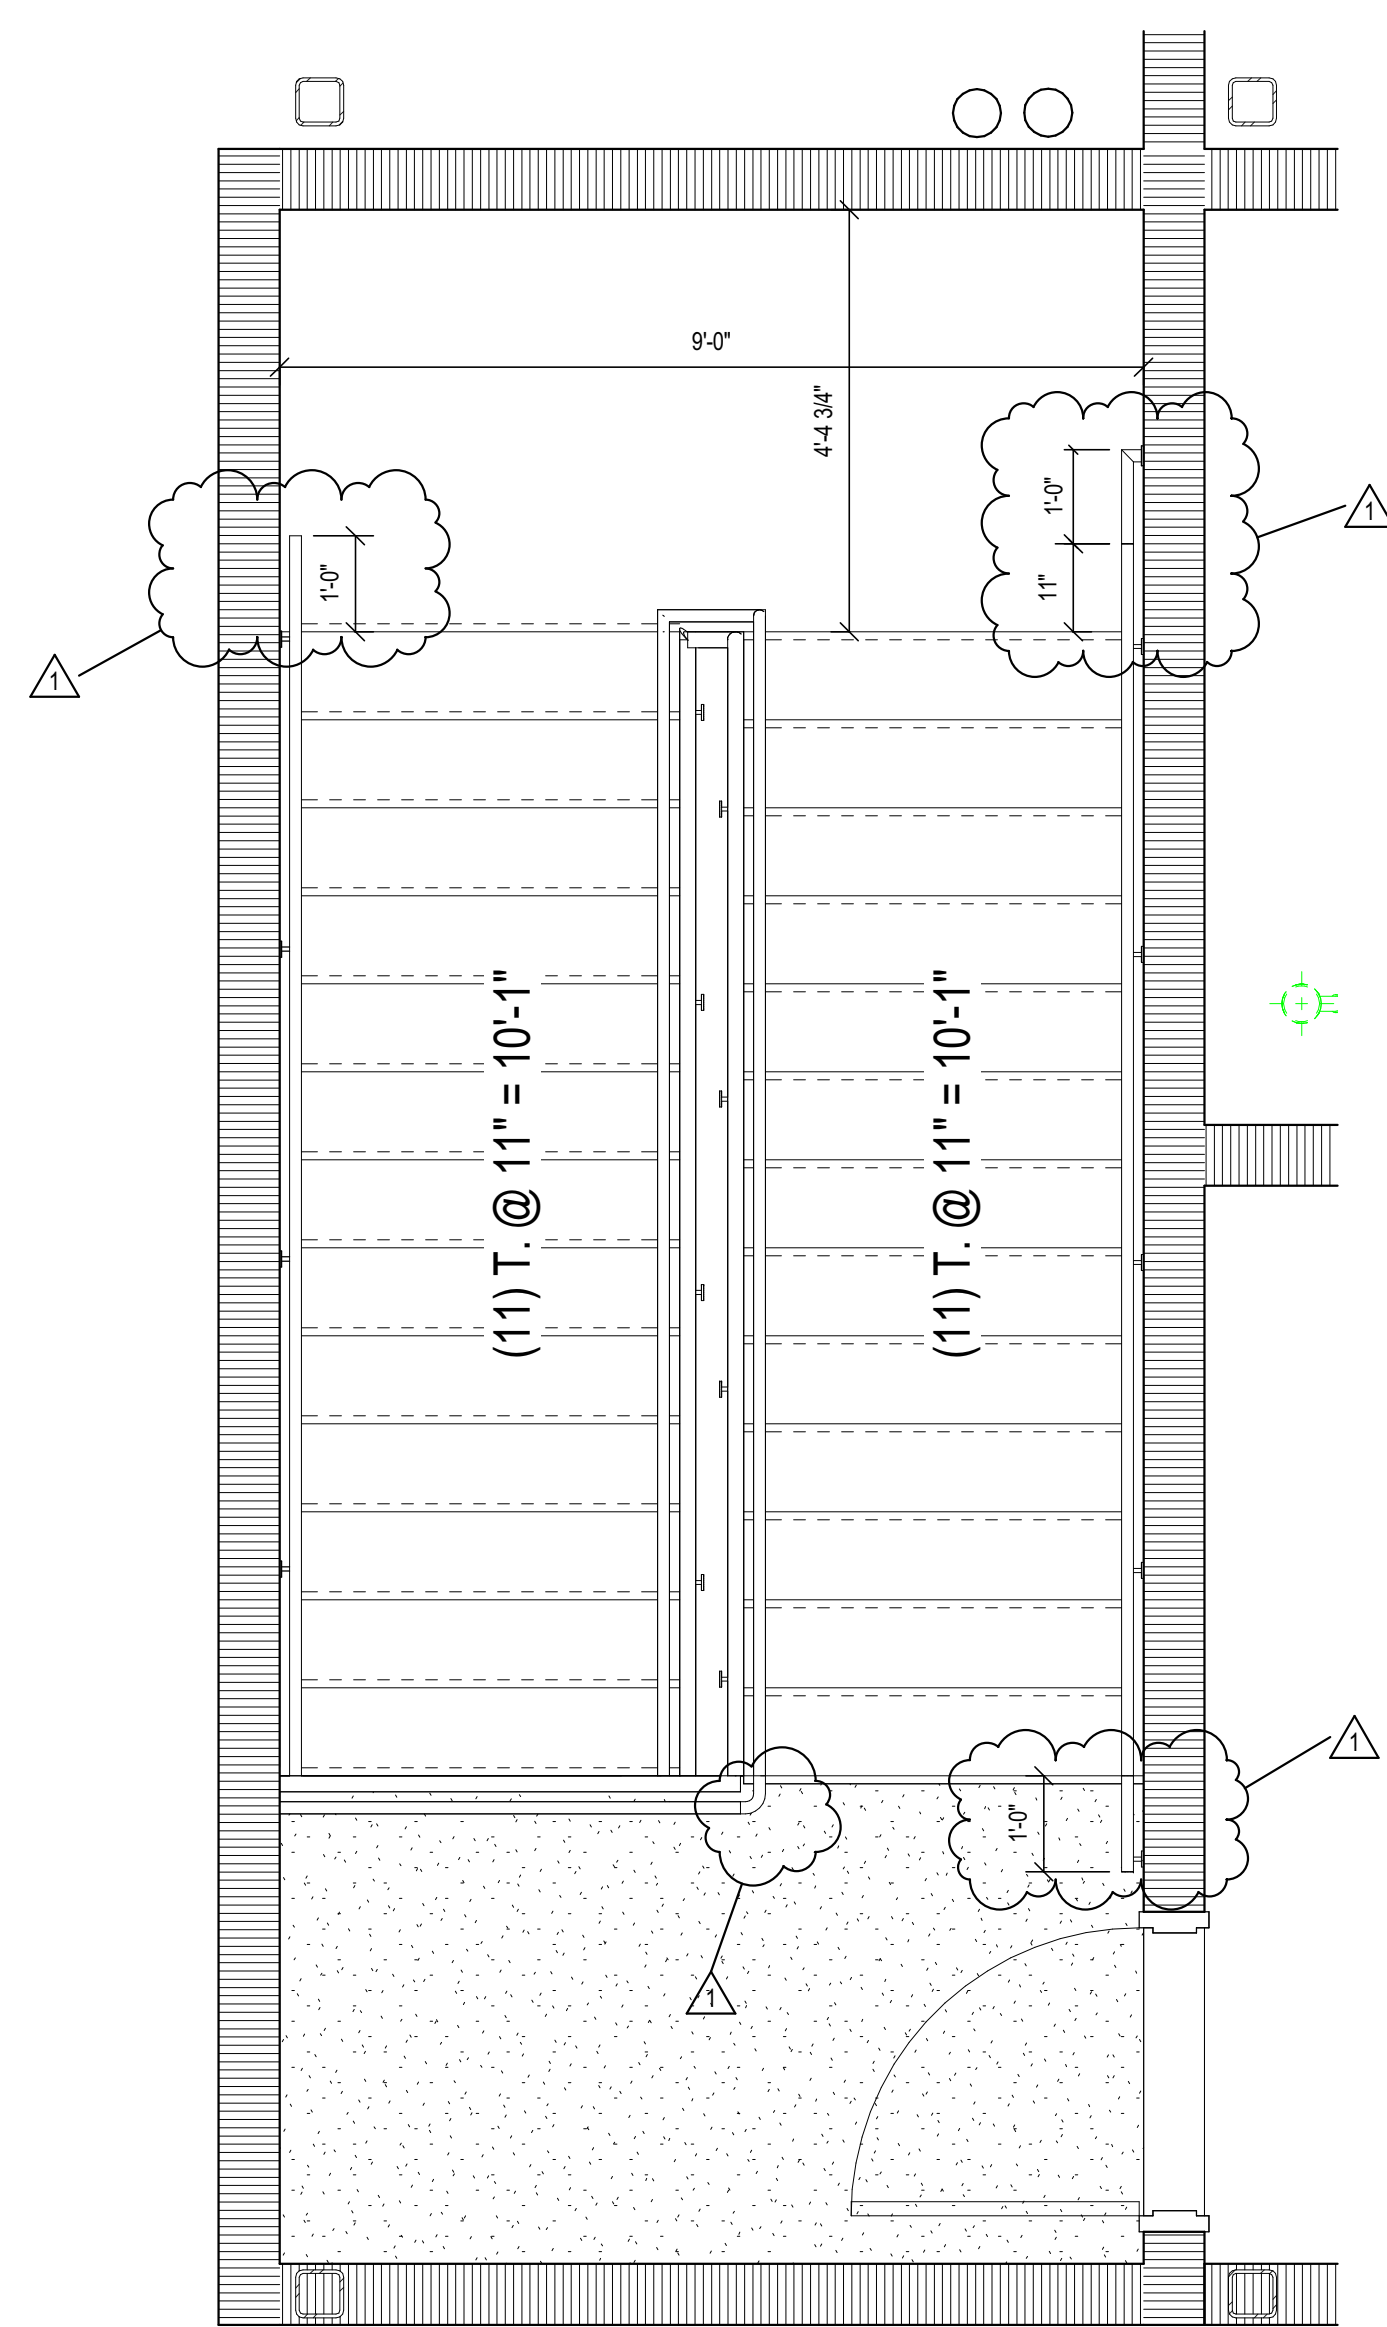

**1 S1 - EAST STAIRCASE**  
SCALE: 1/2" = 1'-0"

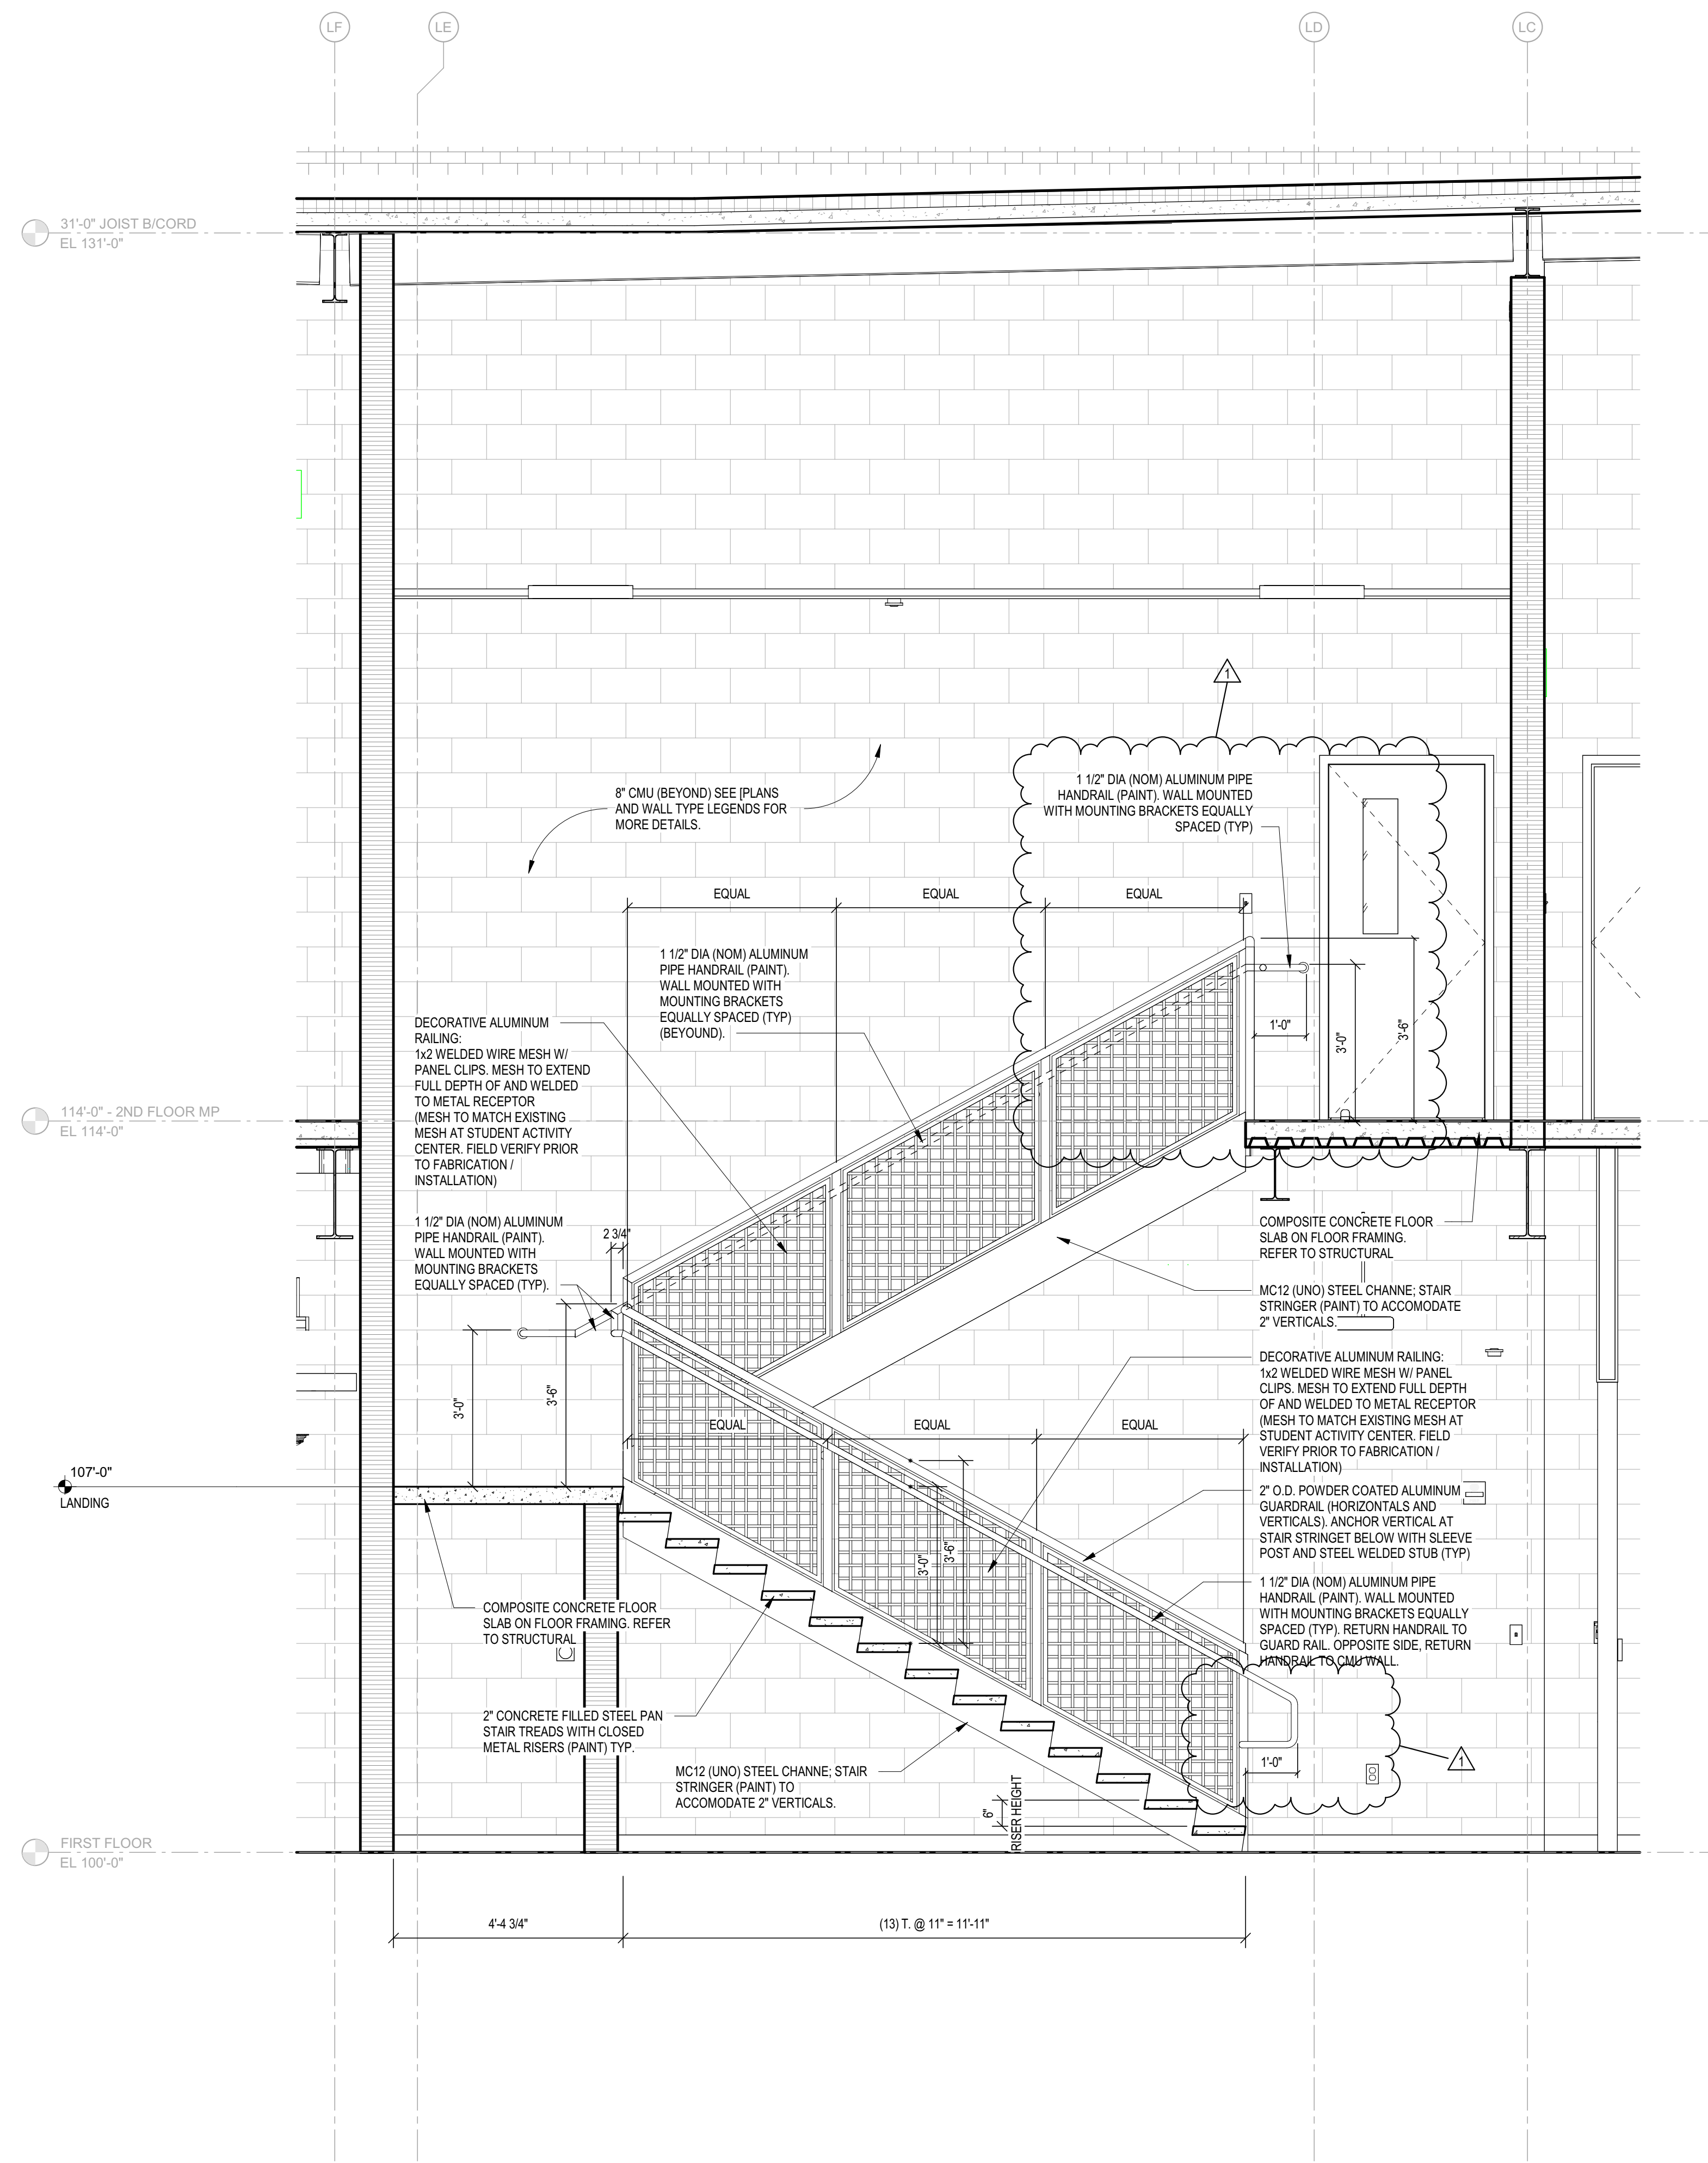

**2 STAIR SECTION**  
SCALE: 1/2" = 1'-0"







# ZIONSVILLE COMMUNITY HIGH SCHOOL ATHLETIC LOCKER ROOMS ADDITION AND RENOVATION

1000 MULBERRY STREET,  
ZIONSVILLE, IN 46077

ZIONSVILLE COMMUNITY SCHOOLS



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KEY PLAN

ISSUED FOR BID




PROJECT MANAGER: JM  
DRAWN BY: Author  
PROJECT NUMBER: 224018.00  
PROJECT ISSUE DATE: 01/21/2025


REV. NO.	DESCRIPTION	DATE
1	ADDENDUM #1	02/11/2025

VERTICAL CIRCULATION

**A3-05**

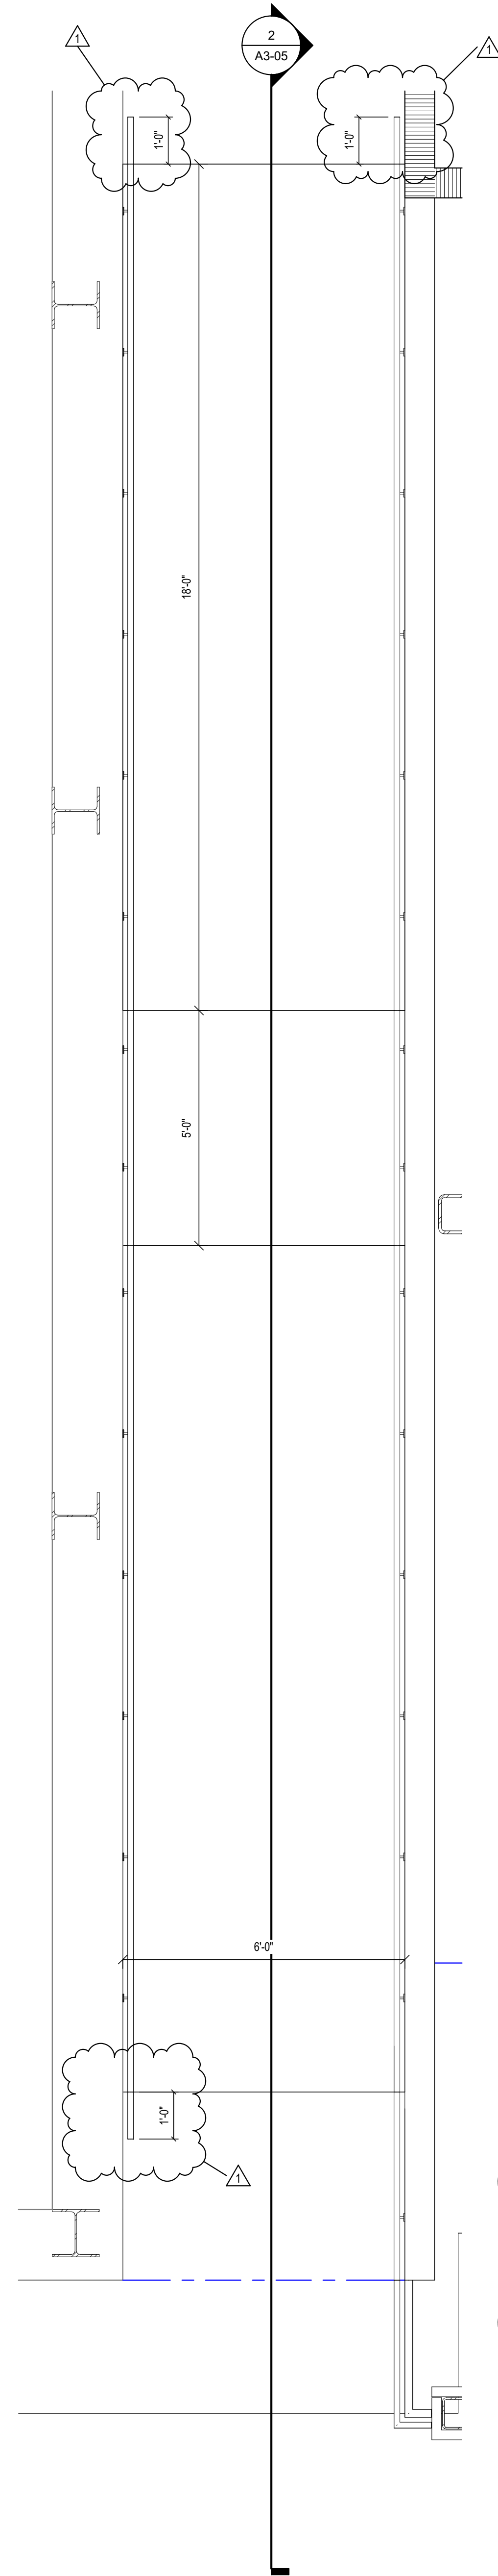

**1 A205 - RAMP ENLARGED PLAN**  
SCALE: 1/2" = 1'-0"

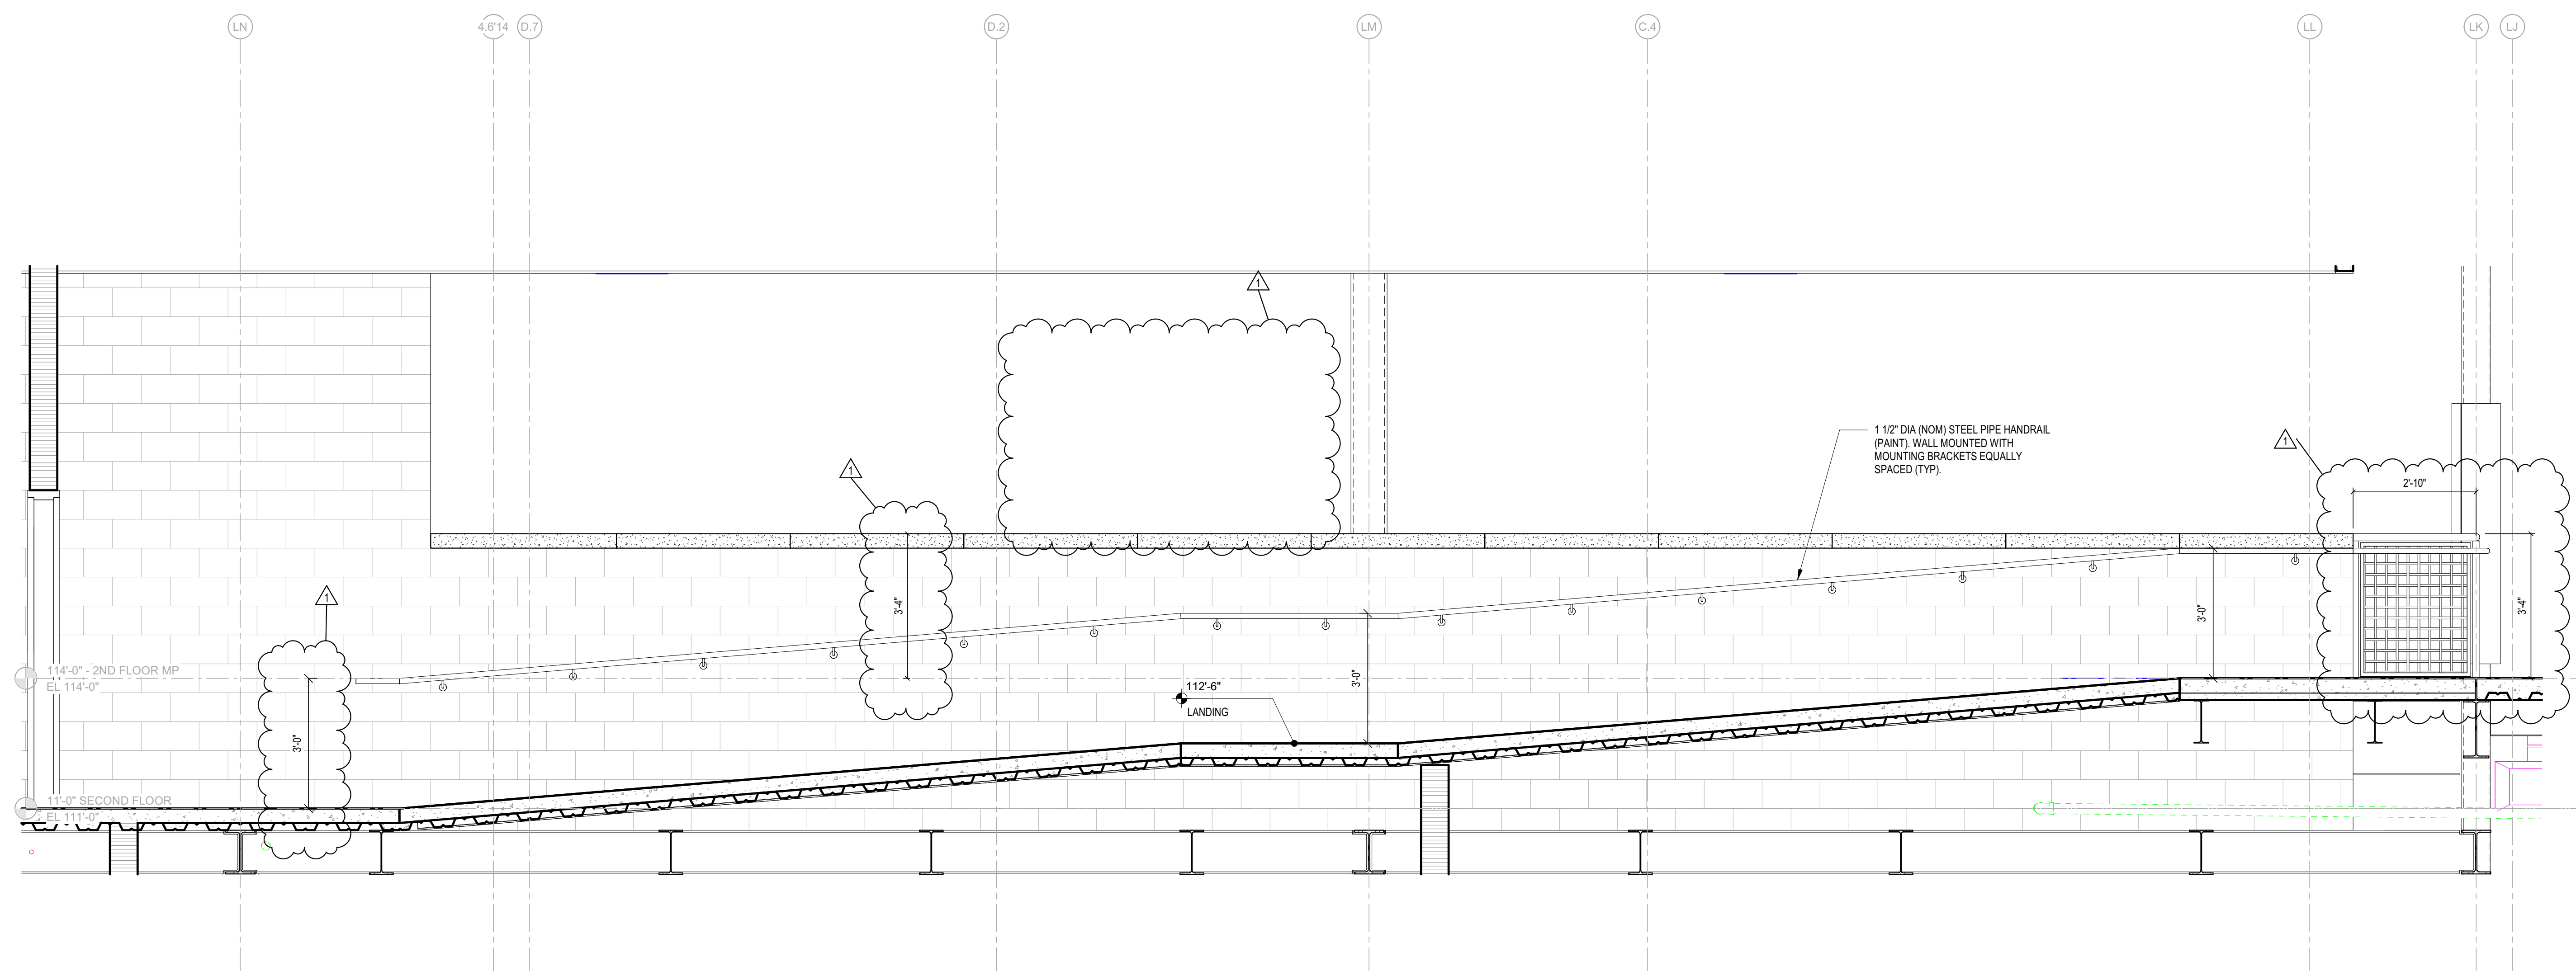

**2 Section 28**  
SCALE: 1/2" = 1'-0"



# ZIONSVILLE COMMUNITY HIGH SCHOOL ATHLETIC LOCKER ROOMS ADDITION AND RENOVATION

1000 MULBERRY STREET,  
ZIONSVILLE, IN 46077

ZIONSVILLE COMMUNITY SCHOOLS




ZIONSVILLE COMMUNITY SCHOOLS

ARCHITECT




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KEY PLAN
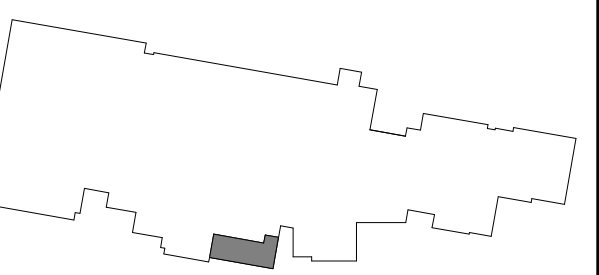
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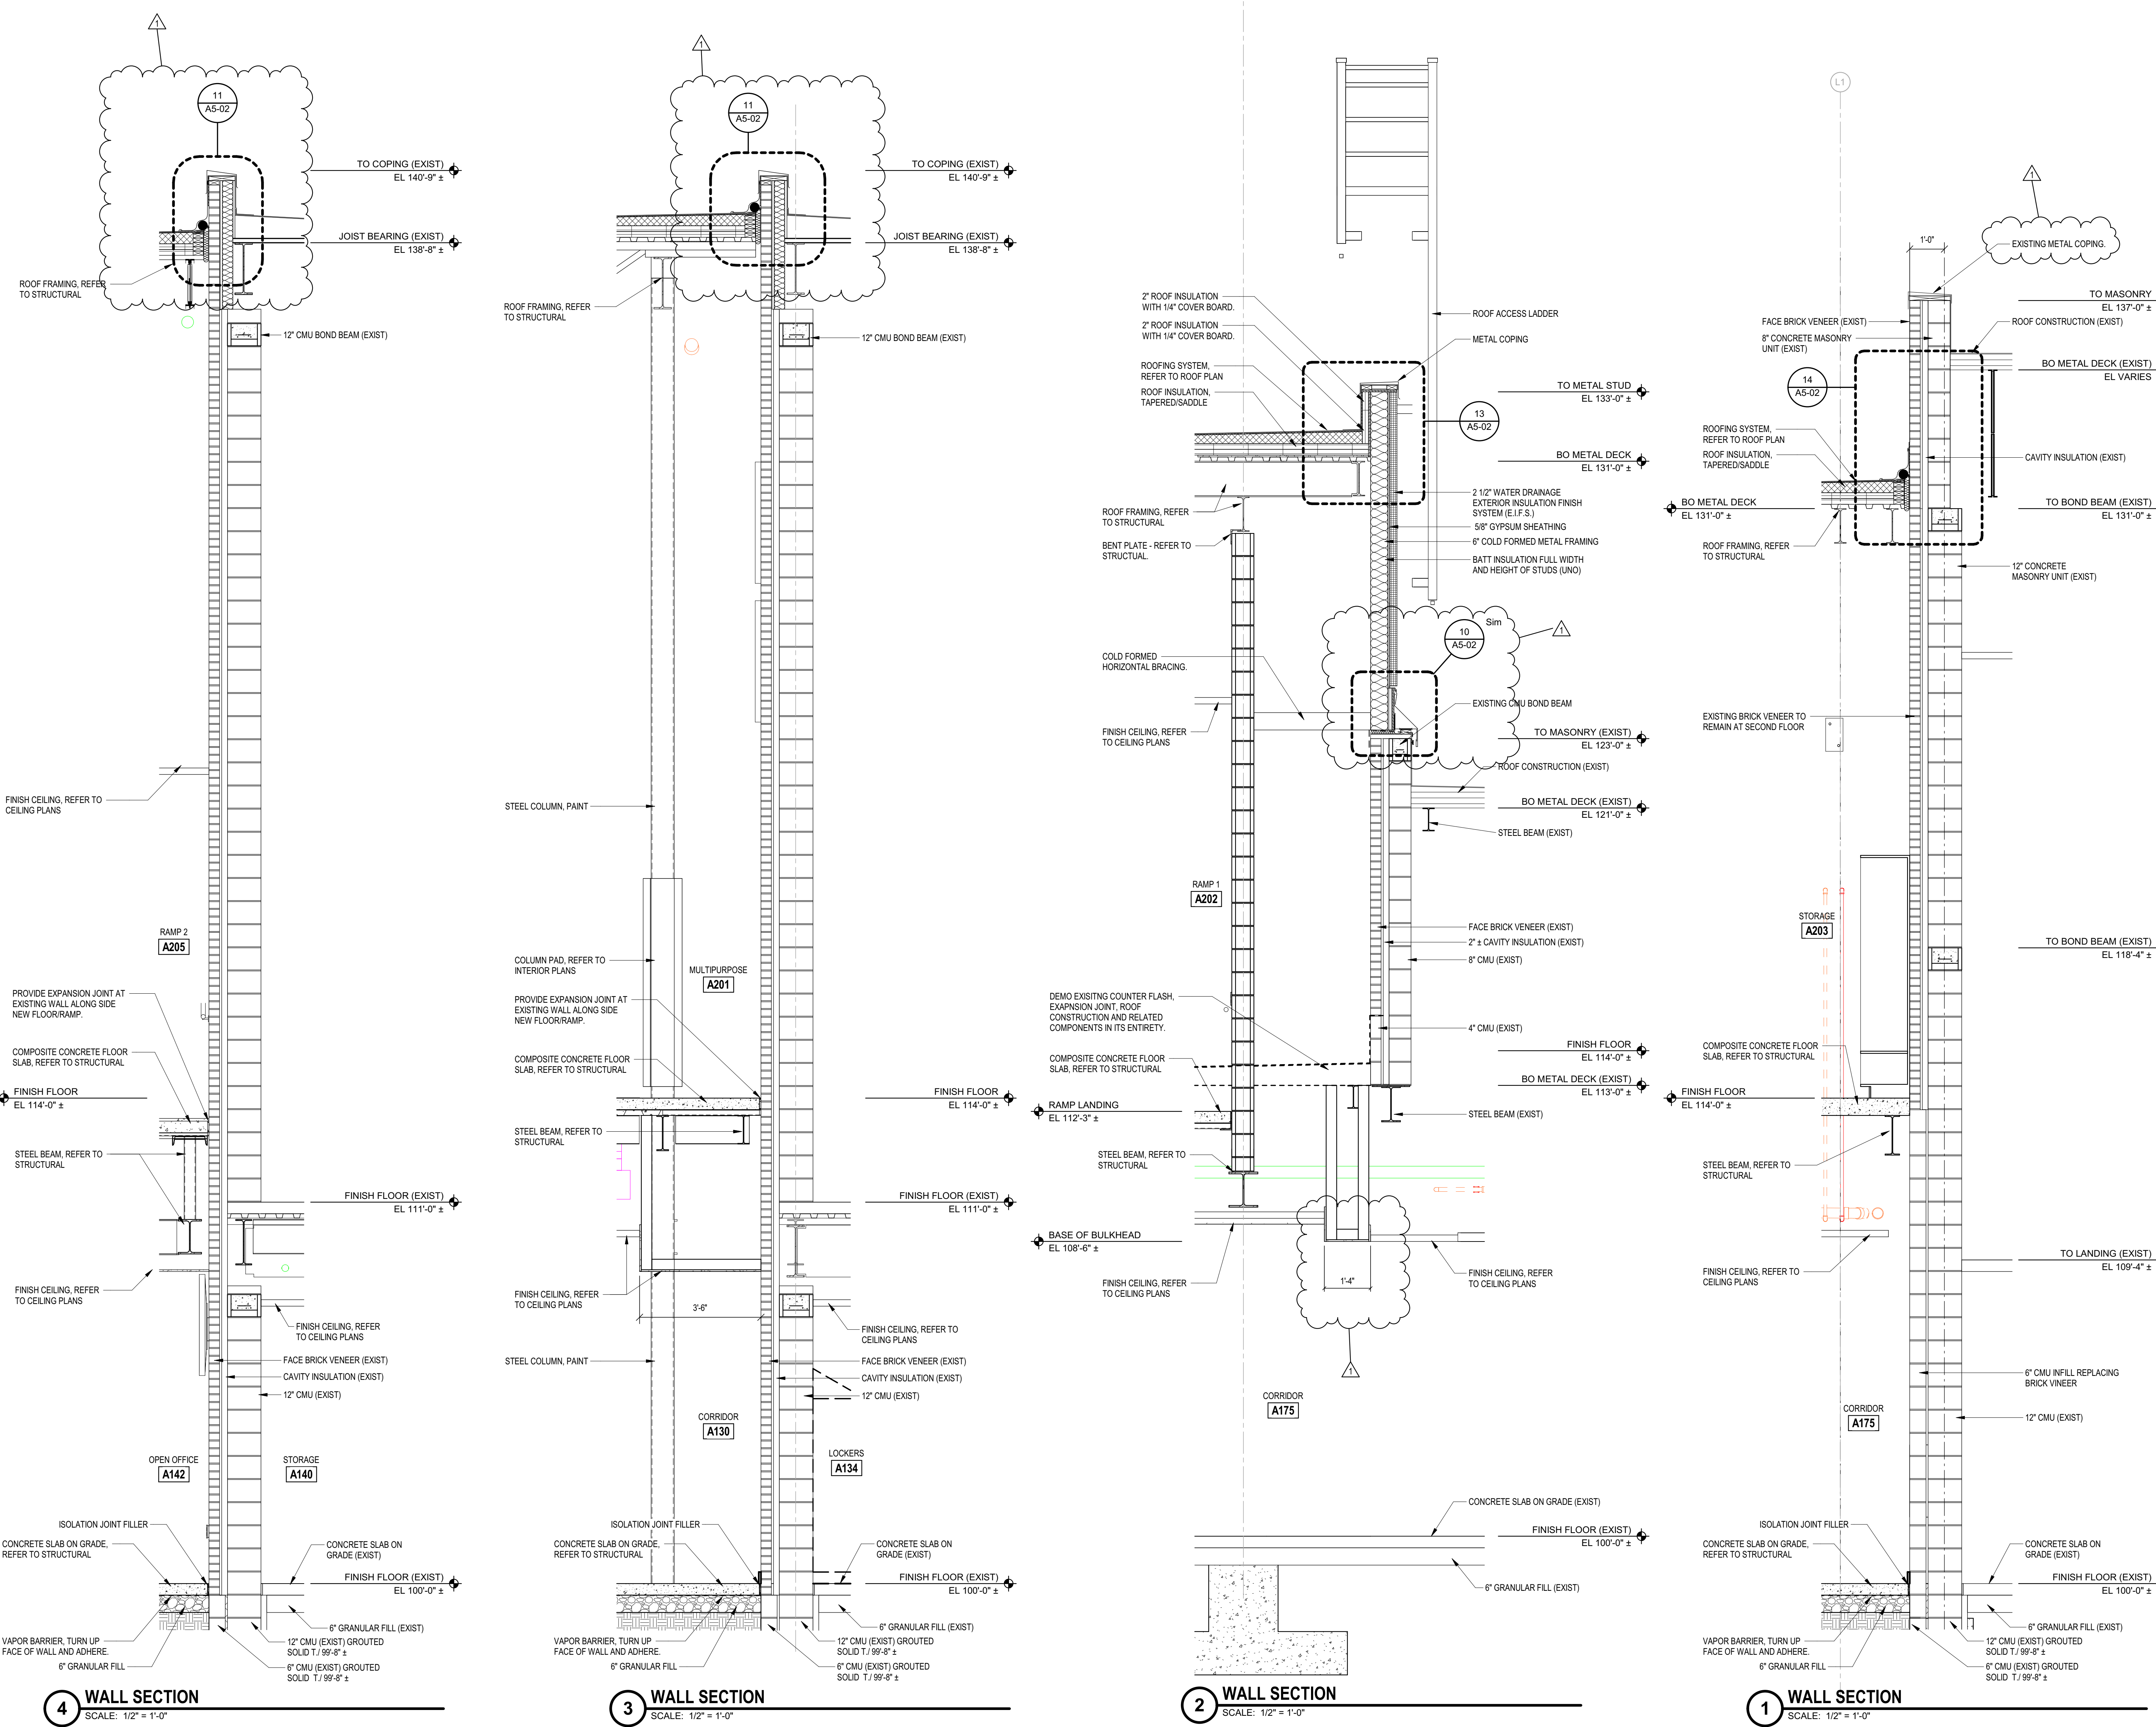


PROJECT MANAGER: JM  
DRAWN BY: BMD  
PROJECT NUMBER: 224018.00  
PROJECT ISSUE DATE: 01/21/2025

REV. NO.	DESCRIPTION	DATE
1	ADDENDUM #1	02/11/2025

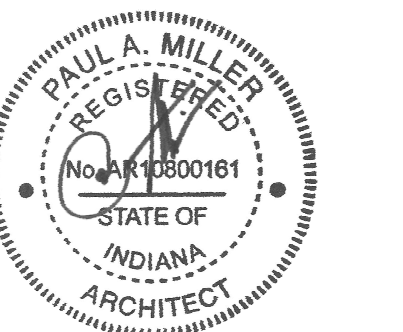- GENERAL NOTES**
- A. COORDINATE ALL LINTEL AND BOND BEAM REQUIREMENTS WITH STRUCTURAL DRAWINGS AND PROJECT MANUAL. REFER TO THE STRUCTURAL DRAWINGS FOR ALL FOUNDATION AND FOOTING CONDITIONS.
  - B. PROVIDE HORIZ. JOINT REINFORCING, TIES, AND OTHER ANCHORAGE/REINFORCEMENT ITEMS AS REQ'D. PER PROJECT MANUAL.
  - C. ROOF TO EXTERIOR WALL JUNCTIONS: REFER TO DIVISION 07 SECTION THERMAL INSULATION FOR SPRAY POLYURETHANE INSULATION REQUIRED AT THESE LOCATIONS.
  - D. WALL INSULATION PENETRATIONS: PROVIDE SPRAY POLYURETHANE INSULATION OR SEALANT AROUND ALL PENETRATIONS OF THE WALL INSULATION BY PIPING, CONDUITS, FRAMING, STRUCTURE, ETC.

**WALL SECTION NOTES**  
(ALL NOTES MAY NOT BE INDICATED ON THIS SHEET)



**VERIFICATION NOTE**  
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WALL SECTIONS

**A3-10**

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# ZIONSVILLE COMMUNITY HIGH SCHOOL ATHLETIC LOCKER ROOMS ADDITION AND RENOVATION

1000 MULBERRY STREET,  
ZIONSVILLE, IN 46077

ZIONSVILLE COMMUNITY SCHOOLS



ARCHITECT




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KEY PLAN

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PROJECT MANAGER: JM  
DRAWN BY: BMD  
PROJECT NUMBER: 224018.00  
PROJECT ISSUE DATE: 01/21/2025

REV. NO.	DESCRIPTION	DATE
1	ADDENDUM #1	02/11/2025

WALL SECTIONS
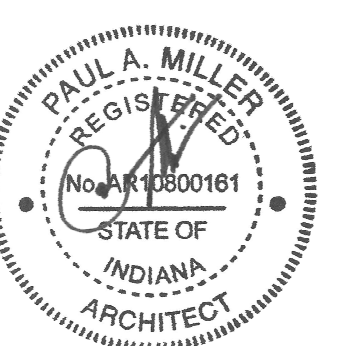
## A3-12

- GENERAL NOTES**
- COORDINATE ALL LINTEL AND BOND BEAM REQUIREMENTS WITH STRUCTURAL DRAWINGS AND PROJECT MANUAL. REFER TO THE STRUCTURAL DRAWINGS FOR ALL FOUNDATION AND FOOTING CONDITIONS.
  - PROVIDE HORIZ. JOINT REINFORCING, TIES, AND OTHER ANCHORAGE/REINFORCEMENT ITEMS AS REQ'D. PER PROJECT MANUAL.
  - ROOF TO EXTERIOR WALL JUNCTIONS: REFER TO DIVISION 07 SECTION "THERMAL INSULATION" FOR SPRAY POLYURETHANE INSULATION REQUIRED AT THESE LOCATIONS.
  - WALL INSULATION PENETRATIONS: PROVIDE SPRAY POLYURETHANE INSULATION OR SEALANT AROUND ALL PENETRATIONS OF THE WALL INSULATION BY PIPING, CONDUITS, FRAMING, STRUCTURE, ETC.


**WALL SECTION NOTES**

(ALL NOTES MAY NOT BE INDICATED ON THIS SHEET)


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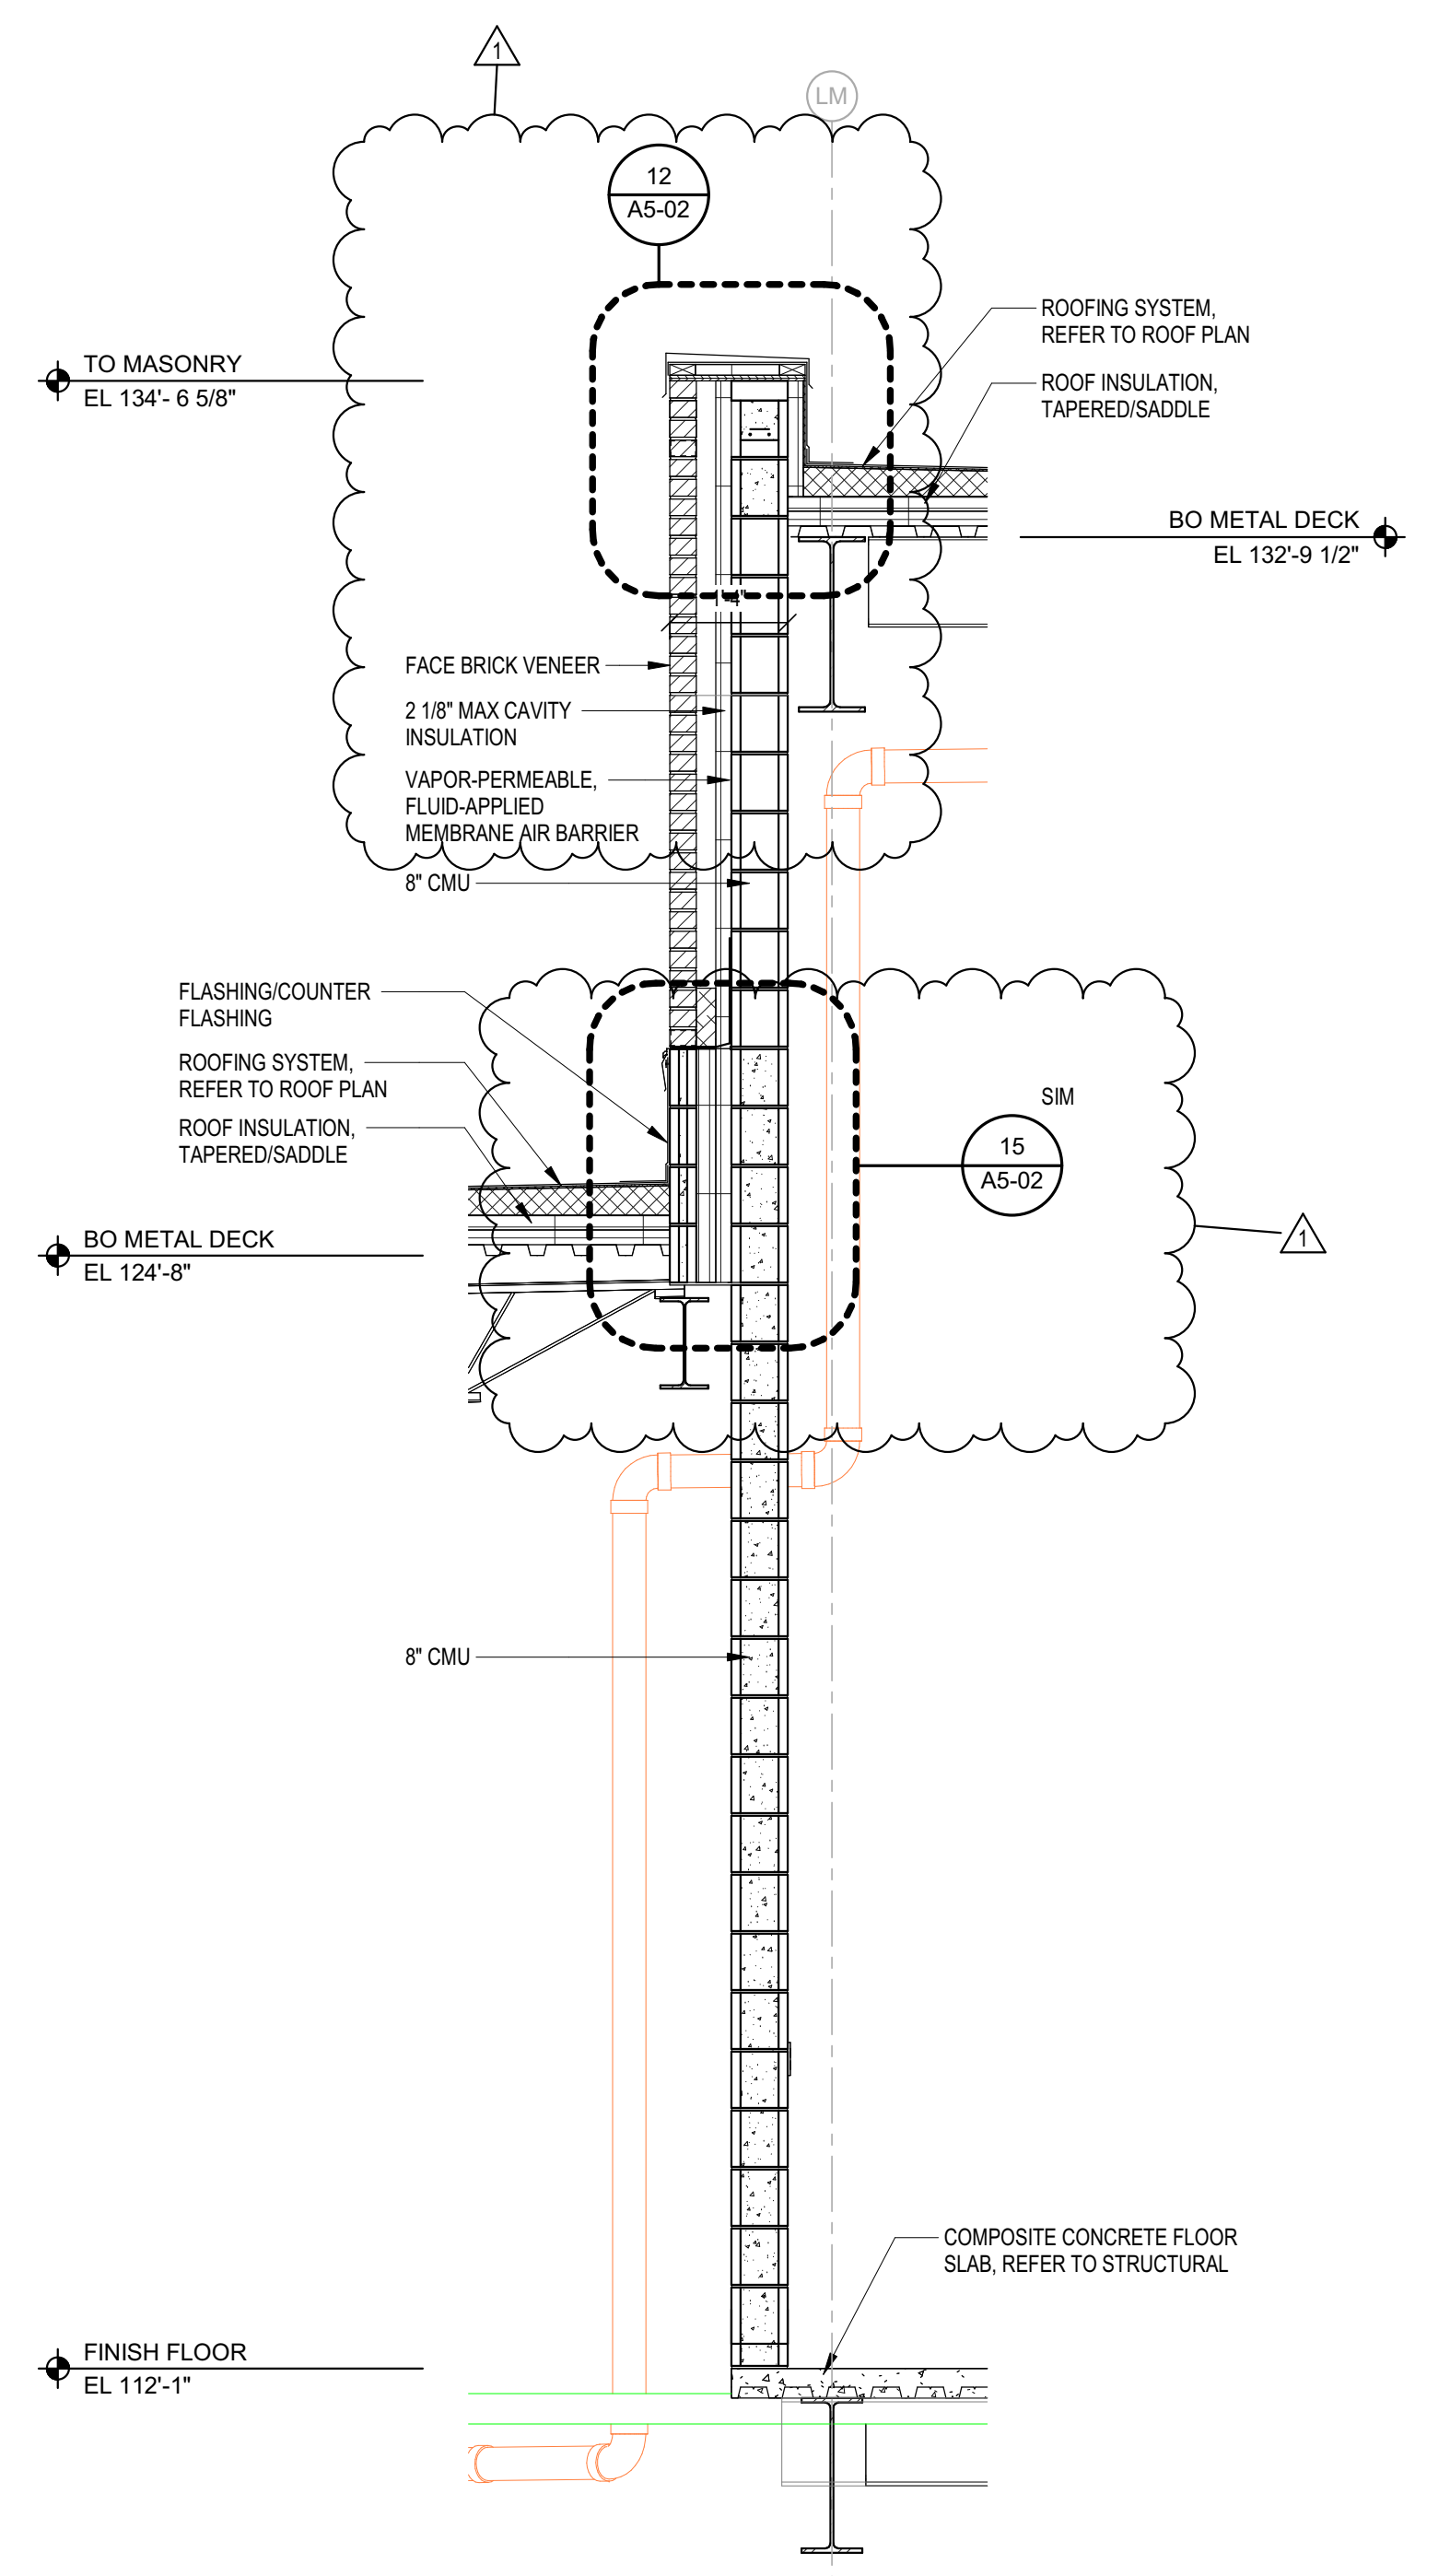
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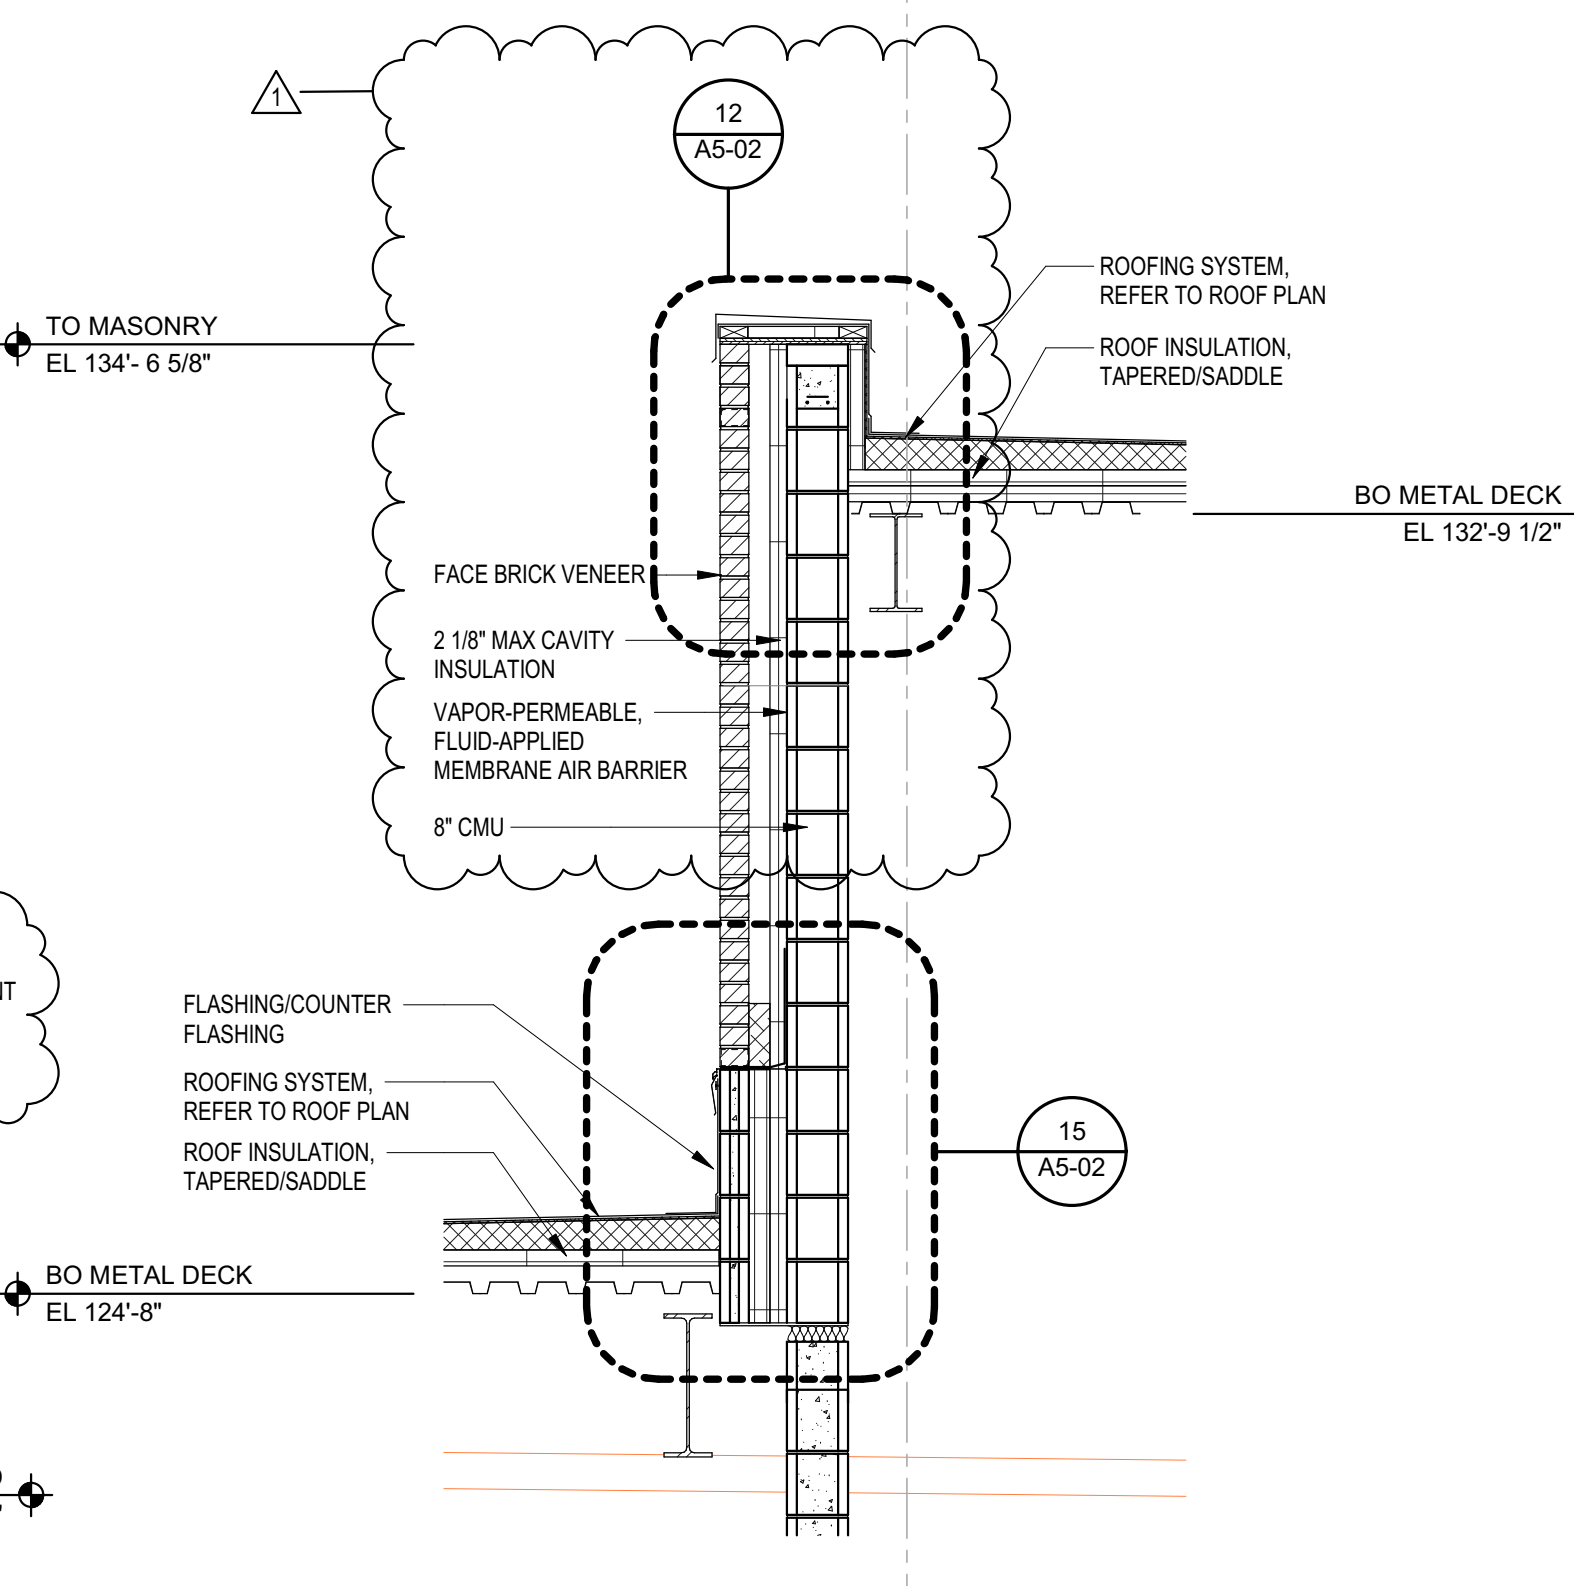
**1 WALL SECTION**  
SCALE: 1/2" = 1'-0"




**2 WALL SECTION**  
SCALE: 1/2" = 1'-0"

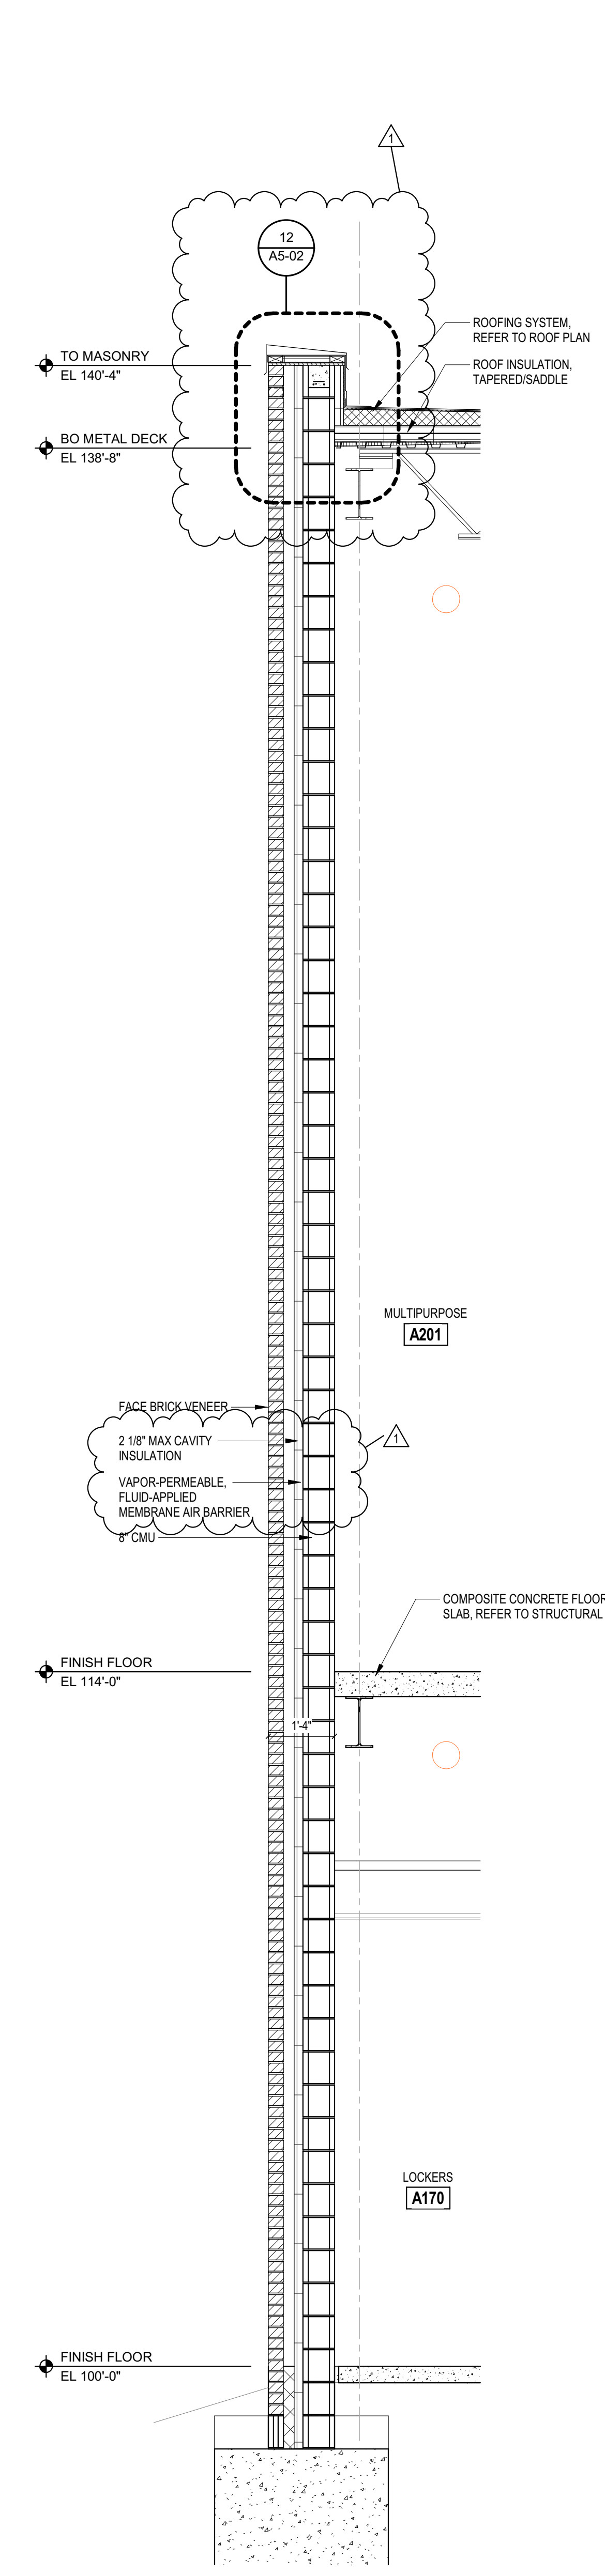

**3 WALL SECTION**  
SCALE: 1/2" = 1'-0"

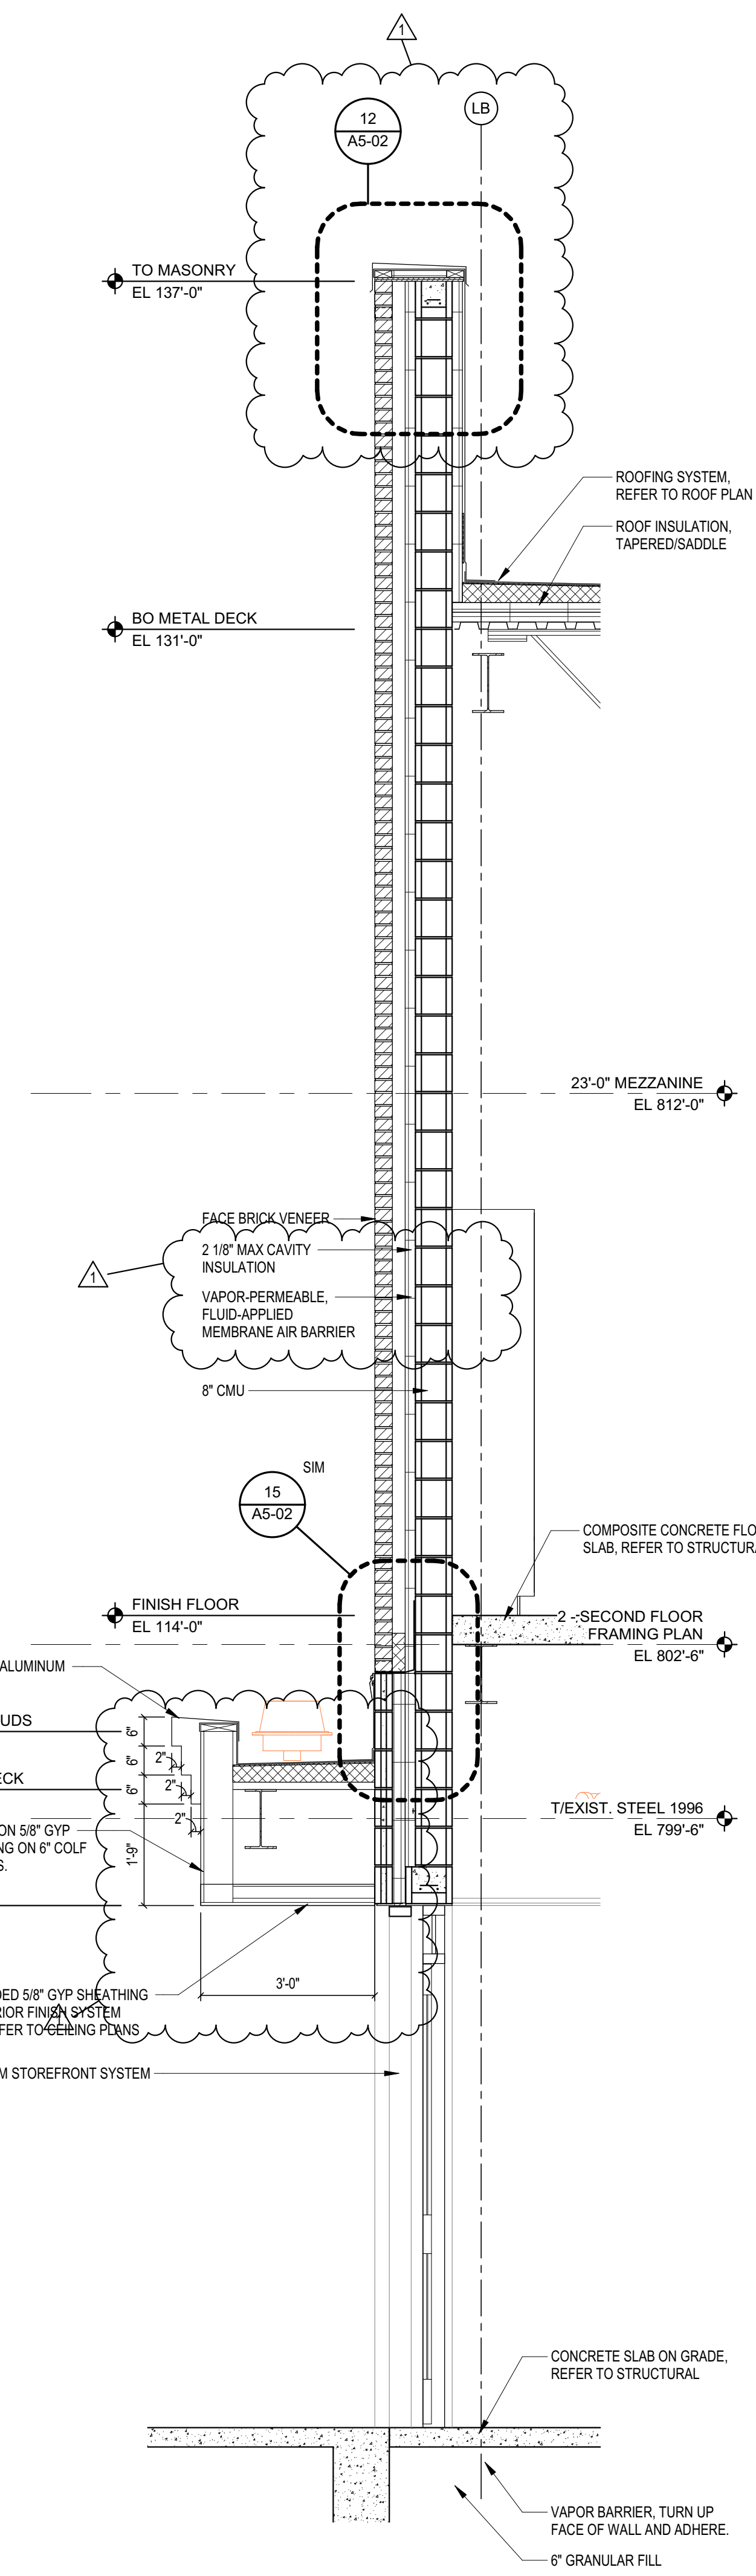

**4 WALL SECTION**  
SCALE: 1/2" = 1'-0"

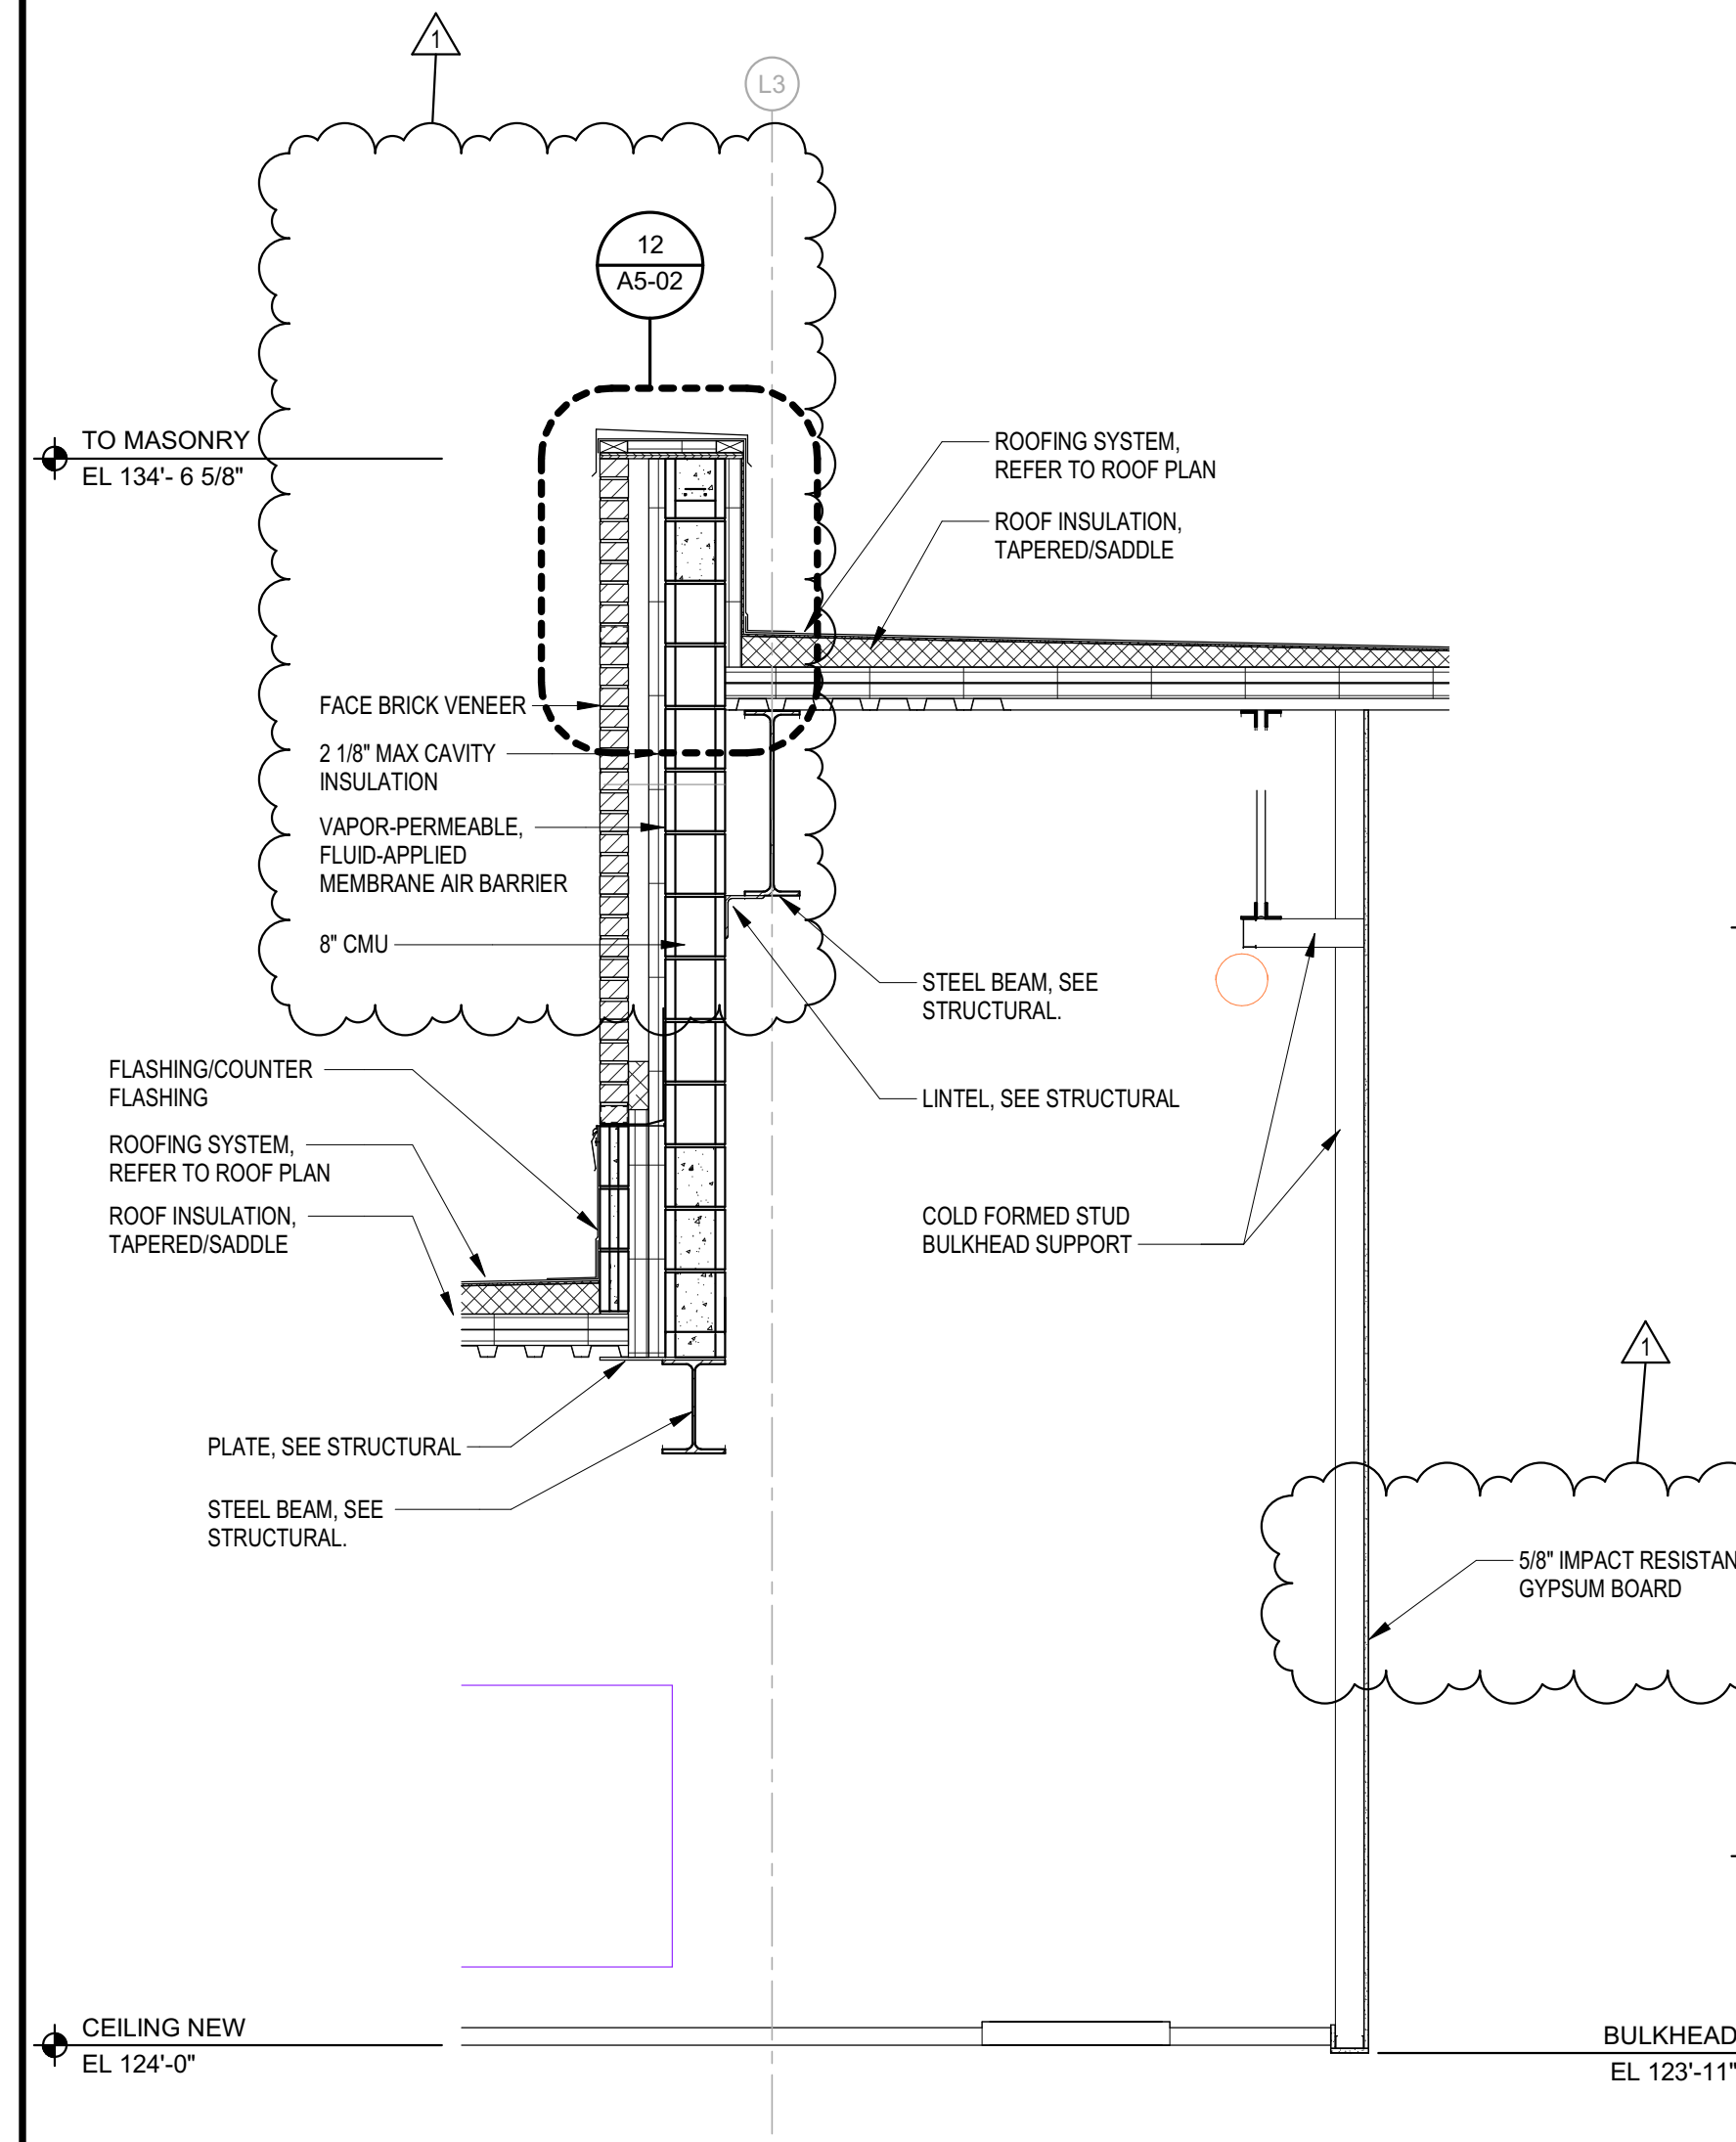

**5 WALL SECTION**  
SCALE: 1/2" = 1'-0"

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# ZIONSVILLE COMMUNITY HIGH SCHOOL ATHLETIC LOCKER ROOMS ADDITION AND RENOVATION

1000 MULBERRY STREET, ZIONSVILLE, IN 46077

ZIONSVILLE COMMUNITY SCHOOLS




ZIONSVILLE COMMUNITY SCHOOLS

ARCHITECT




(800) 452-3573 WWW.FHAI.COM

900 MULBERRY ST. ZIONSVILLE, IN 46077

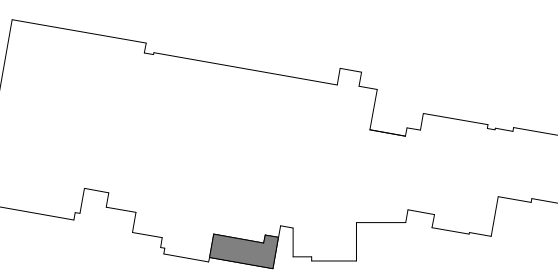

KEY PLAN

ISSUED FOR BID

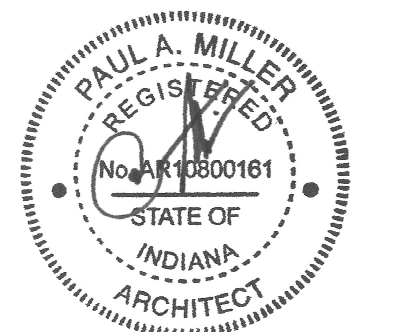

PROJECT MANAGER: JM  
DRAWN BY: Author  
PROJECT NUMBER: 224018.00  
PROJECT ISSUE DATE: 01/21/2025

REV. NO.	DESCRIPTION	DATE
1	ADDENDUM #1	02/11/2025

DOOR AND FRAME SCHEDULE


## A6S-01

DOOR NO.	DOORS		FRAME				HARDWARE				REMARKS	DOOR MARK	
	DOOR SIZE (WxH)	DOOR TYPE	FRAME MATERIAL	FRAME ELEVATION	JAMB DEPTH	DETAILS		FIRE RATING	SET NO.	KEYSIDE ROOM			STC RATING
						HEAD	JAMB						
A105	3'-0" x 6'-10"	F WD	HM	F1	8 3/4"	1	4	-	26.0	A104			A105
A106	3'-0" x 6'-10"	F WD	HM	F1	8 3/4"	1	4	-	16.0	A106			A106
A107	3'-0" x 6'-10"	F WD	HM	F1	8 3/4"	1	4	-	23.0	A107			A107
A108	3'-0" x 6'-10"	F WD	HM	F1	8 3/4"	1	4	-	22.0	A108			A108
A109	3'-0" x 6'-10"	F WD	HM	F1	8 3/4"	1	4	-	27.0	A106			A109
A110	3'-0" x 6'-10"	F WD	HM	F1	8 3/4"	1	4	-	14.0	A108			A110
A113	3'-0" x 6'-10"	F WD	HM	F1	8 3/4"	1	4	-	27.0	A132			A113
A114	PR 2'-0" x 7'-2"	F WD	HM	F1	8 3/4"	1	4	-	10.0	EXT			A114
A115	3'-0" x 6'-10"	F WD	HM	F1	8 3/4"	1	4	-	14.0	A115			A115
A116	3'-0" x 6'-10"	F WD	HM	F1	8 3/4"	1	4	-	20.0	A116			A116
A117	3'-0" x 6'-10"	F WD	HM	F1	8 3/4"	1	4	-	20.0	A117			A117
A118	3'-0" x 6'-10"	F WD	HM	F1	8 3/4"	1	4	-	14.0	A118			A118
A120	3'-0" x 6'-10"	F WD	HM	F1	8 3/4"	1	4	-	26.0	A119			A120
A121	3'-0" x 6'-10"	F WD	HM	F1	8 3/4"	1	4	-	16.0	A121			A121
A122	3'-0" x 6'-10"	F WD	HM	F1	8 3/4"	1	4	-	24.0	A122			A122
A123	3'-0" x 6'-10"	F WD	HM	F1	8 3/4"	1	4	-	22.0	A123			A123
A124	3'-0" x 6'-10"	F WD	HM	F1	8 3/4"	1	4	-	27.0	A120			A124
A125	3'-0" x 6'-10"	F WD	HM	F1	8 3/4"	1	4	-	14.0	A124			A125
A128	3'-0" x 6'-10"	F WD	HM	F1	8 3/4"	1	4	-	27.0	A139			A128
A129	PR 2'-0" x 7'-2"	F WD	HM	F1	8 3/4"	1	4	-	10.0	EXT			A129
A131	PR 3'-0" x 6'-10"	F WD	HM	F2	5 3/4"	3	6	-	10.0	A130			A131
A132	3'-0" x 6'-10"	F WD	HM	F1	5 3/4"	3	6	-	26.0	A130			A132
A133	3'-0" x 6'-10"	F WD	HM	F1	5 3/4"	3	6	-	26.0	A130			A133
A133A	PR 3'-0" x 8'-0"	FGAL2	AL	-	4 1/2"	-	-	-	3.0	EXT	2		A133A
A133B	3'-0" x 8'-0"	FGAL2	AL	-	4 1/2"	-	-	-	1.0	EXT	2, 1		A133B
A136	3'-0" x 6'-10"	F WD	HM	F1	5 3/4"	3	6	-	26.0	A130			A136
A139	3'-0" x 6'-10"	F WD	HM	F1	5 3/4"	3	6	-	26.0	A130			A139
A140	PR 3'-0" x 6'-10"	F WD	HM	F2	5 3/4"	3	6	-	10.0	A130			A140
A143	3'-0" x 6'-10"	F WD	HM	F1	8 3/4"	1	4	-	26.0	A130			A143
A144	3'-0" x 6'-10"	F WD	HM	F3	8 3/4"	1	4	-	15.0	A144			A144
A144B	3'-0" x 6'-10"	F WD	HM	F1	8 3/4"	1	4	-	16.0	A144			A144B
A145	3'-0" x 6'-10"	F WD	HM	F1	8 3/4"	1	4	-	14.0	A144			A145
A146	3'-0" x 6'-10"	F WD	HM	F1	8 3/4"	1	4	-	22.0	A146			A146
A149	3'-0" x 6'-10"	F HM	HM	F1	5 3/4"	3	6	-	5.0	A149			A149
A150	3'-0" x 6'-10"	F WD	HM	F1	8 3/4"	1	4	-	21.0	A150			A150
A151	3'-0" x 6'-10"	F WD	HM	F1	8 3/4"	1	4	-	26.0	A130			A151
A152A	3'-0" x 6'-10"	F WD	HM	F3	8 3/4"	1	4	-	15.0	A152			A152A
A152B	3'-0" x 6'-10"	F WD	HM	F1	8 3/4"	1	4	-	16.0	A152			A152B
A153	3'-0" x 6'-10"	F WD	HM	F1	8 3/4"	1	4	-	14.0	A152			A153
A154	3'-0" x 6'-10"	F WD	HM	F1	8 3/4"	1	4	-	22.0	A154			A154
A157	3'-0" x 6'-10"	F HM	HM	F1	5 3/4"	3	6	-	5.0	A157			A157
A158	3'-0" x 6'-10"	F WD	HM	F1	8 3/4"	1	4	-	26.0	A130			A158
A159A	3'-0" x 6'-10"	F WD	HM	F3	8 3/4"	1	4	-	15.0	A159			A159A
A159B	3'-0" x 6'-10"	F WD	HM	F1	8 3/4"	1	4	-	16.0	A159			A159B
A160	3'-0" x 6'-10"	F WD	HM	F1	8 3/4"	1	4	-	14.0	A160			A160
A161	3'-0" x 6'-10"	F WD	HM	F1	8 3/4"	1	4	-	22.0	A161			A161
A164	3'-0" x 6'-10"	F HM	HM	F1	5 3/4"	3	6	-	5.0	A164			A164
A165	3'-0" x 6'-10"	F WD	HM	F1	8 3/4"	1	4	-	21.0	A166			A165
A166	3'-0" x 6'-10"	F WD	HM	F1	8 3/4"	1	4	-	26.0	A130			A166
A167A	3'-0" x 6'-10"	F WD	HM	F3	8 3/4"	1	4	-	15.0	A167			A167A
A167B	3'-0" x 6'-10"	F WD	HM	F1	8 3/4"	1	4	-	16.0	A167			A167B
A168	3'-0" x 6'-10"	F WD	HM	F1	8 3/4"	1	4	-	14.0	A167			A168
A169	3'-0" x 6'-10"	F WD	HM	F1	8 3/4"	1	4	-	22.0	A169			A169
A172	3'-0" x 6'-10"	F HM	HM	F1	5 3/4"	3	6	-	5.0	A172			A172
A173	3'-0" x 6'-10"	F WD	HM	F1	8 3/4"	1	4	-	12.0	A173			A173
A174	3'-0" x 6'-10"	F WD	HM	F1	8 3/4"	1	4	-	11.0	A175			A174
A175A	3'-0" x 8'-0"	FGAL2	AL	-	4 1/2"	-	-	-	1.0	EXT	2, 1		A175A
A175B	3'-0" x 8'-0"	FGAL2	AL	-	4 1/2"	-	-	-	4.0	EXT	2		A175B
A175C	3'-0" x 8'-0"	FGAL2	AL	-	4 1/2"	-	-	-	4.0	EXT	2		A175C
A175D	3'-0" x 8'-0"	FGAL2	AL	-	4 1/2"	-	-	-	4.0	EXT	2, 3		A175D
A175E	3'-0" x 8'-0"	FGAL2	AL	-	4 1/2"	-	-	-	4.0	EXT	2		A175E
A175F	PR 3'-0" x 6'-10"	F WD	HM	F2	8 3/4"	1	4	-	7.0	A175			A175F
A176A	3'-0" x 6'-10"	F WD	HM	F1	8 3/4"	1	4	-	17.0	A141			A176A
A176B	3'-0" x 6'-10"	F WD	HM	F1	8 3/4"	1	4	-	18.0	EXT	8		A176B
A177	3'-0" x 6'-10"	F WD	HM	F1	8 3/4"	1	4	-	16.0	A177			A177
A178	3'-0" x 6'-10"	F WD	HM	F1	8 3/4"	1	4	-	14.0	A178			A178
A179	PR 3'-0" x 8'-10"	FGAL2	AL	-	4 1/2"	-	-	-	2.0	EXT			A179
A180	PR 3'-0" x 8'-10"	FGAL2	AL	-	4 1/2"	-	-	-	29.0	EXT	8		A180
A181A	3'-0" x 7'-2"	FGAL2	AL	SEE PLAN	4 1/2"	-	-	-	30.0	EXT	5		A181A
A181B	3'-0" x 7'-2"	FGAL2	AL	SEE PLAN	4 1/2"	-	-	-	31.0	EXT	5		A181B
A181C	3'-0" x 7'-2"	FGAL2	AL	SEE PLAN	4 1/2"	-	-	-	30.0	EXT	5		A181C
A181D	3'-0" x 7'-2"	FGAL2	AL	SEE PLAN	4 1/2"	-	-	-	30.0	EXT	5		A181D
A181E	3'-0" x 7'-2"	FGAL2	AL	SEE PLAN	4 1/2"	-	-	-	30.0	EXT	5		A181E
A181F	3'-0" x 7'-2"	FGAL2	AL	SEE PLAN	4 1/2"	-	-	-	30.0	EXT	5		A181F
A181G	3'-0" x 7'-2"	FGAL2	AL	SEE PLAN	4 1/2"	-	-	-	30.0	EXT	5		A181G
A181H	3'-0" x 7'-2"	FGAL2	AL	SEE PLAN	4 1/2"	-	-	-	30.0	EXT	5		A181H
A202	4'-0" x 7'-2"	N WD	HM	F1	5 3/4"	3	6	-	19.0	A202			A202
A203	PR 3'-0" x 6'-10"	F WD	HM	F2	8 3/4"	1	4	-	10.0	EXT			A203
A205	4'-0" x 7'-2"	N WD	HM	F1	5 3/4"	3	6	-	19.0	A204			A205
A207	3'-0" x 6'-10"	F WD	HM	F1	8 3/4"	1	4	-	25.0	A207			A207
A208	3'-0" x 6'-10"	F WD	HM	F1	8 3/4"	1	4	-	20.0	A208			A208
A209	PR 3'-0" x 6'-10"	F WD	HM	F2	5 3/4"	1	4	-	10.0	A206			A209
A211A	3'-0" x 7'-2"	N HM	HM	F4	5 3/4"	9	4	-	8.0	A211	4		A211A
A211B	3'-0" x 7'-2"	N HM	HM	F4	5 3/4"	9	4	-	8.0	A211	4		A211B
A211C	3'-0" x 7'-2"	N HM	HM	F4	5 3/4"	9	4	-	28.0	A211	4		A211C
A212	3'-0" x 6'-10"	F WD	HM	F1	8 3/4"	1	4	-	12.0	A212			A212
A217	3'-0" x 6'-10"	F WD	HM	F1	8 3/4"	1	4	-	13.0	A203			A217
S1-1	3'-0" x 6'-10"	N WD	HM	F1	8 3/4"	1	4	-	6.0	EXT			S1-1
S1-2	3'-0" x 6'-10"	N WD	HM	F1	8 3/4"	1	4	-	9.0	S1			S1-2


### DOOR SCHEDULE REMARKS

- See Division 08 Section "Automatic Door Operator (Handicap)".
- Provide safety glass in door.
- Hardware mullion by Division 08 Section "Door Hardware". Mullion to be field-painted to match aluminum door and frame finish.
- Provide new door and frame in existing wall opening. Field verify opening dimensions.
- Existing door and frame to remain, modify existing door frame as required to receive new upgraded tech devices. refer to technology sheets for specifications
- Existing door and frame to remain, add card reader and all required wiring to existing door and frame.


### DOOR TYPES

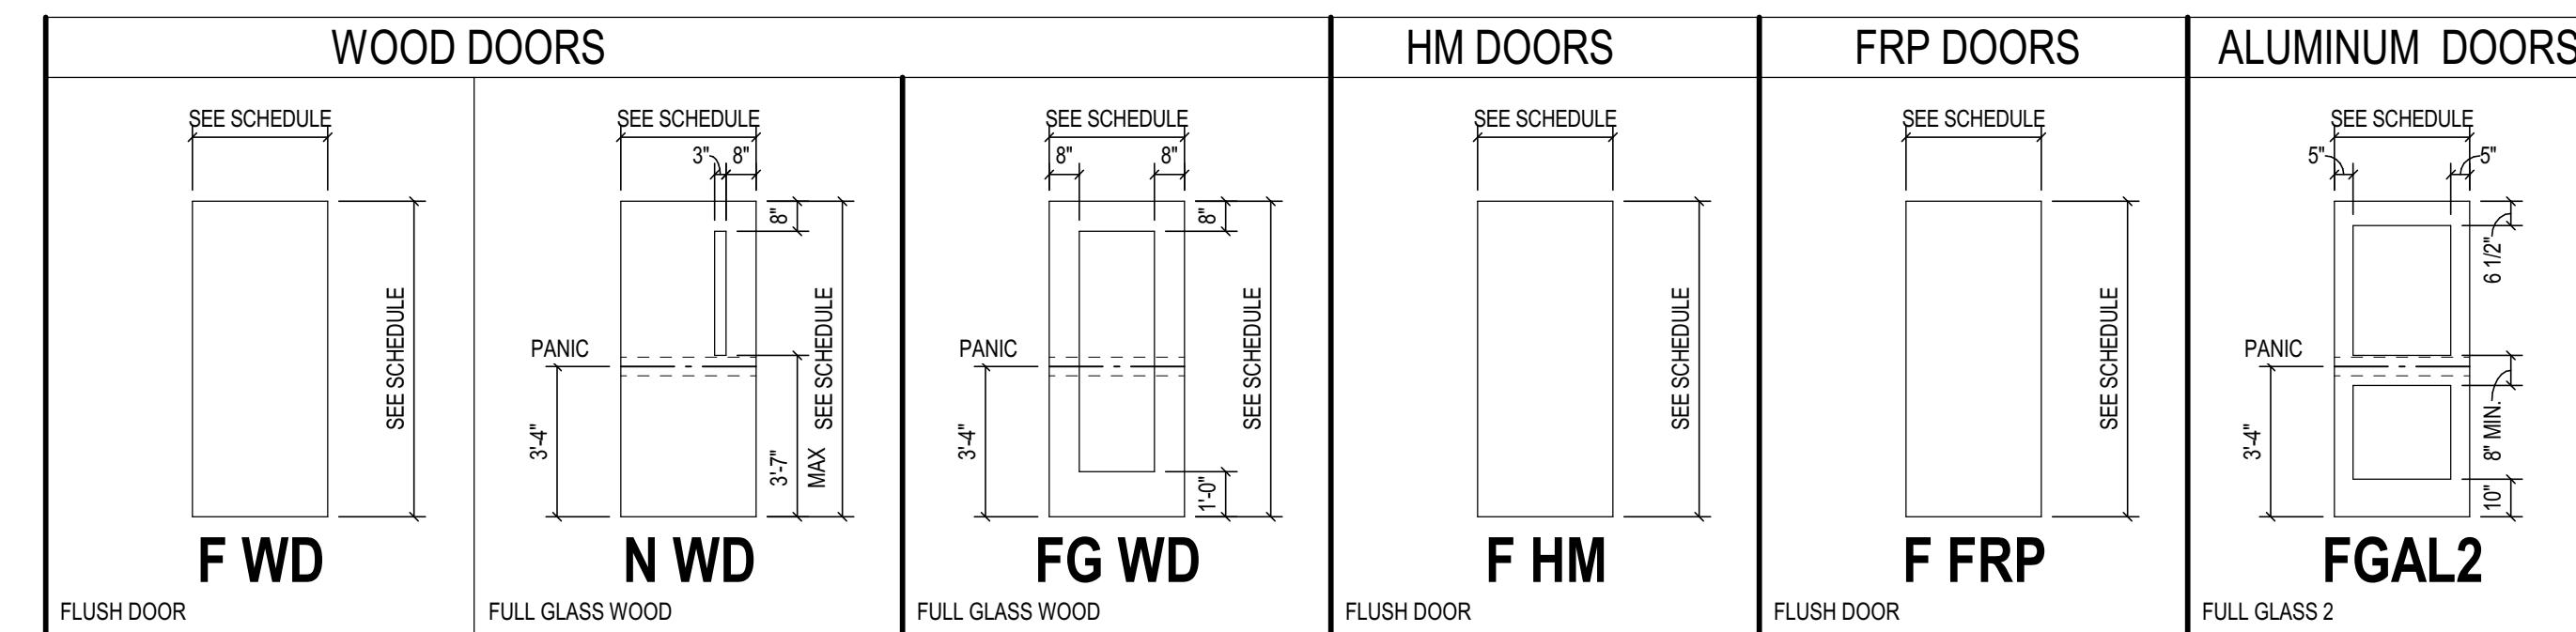


### LOUVER ELEVATIONS

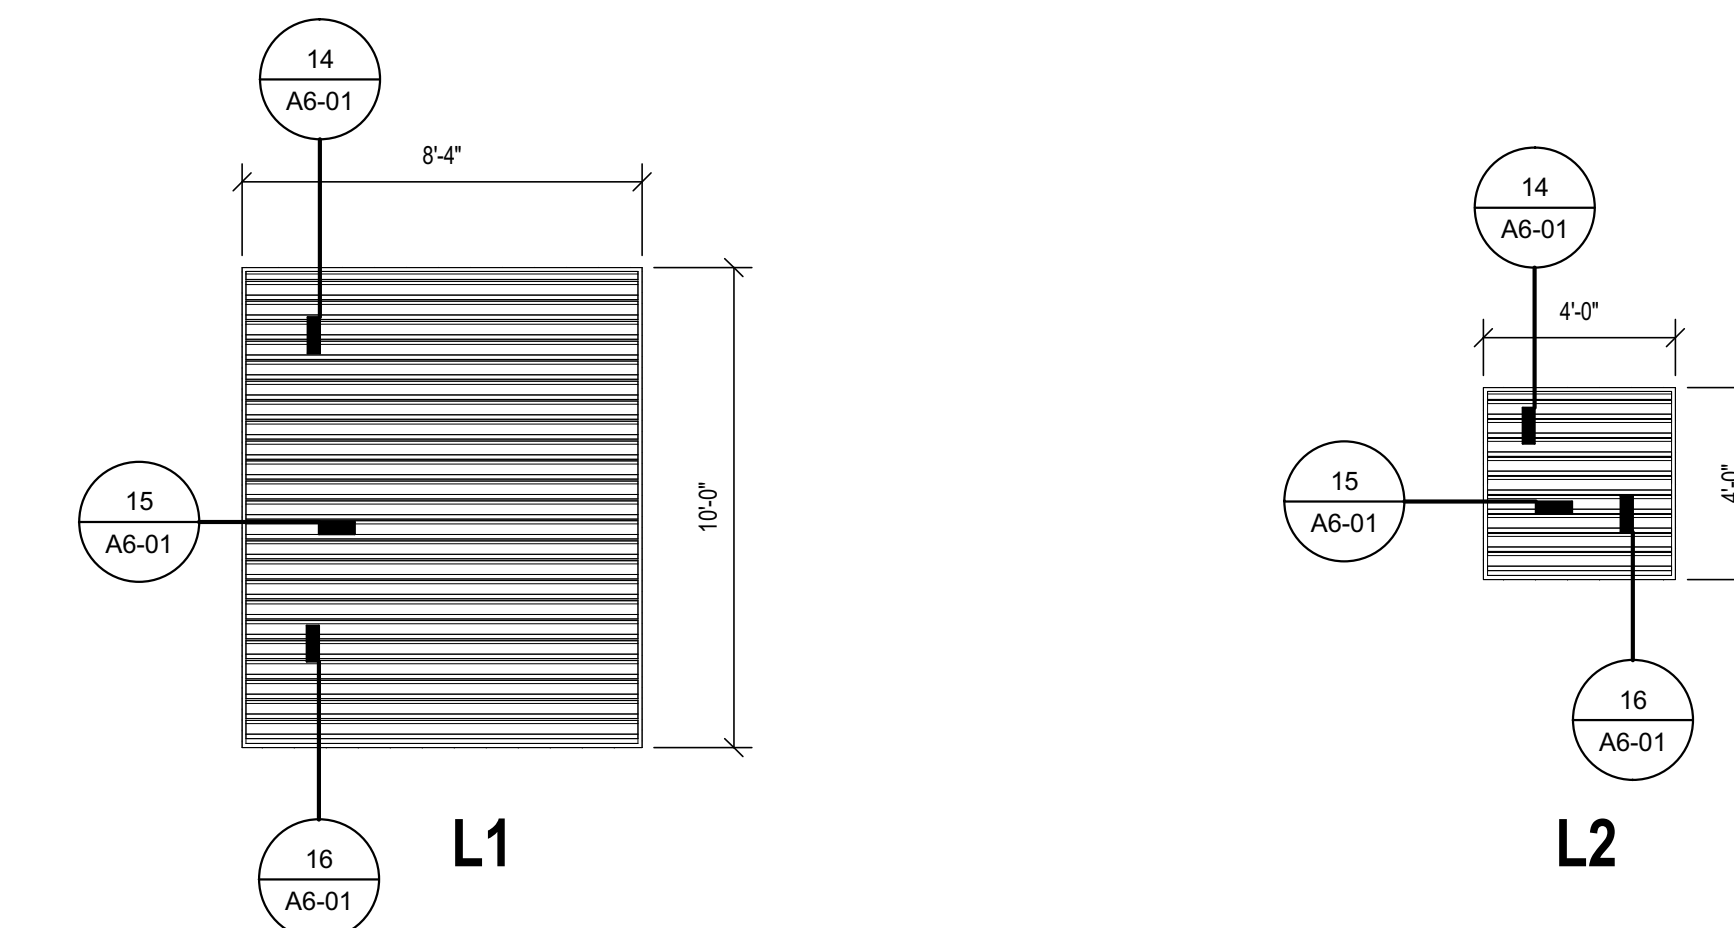

### FRAME ELEVATIONS

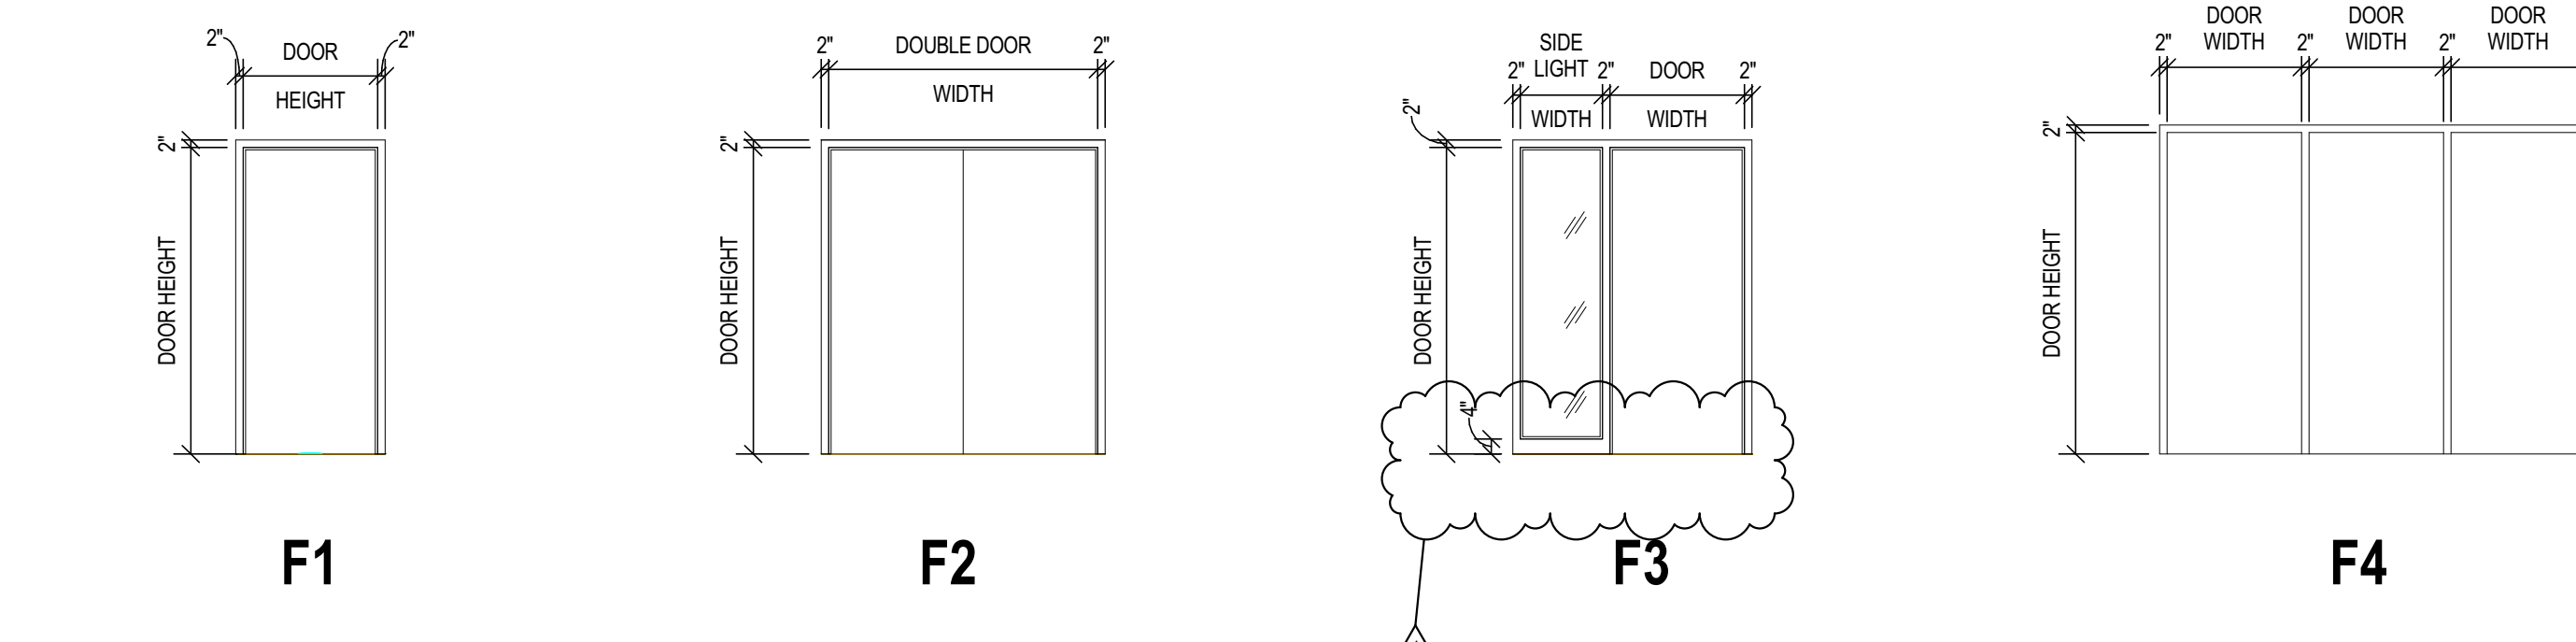

### STORE FRONT ELEVATIONS

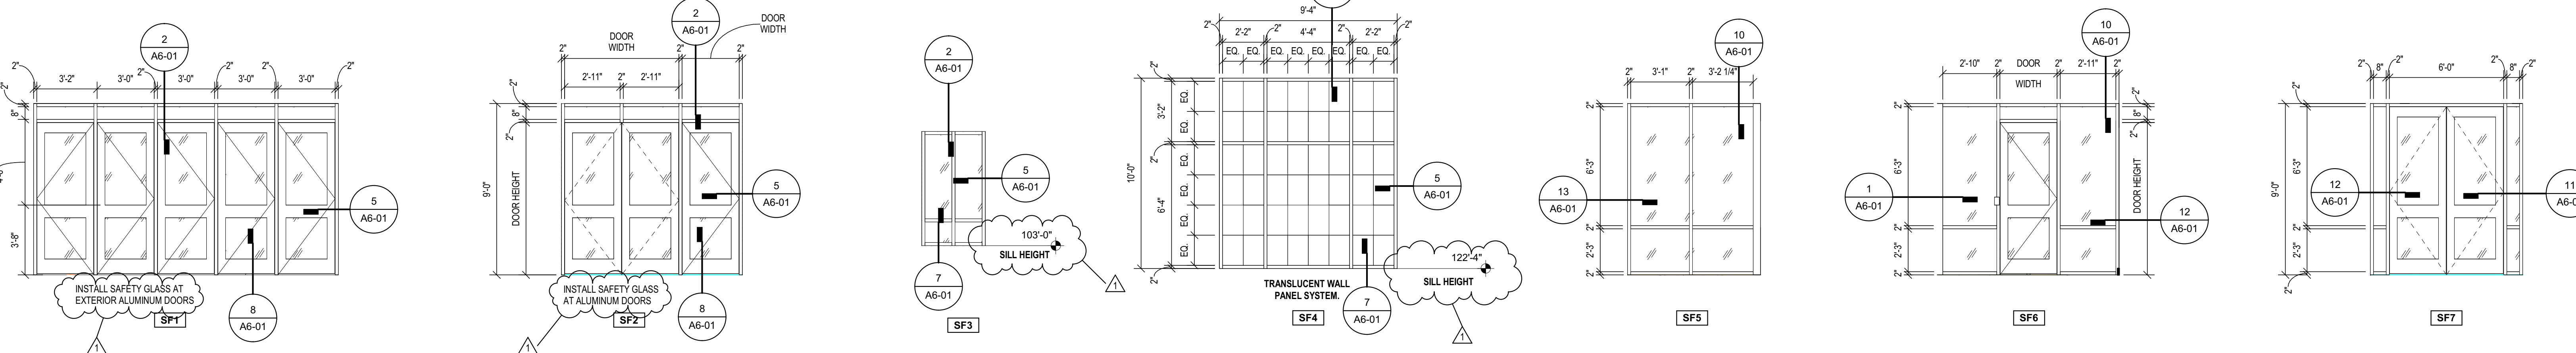







# ZIONSVILLE COMMUNITY HIGH SCHOOL ATHLETIC LOCKER ROOMS ADDITION AND RENOVATION

1000 MULBERRY STREET, ZIONSVILLE, IN 46077

ZIONSVILLE COMMUNITY SCHOOLS




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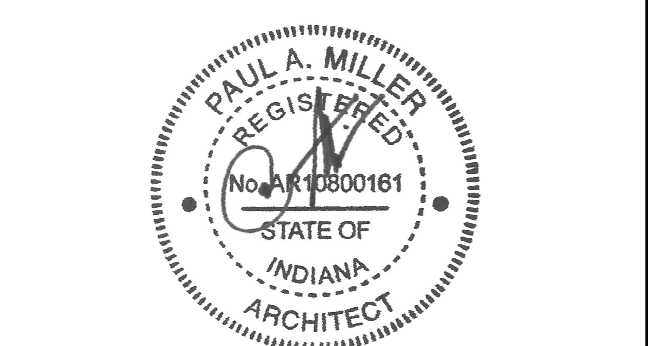


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900 MULBERRY ST. ZIONSVILLE, IN 46077



ISSUED FOR BID

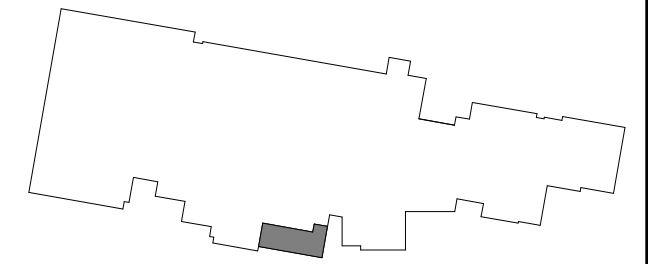

PROJECT MANAGER: JM  
DRAWN BY: AML  
PROJECT NUMBER: 224018.00  
PROJECT ISSUE DATE: 01/21/2025

REV. NO.	DESCRIPTION	DATE
1	ADDENDUM #1	02/11/2025

SECOND FLOOR FINISH PLAN

## AI-12

ROOM LEGEND			
ROOM NO.	OWNER ROOM NO.	ROOM NAME	AREA (SF)
A143		VESTIBULE	106 SF
A147		LOCKERS	806 SF
A149		VESTIBULE	44 SF
A201		MULTIPURPOSE RAMP 1	8,818 SF
A202		RAMP 1	243 SF
A203		STORAGE	682 SF
A204		VESTIBULE	46 SF
A205		RAMP 2	317 SF
A206		CORRIDOR	310 SF
A207		LOCKERS	484 SF
A208		BATHROOM	112 SF
A209		STORAGE	399 SF
A210		EXISTING CORRIDOR	1,422 SF
A211		EXISTING CORRIDOR	1,219 SF
A212		SERVICE	50 SF
A213		IT CLOSET	31 SF
A214		EQUIPMENT PLATFORM	1,257 SF
S1		STAIR	174 SF

- GENERAL FINISH NOTES**
- FIXED CASEWORK AND TACKBOARDS SHALL REMAIN IN PLACE (UNO). NEW WALL FINISHES SHALL BE INSTALLED AROUND THESE ITEMS.
  - SEALANT SHALL BE APPLIED AT ALL MATERIAL TRANSITIONS, BACKSPASHES, AND DOOR FRAMES. ALL LOCATIONS WHERE NEW FINISH ABUTS A DISSIMILAR MATERIAL.
  - REMOVE AND REINSTALL EXISTING DEVICE FACEPLATES, SWITCH FACEPLATES, TECHNOLOGY FACEPLATES, AND CLOCKS.
  - EXISTING ITEMS TO REMAIN AND NEW FINISHES APPLIED AROUND INCLUDE BUT NOT LIMITED TO THERMOSTATS, AND FIRE EXTINGUISHER CABINETS (UNO).
  - RESILIENT TRANSITION STRIP BETWEEN NEW FLOOR FINISH AND EXISTING FLOOR FINISH.
  - PROVIDE NEW RESILIENT TRANSITION STRIPS AT EXPOSED EDGE OF NEW FLOOR FINISH TO EXISTING FLOOR FINISH.
  - PANT ALL SIDES (VERT. AND HORZ.) OF BULKHEAD/SOFFIT COLOR INDICATED (UNO).
  - PATCH AND REPAIR ALL HOLES AND IMPERFECTIONS, TO RECEIVE NEW FINISHES.
  - (DRF) INDICATES DECORATIVE RESINOUS FLOORING.
  - (CART) INDICATES CARPET TILE.
  - (ECT) INDICATES ENTRANCE CARPET TILE.
  - (LVT) INDICATES LUXURY VINY. TILE.
  - (FS) INDICATES FLOOR SEALER.
  - (EP) INDICATES EPOXY FLOORING.
  - (RSA) INDICATES RESILIENT STAR NOSING.
  - (RB) INDICATES RESILIENT BASE.
  - (P) INDICATES PAINT.
  - (ACT) INDICATES ACOUSTICAL CEILING TILE GRID.
  - (PES) INDICATES PAINTED EXPOSED STRUCTURE.
  - (FS) INDICATES INTERIOR FINISH SYSTEM.

- FLOOR PATTERN/FINISH KEY NOTES**
- (ALL NOTES MAY NOT BE INDICATED ON THIS SHEET)
- VESTIBULE FINISHES TO MATCH ADJACENT LOCKER ROOM FINISHES
  - STORAGE ROOM FINISHES TO MATCH ADJACENT LOCKER ROOM FINISHES; WALLS TO BE P-1 ONLY
  - REFER TO AI-51 FOR FLOOR PATTERN DETAILS
  - PAINTED WALL GRAPHIC, INCLUDING LETTERS AND LOGO; MINIMUM 4 COLORS; FINAL DESIGN TO BE DETERMINED
  - NO FINISH SCOPE IN THIS ROOM
  - EXISTING BRICK WALL (XBRK), DO NOT PAINT
  - DECORATIVE BULKHEAD, PAINT P-6
  - PANT ALL SIDES OF BULKHEAD, P-4
  - PANT ALL SIDES OF BULKHEAD, P-3
  - ROOM TO BE PAINTED P-1 WITH P-4 & P-5 ACCENTS ON ALL WALLS U.N.O.; REFER TO TYP ELEVATION 4A1-22
  - PANT METAL PORTIONS OF STAIR AND RAILINGS, P-2
  - RSF-1, 2, 3 2" LOGO INLAD INTO RFT; REFER TO DETAIL 2A1-51
  - RSF-1, 2, 3 2" LOGO INLAD INTO RFT; REFER TO DETAIL 2A1-51
  - RSF-1, 2, 3 2" LOGO INLAD INTO RFT; REFER TO DETAIL 2A1-51
  - 2" LOGO INLAD INTO RFT; REFER TO DETAIL 2A1-51
  - 2" LOGO INLAD INTO RFT; REFER TO DETAIL 2A1-51
  - PANT NEW HM DOORS AND FRAMES; COLOR TO BE SELECTED
  - ROOM TO BE PAINTED P-1 WITH P-4 & P-5 ACCENTS ON ALL WALLS U.N.O.; REFER TO TYP ELEVATION 5A1-22
  - EXISTING PAINTED WALL TO REMAIN
  - IFS-1 CEILING OVER SHOWER; REFER TO AC SERIES DRAWINGS
  - IFS-1 CEILING OVER ENTIRE SHOWER AREA SOUTH OF BULKHEAD; REFER TO AC SERIES DRAWINGS
  - INCLUDE HIGH-PERFORMANCE COATINGS IN THIS ROOM; REFER TO PAINT TYPE NOTES ON AI-61
  - ROOM TO BE PAINTED P-1 WITH P-4 & P-5 ACCENTS ON ALL WALLS U.N.O.; REFER TO TYP ELEVATION 6A1-22
  - PAINTED LOGO; REFER TO DETAIL 2A1-52
  - PAINTED WALL GRAPHIC, INCLUDING LETTERS; MINIMUM 4 COLORS; FINAL DESIGN TO BE DETERMINED; REFER TO ELEVATION
  - LVT-3 LOCATED ON FIRST FLOOR ONLY; RSA-1 INDICATED FOR STAIR TREADS AND LANDINGS AS SHOWN WITH HATCHING

**2 EQUIPMENT PLATFORM - FINISH PLAN**  
SCALE: 1/8" = 1'-0"

**1 SECOND FLOOR FINISH PLAN**  
SCALE: 1/8" = 1'-0"

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# ZIONSVILLE COMMUNITY HIGH SCHOOL ATHLETIC LOCKER ROOMS ADDITION AND RENOVATION

1000 MULBERRY STREET, ZIONSVILLE, IN 46077

ZIONSVILLE COMMUNITY SCHOOLS



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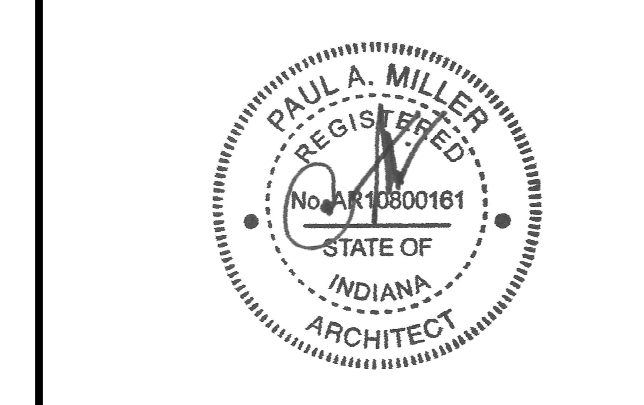
# FANNING HOWEY

(800) 452-3573 WWW.FHAI.COM  
900 MULBERRY ST. ZIONSVILLE, IN 46077



## KEY PLAN

ISSUED FOR BID



PROJECT MANAGER: JM  
DRAWN BY: AML  
PROJECT NUMBER: 224018.00  
PROJECT ISSUE DATE: 01/21/2025

REV. NO.	DESCRIPTION	DATE
1	ADDENDUM #1	02/11/2025

## FIRST FLOOR EQUIPMENT PLAN

# AQ-11

ROOM NO.	OWNER ROOM NO.	ROOM NAME	AREA (SF)
A101	C9	CORRIDOR	1,376 SF
A102	C9 LAUNDRY	LAUNDRY	515 SF
A103	C6 MECH	MECHANICAL	897 SF
A104		VESTIBULE	46 SF
A105		VESTIBULE	65 SF
A106		OFFICE	193 SF
A107		LOCKERS	110 SF
A108		RESTROOM	70 SF
A109		VESTIBULE	128 SF
A110		STORAGE	19 SF
A111		RESTROOM	226 SF
A112		SHOWERS	127 SF
A113		LOCKERS	868 SF
A114		STORAGE	11 SF
A115		SERVICE SINK	34 SF
A116		REF RESTROOM	98 SF
A117		REF RESTROOM	99 SF
A118		STORAGE	86 SF
A119		VESTIBULE	46 SF
A120		VESTIBULE	60 SF
A121		OFFICE	237 SF
A122		LOCKERS	110 SF
A123		RESTROOM	70 SF
A124		VESTIBULE	128 SF
A125		STORAGE	19 SF
A126		RESTROOM	226 SF
A127		SHOWERS	127 SF
A128		LOCKERS	868 SF
A129		STORAGE	10 SF
A130		CORRIDOR	1,707 SF
A131		STORAGE	92 SF
A132		VESTIBULE	40 SF
A133		VESTIBULE	82 SF
A134		LOCKERS	215 SF
A135		RESTROOM	182 SF
A136		VESTIBULE	82 SF
A137		LOCKERS	216 SF
A138		RESTROOM	182 SF
A139		VESTIBULE	40 SF
A140		STORAGE	134 SF
A141		LOBBY	396 SF
A142		OPEN OFFICE	306 SF
A143		VESTIBULE	108 SF
A144		OFFICE	250 SF
A145		STORAGE	12 SF
A146		RESTROOM	92 SF
A147		LOCKERS	868 SF
A148		RESTROOM	229 SF
A149		VESTIBULE	44 SF
A150		RESTROOM	66 SF
A151		VESTIBULE	105 SF
A152		OFFICE	240 SF
A153		STORAGE	12 SF
A154		RESTROOM	92 SF
A155		LOCKERS	799 SF
A156		RESTROOM	229 SF
A157		VESTIBULE	44 SF
A158		VESTIBULE	105 SF
A159		OFFICE	249 SF
A160		STORAGE	12 SF
A161		RESTROOM	86 SF
A162		LOCKERS	799 SF
A163		RESTROOM	248 SF
A164		VESTIBULE	44 SF
A165		RESTROOM	86 SF
A166		VESTIBULE	104 SF
A167		OFFICE	250 SF
A168		STORAGE	12 SF
A169		RESTROOM	86 SF
A170		LOCKERS	794 SF
A171		RESTROOM	248 SF
A172		VESTIBULE	44 SF
A173		ELECTRICAL	55 SF
A174		TECHNOLOGY	46 SF
A175	C6	CORRIDOR	1,263 SF
A176	C42	TRAINING	703 SF
A177	C42A	OFFICE	178 SF
A178		STORAGE	69 SF
A179		CORRIDOR	251 SF
A180	C6	CORRIDOR	257 SF
A181		VESTIBULE	387 SF
S1		STAIR	174 SF

**EQUIPMENT GENERAL NOTES**

A. ALL COUNTERTOPS TO HAVE CONTINUOUS 4" HIGH BACKSPASHES AND ENDSPLASHES UNLESS NOTED OTHERWISE.

B. HIDDEN LINES (---) INDICATE ITEMS TO BE PART OF LOOSE EQUIPMENT PACKAGE OR BY OWNER, NOT INCLUDED IN CONSTRUCTION CONTRACTS. DASHED LINES (---) INDICATE OVERHEAD ITEMS (INCLUDED IN CONSTRUCTION CONTRACTS).

C. (TB) INDICATES 4" HIGH TRACK BOARD LENGTH AS INDICATED. REFER TO MOUNTING HEIGHT DRAWING.

D. PROVIDE FILLER STRIPS BETWEEN CASEWORK UNITS AND WALL OR BETWEEN ANY UNIT AS REQUIRED. EXTEND COUNTER TO FACE OF WALL OR ADJACENT TALL CABINET. ALL CASEWORK DOORS AND DRAWERS SHALL BE LOCKABLE.

E. ALL EXPOSED ENDS AND BACKS OF CASEWORK SHALL BE FINISHED.

F. CASEWORK INSTALLER SHALL CUT CASEWORK AS REQUIRED FOR PLUMBING/ELECTRICAL LINES.

G. CASEWORK INSTALLER SHALL CALKUL BETWEEN COUNTERTOPS, BACKSPASHES, AND WALLS.

H. ALL WALL-MOUNTED CASEWORK SHALL BE MOUNTED WITH THE TOP AT 7'-0" AFF UNLESS OTHERWISE NOTED. REFER TO A-01 LIST OF FINISHES FOR COLOR SELECTIONS.


I. (RWS) INDICATES ROLLER WINDOW SHADES. REFER TO SPECIFICATIONS.

J. (RS\_) INDICATES ROOM SIGNAGE. REFER TO A0-S1 FOR SIGNAGE TYPE DETAILS.

**EQUIPMENT NOTES**

(ALL NOTES MAY NOT BE INDICATED ON THIS SHEET)

- ALTERNATING TYPE A, B, AND C LOCKERS WITH CONCRETE BENCH IN THIS ROOM. REFER TO A4-02 & A4-03 FOR ENLARGED PLAN AND A0-61 FOR LOCKER AND BENCH DETAILS.
- TWO TIER METAL ATHLETIC LOCKERS (TYPE C) AND CONCRETE BENCH. REFER TO A4-02 FOR ENLARGED PLAN AND A0-61 FOR LOCKER AND BENCH DETAILS.
- SINGLE TIER METAL ATHLETIC LOCKERS WITH METAL BASE (TYPE D). REFER TO A0-61 FOR LOCKER DETAILS.
- SINGLE TIER METAL ATHLETIC LOCKERS (TYPE E) AND CONCRETE BENCH. REFER TO A4-02 FOR ENLARGED PLAN AND A0-61 FOR LOCKER AND BENCH DETAILS.
- VOLLEYBALL STANDARDS AND NET TO BE PROVIDED BY OWNER.
- TREATMENT / MASSAGE / TAPING TABLE, BY OWNER.
- MUSCLE STIM UNIT, BY OWNER.
- MONITOR, BY OWNER.
- MONITOR ON ANGLED BRACKET, BY OWNER.
- PL-1 CASEWORK WITH SSM-1 COUNTERTOP.
- WALL-MOUNTED GLASSLESS MIRRORS, 48" W X 132" H PANELS. BASIS OF DESIGN IS ROSE BRAND GLASSLESS MIRRORS. REFER TO ELEVATION.
- WALL-MOUNTED, BI-PARTING ACOUSTICAL CURTAIN. REFER TO ELEVATION.
- WALL-MOUNTED SCOREBOARD. MOUNT WITH BOTTOM AT 11'-0" AFF. REFER TO SPECIFICATIONS.
- MOTOR IZED PROJECTION SCREEN, MOUNTED WITH CEILING MOUNT BRACKETS TO STRUCTURAL STEEL BEAM ABOVE. BASIS OF DESIGN IS DRAPER ACUMEN XL 100" DIAGONAL. INCLUDE 18" DROP.
- WALL-MOUNTED WEB SLIDE UNIT, BY OWNER.
- EXERCISE BICYCLE, BY OWNER.
- EXISTING ROOM SIGNAGE TO REMAIN, REMOVE/REINSTALL AS REQUIRED FOR NEW FINISHES.
- SINGLE TIER METAL ATHLETIC LOCKERS (TYPE B) AND CONCRETE BENCH. REFER TO A4-02 FOR ENLARGED PLAN AND A0-61 FOR LOCKER AND BENCH DETAILS.
- ALTERNATING TYPE B AND C LOCKERS WITH CONCRETE BENCH. REFER TO A4-02 FOR ENLARGED PLAN AND A0-61 FOR LOCKER AND BENCH DETAILS.
- FUTURE BATTING CAGE, BY OWNER.
- PL-1 CUBBIES. REFER TO 1/4-21 & CASEWORK SCHEDULE (NOT USED).
- CEILING-MOUNTED SHORT-THROW PROJECTOR WITH PROTECTIVE CAGE. BASIS OF DESIGN IS EPSON EB-P2213R. PROJECTOR TO BE PROVIDED BY OWNER AND CAGE TO BE INCLUDED IN PROJECT. REFER TO TECHNOLOGY DRAWINGS.
- INSTALL NEW DEDICATION PLAQUE.
- EXISTING BLEACHERS TO REMAIN.
- VOLLEYBALL COURT LINES. REFER TO DETAIL 1/AQ-02.
- BASKETBALL COURT LINES. REFER TO DETAIL 2/AQ-02.

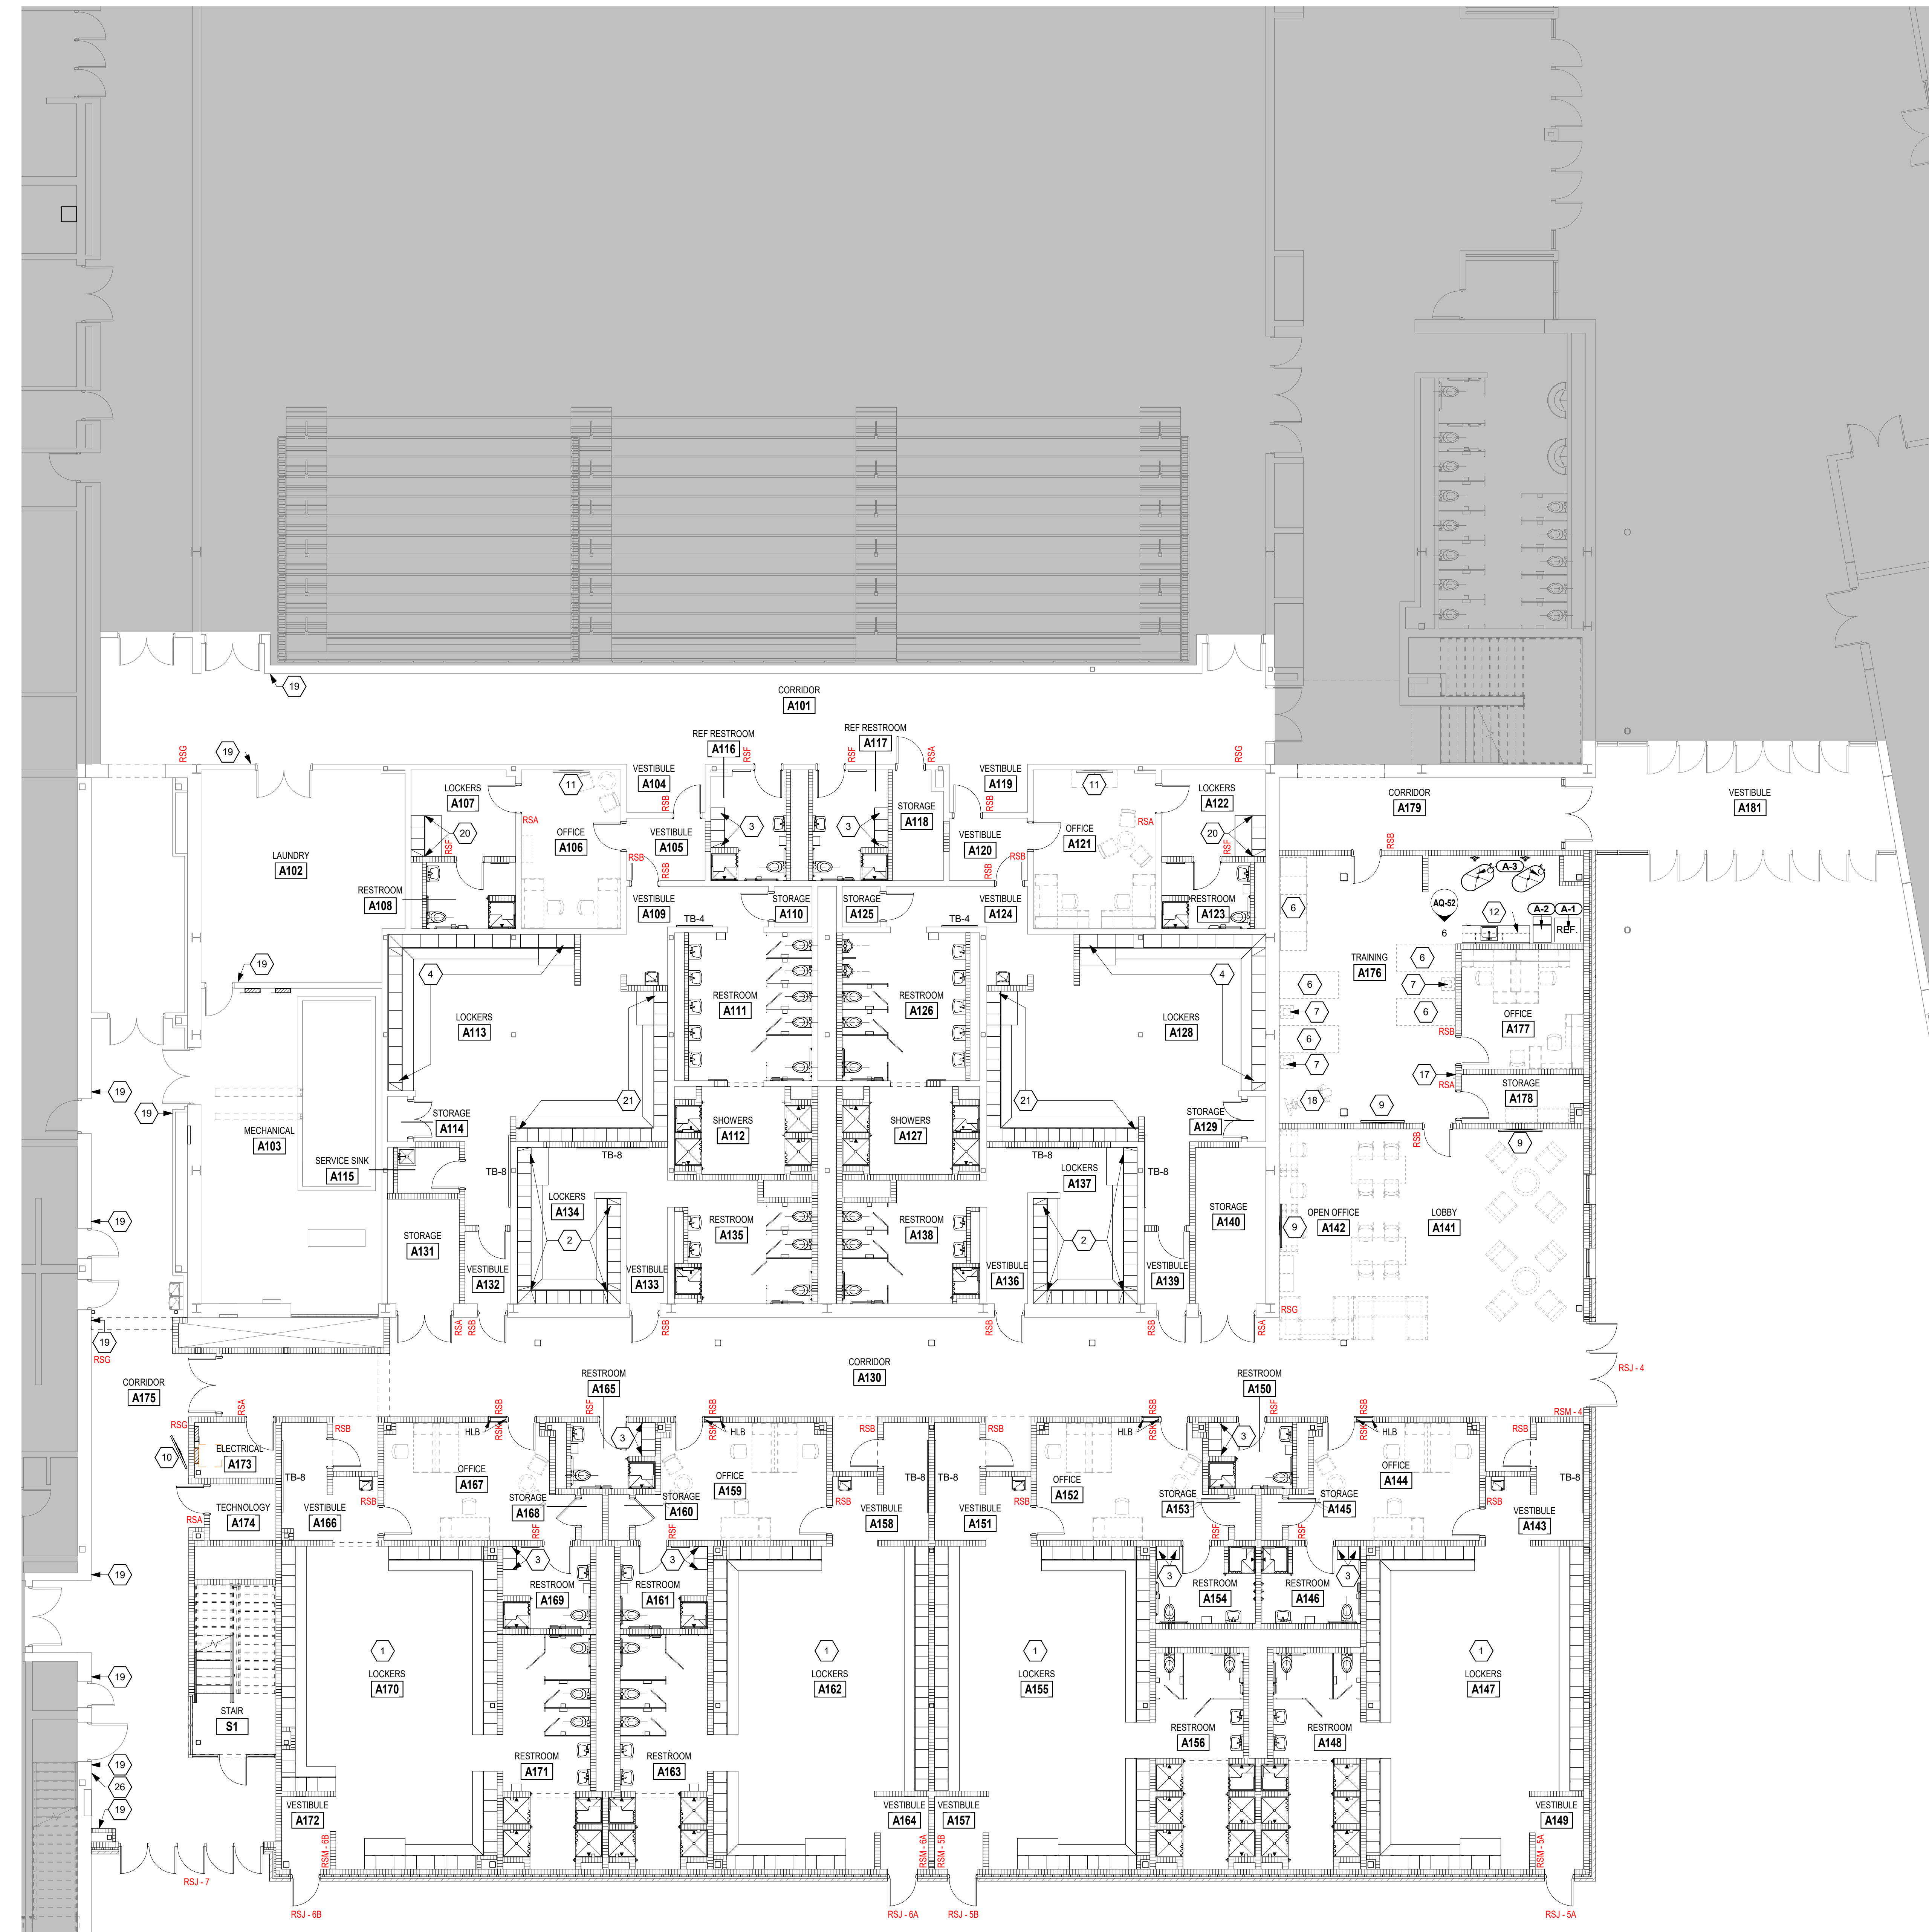

**1 FIRST FLOOR EQUIPMENT PLAN**  
SCALE: 1/8" = 1'-0"

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ZIONSVILLE COMMUNITY SCHOOLS




ZIONSVILLE COMMUNITY SCHOOLS

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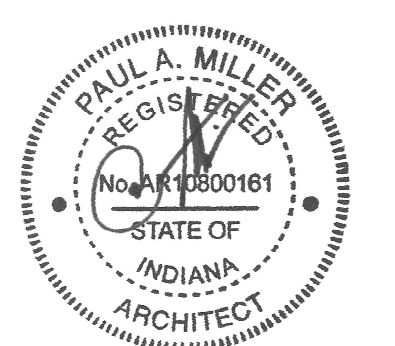


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KEY PLAN

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REV. NO.	DESCRIPTION	DATE
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EQUIPMENT SCHEDULES & LOCKER DETAILS

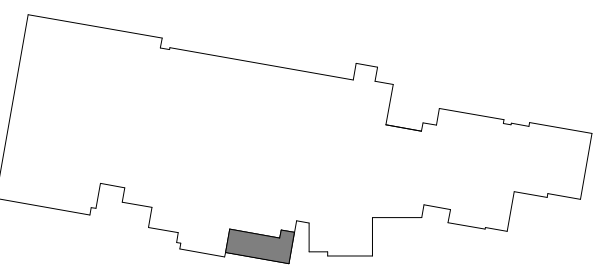**AQ-61**

## LIST OF FINISHES

### EQUIPMENT MATERIALS

#### HP PLASTIC LAMINATE

MATERIAL ABBREVIATION	MATERIAL MANUFACTURER	COLOR SELECTION
PL-1	FORMICA	CHESTNUT WOODLINE 5884-58

#### MARKERBOARD

WHITE

#### METAL LOCKERS

MATERIAL ABBREVIATION	MATERIAL MANUFACTURER	COLOR SELECTION
ATHLETIC LOCKERS	REFER TO SPECIFICATIONS	TO BE SELECTED (GRAY)

#### SOLID SURFACE MATERIAL

MATERIAL ABBREVIATION	MATERIAL MANUFACTURER	COLOR SELECTION
SSM-1 (COUNTERTOPS) SSM-2 (SILLS)	CORIAN / LX HAUSLY / WILSONART CORIAN / LX HAUSLY / WILSONART	GROUP 2 TO BE SELECTED

#### TACKBOARDS

MATERIAL ABBREVIATION	MATERIAL MANUFACTURER	COLOR SELECTION
TB	KOROSEAL / HARBORWEAVE	SCARBOROUGH

### MISCELLANEOUS MATERIALS

#### HORIZONTAL LOUVERED BLINDS

MATERIAL ABBREVIATION	MATERIAL MANUFACTURER	COLOR SELECTION
HLB	REFER TO SPECIFICATIONS	TO BE SELECTED

#### KICKPLATES

STAINLESS STEEL

#### SOLID PLASTIC TOILET PARTITIONS/COMPARTMENTS

MATERIAL ABBREVIATION	MATERIAL MANUFACTURER	COLOR SELECTION
	REFER TO SPECIFICATIONS	BLACK

#### SHOWER CURTAINS

WHITE

### EQUIPMENT MATERIAL/FINISH GEN. NOTES

- COLOR SELECTION OF ALL FINISHES FOR INTERIOR ARCHITECTURAL WOODWORK/CUSTOM CASEWORK ITEMS ARE NOTED ON CASEWORK ELEVATIONS AND DETAIL DRAWINGS.
- EDUCATION CASEWORK FINISHES ARE AS FOLLOWS (UNLESS OTHERWISE NOTED):
  - COUNTERTOPS AND WORKSURFACES ARE TO BE SSM-1, UNLESS OTHERWISE NOTED.
  - HIGH PRESSURE PLASTIC LAMINATE CABINETS/VERTICAL SURFACES ARE TO BE PL-1, UNLESS OTHERWISE NOTED.
  - INTERIOR MELAMINE TO BE WHITE.
  - 3MM AND 1MM PVC EDGES ON CASEWORK ARE TO MATCH PL-1. COLOR SELECTION TO BE DETERMINED.
  - HANDLES TO BE BRUSHED CHROME.
  - HINGES TO BE BRUSHED CHROME.
- THE SAFETY WALL PADDING TO BE BLACK. REFER TO INTERIOR ELEVATIONS FOR DESIGN.
- ALL SAFETY PADDING ON BASKETBALL GOALS TO BE SELECTED BY ARCHITECT FROM MANUFACTURER'S FULL RANGE OF STANDARD AND DESIGNER VINYL COLOR SELECTIONS.
- GYMNASIUM DIVIDER CURTAIN VINYL COLOR TO BE SELECTED; TOP MESH TO BE WHITE. SUBMIT FULL RANGE OF MANUFACTURER'S STANDARD AND DESIGNER COLORS FOR SELECTION & APPROVAL.
- SCOREBOARD CABINET COLOR TO BE GREEN (SUBMIT FULL RANGE OF MANUFACTURER'S STANDARD AND DESIGNER VINYL COLOR SAMPLES FOR SELECTION & APPROVAL).
- REFER TO A1-61 FOR LIST OF FINISHES NOT INCLUDED ON THIS SHEET.

## PE EQUIPMENT SCHEDULE

PROVIDED AND INSTALLED BY CONTRACTOR

ITEM NO.	ITEM DESCRIPTION	ELEC. FIELD CONNECTION	BUILDING LOAD & MOUNTING
(PE-1)	<b>SIDE-FOLDING BASKETBALL GOAL</b> • BASIS OF DESIGN: PORTER 90955000, 713, 797, 00208-000, 0032800X, 00233-000, 0090211 • SIDE-FOLDING, SIDE-BRACED BASKETBALL BACKSTOP UNIT. INCLUDE ALL NECESSARY FITTINGS, PIPE BEAMS, ELECTRIC WINCH, CABLES, PULLEY, MOUNTING HARDWARE, & CONTROLLER AS REQUIRED FOR COMPLETE INSTALLATION. HEIGHT AS REQUIRED TO ACCOMMODATE STRUCTURE. • INCLUDE "SAFE STRAP" BASKETBALL BACKSTOP SAFETY LOCK. • 72"W x 42"H RECTANGULAR GLASS BACKBOARD WITH FRAME, ONE SAFETY BOLT ON CUSHION EDGE/PAD, ONE FRONT MOUNT, POWR-FLEX GOAL, AND ONE NYLON ANTI-WINCH NET. • BACKBOARD SHALL BE EQUIPPED WITH MANUAL HEIGHT ADJUSTMENT FROM 8' TO 10' WITH DIRECT GOAL ATTACHMENT & HEIGHT LOCK FEATURE. • REFER TO EQUIPMENT PLAN FOR DIRECTION OF FOLD. • BASKETBALL GOAL STRUCTURE TO BE MANUFACTURER'S STANDARD WHITE.	1 HP - 115V DIGITAL KEYPAD CONTROL SYSTEM	STRUCTURAL LOAD PER UNIT: APPROXIMATELY 7,600LB STATIC LOAD PER GOAL MOUNTING: PROVIDE 3 BEAMS FOR ATTACHMENT PER GOAL.
(PE-2)	<b>GYMNASIUM DIVIDER CURTAIN</b> • BASIS OF DESIGN: PORTER 90670000, 9100700X, 10796-00 • 54' LONG FOLD-UP GYM DIVIDER CURTAIN WITH LOWER SECTION OF 18" HIGH SOLID VINYL WITH 4" MESH ABOVE. INCLUDE ALL NECESSARY FITTINGS, PIPE BEAMS, ELECTRIC HOIST OPERATION, CABLES, PULLEY, MOUNTING HARDWARE, & CONTROLLER FOR COMPLETE INSTALLATION. • INCLUDE LINE SHFT SAFETY LOCK. • COLOR: STANDARD, TBD	1 HP - 115V/60HZ SINGLE PHASE DIGITAL KEYPAD CONTROL SYSTEM	STRUCTURAL LOAD PER UNIT: APPROXIMATELY 18LBF MOUNTING: PROVIDE BEAM IN LINE WITH CURTAIN & PROVIDE CROSS-BRACING AS REQUIRED
(PE-3)	<b>VOLLEYBALL FLOOR SLEEVE WITH CHROME COVER AND SECOND-FLOOR ADAPTER</b> • BASIS OF DESIGN: PORTER 06870-200 AND 06879-000 • INDOOR VOLLEYBALL/TENNIS FLOOR SLEEVE FOR GAME POST 3.75" O.D., 3.51" O.D., & 5" DIA. CHROME-PLATED SWIVEL COVER PLATE. • FLOOR SLEEVE TO BE LOCATED 5'-4" FROM COURT LINE, IN ACCORDANCE WITH MANUFACTURER'S RECOMMENDATION. • SLEEVE TO BE INSTALLED IN SLAB BEFORE FINISHED FLOORS ARE IN PLACE. • SECOND FLOOR ADAPTER INCLUDES WELDMENT TO BOLT ON UNDERSIDE OF SECOND FLOOR CONCRETE SLAB WITH CENTER 8" INSIDE DIA. BY 10" LONG SLEEVE TO ACCEPT GROUT FOR CASTING 9" LONG FLOOR SLEEVE INTO NON-SHRINK GROUT FILL. • ATTACH ADAPTER TO SLAB WITH MANUFACTURER'S RECOMMENDED ANCHORS.		
(PE-4)	<b>WALL PADDING</b> • BASIS OF DESIGN: PORTER 4120 • 2" WAINSCOT PADDING w/ BONDED FOAM FILLER. REFER TO ELEVATIONS FOR WIDTHS & HEIGHTS. • WALL ATTACHMENT Z-CLIP ALUMINUM CHANNELS • PROVIDE MOLDED UNITS AS REQUIRED TO ACCOMMODATE ELECTRICAL DEVICES. • COLOR: BLACK		
(PE-5)	<b>PE EQUIPMENT CONTROL SYSTEM</b> • REFER TO SPECIFICATIONS FOR ADDITIONAL INFORMATION • CONTROL SYSTEM THAT ALLOWS OPERATION OF PE EQUIPMENT WITH DIGITAL TOUCHSCREEN CONTROL PAD SYSTEM GIVES THE ABILITY TO CONTROL MULTIPLE BASKETBALL GOALS, DIVIDER CURTAIN, AND FUTURE BATTING CAGES FROM ONE LOCATION. • TO BE LOCATED ON CMU WALL AS SHOWN ON EQUIPMENT PLAN		

NOTE: LOADS ARE APPROXIMATE AND BASED ON THE EQUIPMENT ONLY - NOT DYNAMIC FORCES OR LOADS AT INDIVIDUAL CONNECTION POINTS. ACTUAL LOADING INFORMATION SHOULD BE COORDINATED BETWEEN EQUIPMENT SUPPLIER AND PRE-ENGINEERED METAL BUILDING SUPPLIER.



## RESIDENTIAL APPLIANCE SCHEDULE

PROVIDED AND INSTALLED BY CONTRACTOR

ITEM NO.	ITEM DESCRIPTION	ELEC. FIELD CONNECTION	PLUMB FIELD CONNECTION
(A-1)	<b>REFRIGERATOR WITHOUT ICEMAKER</b> • 28.8 CU FT • FRENCH DOOR • NO DISPENSER • ENERGY STAR QUALIFIED • 70" H x 36" W x 35 1/16" D • COLOR: FINGERPRINT-RESISTANT STAINLESS STEEL • BASIS OF DESIGN: FRIGIDAIRE FRFN2823AS	115V, 60Hz, 15AMP	
(A-2)	<b>ICE MACHINE</b> • PRODUCES 456 LB PER 24 HOURS • AIR-COOLED CONDENSER UNIT • UNIT MAKES 1/2" NUGGET ICE WITH 95% HARDNESS RATING • ICE MAKER IS 22"W X 24"D X 23"H • STORAGE BIN HAS 370LB CAPACITY • STORAGE BIN IS 22"W X 24"D X 4"H • COLOR: STAINLESS STEEL • BASIS OF DESIGN IS SCOTSMAN N422 PRODIGY PLUS NUGGET ICE MACHINE WITH SCOTSMAN S225 STORAGE BIN	115V, 60Hz, 15AMP	X
(A-3)	<b>WHIRLPOOL</b> • 90 GALLON TANK CAPACITY WHIRLPOOL • SEAMLESS WELDED CONSTRUCTION TANK, FABRICATED FROM 304 GAUGE STAINLESS STEEL • INCLUDES 1/2HP ADJUSTABLE TURBINE WITH LOCKING DEVICE • INCLUDES THERMOMETER • INCLUDES 2" COMBINATION DRAIN OVERFLOW AND FILLER SPOUT • 46" L x 24" W x 25" H • COLOR: STAINLESS STEEL WITH SATIN FINISH • BASIS OF DESIGN IS WHITEHALL MANUFACTURING WHS-90-S	115V, 60Hz, 6.9AMP	X

## CASEWORK SCHEDULE

TYPE	NO.	SIZE			DESCRIPTION
		W	D	H	
B	63	3'-0"	2'-0"	2'-10"	BASE UNIT WITH TWO ADJUSTABLE SHELVES AND TWO HINGED DOORS
BS	122	3'-0"	2'-0"	2'-0"	ADULT ADA SINK BASE UNIT WITH A REMOVABLE ACCESS PANEL
D	115	1'-6"	2'-0"	2'-10"	DRAWER UNIT WITH FOUR EQUAL DRAWERS, 4-1/2 INCHES DEEP INSIDE
W	14	1'-6"	1'-2"	2'-6"	WALL UNIT WITH ONE ADJUSTABLE SHELF AND ONE HINGED DOOR
W	44	3'-0"	1'-2"	2'-0"	WALL UNIT WITH ONE ADJUSTABLE SHELF AND TWO HINGED DOORS
W	52	3'-0"	1'-2"	2'-6"	WALL UNIT WITH ONE ADJUSTABLE SHELF AND TWO HINGED DOORS
WDS	4	1'-0"	1'-0"	7'-0"	1 UNIT WIDE SLOTTED WARDROBE WITH FIXED UPPER SHELF, 12 INCH WIDE COAT COMPARTMENT AND A DOUBLE COAT HOOK.
WDS	8	2'-0"	1'-0"	7'-0"	2 UNIT WIDE AND 4 UNIT HIGH CUBBY. BASIS OF DESIGN IS STEVENS CABINET #6292

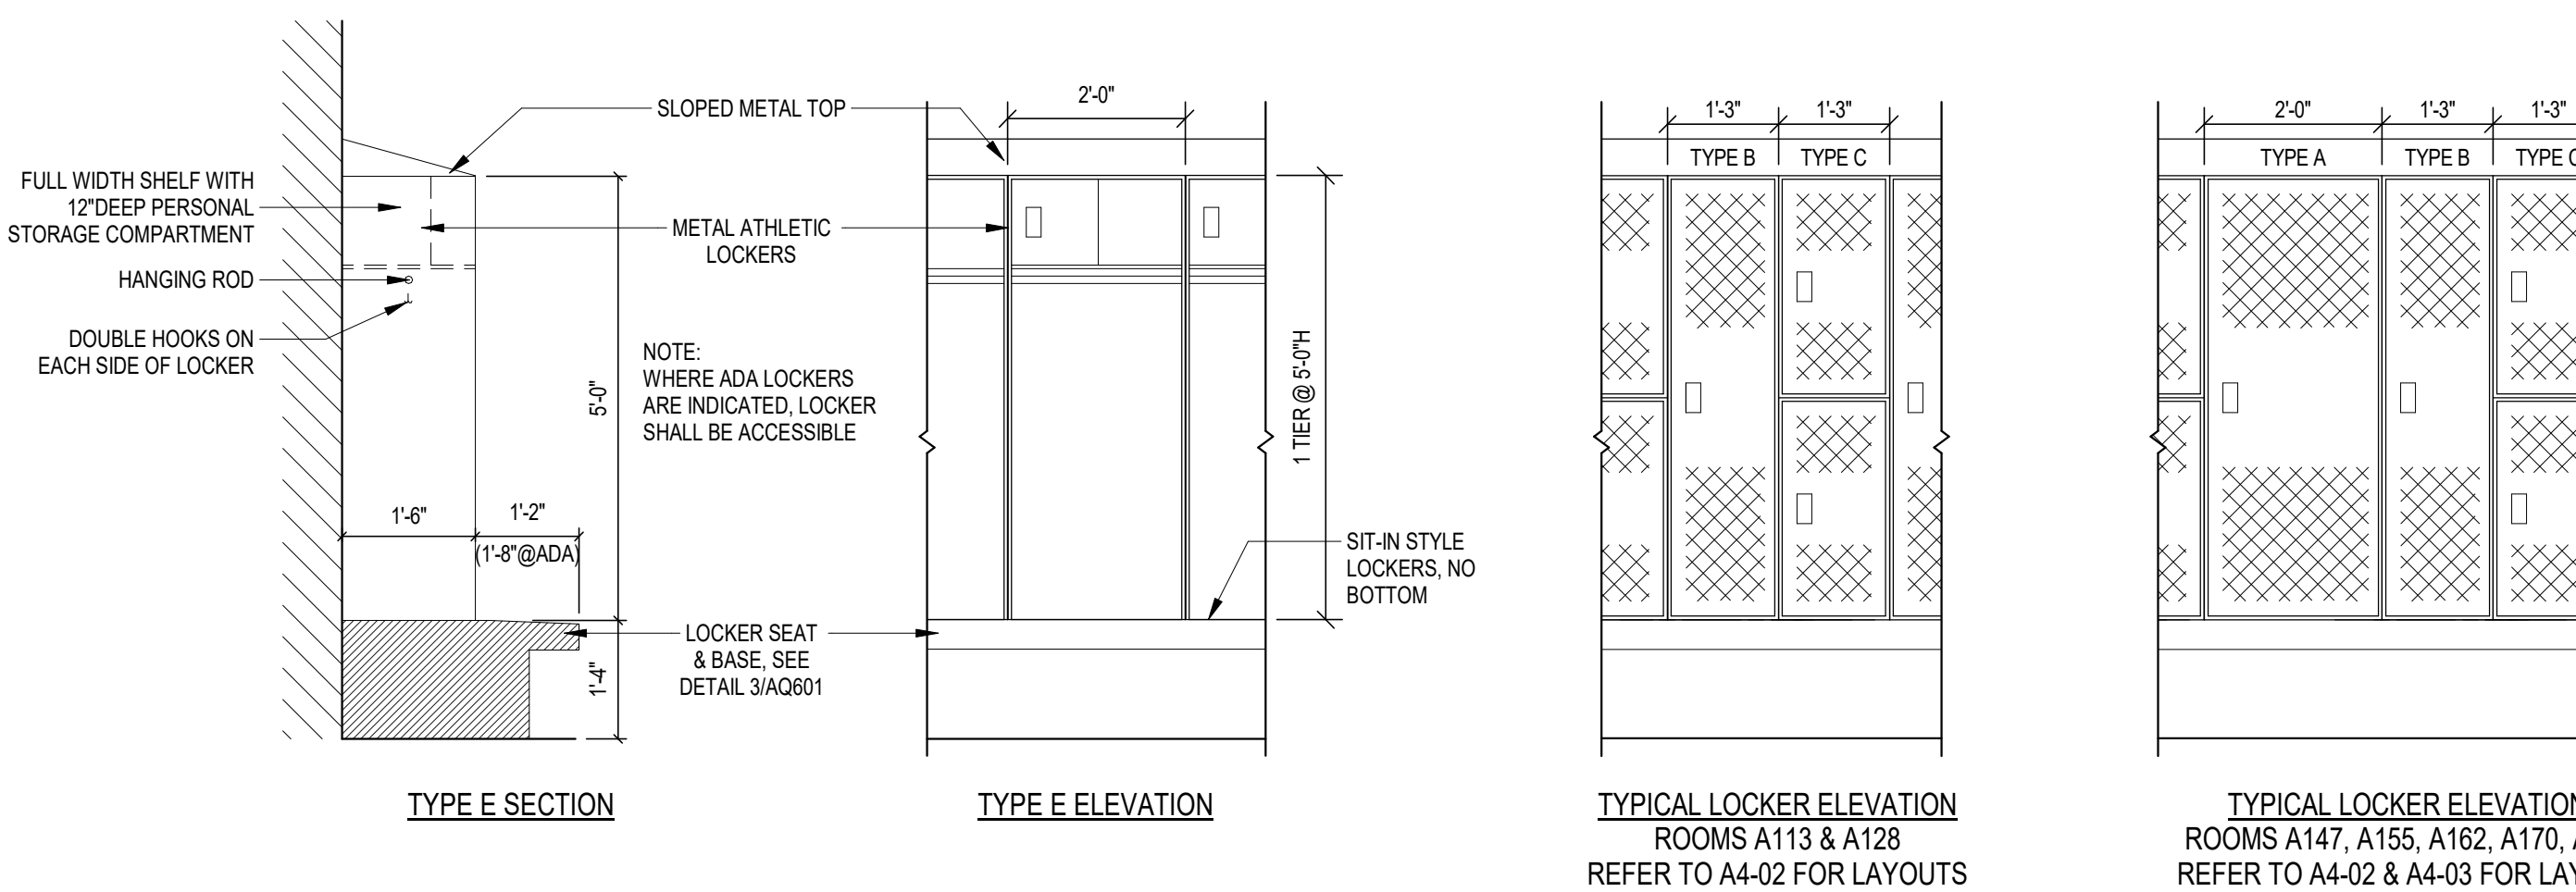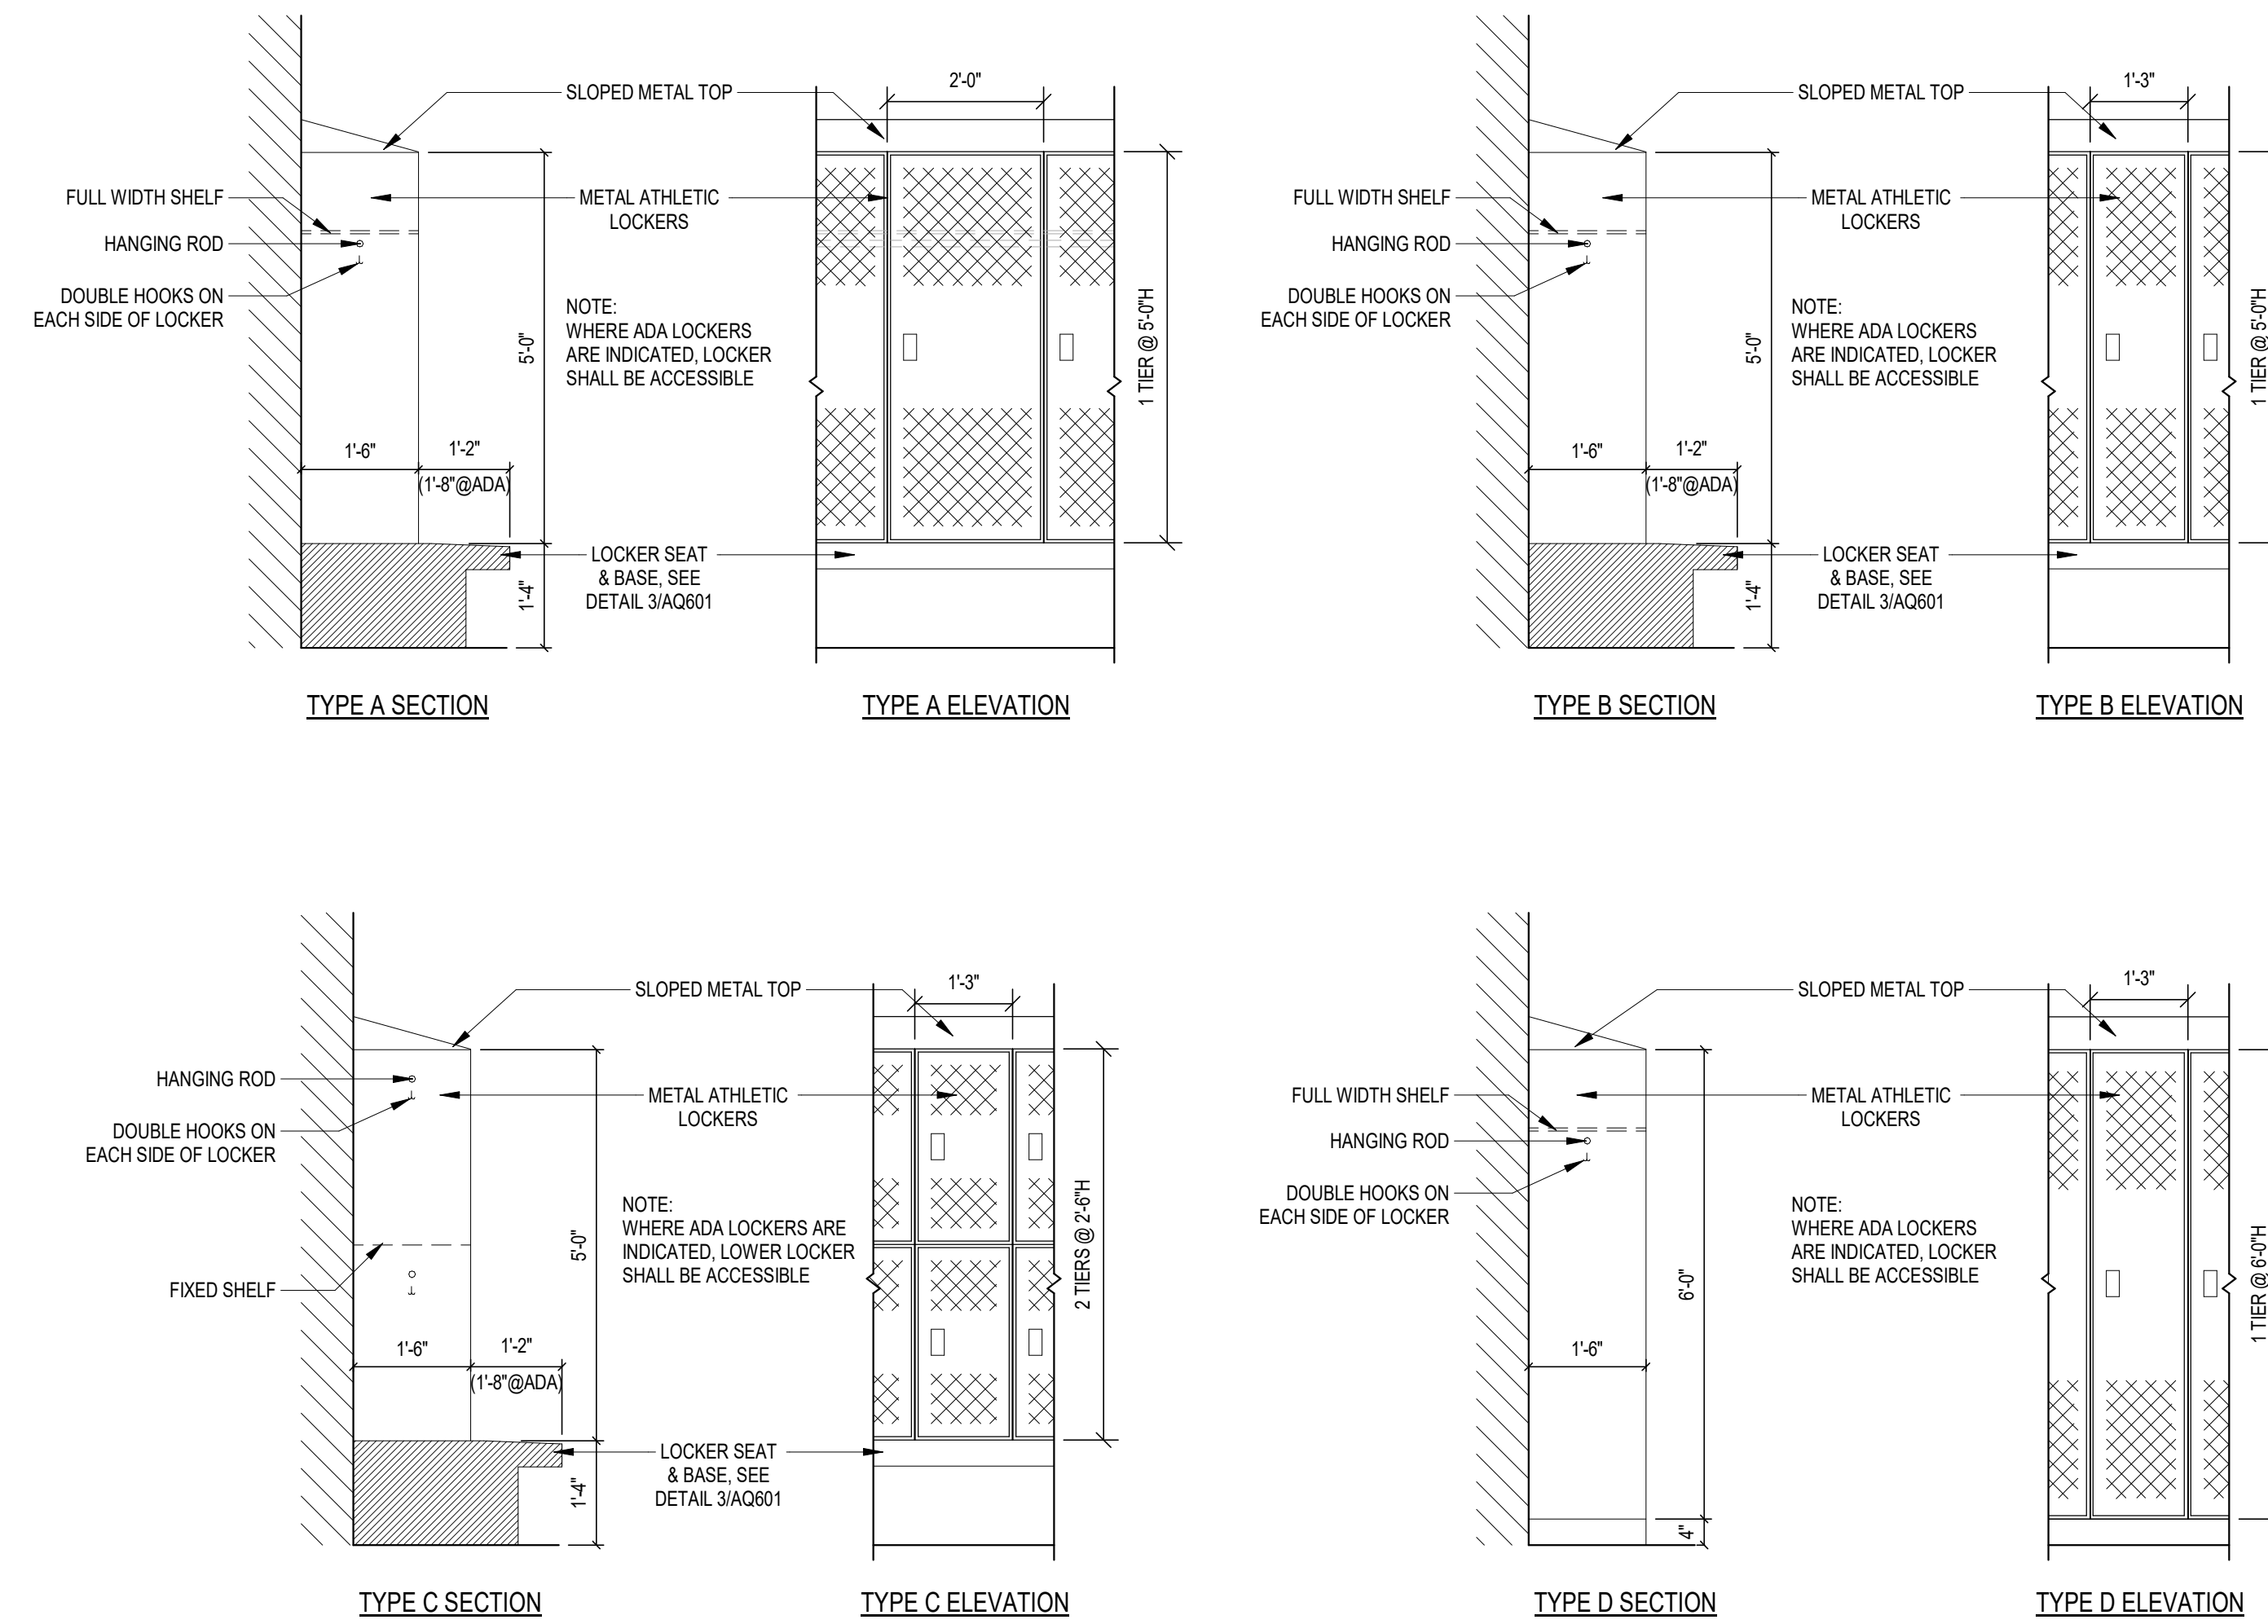


### 2 LOCKER DETAILS

SCALE: 1/2" = 1'-0"

### 3 CONCRETE BENCH SEAT - 18IN DEEP LOCKERS

SCALE: 1 1/2" = 1'-0"

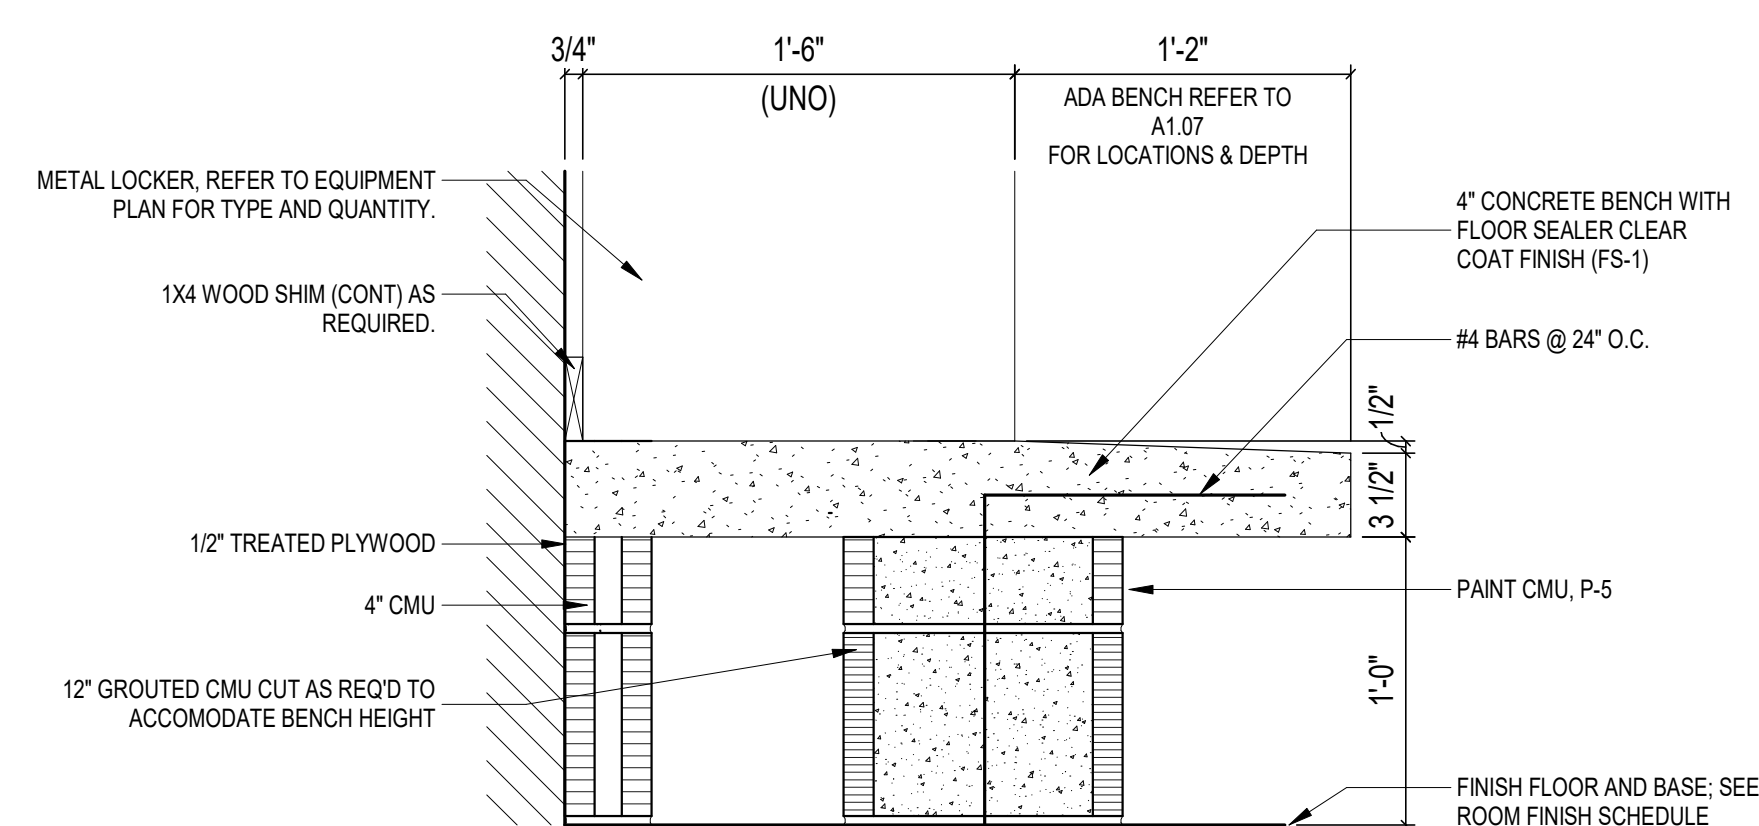







# ZIONSVILLE HS ATHLETIC LOCKER ADDITION

1000 MULBERRY STREET, ZIONSVILLE, IN 46077

## ZIONSVILLE COMMUNITY SCHOOLS




ARCHITECT

# FANNING HOWEY

(800) 452-3573 WWW.FHAI.COM  
900 MULBERRY ST. ZIONSVILLE, IN 46077



ISSUED FOR BID

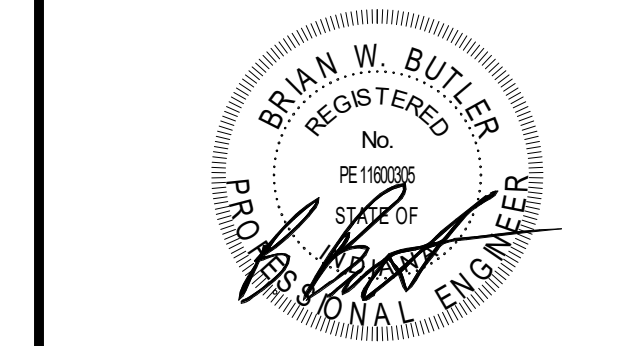

PROJECT MANAGER: JM  
DRAWN BY: RDR  
PROJECT NUMBER: 224018.00  
PROJECT ISSUE DATE: 01/21/2025

REV. NO.	DESCRIPTION	DATE
1	ADDENDUM #1	02/11/2025


### PANELBOARD SCHEDULE - LUMINAIRE SCHEDULE - ONE-LINE DIAGRAM

# E-61

PLAN TYPE	MANUFACTURER/CATALOG	MOUNTING	LAMPS		APPLIED VOLTAGE	DESCRIPTION	VA LOAD		
			NO.	WATTS					
LD61	HALO HCB SERIES LITHONIA LDN6 SERIES PRESCOLITE LF6LED SERIES	RECESSED	1	22 W	LED	1500 lm	277 V	8-INCH ROUND APERTURE OPEN REFLECTOR LED DOWNLIGHT, MEDIUM DISTRIBUTION, WHITE SPECULAR FINISH, WHITE FLANGE, SELF-FLANGED, 0-10VDC DIMMING, 4000K, BAR HANGER ACCESSORY, PROVIDE WITH EMERGENCY TRANSFER DEVICE.	22 VA
LD61X	HALO HCB SERIES LITHONIA LDN6 SERIES PRESCOLITE LF6LED SERIES	RECESSED	1	22 W	LED	1500 lm	277 V	8-INCH ROUND APERTURE OPEN REFLECTOR LED DOWNLIGHT, MEDIUM DISTRIBUTION, WHITE SPECULAR FINISH, WHITE FLANGE, SELF-FLANGED, 0-10VDC DIMMING, 4000K, BAR HANGER ACCESSORY, PROVIDE WITH EMERGENCY TRANSFER DEVICE.	22 VA
LDW61	LITHONIA LDN6 SERIES PRESCOLITE LF6LED SERIES PORTFOLIO LD66 SERIES	RECESSED	1	8 W	LED	1000 lm	277 V	6-INCH ROUND APERTURE LED SHOWER LIGHT WITH REGRESSED LENS REFLECTOR, WHITE REFLECTOR AND TRIM, SELF-FLANGED, IP65 WET LOCATION LISTED.	8 VA
LDW61X	LITHONIA LDN6 SERIES PRESCOLITE LF6LED SERIES PORTFOLIO LD66 SERIES	RECESSED	1	8 W	LED	1000 lm	277 V	6-INCH ROUND APERTURE LED SHOWER LIGHT WITH REGRESSED LENS REFLECTOR, WHITE REFLECTOR AND TRIM, SELF-FLANGED, IP65 WET LOCATION LISTED, PROVIDE WITH EMERGENCY TRANSFER DEVICE.	8 VA
LE1X	LITHONIA WSR LED SERIES MCGRAW EDISON IMPACT SERIES	SURFACE WALL	1	34 W	LED	3900 lm	277 V	HALF-CYLINDER LED WALL MOUNTED LUMINAIRE WITH DIE CAST ALUMINUM HOUSING, BOTTOM DIFFUSER FLUSH WITH THE DIE CASTING, TYPE 3 DISTRIBUTION, 70 CRI LEADS, LUMINAIRE COLOR: DARK BRONZE, MOUNT ONTO JUNCTION BOX, PROVIDE WITH INTEGRAL COLD WEATHER EMERGENCY BATTERY PACK AND INTEGRAL PHOTOCELL AT OUT BUILDINGS.	38 VA
LF2	LITHONIA CPX SERIES EATON METALUX CGT SERIES COLUMBIA CPP SERIES	RECESSED	1	36 W	LED	4000 lm	277 V	2 BY 4-FOOT, BACK LIT FLAT PANEL WITH ALUMINUM FRAME, 4000K, 80+ CRI, 0-10V DIMMING, PROVIDE WITH EMERGENCY TRANSFER DEVICE.	36 VA
LF2X	LITHONIA CPX SERIES EATON METALUX CGT SERIES COLUMBIA CPP SERIES	RECESSED	1	36 W	LED	4000 lm	277 V	2 BY 4-FOOT, BACK LIT FLAT PANEL WITH ALUMINUM FRAME, 4000K, 80+ CRI, 0-10V DIMMING, PROVIDE WITH EMERGENCY TRANSFER DEVICE.	36 VA
LF3	LITHONIA CPX SERIES EATON METALUX CGT SERIES COLUMBIA CPP SERIES	RECESSED	1	47 W	LED	4800 lm	277 V	2 BY 4-FOOT BACK LIT FLAT PANEL WITH ALUMINUM FRAME, 10% DIMMING, 4000K.	47 VA
LF3X	LITHONIA CPX SERIES EATON METALUX CGT SERIES COLUMBIA CPP SERIES	RECESSED	1	47 W	LED	4800 lm	277 V	2 BY 4-FOOT BACK LIT FLAT PANEL WITH ALUMINUM FRAME, 10% DIMMING, 4000K, PROVIDE WITH EMERGENCY TRANSFER DEVICE.	47 VA
LFW1	LITHONIA EPANL SERIES EATON METALUX 24 FP SERIES COLUMBIA CPP SERIES	RECESSED	1	39 W	SOLID STATE LED	4400 lm	277 V	1 BY 4-FOOT BACK LIT FLAT PANEL WITH ALUMINUM FRAME, 10% DIMMING, LISTED FOR WET LOCATIONS, IP65 RATED, NSF LISTED, FLANGE KIT	39 VA
LFW1X	LITHONIA EPANL SERIES EATON METALUX 24 FP SERIES COLUMBIA CPP SERIES	RECESSED	1	39 W	SOLID STATE LED	4400 lm	277 V	1 BY 4-FOOT BACK LIT FLAT PANEL WITH ALUMINUM FRAME, 10% DIMMING PROVIDE WITH EMERGENCY TRANSFER DEVICE, LISTED FOR WET LOCATIONS, IP65 RATED, NSF LISTED, FLANGE KIT	39 VA
LH18	METALUX OHB SERIES LITHONIA IBG SERIES COLUMBIA PEL SERIES	SUSPENDED	1	133 W	LED	18000 lm	277 V	RECTANGULAR LED HIGH BAY, GENERAL DISTRIBUTION, FROSTED ACRYLIC LENSES, 0-10VDC DIMMING, PROVIDE WITH WIRE GUARD, ALL MOUNTING HARDWARE AND ACCESSORIES FOR AIRCRAFT CABLE SUSPENSION.	133 VA
LH18X	METALUX OHB SERIES LITHONIA IBG SERIES COLUMBIA PEL SERIES	SUSPENDED	1	133 W	LED	18000 lm	277 V	RECTANGULAR LED HIGH BAY, GENERAL DISTRIBUTION, FROSTED ACRYLIC LENSES, 0-10VDC DIMMING, PROVIDE WITH WIRE GUARD ALL MOUNTING HARDWARE AND ACCESSORIES FOR AIRCRAFT CABLE SUSPENSION, PROVIDE WITH EMERGENCY TRANSFER DEVICE.	133 VA
LR2	METALUX WNL0D SERIES LITHONIA SBL SERIES COLUMBIA LAW SERIES	SUSPENDED	1	48 W	LED	4000 lm	277 V	4-FOOT LED WRAP AROUND FIXTURE, ACRYLIC PRISMATIC DIFFUSER, 0-10VDC DIMMING, IF SUSPENDED, INSTALL AT 10-FOOT AFF WITH CONDUIT STEMS (UNO), 4000K	27 VA
LR2X	METALUX WNL0D SERIES LITHONIA SBL SERIES COLUMBIA LAW SERIES	SUSPENDED	1	48 W	LED	4000 lm	277 V	4-FOOT LED WRAP AROUND FIXTURE, ACRYLIC PRISMATIC DIFFUSER, 0-10VDC DIMMING, PROVIDE WITH EMERGENCY TRANSFER DEVICE, IF SUSPENDED, INSTALL AT 10-FOOT AFF WITH CONDUIT STEMS (UNO), 4000K	27 VA
XC	SURE-LITES CX SERIES LITHONIA SIGNATURE SERIES DUAL-LITE SEMBRA SERIES	SURFACE CEILING	1	3 W	RED LED	0 lm	277 V	CAST ALUMINUM CAS ONLY EXIT SIGN, SINGLE FACE, DIRECTIONAL ARROWS INDICATED, BLACK HOUSING, REFER TO PROJECT MANUAL FOR ADDITIONAL REQUIREMENTS.	3 VA
XVW	SURE-LITES UX SERIES CHLORIDE 60 LINE SERIES LITHONIA LV SERIES DUAL-LITE SEWLL SERIES	SURFACE WALL	1	3 W	RED LED	0 lm	277 V	CAST ALUMINUM, VANDAL-RESISTANT CAS ONLY EXIT SIGN, SINGLE FACE, DIRECTIONAL ARROWS INDICATED, WHITE HOUSING, LISTED FOR WET LOCATIONS, REFER TO PROJECT MANUAL FOR ADDITIONAL REQUIREMENTS.	3 VA
XW	SURE-LITES CX SERIES LITHONIA SIGNATURE SERIES DUAL-LITE SEMBRA SERIES	SURFACE WALL	1	3 W	RED LED	0 lm	277 V	CAST ALUMINUM CAS ONLY EXIT SIGN, SINGLE FACE, DIRECTIONAL ARROWS INDICATED, BLACK HOUSING, REFER TO PROJECT MANUAL FOR ADDITIONAL REQUIREMENTS.	3 VA

### LUMINAIRE SCHEDULE - GENERAL NOTES

- SEE SPECIFICATIONS FOR DRIVER REQUIREMENTS
- FOR ALL DOWNLIGHTING FIXTURES, PROVIDE REQUIRED MOUNTING HARDWARE FOR MOUNTING IN LAY-IN TYPE CEILING.
- CONTRACTOR TO VERIFY TYPES AND QUANTITY OF LIGHT FIXTURES REQUIRING EMERGENCY TRANSFER DEVICES AND PROVIDE REQUIRED QUANTITY OF EMERGENCY TRANSFER DEVICES, LABOR, MATERIAL, ETC. IN THE PROJECT BID FOR FIELD INSTALLATION OF EMERGENCY TRANSFER DEVICES.
- LIGHT FIXTURE SUBMITTALS TO INCLUDE DATA SHEETS FOR ALL FIXTURE TYPES, INCLUDING ADDITIONAL DATA SHEETS FOR DRIVER COMBINATIONS REQUIRED TO MEET THE INSTALLATION REQUIREMENTS OF THE VARIOUS FIXTURE TYPES INDICATED IN THE REMARKS COLUMN OF THE FIXTURE SCHEDULES OR ON THE DRAWINGS. SUBMITTALS SHALL ALSO INDICATE COLOR FOR ANY CUSTOM COLOR LIGHT FIXTURES.
- COLOR TEMPERATURE FOR ALL LIGHT FIXTURES IS TO BE 4,000K UNLESS NOTED OTHERWISE

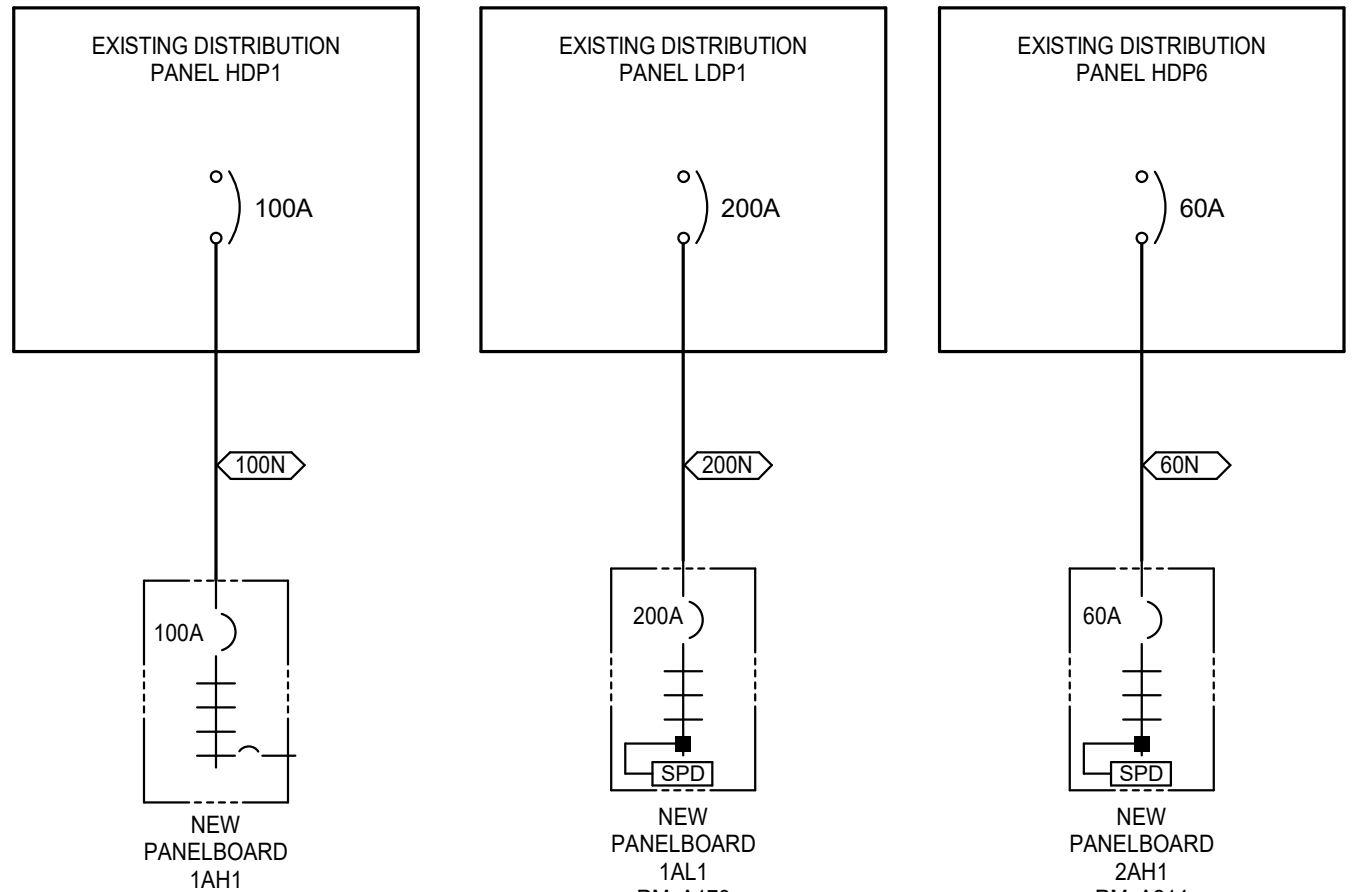

ONE-LINE DIAGRAMS NO SCALE

### Branch Panel: 1AH1

Location: A173  
Supply From: Exit\_HDP1  
Mounting: Surface  
Enclosure: Type 1

Volts: 480/277 Wye  
Phases: 3  
Wires: 4

A.I.C. Rating:  
Mains Type: MLO  
Mains Rating: 100 A  
MCB Rating: 100 A

Notes: INTEGRAL SURGE PROTECTION

CKT	Circuit Description	Trip	Poles	A (VA)	B (VA)	C (VA)	Poles	Trip	Circuit Description	CKT
1	LIGHTING RM. A130, A141, A142, A173, A174...	20 A	1	1553	1638			1	LIGHTING RM. A158-A172	2
3	LIGHTING RM. A143-A157	20 A	1		1632	0		1	Spare	4
5	Spare	20 A	1			0	0	1	20 A	5
7	Spare	20 A	1	0	0			1	20 A	8
9	Spare	20 A	1		0	0		1	20 A	10
11	Spare	20 A	1		0	0		1	20 A	12
13	Spare	20 A	1	0	0			1	20 A	14
15	Spare	20 A	1		0	0		1	20 A	16
17	Spare	20 A	1			0	0	1	20 A	18
19	Spare	20 A	1	0	0			1	20 A	20
21	Spare	20 A	1		0	0		1	20 A	22
23	Spare	20 A	1		0	0		1	20 A	24
25	Spare	20 A	1	0	0			1	20 A	26
27	Spare	20 A	1			0	0	1	20 A	28
29	Spare	20 A	1			0	0	1	20 A	30
				<b>Total Load:</b>	3191 VA	1632 VA	0 VA			
				<b>Total Amps:</b>	12 A	7 A	0 A			

Legend:

Load Classification	Connected Load	Demand Factor	Estimated Demand	Panel Totals
Lighting	4823 VA	100.00%	4823 VA	
				<b>Total Conn. Load:</b> 4823 VA
				<b>Total Est. Demand:</b> 4823 VA
				<b>Total Conn.:</b> 6 A
				<b>Total Est. Demand:</b> 6 A

### Branch Panel: 1AL1

Location: A173  
Supply From: T-1  
Mounting: Surface  
Enclosure: Type 1

Volts: 208/120 Wye  
Phases: 3  
Wires: 4


A.I.C. Rating:  
Mains Type: M.C.B  
Mains Rating: 200 A  
MCB Rating: 200 A

Notes: INTEGRAL SURGE PROTECTION

CKT	Circuit Description	Trip	Poles	A	B	C	Poles	Trip	Circuit Description	CKT
1	W.C. RM. A201	20 A	1	180	1080			1	RECEPTS RM. A202, A203, A212, A213	2
3	RECEPTS RM. A201	20 A	1		1260	439		1	PUH, EPS RM. A201, A203	4
5	RECEPTS RM. A201	20 A	1			1260	720	1	T.T.B. RM. A213	6
7	W.C. RM. A201	20 A	1	180	180			1	TECH RACK RM. A213	8
9	RECEPTS RM. A205-A209	20 A	1		1260	360		1	TECH RACK RM. A213	10
11	VVR-12 RM. A207	20 A	1			0	180	1	SCOREBOARD RM. A201	12
13	BACKSTOP RM. A201	30 A	1	230	230			1	BACKSTOP RM. A201	14
15	DIVIDER CURTAIN RM. A201	30 A	1		230	180		1	VIDEO PROJECTOR RM. A201	16
17	PROJECTION SCREEN RM. A201	20 A	1			230	1127	1	AUTOMATIC DOOR OPENER RM. A175	18
19	CUH-A1 RM. A175 EF, RM A166 EF, RM A170	20 A	1	1439	0			1	VVRS	20
21	RECEPTS RM. A175, S1	20 A	1		1260	0		1	VVRS	22
23	RECEPTS RM. A130, A173, A174	20 A	1			1080	720	1	T.T.B. RM A174	24
25	TECH RACK RM. A174	20 A	1	180	360			1	TECH RACK RM. A174	26
27	RECEPTS RM. A165, A166, A170, A171	20 A	1		900	1890		1	RECEPTS RM. A167	28
29	W.C. RM. A158, A160	20 A	1			360	1890	1	RECEPTS RM. A159	30
31	RECEPTS RM. A158, A161-A164	20 A	1	900	360			1	W.C. RM. A143, A151	32
33	RECEPTS RM. A151, A154-A156	20 A	1		1080	1890		1	RECEPTS RM. A152	34
35	RECEPTS RM. A143, A146-A148, A150	20 A	1		1260	1890		1	RECEPTS RM. A144	36
37	AUTOMATIC DOOR OPERATOR RM. A141	20 A	1	1127	1260			1	RECEPTS RM. A141	38
39	RECEPTS RM. A142	20 A	1		1080	1080		1	RECEPTS RM. A176, A178	40
41	RECEPTS RM. A176	20 A	1			1260	1620	1	RECEPTS RM. A177	42
43	RECEPTS RM. A176, A179	20 A	1	1080	180			1	WHIRLPOOL RM. A176	44
45	REFRIG. RM. A176	20 A	1		1000	180		1	WHIRLPOOL RM. A176	46
47	ICE MAKER RM. A176	20 A	1			180	1440	1	RECEPTS RM. A121	48
49	RECEPTS RM. A122, A123, A128, A130, A140	20 A	1	1260	1080			1	RECEPTS RM. A112, A126, A134, A135, A137...	50
51	W.C. RM. A109, A124	20 A	1		360	900		1	RECEPTS RM. A105, A116-A120	52
53	RECEPTS RM. A108	20 A	1			1440	1440	1	RECEPTS RM. A107-A109, A113-A115, A131...	54
55	Spare	20 A	1	0	0			1	Spare	56
57	Spare	20 A	1		0	0		1	20 A	58
59	Spare	20 A	1		0	0		1	20 A	60
61	Spare	20 A	1	0	0			1	20 A	62
63	Spare	20 A	1		0	0		1	20 A	64
65	Spare	20 A	1		0	0		1	20 A	66
67	Spare	20 A	1	0	0			1	20 A	68
69	Spare	20 A	1		0	0		1	20 A	70
71	Spare	20 A	1		0	0		1	20 A	72
				<b>Total Load:</b>	11306 VA	15349 VA	18097 VA			
				<b>Total Amps:</b>	94 A	133 A	156 A			

Legend:


Load Classification	Connected Load	Demand Factor	Estimated Demand	Panel Totals
Motor	5052 VA	105.58%	5334 VA	
Other	0 VA	0.00%	0 VA	
Receptacle - Convenience	1620 VA	100.00%	1620 VA	
Receptacle	37360 VA	50.00%	18680 VA	
Receptacle - Special	720 VA	80.00%	576 VA	
				<b>Total Conn. Load:</b> 44752 VA
				<b>Total Est. Demand:</b> 26210 VA
				<b>Total Conn.:</b> 124 A
				<b>Total Est. Demand:</b> 73 A

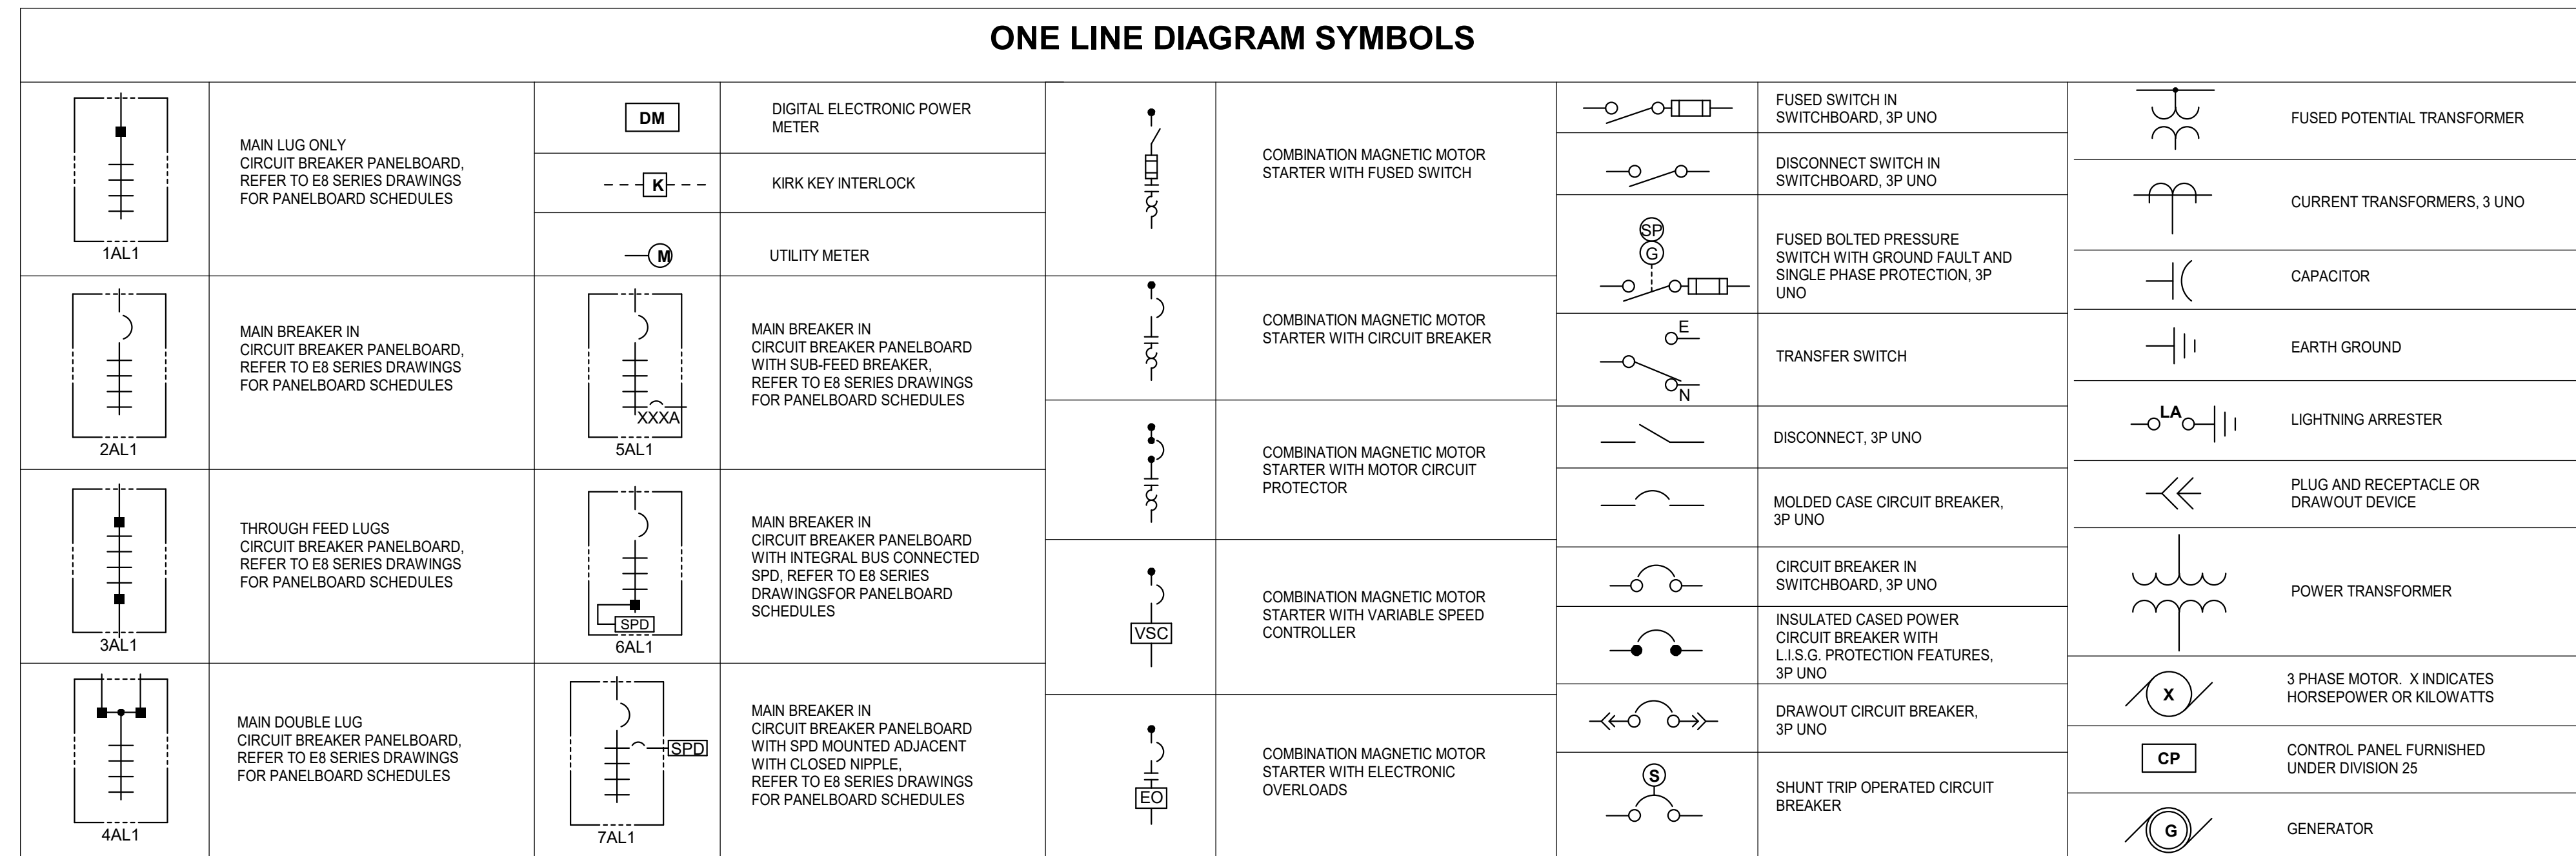



**GENERAL NOTES - DEMOLITION**

1. REFER TO ELECTRICAL SPECIFICATIONS SECTIONS 26000'S "ELECTRICAL DEMOLITION" FOR ADDITIONAL REQUIREMENTS THAT APPLY TO THIS DRAWING SHEET.
2. REMOVE ELECTRICAL EQUIPMENT COMPLETE.

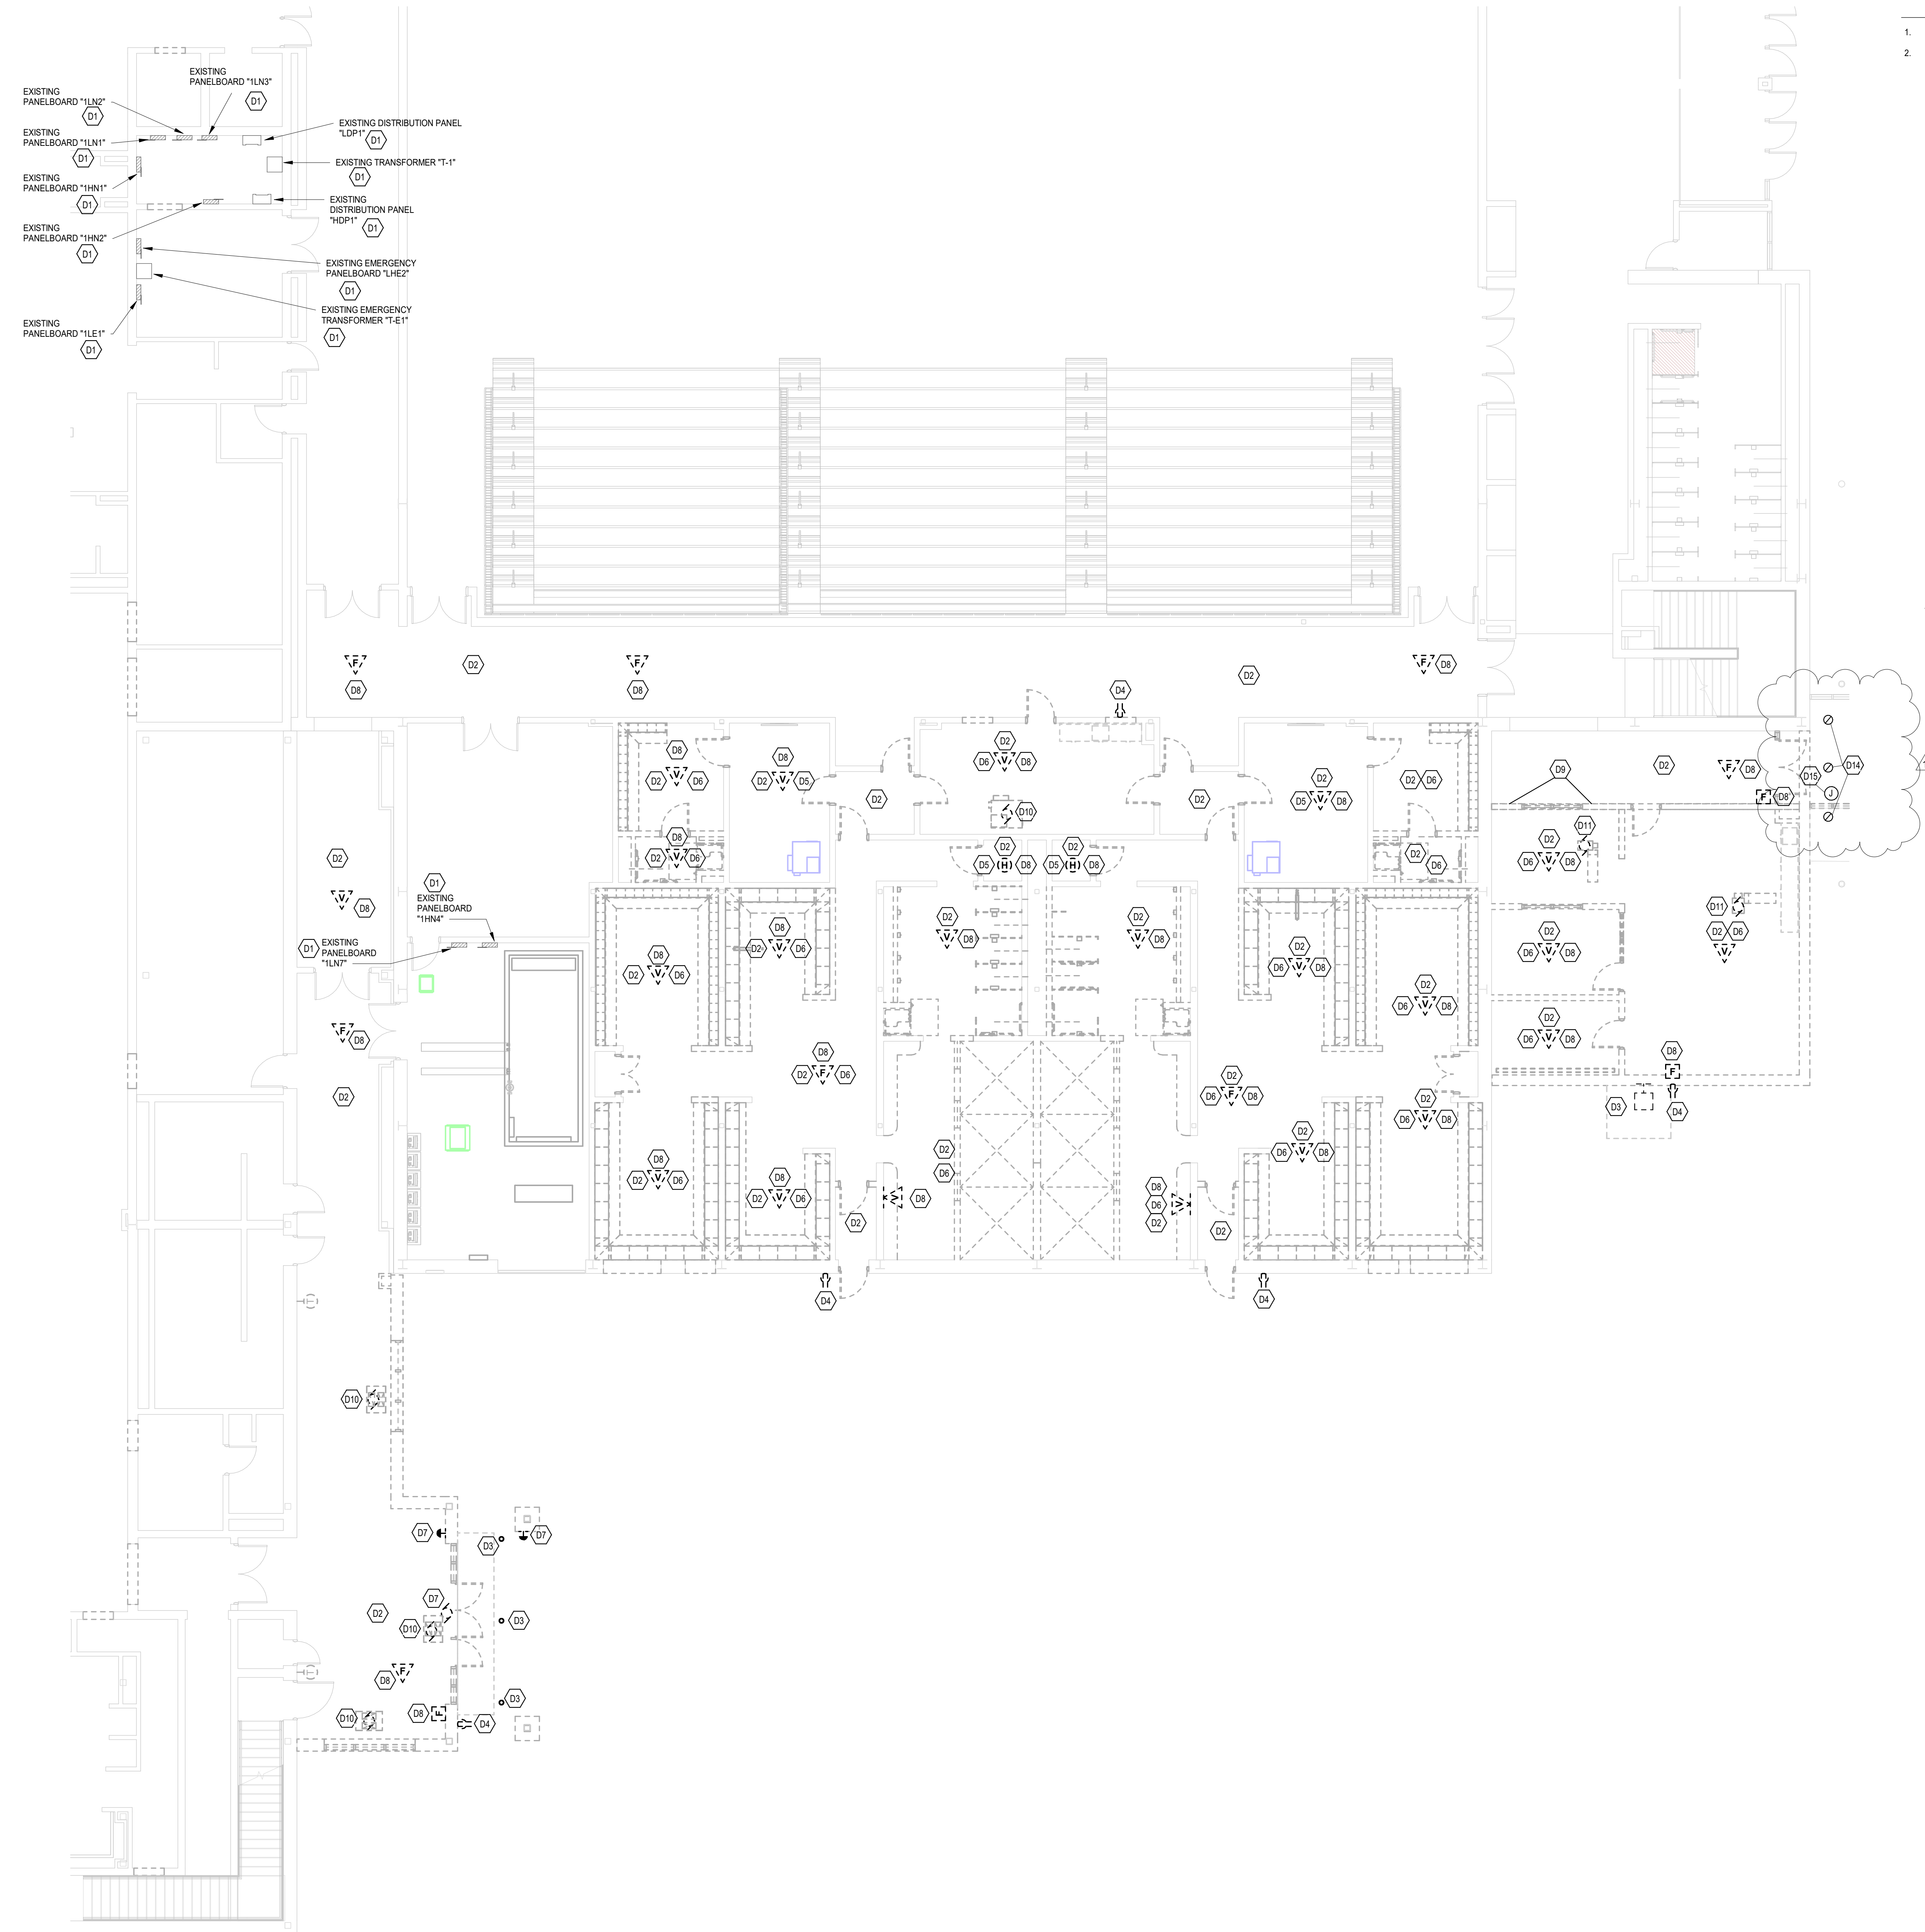

KEYNOTES	
D1	EXISTING ELECTRICAL EQUIPMENT TO REMAIN IN PLACE.
D2	DISCONNECT AND REMOVE EXISTING LIGHT FIXTURES AND LIGHT SWITCHES IN THIS ROOM. EXISTING LIGHTING CIRCUITS ARE TO REMAIN IN PLACE FOR NEW LIGHTING. REFER TO THE LIGHTING PLAN DRAWING SHEETS FOR ADDITIONAL REQUIREMENTS.
D3	DISCONNECT AND REMOVE EXISTING EXTERIOR LIGHT FIXTURE AT THIS LOCATION. EXISTING CIRCUITRY IS TO BE EXTENDED TO NEW EXTERIOR LIGHT FIXTURE(S). REFER TO THE LIGHTING PLAN DRAWING SHEETS FOR ADDITIONAL REQUIREMENTS.
D4	DISCONNECT AND REMOVE EXISTING ELECTRICAL DEVICE AT THIS LOCATION.
D5	DISCONNECT AND REMOVE EXISTING DUPLEX RECEPTACLES IN THIS ROOM AND REPLACE WITH NEW DUPLEX RECEPTACLES MOUNTED IN THE EXISTING BACK BOX AND WIRE TO THE EXISTING CIRCUITS.
D6	DISCONNECT AND REMOVE ALL EXISTING ELECTRICAL DEVICES IN THIS ROOM.
D7	DISCONNECT AND REMOVE POWER FROM THE EXISTING AUTOMATIC DOOR OPERATOR.
D8	EXISTING FIRE ALARM DEVICE AT THIS LOCATION IS TO BE DISCONNECTED AND REMOVED, THEN REINSTALLED. REFER TO THE FIRE ALARM DRAWING SHEETS FOR NEW LOCATION AND ADDITIONAL REQUIREMENTS.
D9	DISCONNECT AND REMOVE ALL EXISTING ELECTRICAL DEVICES IN THIS PORTION OF THE EXISTING WALL THAT IS TO BE REMOVED.
D10	DISCONNECT AND REMOVE FEEDERS AND CONDUIT TO EXISTING MECHANICAL EQUIPMENT THAT IS BEING REMOVED.
D11	EXISTING MECHANICAL UNIT IS TO BE RELOCATED. EXTEND EXISTING CIRCUITRY TO NEW LOCATION. REFER TO SHEET "EP-11" FOR NEW LOCATION.
D14	EXISTING LIGHT FIXTURE IS TO BE DISCONNECTED AND REMOVED FOR THE DEMOLITION WORK IN THIS AREA. THEN ARE TO BE REINSTALLED IN THE SAME LOCATION WHEN NEW WORK IS BEING COMPLETED.
D15	DISCONNECT AND REMOVE CONDUITS AND JUNCTION BOX AT THIS LOCATION FOR THE EXISTING DOOR SECURITY DEVICES.

**FIRST FLOOR ELECTRICAL DEMOLITION PLAN**  
SCALE: 1/8" = 1'-0"

**ZIONSVILLE HS  
ATHLETIC LOCKER  
ADDITION**

1000 MULBERRY STREET,  
ZIONSVILLE, IN 46077

ZIONSVILLE COMMUNITY  
SCHOOLS




ZIONSVILLE  
COMMUNITY SCHOOLS

ARCHITECT




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KEY PLAN

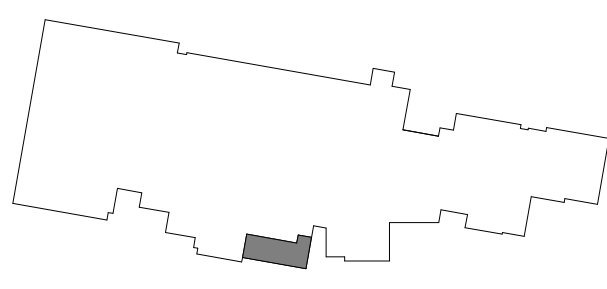ISSUED FOR BID



PROJECT MANAGER: JM  
DRAWN BY: RDR  
PROJECT NUMBER: 224018.00  
PROJECT ISSUE DATE: 01/21/2025

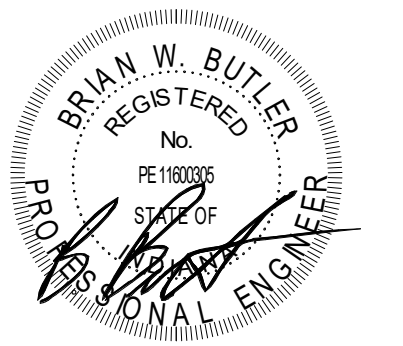REV. NO.	DESCRIPTION	DATE
1	ADDENDUM #1	02/11/2025

FIRST FLOOR ELECTRICAL  
DEMOLITION PLAN


**ED-11**



**GENERAL NOTES - DEMOLITION**

1. REFER TO ELECTRICAL SPECIFICANTS SECTIONS 260005 "ELECTRICAL DEMOLITION" FOR ADDITIONAL REQUIREMENTS THAT APPLY TO THIS DRAWING SHEET.
2. REMOVE ELECTRICAL EQUIPMENT COMPLETE.

KEYNOTES	
D4	DISCONNECT AND REMOVE EXISTING ELECTRICAL DEVICE AT THIS LOCATION.
D9	DISCONNECT AND REMOVE ALL EXISTING ELECTRICAL DEVICES IN THIS PORTION OF THE EXISTING WALL THAT IS TO BE REMOVED.
D12	EXISTING WALL MOUNTED EMERGENCY LIGHT FIXTURE IS TO BE RELOCATED. REFER TO DRAWING SHEET EL-12 FOR NEW LOCATION AND ADDITIONAL REQUIREMENTS.
D13	DISCONNECT AND REMOVE EXISTING EXIT SIGN AT THIS LOCATION. EXISTING CIRCUITRY IS TO REMAIN FOR NEW EXIT SIGN ON THE OPPOSITE SIDE OF THE DOORS. REFER TO LIGHTING PLAN ON DRAWING SHEET EL-12 FOR ADDITIONAL REQUIREMENTS.

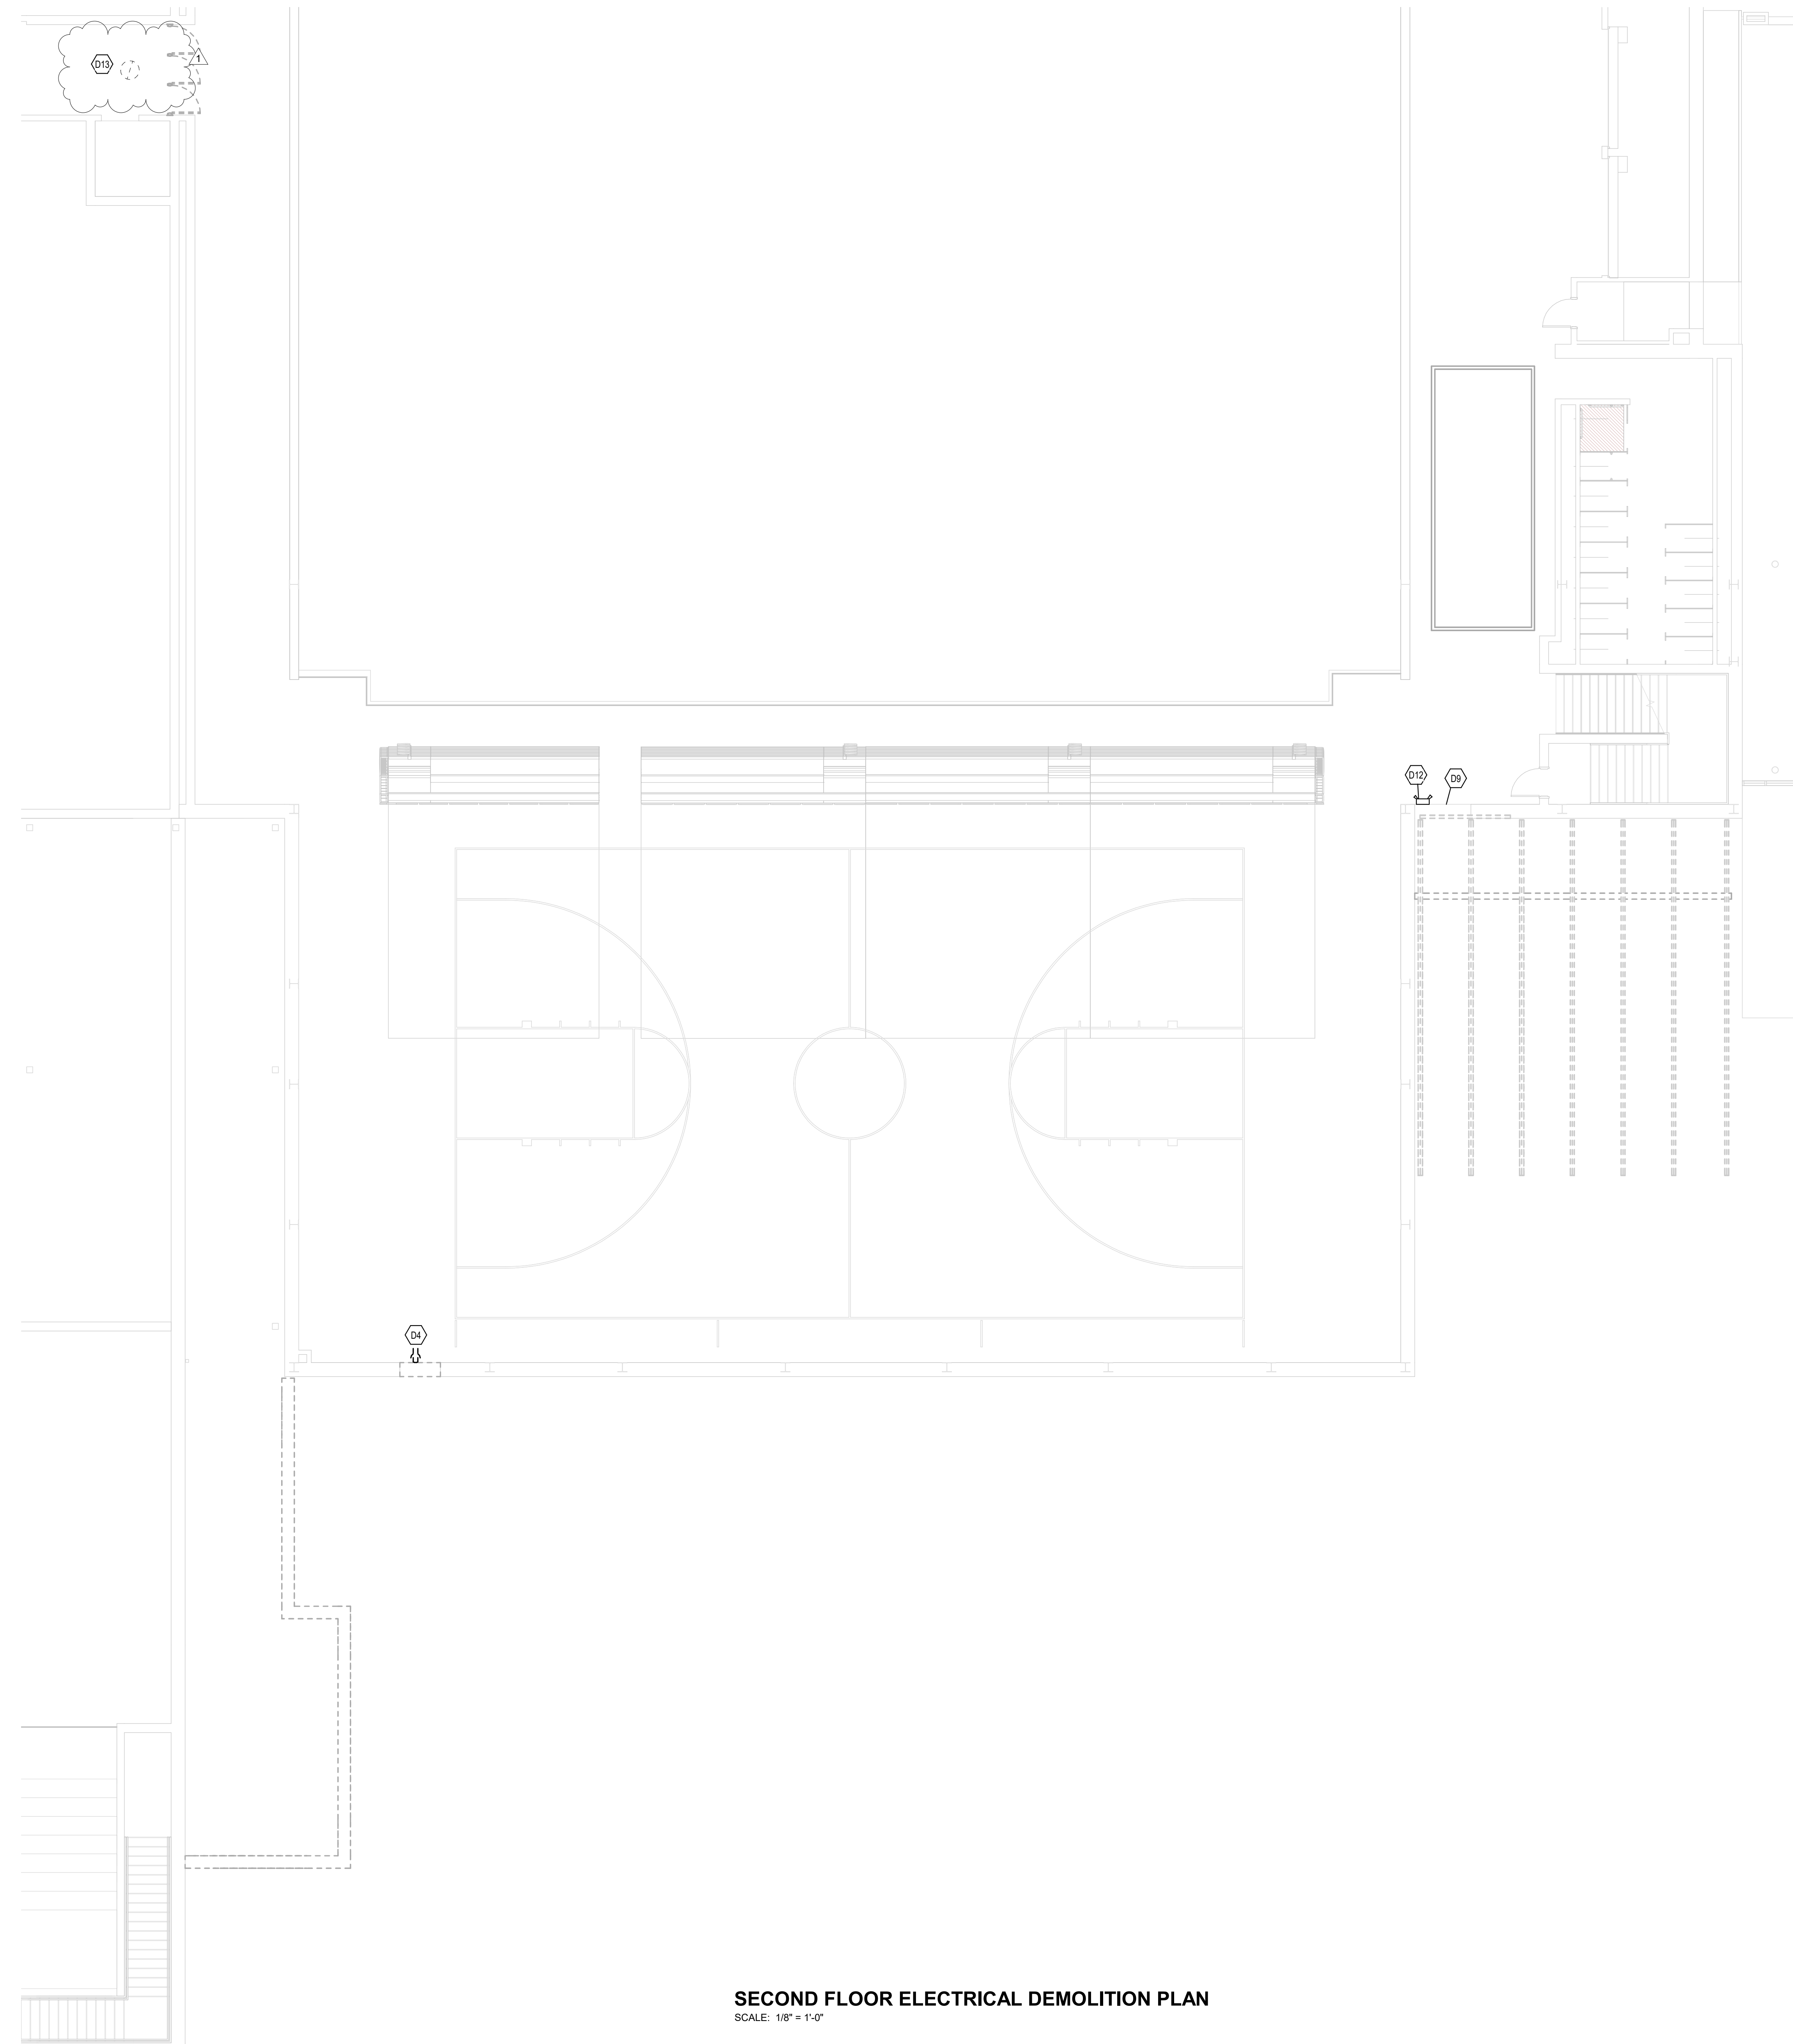

**SECOND FLOOR ELECTRICAL DEMOLITION PLAN**  
SCALE: 1/8" = 1'-0"

**ZIONSVILLE HS  
ATHLETIC LOCKER  
ADDITION**

1000 MULBERRY STREET,  
ZIONSVILLE, IN 46077


ZIONSVILLE COMMUNITY  
SCHOOLS



ARCHITECT




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KEY PLAN 

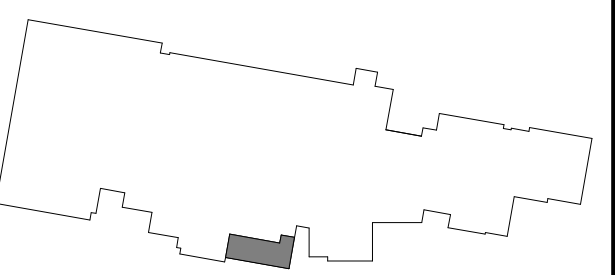ISSUED FOR BID



PROJECT MANAGER: JM  
DRAWN BY: RDR  
PROJECT NUMBER: 224018.00  
PROJECT ISSUE DATE: 01/21/2025

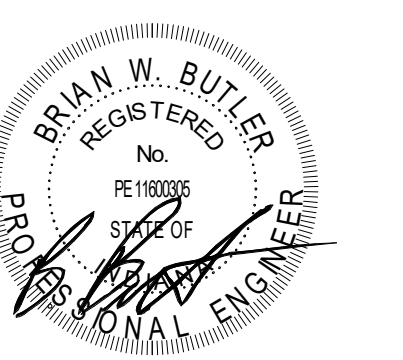REV. NO.	DESCRIPTION	DATE
1	ADDENDUM #1	02/11/2025

SECOND FLOOR ELECTRICAL  
DEMOLITION PLAN

**ED-12**



# ZIONSVILLE HS ATHLETIC LOCKER ADDITION

1000 MULBERRY STREET,  
ZIONSVILLE, IN 46077

ZIONSVILLE COMMUNITY  
SCHOOLS




ZIONSVILLE  
COMMUNITY SCHOOLS

ARCHITECT




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900 MULBERRY ST. ZIONSVILLE, IN 46077

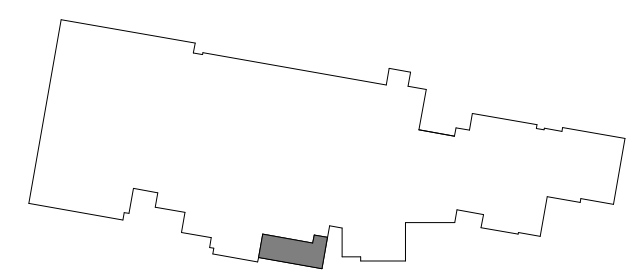

KEY PLAN

ISSUED FOR BID

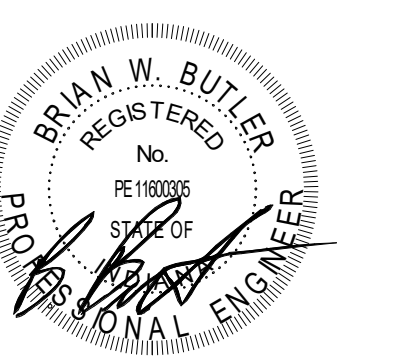

PROJECT MANAGER: JM  
DRAWN BY: RDR  
PROJECT NUMBER: 224018.00  
PROJECT ISSUE DATE: 01/21/2025

REV. NO.	DESCRIPTION	DATE
1	ADDENDUM #1	02/11/2025

FIRST FLOOR FIRE ALARM PLAN

EF-11

ROOM LEGEND - FIRST FLOOR UNIT A		
ROOM NO.	ROOM NAME	AREA (SF)
A101	CORRIDOR	1378 SF
A102	LAUNDRY	515 SF
A103	MECHANICAL	697 SF
A104	VESTIBULE	46 SF
A105	VESTIBULE	60 SF
A106	OFFICE	193 SF
A107	LOCKERS	110 SF
A108	RESTROOM	70 SF
A109	VESTIBULE	129 SF
A110	STORAGE	19 SF
A111	RESTROOM	226 SF
A112	SHOWERS	127 SF
A113	LOCKERS	668 SF
A114	STORAGE	11 SF
A115	SERVICE SINK	34 SF
A116	REF RESTROOM	98 SF
A117	REF RESTROOM	99 SF
A118	STORAGE	66 SF
A119	VESTIBULE	46 SF
A120	VESTIBULE	60 SF
A121	OFFICE	237 SF
A122	LOCKERS	110 SF
A123	RESTROOM	70 SF
A124	VESTIBULE	129 SF
A125	STORAGE	19 SF
A126	RESTROOM	226 SF
A127	SHOWERS	127 SF
A128	LOCKERS	659 SF
A129	STORAGE	10 SF
A130	CORRIDOR	1707 SF
A131	STORAGE	92 SF


ROOM LEGEND - FIRST FLOOR UNIT A		
ROOM NO.	ROOM NAME	AREA (SF)
A132	VESTIBULE	40 SF
A133	VESTIBULE	62 SF
A134	LOCKERS	216 SF
A135	RESTROOM	182 SF
A136	VESTIBULE	62 SF
A137	LOCKERS	216 SF
A138	RESTROOM	182 SF
A139	VESTIBULE	40 SF
A140	STORAGE	Not Placed
A141	LOBBY	396 SF
A142	OPEN OFFICE	305 SF
A143	VESTIBULE	108 SF
A144	OFFICE	250 SF
A145	STORAGE	12 SF
A146	RESTROOM	92 SF
A147	LOCKERS	808 SF
A148	RESTROOM	229 SF
A149	VESTIBULE	44 SF
A150	RESTROOM	66 SF
A151	VESTIBULE	105 SF
A152	OFFICE	249 SF
A153	STORAGE	12 SF
A154	RESTROOM	92 SF
A155	LOCKERS	799 SF
A156	RESTROOM	226 SF
A157	VESTIBULE	44 SF
A158	VESTIBULE	105 SF
A159	OFFICE	249 SF
A160	STORAGE	12 SF
A161	RESTROOM	98 SF
A162	LOCKERS	799 SF
A163	RESTROOM	248 SF
A163	RESTROOM	Not Placed
A164	VESTIBULE	44 SF
A165	RESTROOM	66 SF
A166	VESTIBULE	104 SF
A167	OFFICE	250 SF
A168	STORAGE	12 SF
A169	RESTROOM	86 SF
A170	LOCKERS	794 SF
A171	RESTROOM	248 SF
A172	VESTIBULE	44 SF
A173	ELECTRICAL	55 SF
A174	TECHNOLOGY	46 SF
A175	CORRIDOR	1033 SF
A176	TRAINING	703 SF
A177	OFFICE	178 SF
A178	STORAGE	69 SF
A179	CORRIDOR	251 SF
A180	CORRIDOR	257 SF
A181	VESTIBULE	387 SF

### GENERAL NOTES - FIRE ALARM

- ALL NEW FIRE ALARM DEVICES TO BE CONNECTED TO THE EXISTING FIRE ALARM SYSTEM.
- COORDINATE WITH EXISTING EQUIPMENT. PROVIDE PROGRAMMING AND TESTING AS REQUIRED.
- FIRE ALARM LAYOUT IS SHOWN FOR COVERAGE AREA ONLY. CONTRACTOR SHALL PROVIDE DEVICES AS REQUIRED FOR COMPLETE COVERAGE.

### KEYNOTES

F1	NEW FIRE ALARM DEVICE IS TO BE RATED FOR DAMP LOCATION.
FS	PROVIDE A FIRE ALARM CONNECTION TO THIS SUPERVISORY VALVE WITH TAMPER SWITCH.

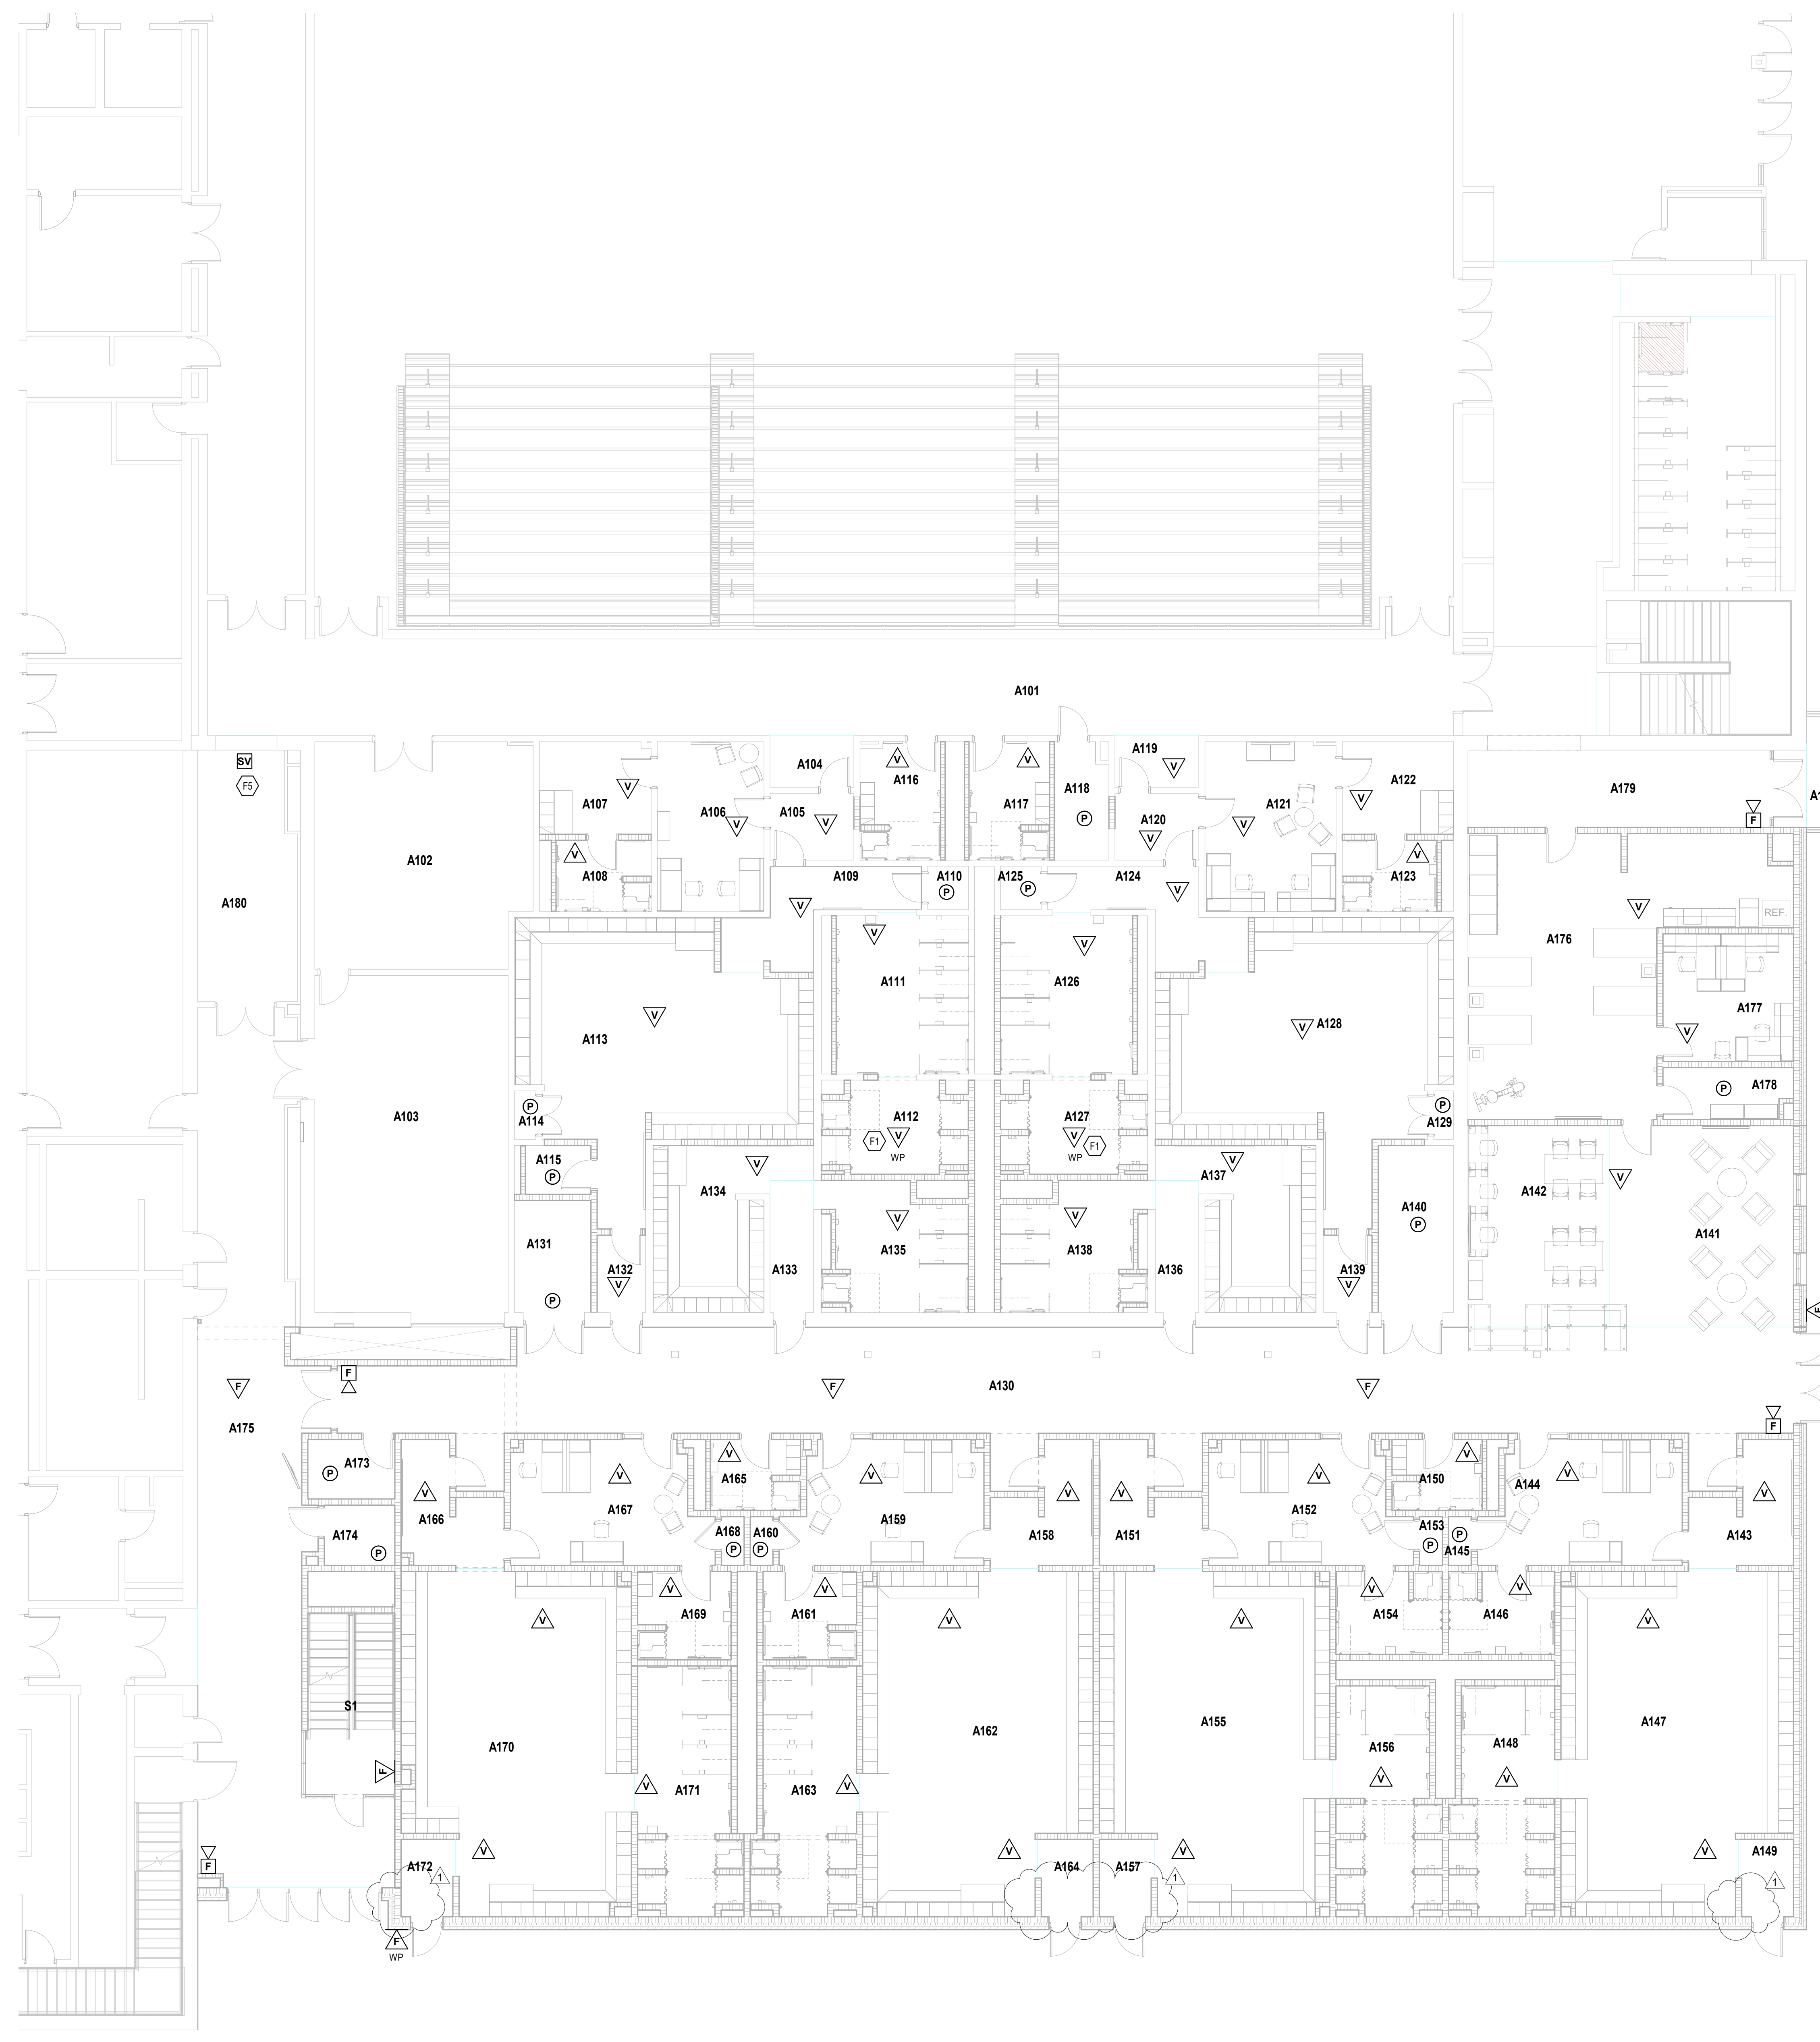

FIRST FLOOR FIRE ALARM PLAN  
SCALE: 1/8" = 1'-0"



# ZIONSVILLE HS ATHLETIC LOCKER ADDITION

1000 MULBERRY STREET,  
ZIONSVILLE, IN 46077

ZIONSVILLE COMMUNITY SCHOOLS



ZIONSVILLE  
COMMUNITY SCHOOLS


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KEY PLAN

ISSUED FOR BID



PROJECT MANAGER: JM  
DRAWN BY: RDR  
PROJECT NUMBER: 224018.00  
PROJECT ISSUE DATE: 01/21/2025

REV. NO.	DESCRIPTION	DATE
1	ADDENDUM #1	02/11/2025

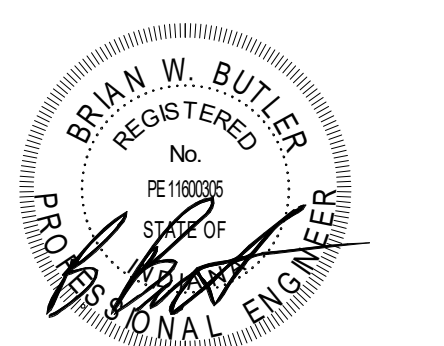FIRST FLOOR LIGHTING PLAN

# EL-11

ROOM LEGEND - FIRST FLOOR UNIT A		
ROOM NO.	ROOM NAME	AREA (SF)
A101	CORRIDOR	1376 SF
A102	LAUNDRY	515 SF
A103	MECHANICAL	697 SF
A104	VESTIBULE	46 SF
A105	VESTIBULE	60 SF
A106	OFFICE	193 SF
A107	LOCKERS	110 SF
A108	RESTROOM	70 SF
A109	VESTIBULE	129 SF
A110	STORAGE	19 SF
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A112	SHOWERS	127 SF
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A117	REF RESTROOM	99 SF
A118	STORAGE	66 SF
A119	VESTIBULE	46 SF
A120	VESTIBULE	60 SF
A121	OFFICE	237 SF
A122	LOCKERS	110 SF
A123	RESTROOM	70 SF
A124	VESTIBULE	129 SF
A125	STORAGE	19 SF
A126	RESTROOM	226 SF
A127	SHOWERS	127 SF
A128	LOCKERS	659 SF
A129	STORAGE	10 SF
A130	CORRIDOR	1707 SF
A131	STORAGE	92 SF

ROOM LEGEND - FIRST FLOOR UNIT A		
ROOM NO.	ROOM NAME	AREA (SF)
A132	VESTIBULE	40 SF
A133	VESTIBULE	62 SF
A134	LOCKERS	215 SF
A135	RESTROOM	182 SF
A136	VESTIBULE	62 SF
A137	LOCKERS	216 SF
A138	RESTROOM	182 SF
A139	VESTIBULE	40 SF
A140	STORAGE	Not Placed
A141	LOBBY	396 SF
A142	OPEN OFFICE	306 SF
A143	VESTIBULE	108 SF
A144	OFFICE	250 SF
A145	STORAGE	12 SF
A146	RESTROOM	92 SF
A147	LOCKERS	806 SF
A148	RESTROOM	229 SF
A149	VESTIBULE	44 SF
A150	RESTROOM	66 SF
A151	VESTIBULE	105 SF
A152	CORRIDOR	249 SF
A153	STORAGE	12 SF
A154	RESTROOM	92 SF
A155	LOCKERS	799 SF
A156	RESTROOM	229 SF
A157	VESTIBULE	44 SF
A158	VESTIBULE	105 SF
A159	OFFICE	249 SF
A160	STORAGE	12 SF
A161	RESTROOM	98 SF
A162	LOCKERS	799 SF
A163	RESTROOM	248 SF
A163	RESTROOM	Not Placed
A164	VESTIBULE	44 SF
A165	RESTROOM	66 SF
A166	VESTIBULE	104 SF
A167	OFFICE	250 SF
A168	STORAGE	12 SF
A169	RESTROOM	86 SF
A170	LOCKERS	794 SF
A171	RESTROOM	248 SF
A172	VESTIBULE	44 SF
A173	ELECTRICAL	55 SF
A174	TECHNOLOGY	46 SF
A175	CORRIDOR	1053 SF
A176	TRAINING	703 SF
A177	OFFICE	178 SF
A178	STORAGE	69 SF
A179	CORRIDOR	251 SF
A180	CORRIDOR	257 SF
A181	VESTIBULE	387 SF


ALL EMERGENCY LIGHT FIXTURES AND EXIT SIGNS IN THIS UNIT ARE TO BE WIRED TO A SPARE CIRCUIT IN THE NEAREST EXISTING 277/480V EMERGENCY PANELBOARD THAT SERVES THIS AREA.

## GENERAL NOTES - LIGHTING

- GENERATOR TRANSFER DEVICE TO TAKE FIXTURE TO 100% IN EMERGENCY CONDITION.
- FINAL CONNECTION TO RECESSED LUMINAIRES SHALL BE WITH FLEXIBLE METALLIC CONDUIT, MC CABLE OR MANUFACTURED WIRING SYSTEM.
- REFER TO ARCHITECTURAL REFLECTED CEILING PLANS FOR LOCATION OF LUMINAIRES. COORDINATE LOCATION OF LUMINAIRES, LOUDESPEAKERS, DIFFUSERS, GRILLES, AND OTHER CEILING INSTALLED ELEMENTS WITH THEIR RESPECTIVE INSTALLERS.
- REFER TO ARCHITECTURAL REFLECTED CEILING PLAN AND ROOM FINISH SCHEDULE TO DETERMINE PROPER TYPE OF LUMINAIRE TRIM REQUIRED FOR CEILING TYPE PRIOR TO ORDERING LUMINAIRES. PROVIDE LUMINAIRES COMPATIBLE WITH CEILING TYPE.
- RECESSED LUMINAIRE IN GRID CEILING SYSTEMS SHALL BE PROVIDED WITH SEISMIC CLIPS OR PROVIDE ATTACHMENT TO CEILING GRID SYSTEM AND SUPPORTED PER PROJECT MANUAL AND DETAIL "9600".
- WHERE TWO SWITCHES ARE SHOWN ON PLAN CONNECTED TO THE SAME LIGHT FIXTURE, CONTRACTOR SHALL WIRE TO PROVIDE MULTI-LEVEL LIGHTING. ONE SWITCH SHALL ENERGIZE THE INBOARD LAMPS AND ONE SWITCH SHALL ENERGIZE THE OUTBOARD LAMPS. ALL ROOMS SHALL BE WIRED THE SAME. LUMINAIRE TYPE IS SHOWN ONLY ONCE, AS "TYP" IN EVERY ROOM. PROVIDE SAME TYPE OF LUMINAIRE THROUGH-OUT SAME ROOM UNLESS OTHERWISE INDICATED.
- PROVIDE NO. 10 AWG, MINIMUM CONDUCTORS FOR EXIT SIGNS AND SECURITY LIGHT CIRCUITS.

## KEYNOTES

L1	WIRE NEW LIGHTING IN THIS ROOM TO THE EXISTING LIGHTING CIRCUIT IN THIS AREA.
L2	MOUNT LIGHT FIXTURE AT 10'-0" AFG. REFER THE ARCHITECTURAL EXTERIOR ELEVATION DRAWING SHEETS FOR MOUNTING LOCATION OF THIS FIXTURE.
L7	PROVIDE THIS LF2 TYPE LIGHT FIXTURE WITH A GYPOBOARD FLANGE KID.
L8	REFER TO THE ELECTRICAL SITE PLAN, DRAWING SHEET "ES101" FOR CIRCUITING REQUIREMENTS.
L10	NEW LOCATION OF EXISTING LIGHT FIXTURE THAT IS TO BE REINSTALLED. WIRE TO THE SAME CIRCUITRY AS IT WAS WIRED TO BEFORE DEMOLITION.

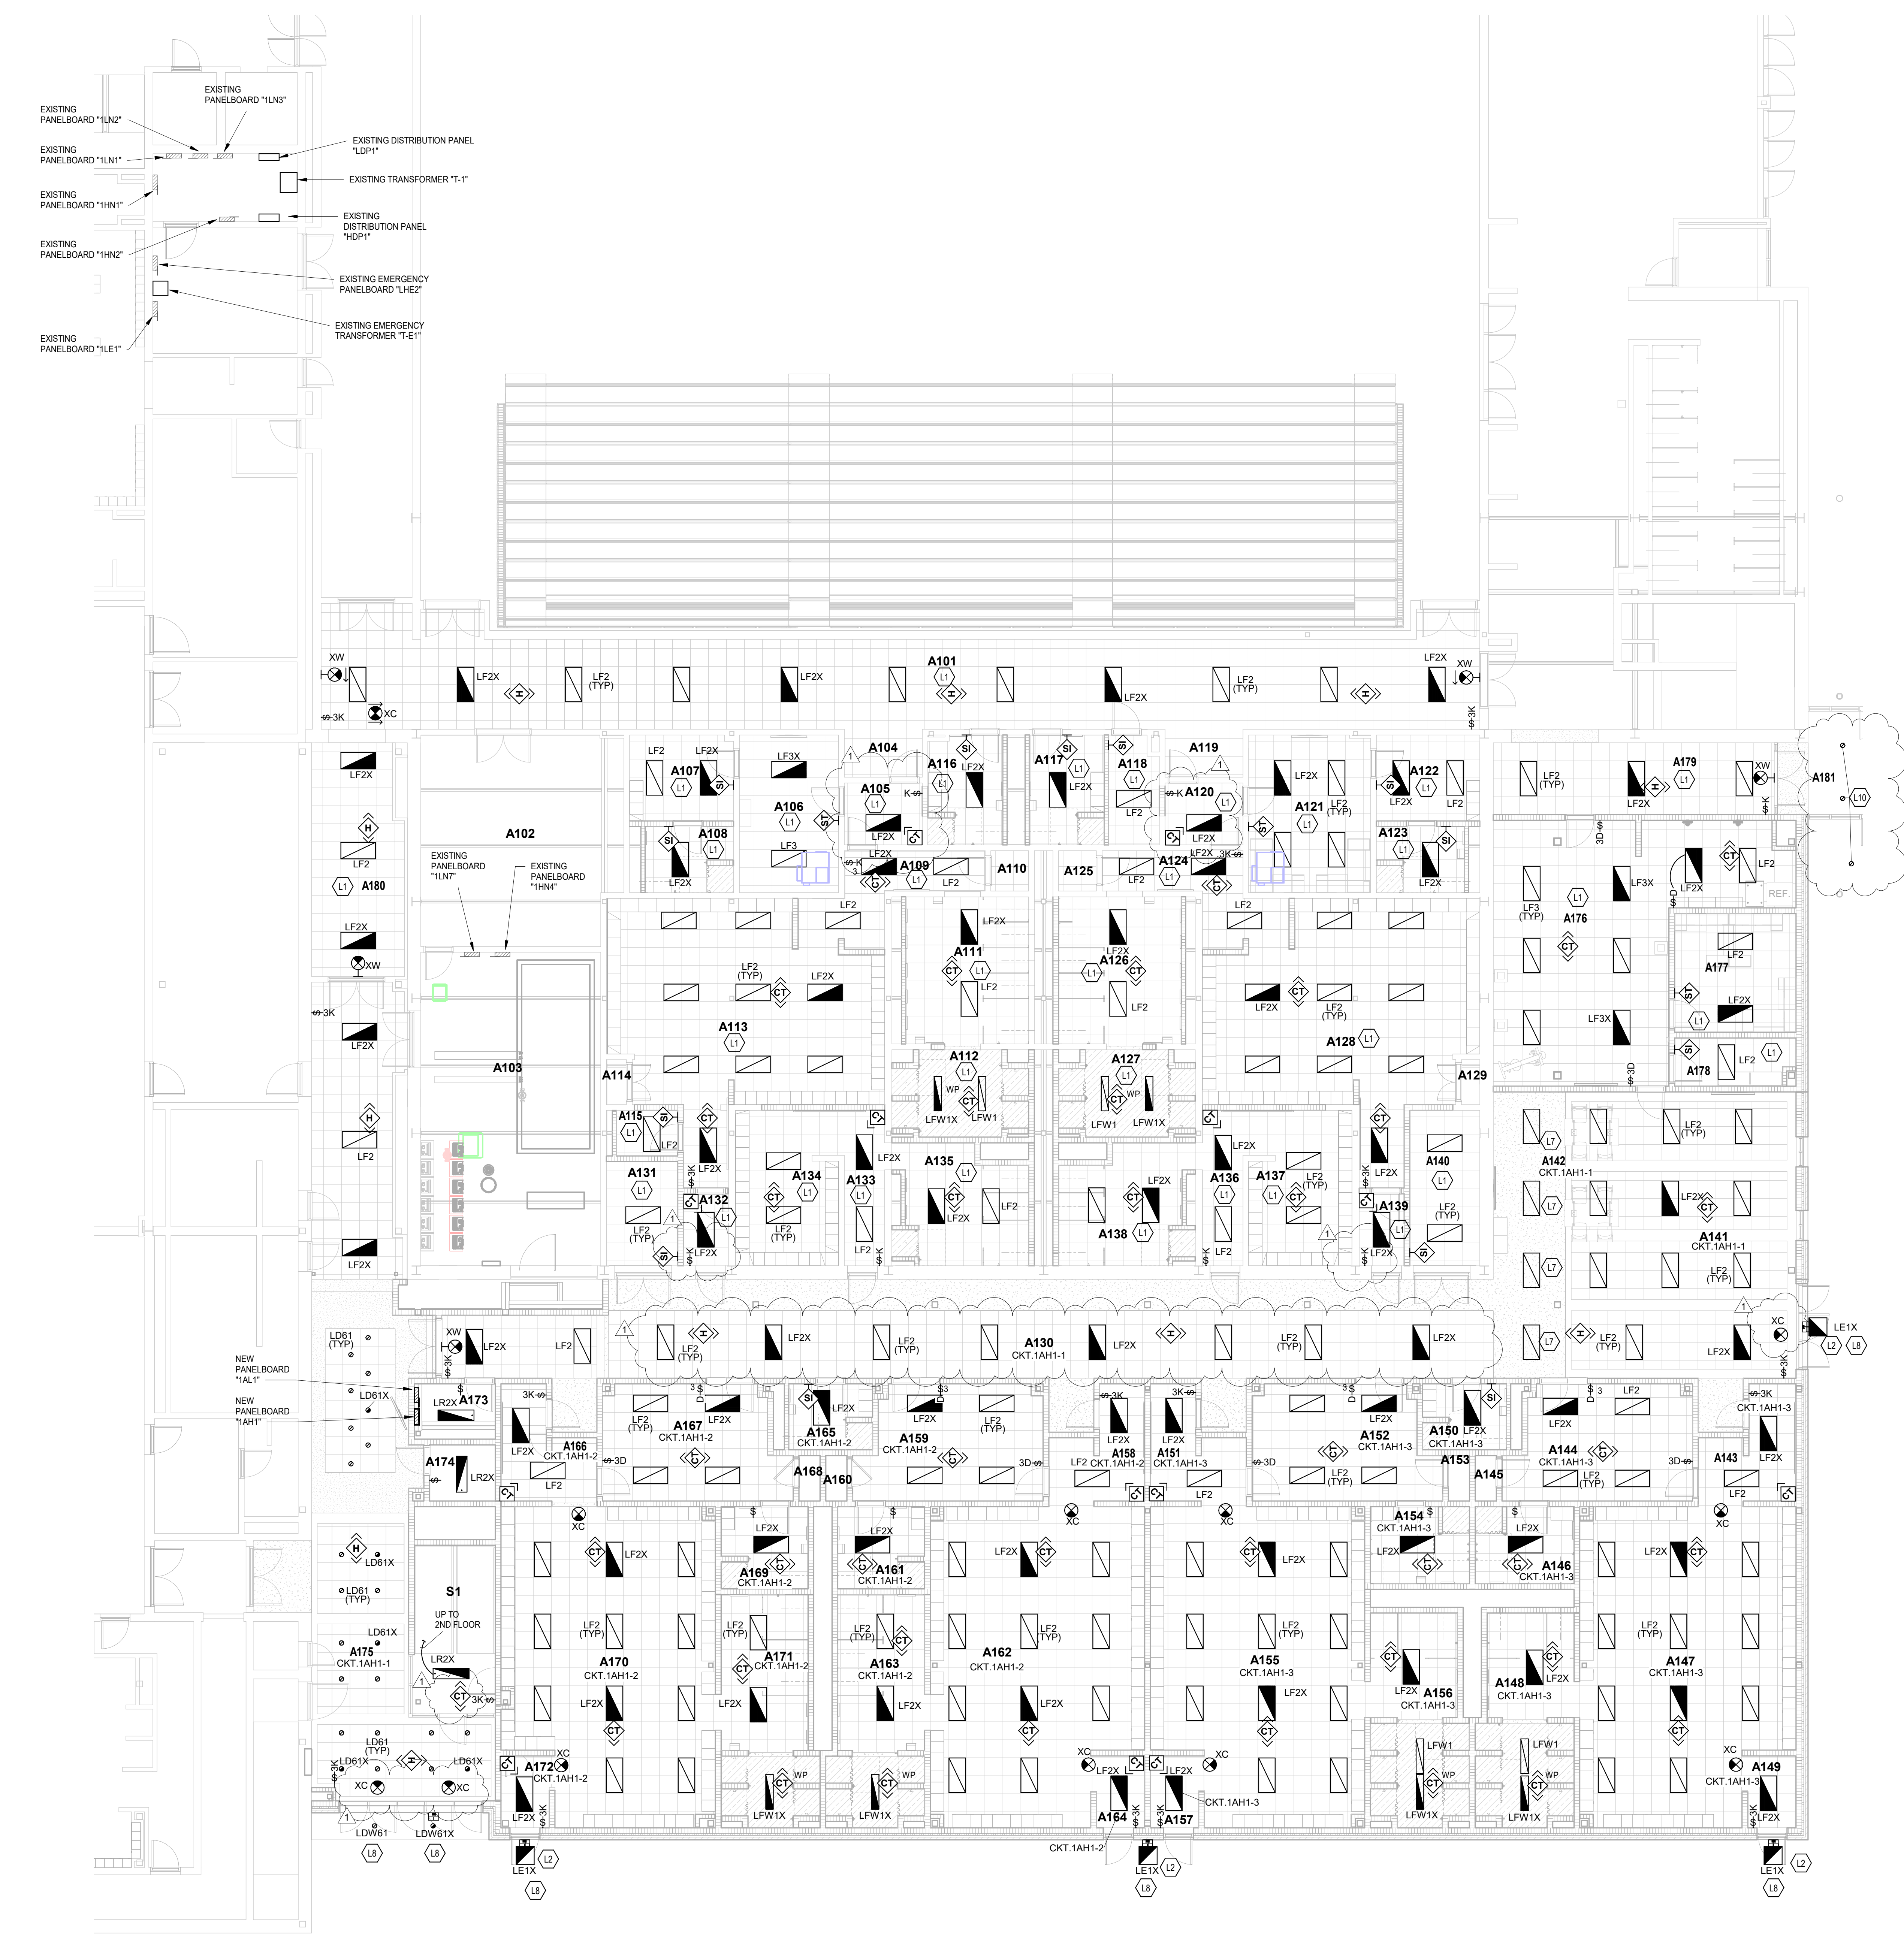

FIRST FLOOR LIGHTING PLAN  
SCALE: 1/8" = 1'-0"

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ROOM LEGEND - SECOND FLOOR UNIT A		
ROOM NO.	ROOM NAME	AREA (SF)
A201	MULTIPURPOSE	8618 SF
A202	RAMP 1	344 SF
A203	STORAGE	682 SF
A204	VESTIBULE	46 SF
A205	RAMP 2	317 SF
A206	CORRIDOR	310 SF
A207	LOCKERS	484 SF
A208	BATHROOM	112 SF
A209	STORAGE	399 SF
A210	EXISTING CORRIDOR	1422 SF
A211	EXISTING CORRIDOR	1219 SF
A212	SERVICE	50 SF
A213	IT CLOSET	31 SF
A214	EQUIPMENT PLATFORM	1257 SF

# ZIONSVILLE HS ATHLETIC LOCKER ADDITION

1000 MULBERRY STREET,  
ZIONSVILLE, IN 46077

ZIONSVILLE COMMUNITY SCHOOLS



ARCHITECT




(800) 452-3573 WWW.FHAI.COM  
900 MULBERRY ST. ZIONSVILLE, IN 46077

## GENERAL NOTES - LIGHTING


- GENERATOR TRANSFER DEVICE TO TAKE FIXTURE TO 100% IN EMERGENCY CONDITION.
- FINAL CONNECTION TO RECESSED LUMINAIRES SHALL BE WITH FLEXIBLE METALLIC CONDUIT, MC CABLE OR MANUFACTURED WIRING SYSTEM.
- REFER TO ARCHITECTURAL REFLECTED CEILING PLANS FOR LOCATION OF LUMINAIRES. COORDINATE LOCATION OF LUMINAIRES, LOUDSPEAKERS, DIFFUSERS, GRILLES, AND OTHER CEILING INSTALLED ELEMENTS WITH THEIR RESPECTIVE INSTALLERS.
- REFER TO ARCHITECTURAL REFLECTED CEILING PLAN AND ROOM FINISH SCHEDULE TO DETERMINE PROPER TYPE OF LUMINAIRE. TRM REQUIRED FOR CEILING TYPE PRIOR TO ORDERING LUMINAIRE. PROVIDE LUMINAIRE COMPATIBLE WITH CEILING TYPE.
- RECESSED LUMINAIRE IN GRID CEILING SYSTEMS SHALL BE PROVIDED WITH SEISMIC CLIPS OR PROVIDE ATTACHMENT TO CEILING GRID SYSTEM AND SUPPORTED PER PROJECT MANUAL AND DETAIL "R6E02".
- WHERE TWO SWITCHES ARE SHOWN ON PLAN CONNECTED TO THE SAME LIGHT FIXTURE, CONTRACTOR SHALL WIRE TO PROVIDE MULTILEVEL LIGHTING. ONE SWITCH SHALL ENERGIZE THE INBOARD LAMP AND ONE SWITCH SHALL ENERGIZE THE OUTBOARD LAMP. ALL ROOMS SHALL BE WIRED THE SAME. LUMINAIRE TYPE IS SHOWN ONLY ONCE, AS "TYP" IN EVERY ROOM. PROVIDE SAME TYPE OF LUMINAIRE THROUGH-OUT SAME ROOM UNLESS OTHERWISE INDICATED.
- PROVIDE NO. 10 AWG. MINIMUM CONDUCTORS FOR EXIT SIGNS AND SECURITY LIGHT CIRCUITS.

KEYNOTES	
L3	MULTIPURPOSE LIGHT LEVEL CONTROL SWITCH REFER TO DETAIL "10E-002".
L4	MOUNT BOTTOM OF LIGHT FIXTURE AT THE SAME HEIGHT AS THE BOTTOM OF STRUCTURAL STEEL IN THIS ROOM.
L5	MOUNT LIGHT FIXTURES TO MISS MECHANICAL EQUIPMENT.
L6	NO EXPOSED CONDUITS PERMITTED BELOW THE BOTTOM CHORD OF THE CEILING JOIST, IN THIS ROOM UNLESS OTHERWISE NOTED.
L9	WIRE NEW EXIT SIGN TO THE EXISTING EMERGENCY CIRCUIT THAT FED THE REMOVED EXIT SIGN ON THE OPPOSITE SIDE OF THE DOORS.
L11	NEW LOCATION OF EXISTING WALL MOUNTED EMERGENCY LIGHT FIXTURE MOUNT TO THE FACE OF THE NEW BULKHEAD AT APPROXIMATELY THE SAME HEIGHT AS IT WAS MOUNTED BEFORE. EXTEND EXISTING CONDUIT AND WIRING TO NEW LOCATION.

ALL EMERGENCY LIGHT FIXTURES AND EXIT SIGNS IN THIS UNIT ARE TO BE WIRED TO A SPARE CIRCUIT IN THE NEAREST EXISTING 277/480V EMERGENCY PANELBOARD THAT SERVES THIS AREA.

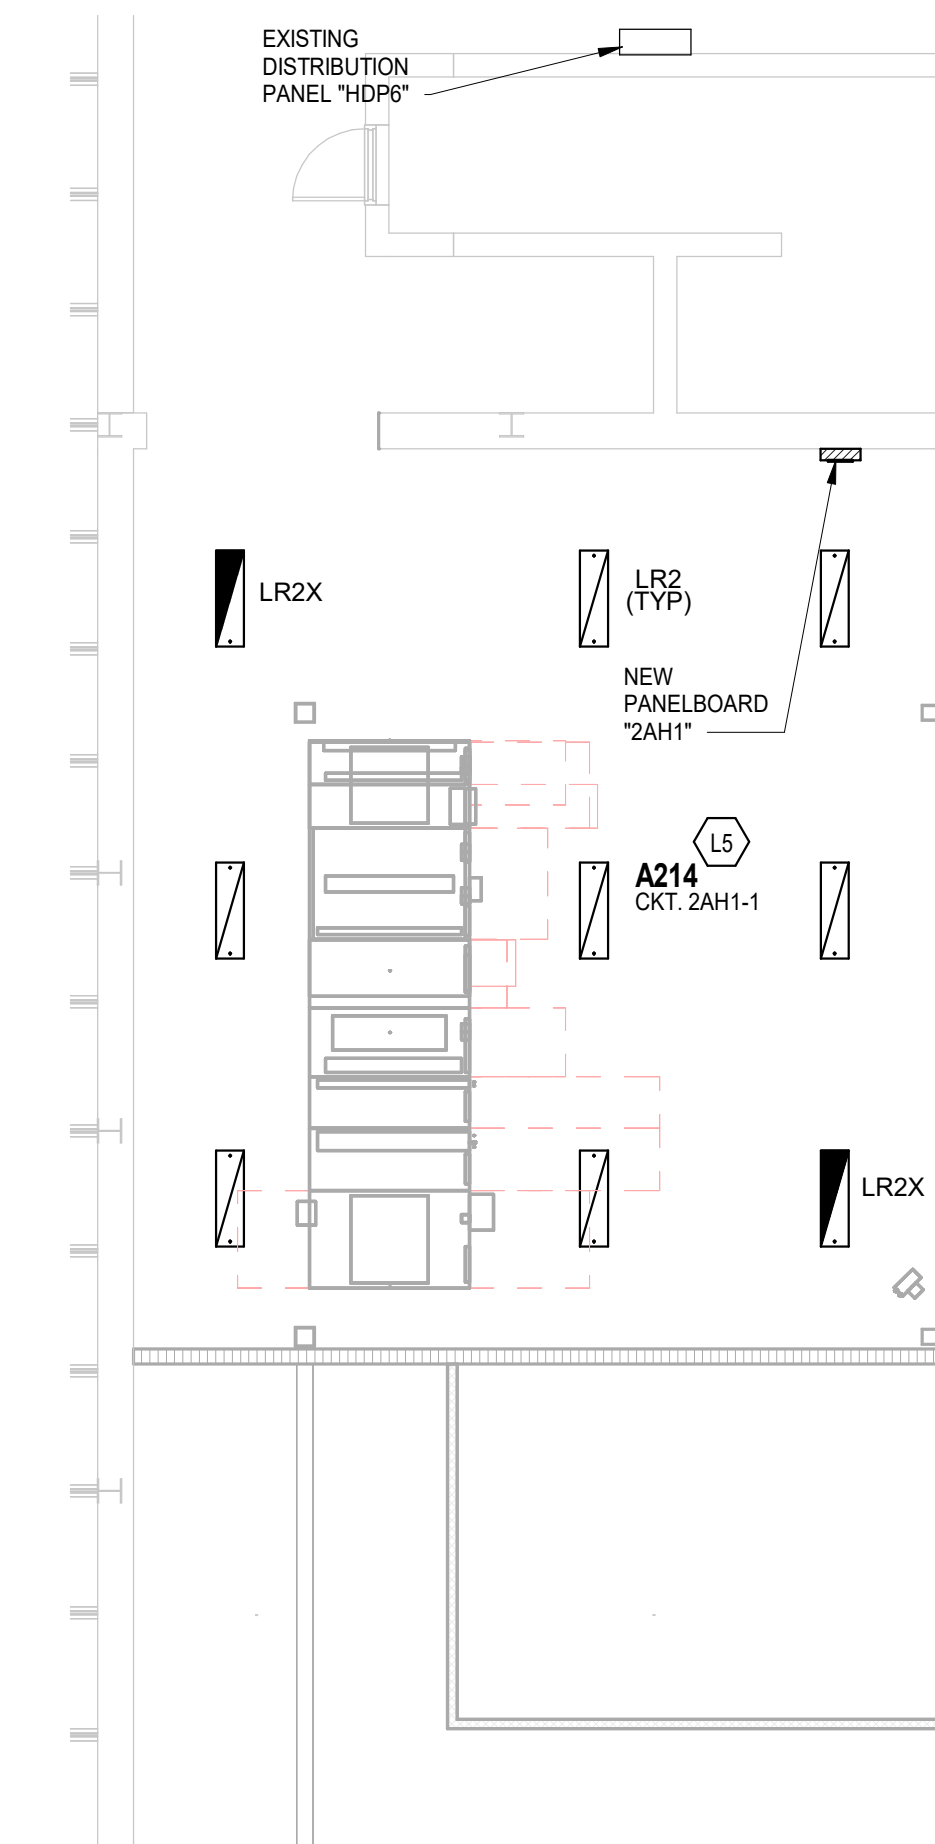


EQUIPMENT PLATFORM LIGHTING PLAN  
SCALE: 1/8" = 1'-0"

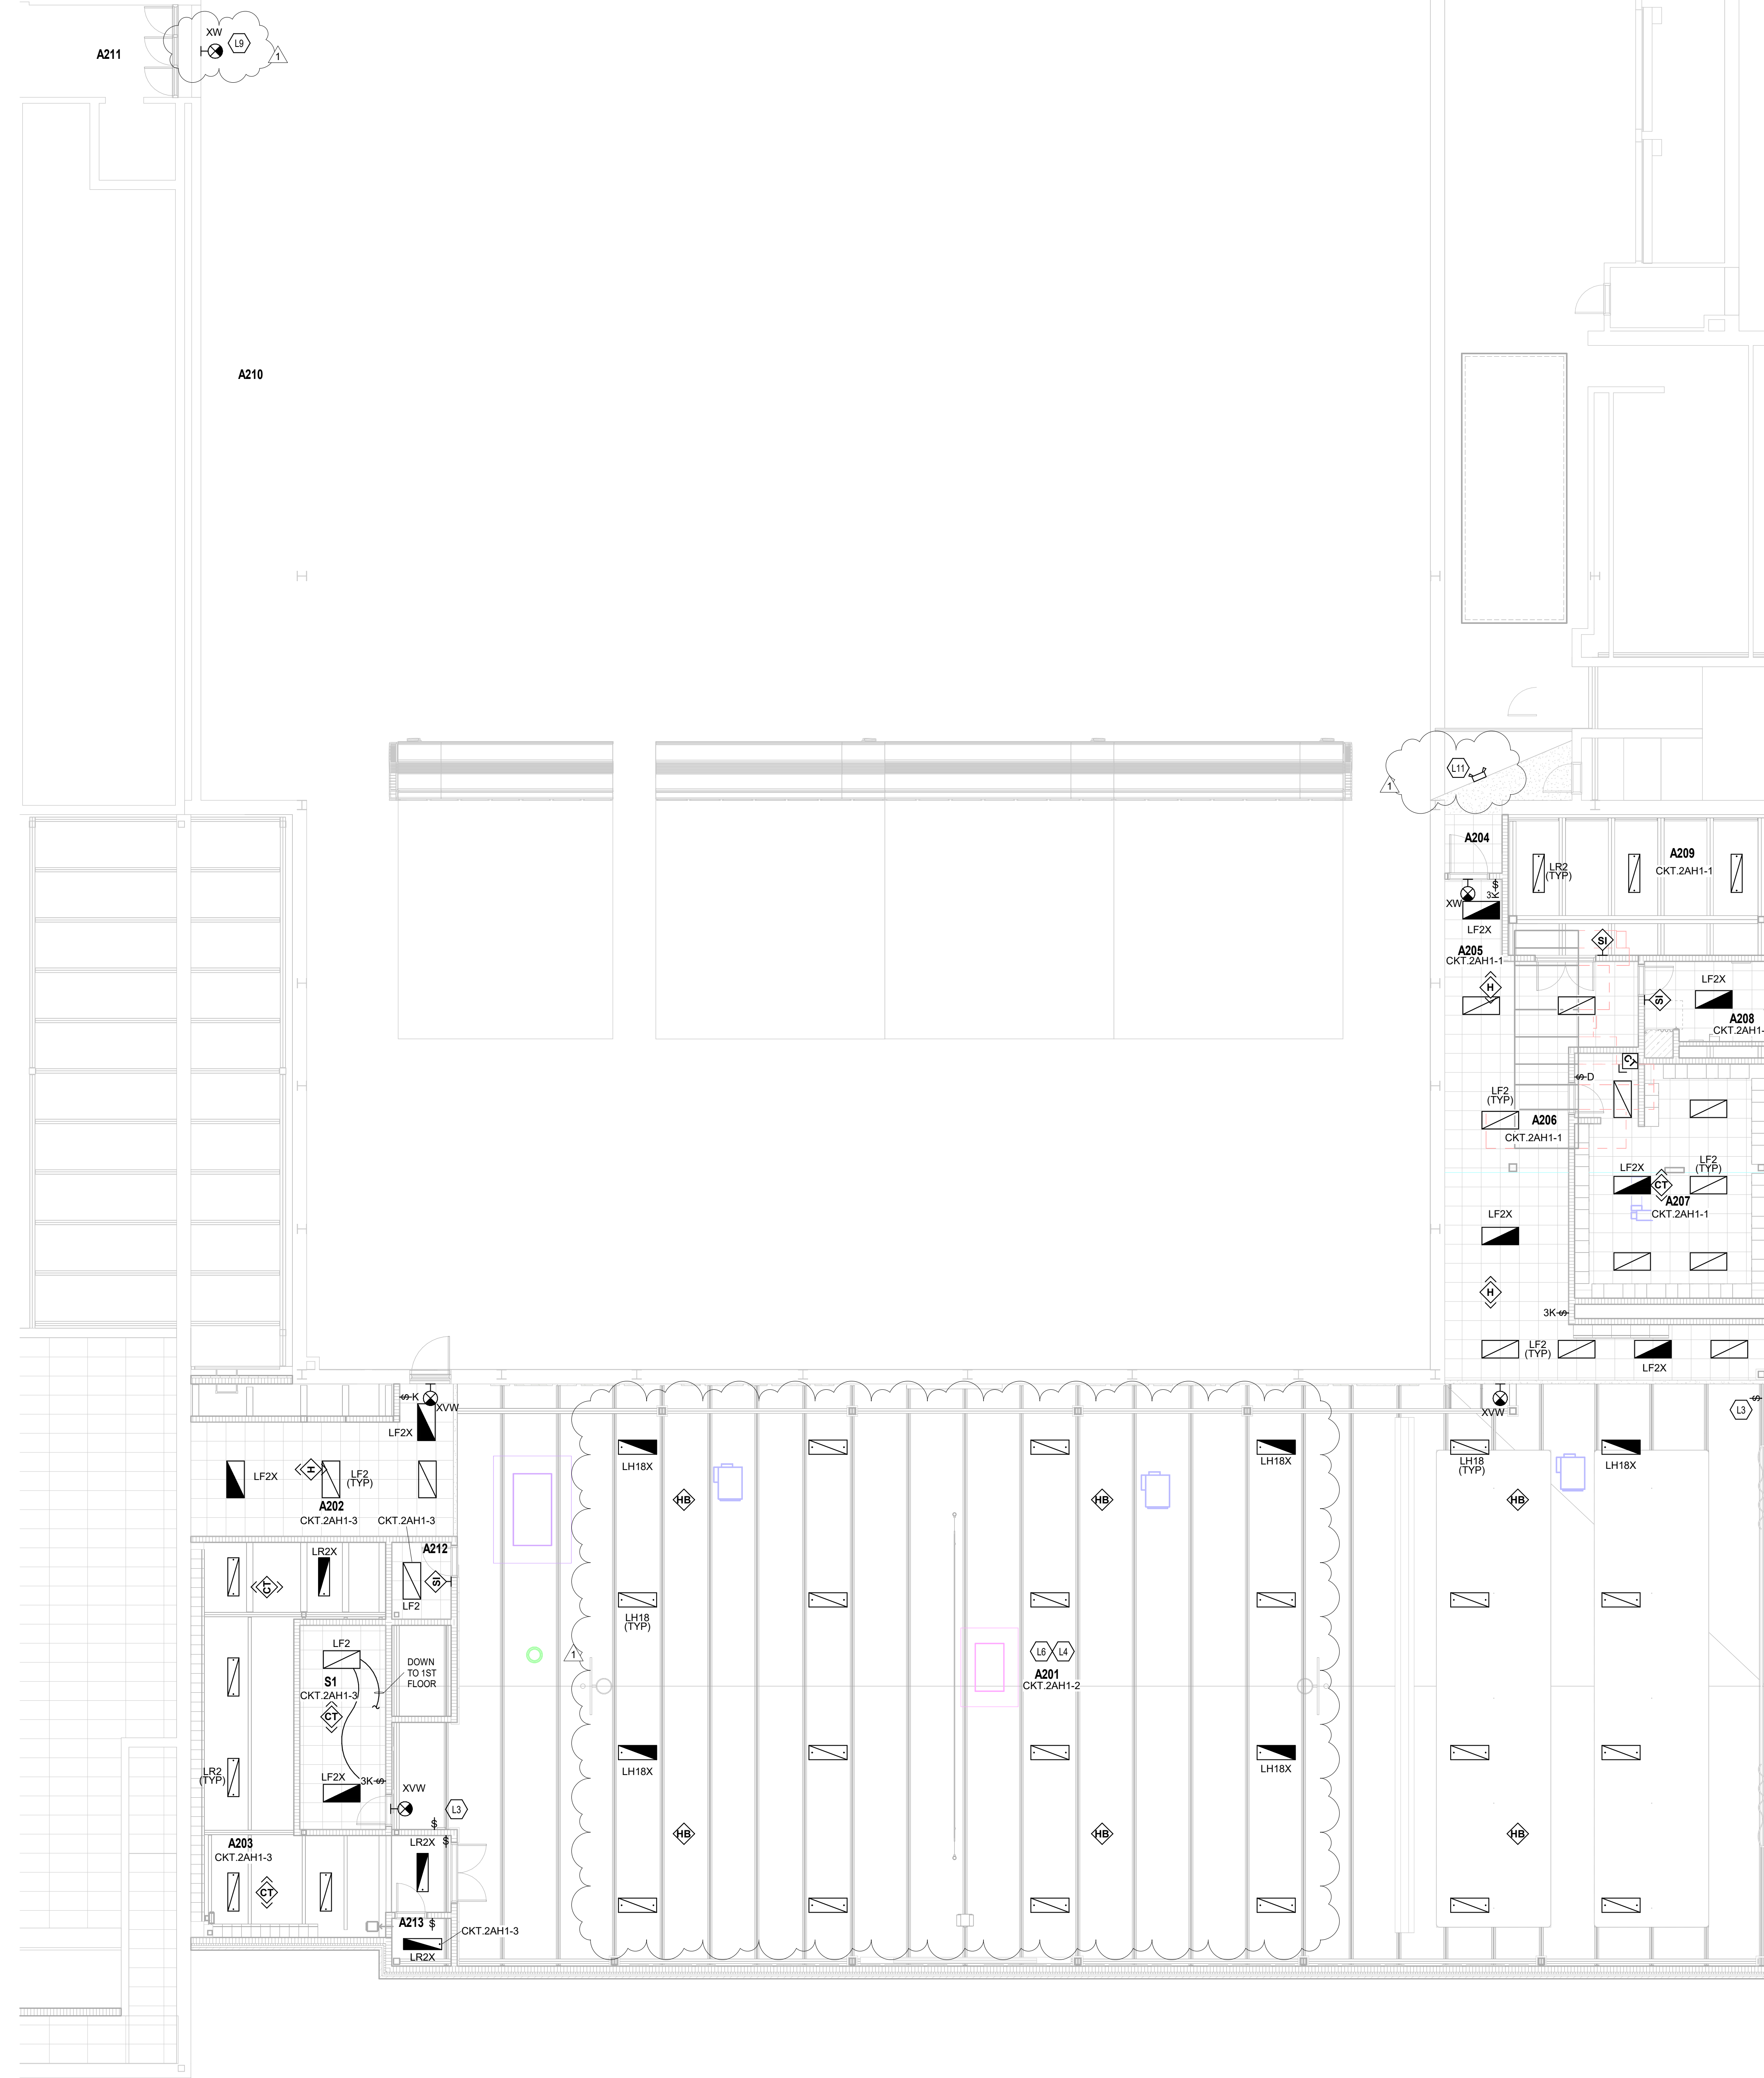

SECOND FLOOR LIGHTING PLAN BUILDING A  
SCALE: 1/8" = 1'-0"

## KEY PLAN

ISSUED FOR BID

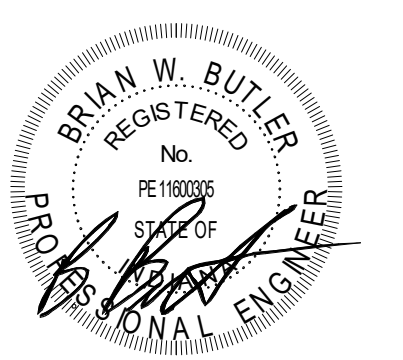

PROJECT MANAGER: JM  
DRAWN BY: RDR  
PROJECT NUMBER: 224018.00  
PROJECT ISSUE DATE: 01/21/2025

REV. NO.	DESCRIPTION	DATE
1	ADDENDUM #1	02/11/2025

SECOND FLOOR LIGHTING PLAN

# EL-12



# ZIONSVILLE HS ATHLETIC LOCKER ADDITION

1000 MULBERRY STREET,  
ZIONSVILLE, IN 46077

ZIONSVILLE COMMUNITY SCHOOLS




ZIONSVILLE  
COMMUNITY SCHOOLS

ARCHITECT


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900 MULBERRY ST. ZIONSVILLE, IN 46077

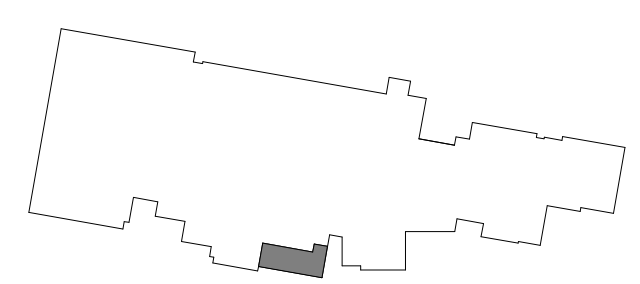

KEY PLAN

ISSUED FOR BID

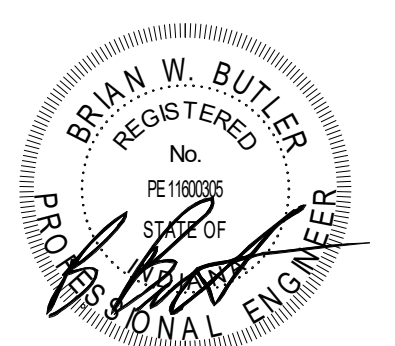

PROJECT MANAGER: JM  
DRAWN BY: RDR  
PROJECT NUMBER: 224018.00  
PROJECT ISSUE DATE: 01/21/2025

REV. NO.	DESCRIPTION	DATE
1	ADDENDUM #1	02/11/2025

FIRST FLOOR POWER PLAN

# EP-11

ROOM LEGEND - FIRST FLOOR UNIT A		
ROOM NO.	ROOM NAME	AREA (SF)
A101	CORRIDOR	1376 SF
A102	LAUNDRY	515 SF
A103	MECHANICAL	697 SF
A104	VESTIBULE	46 SF
A105	VESTIBULE	60 SF
A106	OFFICE	193 SF
A107	LOCKERS	110 SF
A108	RESTROOM	70 SF
A109	VESTIBULE	129 SF
A110	STORAGE	19 SF
A111	RESTROOM	226 SF
A112	SHOWERS	127 SF
A113	LOCKERS	668 SF
A114	STORAGE	11 SF
A115	SERVICE SINK	34 SF
A116	REF RESTROOM	98 SF
A117	REF RESTROOM	99 SF
A118	STORAGE	66 SF
A119	VESTIBULE	46 SF
A120	VESTIBULE	60 SF
A121	OFFICE	237 SF
A122	LOCKERS	110 SF
A123	RESTROOM	70 SF
A124	VESTIBULE	129 SF
A125	STORAGE	19 SF
A126	RESTROOM	226 SF
A127	SHOWERS	127 SF
A128	LOCKERS	659 SF
A129	STORAGE	10 SF
A130	CORRIDOR	1707 SF
A131	STORAGE	92 SF

ROOM LEGEND - FIRST FLOOR UNIT A		
ROOM NO.	ROOM NAME	AREA (SF)
A132	VESTIBULE	40 SF
A133	VESTIBULE	62 SF
A134	LOCKERS	215 SF
A135	RESTROOM	182 SF
A136	VESTIBULE	62 SF
A137	LOCKERS	216 SF
A138	RESTROOM	182 SF
A139	VESTIBULE	40 SF
A139	STORAGE	Not Placed
A140	STORAGE	134 SF
A141	LOBBY	396 SF
A142	OPEN OFFICE	306 SF
A143	VESTIBULE	108 SF
A144	OFFICE	250 SF
A145	STORAGE	12 SF
A146	RESTROOM	92 SF
A147	LOCKERS	806 SF
A148	RESTROOM	229 SF
A149	VESTIBULE	44 SF
A150	RESTROOM	66 SF
A151	VESTIBULE	105 SF
A152	OFFICE	249 SF
A153	STORAGE	12 SF
A154	RESTROOM	92 SF
A155	LOCKERS	739 SF
A156	RESTROOM	229 SF
A157	VESTIBULE	44 SF
A158	VESTIBULE	105 SF
A159	OFFICE	249 SF
A160	STORAGE	1707 SF
A161	RESTROOM	86 SF
A162	LOCKERS	799 SF
A163	RESTROOM	248 SF
A163	RESTROOM	Not Placed
A164	VESTIBULE	48 SF
A165	RESTROOM	66 SF
A166	VESTIBULE	104 SF
A167	OFFICE	250 SF
A168	STORAGE	12 SF
A169	RESTROOM	86 SF
A170	LOCKERS	794 SF
A171	RESTROOM	248 SF
A172	VESTIBULE	44 SF
A173	ELECTRICAL	65 SF
A174	TECHNOLOGY	46 SF
A175	CORRIDOR	1063 SF
A176	TRAINING	703 SF
A177	OFFICE	178 SF
A178	STORAGE	69 SF
A179	CORRIDOR	251 SF
A180	CORRIDOR	257 SF
A181	VESTIBULE	387 SF



## GENERAL NOTES - POWER

- PROVIDE REVISED TYPED PANELBOARD DIRECTORIES FOR EACH PANELBOARD ADDED OR MODIFIED DURING CONSTRUCTION. FIELD VERIFY EXISTING CIRCUIT INFORMATION WITH OWNER'S ASSISTANCE TO ENSURE FINAL DIRECTORY IS ACCURATE. UNUSED SPARE BREAKERS SHALL BE IN THE OFF POSITION.
- VIDEO PROJECTOR RECEPTACLE TO BE MOUNTED ABOVE WALL MOUNTED PROJECTOR BRACKET, 8" AFF. UMC.
- CONTRACTOR SHALL VERIFY ALL DIMENSIONS AND CLEARANCES AND ALL EXISTING FIELD CONDITIONS BEFORE STARTING CONSTRUCTION. COMMENCEMENT OF WORK CONSTITUTES ACCEPTANCE OF CONDITIONS. SHOULD DIFFERENT CONDITIONS BE ENCOUNTERED, CONTACT THE ARCHITECT BEFORE PROCEEDING WITH WORK. LABEL EACH RECEPTACLE WITH THE PANEL NAME AND CIRCUIT NUMBER ON THE FACE OF EACH COVER PLATE WITH A TYPED LAMINATED LABEL.
- PROVIDE "GFCI PROTECTED" LABEL ON COVER PLATE FOR ANY GFCI PROTECTED DEVICE.
- CONTRACTOR SHALL INCREASE CIRCUIT CONDUCTOR SIZE TO COMPENSATE FOR VOLTAGE DROP DUE TO EXCESSIVE CIRCUIT LENGTHS. IN NO CASE SHALL VOLTAGE DROP EXCEED 3% IN C.I. REQUIREMENTS.
- REFER TO MECHANICAL PLANS FOR LOCATION OF MECHANICAL EQUIPMENT. LOCATE AND DISCONNECT SWITCHES PER REC.
- REFER TO "CONTROL SCHEMATICS" MECHANICAL DRAWINGS FOR ADDITIONAL CONTROL WIRING AND CONTROL CONNECTIONS.
- ALL DEVICES, EQUIPMENT, FIXTURES, AND THE LIKE, SHALL BE BONDED WITH A PROPERLY SIZED EQUIPMENT GROUNDING CONDUCTOR. MAINTAIN MECHANICAL/ELECTRICAL BONDS OF METALLIC RACEWAY SYSTEM.
- ALL EXISTING RECEPTACLES INSIDE AND OUTSIDE OF THE BUILDING THAT ARE TO REMAIN ARE TO BE REPLACED WITH NEW DEVICES AND COVER PLATES, AND WIRE BACK TO EXISTING CONDUCTORS.

## KEYNOTES

P1	WIRE TO A SPARE 20-AMP, 1-POLE CIRCUIT BREAKER IN EXISTING DESIGNATED PANELBOARD.
P2	ACCESS CONTROL SECURITY JUNCTION BOX MOUNTED ABOVE CEILING FOR THE LOCK SECURITY DEVICES AND POWER WIRE TO THE NEAREST DUPLEX RECEPTACLE CIRCUIT IN THIS ROOM.
P3	TECHNOLOGY RACK(DF) RECEPTACLES: COORDINATE MOUNTING LOCATIONS AND INSTALLATION REQUIREMENT WITH THE TECHNOLOGY CONTRACTOR PRIOR TO ROUGH-IN. PROVIDE #10 CONDUCTORS.
P4	TECHNOLOGY RACK(DF) BACKBOARD RECEPTACLES REFER TO DETAIL "2E-002" FOR MOUNTING LOCATIONS AND INSTALLATION REQUIREMENTS. PROVIDE #10 CONDUCTORS.
P5	AUTOMATIC DOOR OPERATOR MOTOR, PUSH BUTTONS AND KEY SWITCH ARE BY THE UNIT MANUFACTURER. CONDUITS, BACKBOXES, AND POWER WIRING ARE BY THE DIVISION 25 CONTRACTOR, PER THE UNIT MANUFACTURER'S REQUIREMENTS. LOCATIONS SHOWN ARE FOR REFERENCE ONLY. VERIFY EXACT LOCATIONS WITH THE OPERATOR INSTALLER PRIOR TO ROUGH-IN.
P11	NEW LOCATION OF EXISTING MECHANICAL UNIT. EXTEND EXISTING CIRCUITRY TO THIS LOCATION.

FIRST FLOOR POWER PLAN  
SCALE: 1/8" = 1'-0"

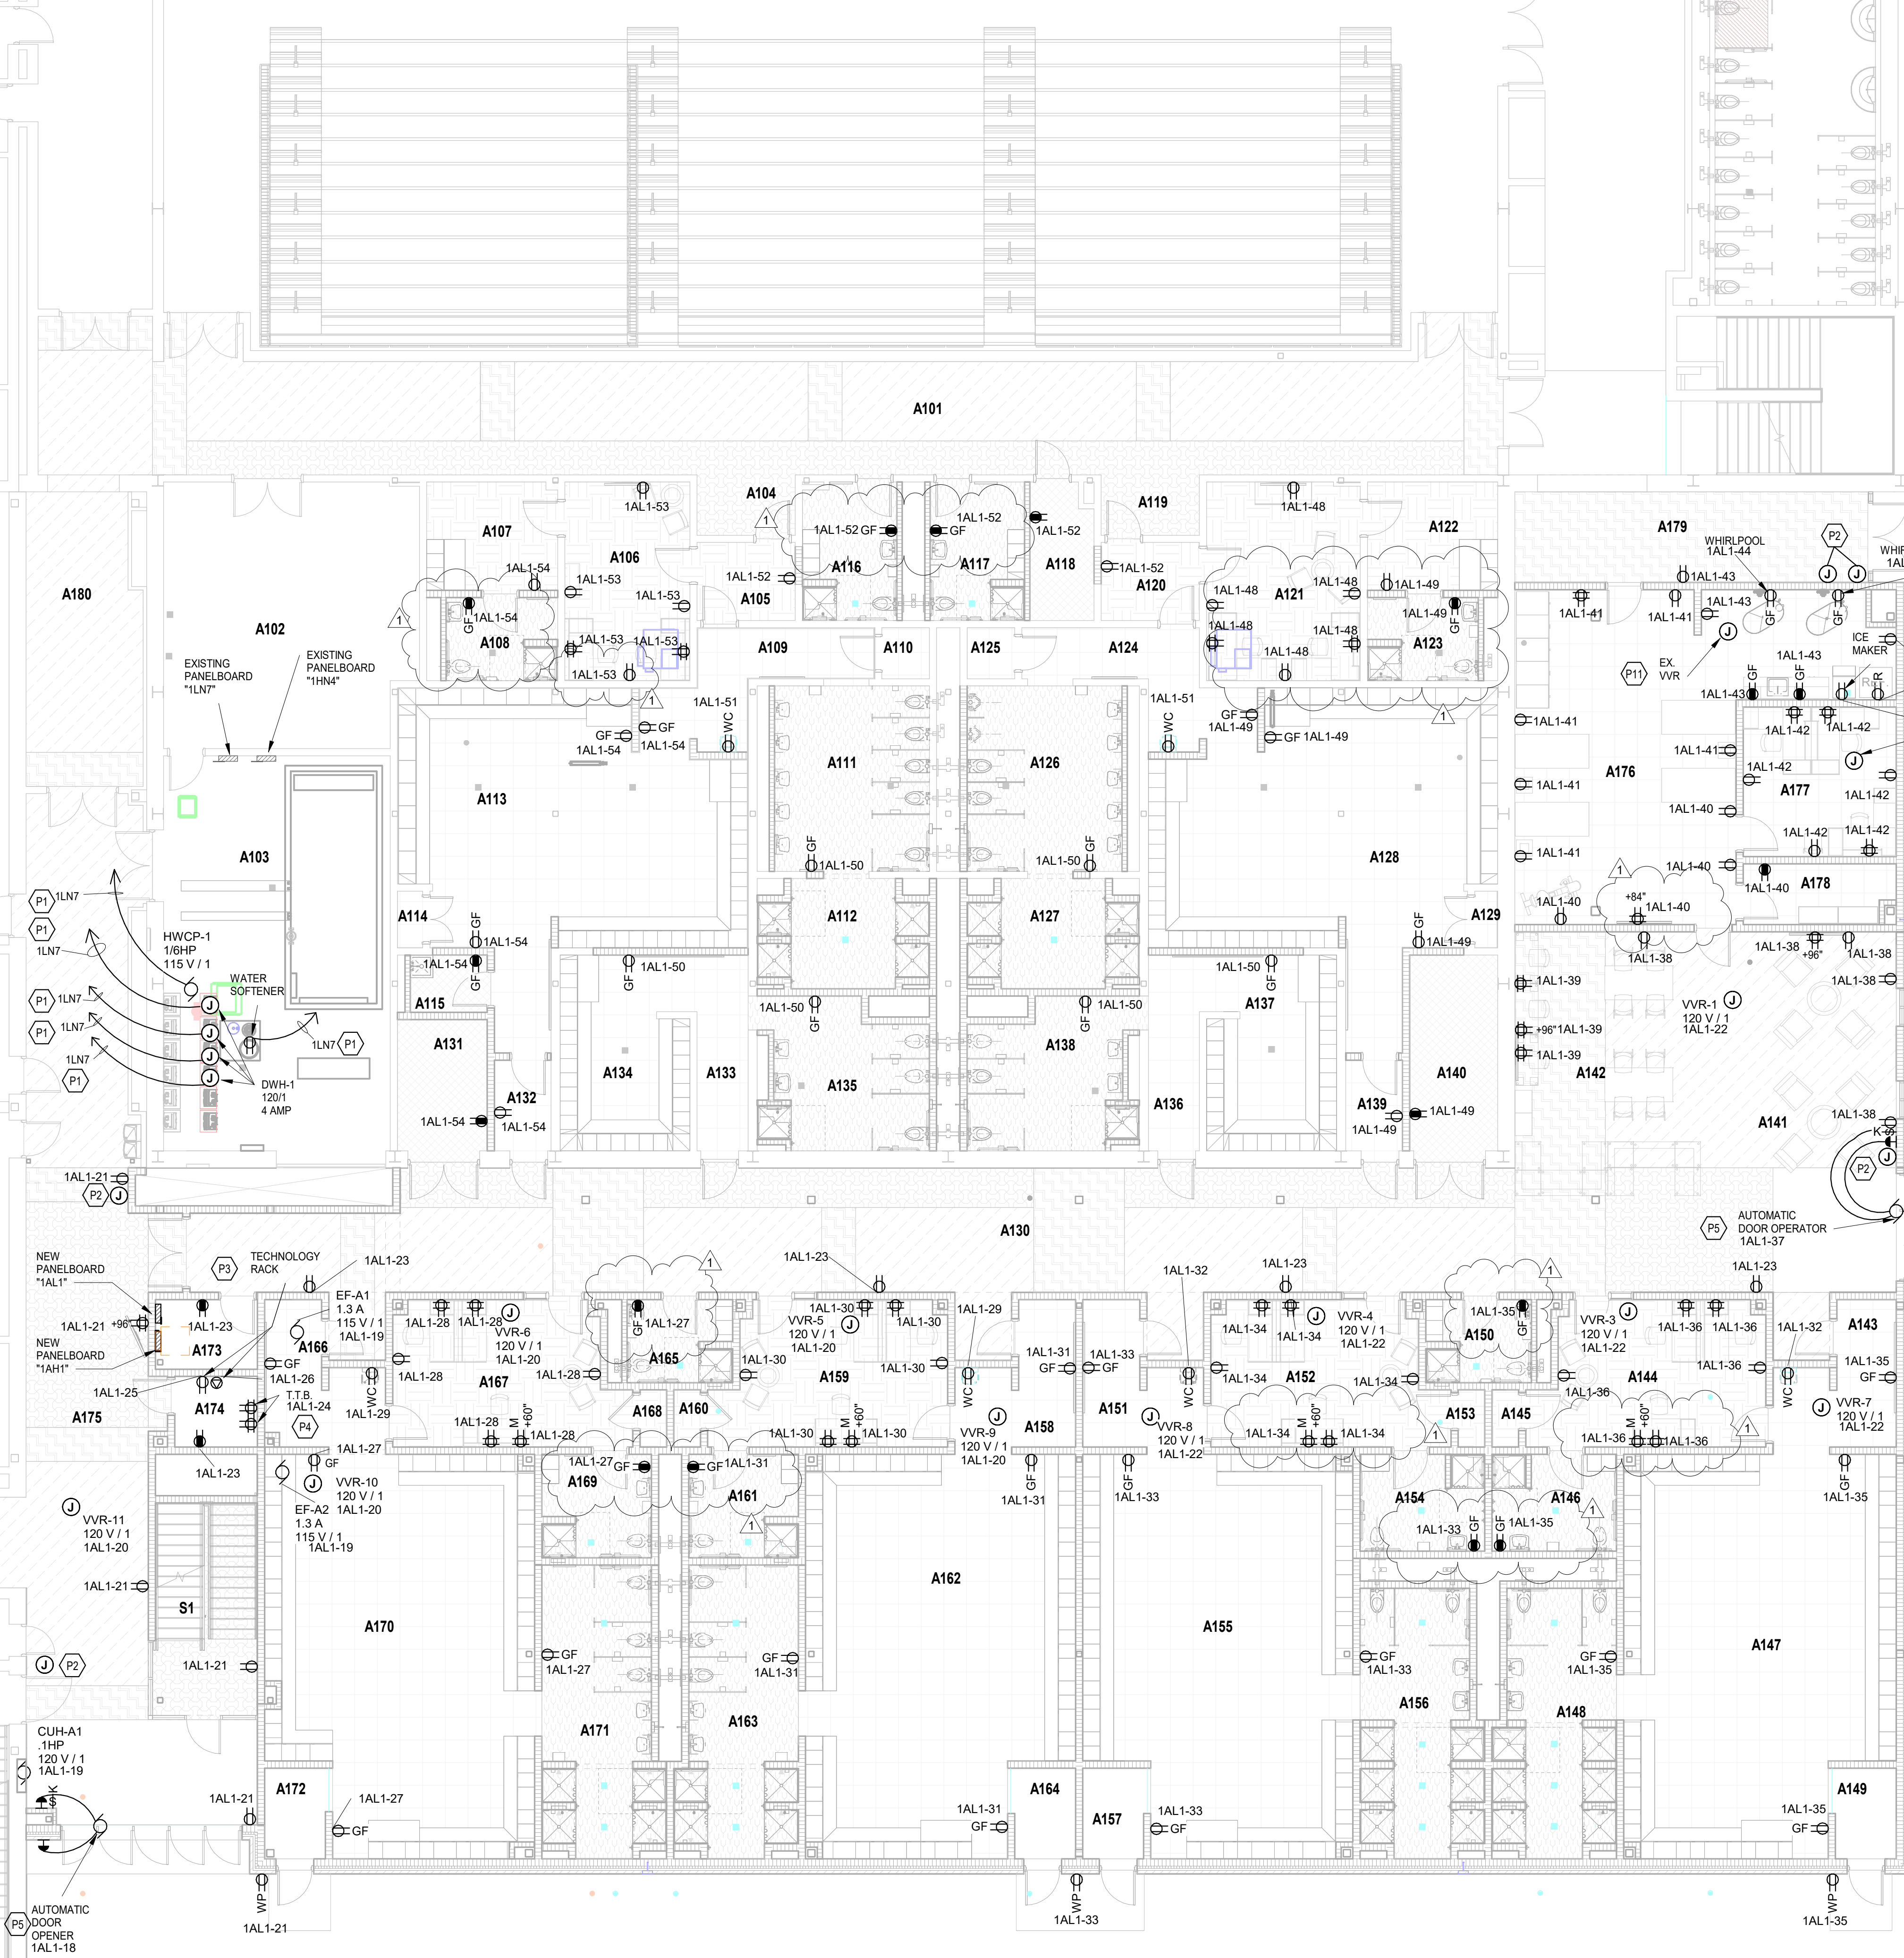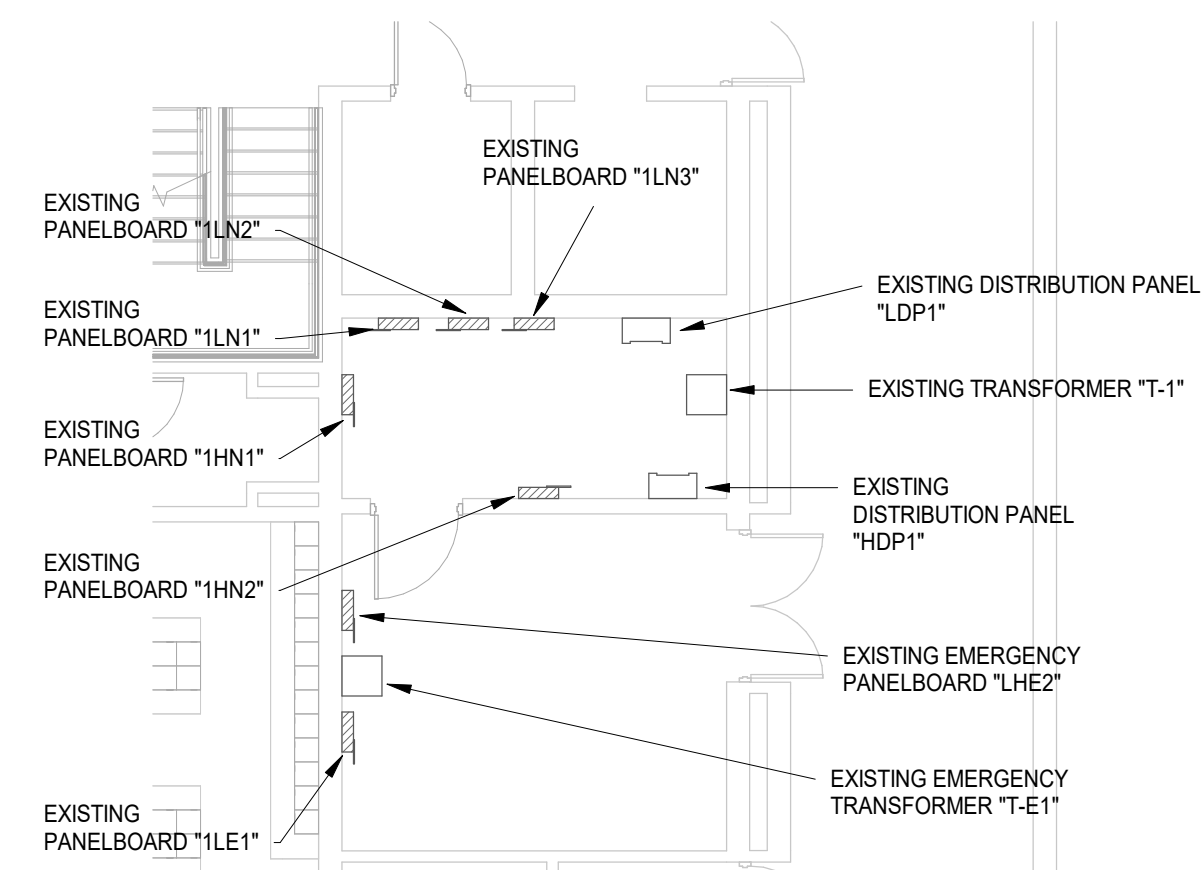



# ZIONSVILLE HS ATHLETIC LOCKER ADDITION

1000 MULBERRY STREET,  
ZIONSVILLE, IN 46077

ZIONSVILLE COMMUNITY SCHOOLS



ZIONSVILLE  
COMMUNITY SCHOOLS


ARCHITECT



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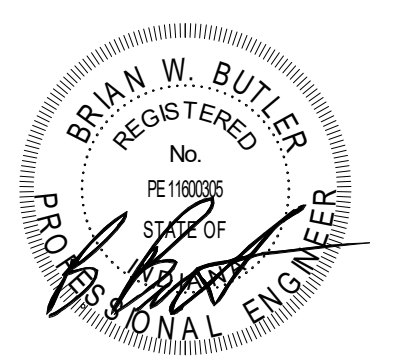
WWW.FHAI.COM

900 MULBERRY ST. ZIONSVILLE, IN 46077

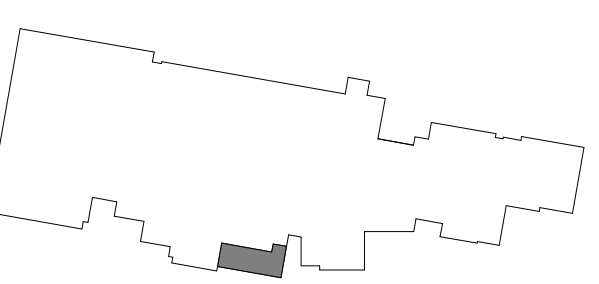

KEY PLAN

ISSUED FOR BID



PROJECT MANAGER: JM  
DRAWN BY: RDR  
PROJECT NUMBER: 224018.00  
PROJECT ISSUE DATE: 01/21/2025

REV. NO.	DESCRIPTION	DATE
1	ADDENDUM #1	02/11/2025

SECOND FLOOR POWER PLAN

# EP-12


ROOM LEGEND - SECOND FLOOR UNIT A		
ROOM NO.	ROOM NAME	AREA (SF)
A201	MULTIPURPOSE	8618 SF
A202	RAMP 1	344 SF
A203	STORAGE	682 SF
A204	VESTIBULE	46 SF
A205	RAMP 2	317 SF
A206	CORRIDOR	310 SF
A207	LOCKERS	494 SF
A208	BATHROOM	112 SF
A209	STORAGE	399 SF
A210	EXISTING CORRIDOR	1422 SF
A211	EXISTING CORRIDOR	1219 SF
A212	SERVICE	50 SF
A213	IT CLOSET	31 SF
A214	EQUIPMENT PLATFORM	1257 SF

## GENERAL NOTES - POWER

- PROVIDE REVISED TYPED PANELBOARD DIRECTORIES FOR EACH PANELBOARD ADDED OR MODIFIED DURING CONSTRUCTION. FIELD VERIFY EXISTING CIRCUIT INFORMATION WITH OWNER'S ASSISTANCE TO ENSURE FINAL DIRECTORY IS ACCURATE. UNUSED SPARE BREAKERS SHALL BE IN THE OFF POSITION.
- VIDEO PROJECTOR RECEPTACLE TO BE MOUNTED ABOVE WALL MOUNTED PROJECTOR BRACKET, BY A F.F. LIND
- CONTRACTOR SHALL VERIFY ALL DIMENSIONS AND CLEARANCES AND ALL EXISTING FIELD CONDITIONS BEFORE STARTING CONSTRUCTION. COMMENCEMENT OF WORK CONSTITUTES ACCEPTANCE OF CONDITIONS. SHOULD DIFFERENT CONDITIONS BE ENCOUNTERED, CONTACT THE ARCHITECT BEFORE PROCEEDING WITH WORK.
- LABEL EACH RECEPTACLE WITH THE PANEL NAME AND CIRCUIT NUMBER ON THE FACE OF EACH COVER PLATE WITH A TYPED LAMINATED LABEL.
- PROVIDE "GFCI PROTECTED" LABEL ON COVER PLATE FOR ANY GFCI PROTECTED DEVICE.
- CONTRACTOR SHALL INCREASE CIRCUIT CONDUCTOR SIZE TO COMPENSATE FOR VOLTAGE DROP DUE TO EXCESSIVE CIRCUIT LENGTHS. IN NO CASE SHALL VOLTAGE DROP EXCEED NFPA 70 (N.E.C.) REQUIREMENTS.
- REFER TO MECHANICAL PLANS FOR LOCATION OF MECHANICAL EQUIPMENT. LOCATE DISCONNECT SWITCHES PER NEC.
- REFER TO "CONTROL SCHEMATICS" MECHANICAL DRAWINGS FOR ADDITIONAL CONTROL WIRING AND CONTROL CONNECTIONS.
- ALL DEVICES, EQUIPMENT, FIXTURES AND THE LIKE, SHALL BE BONDED WITH A PROPERLY SIZED EQUIPMENT GROUNDING CONDUCTOR. MAINTAIN MECHANICAL/ELECTRICAL BONDS OF METALLIC RACEWAY SYSTEM.
- ALL EXISTING RECEPTACLES INSIDE AND OUTSIDE OF THE BUILDING THAT ARE TO REMAIN ARE TO BE REPLACED WITH NEW DEVICES AND COVER PLATES, AND WIRE BACK TO EXISTING CONDUCTORS.


## KEYNOTES

P1	WIRE TO A SPARE 20-AMP, 1-POLE CIRCUIT BREAKER IN EXISTING DESIGNATED PANELBOARD.
P2	ACCESS CONTROL SECURITY JUNCTION BOX MOUNTED ABOVE CEILING FOR THE DOOR SECURITY DEVICES AND POWER. WIRE TO THE NEAREST DUPLEX RECEPTACLE CIRCUIT IN THIS ROOM.
P3	TECHNOLOGY RACK(DF) RECEPTACLES. COORDINATE MOUNTING LOCATIONS AND INSTALLATION REQUIREMENTS WITH THE TECHNOLOGY CONTRACTOR PRIOR TO ROUGH-IN. PROVIDE #10 CONDUCTORS.
P4	TECHNOLOGY RACK(DF) BACKBOARD RECEPTACLES REFER TO DETAIL "20-002" FOR MOUNTING LOCATIONS AND INSTALLATION REQUIREMENTS. PROVIDE #10 CONDUCTORS.
P6	MOTORS AND CONTROLLERS FOR THE BASKETBALL BACKSTOP ARE PROVIDED BY THE BACKSTOP MANUFACTURER. CONDUITS, BACKBOXES, AND WIRING ARE PROVIDED BY DIVISION 26 CONTRACTOR PER THE MANUFACTURERS REQUIREMENTS.
P7	SCOREBOARD BY OTHERS. PROVIDE POWER RECEPTACLE AT THIS LOCATION. REFER TO ARCHITECTURAL SECTIONS AND INTERIOR ELEVATIONS DRAWINGS SHEETS FOR THE EXACT LOCATION AND MOUNTAIN HEIGHT OF THE SCOREBOARD.
P8	KEYED SWITCHES FOR EQUIPMENT ARE PROVIDED BY THE EQUIPMENT MANUFACTURER.
P9	NO EXPOSED CONDUIT PERMITTED BELOW THE BOTTOM CHORD OF THE CEILING JOIST IN THIS ROOM UNLESS OTHERWISE NOTED.
P10	PROVIDE ROUGH-INS ONLY FOR THE FUTURE BATTING CAGE. RUN A 3/4 INCH CONDUIT TO THE GYM EQUIPMENT CONTROLLER AND ANOTHER 3/4 INCH TO PANELBOARD 1AL IN ROOM A113.
P12	CONTROLLER FOR BACKSTOPS, DIVIDER CURTAIN, AND FUTURE BATTING CAGES. CONDUITS, BACKBOXES, AND WIRING ARE BY THE DIVISION 26 CONTRACTOR PER THE MANUFACTURERS REQUIREMENTS.

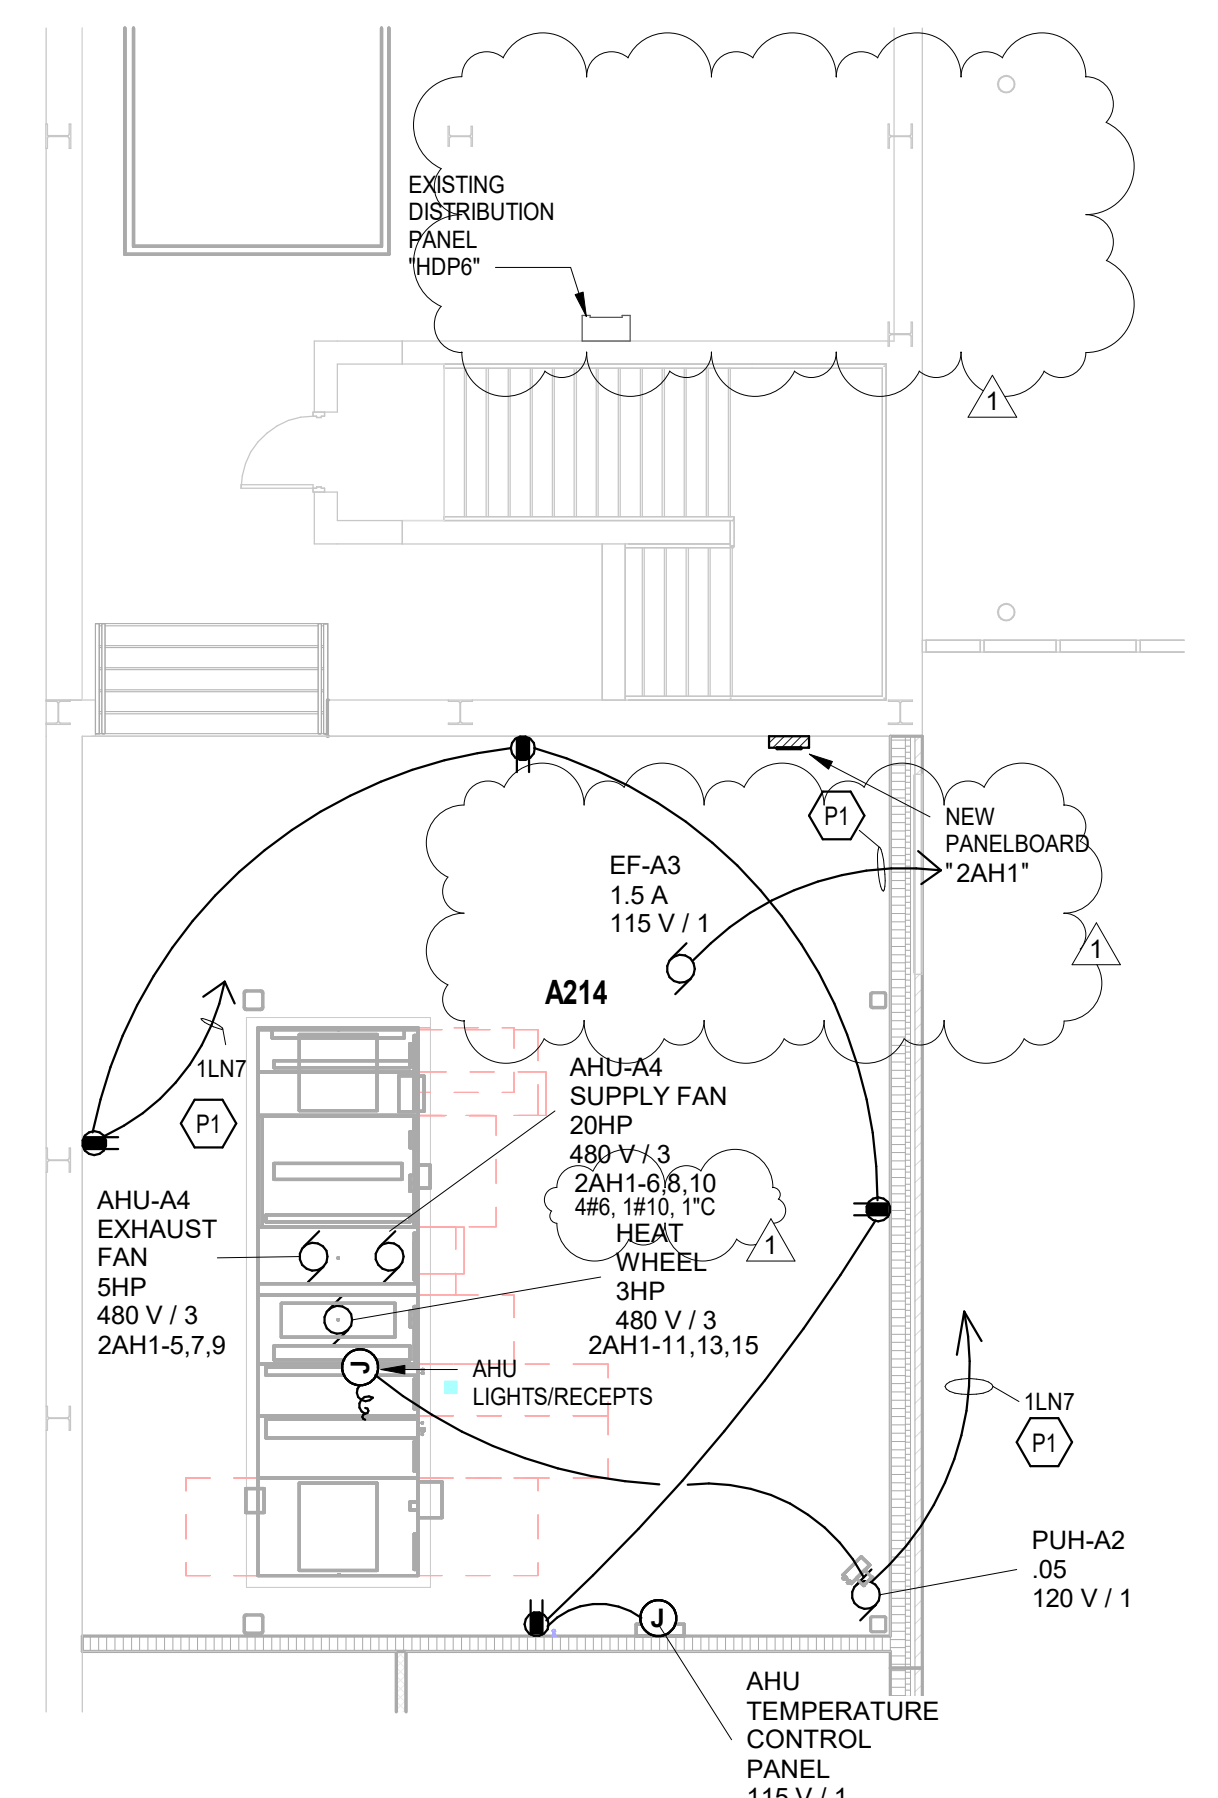

## EQUIPMENT PLATFORM POWER PLAN

SCALE: 1/8" = 1'-0"

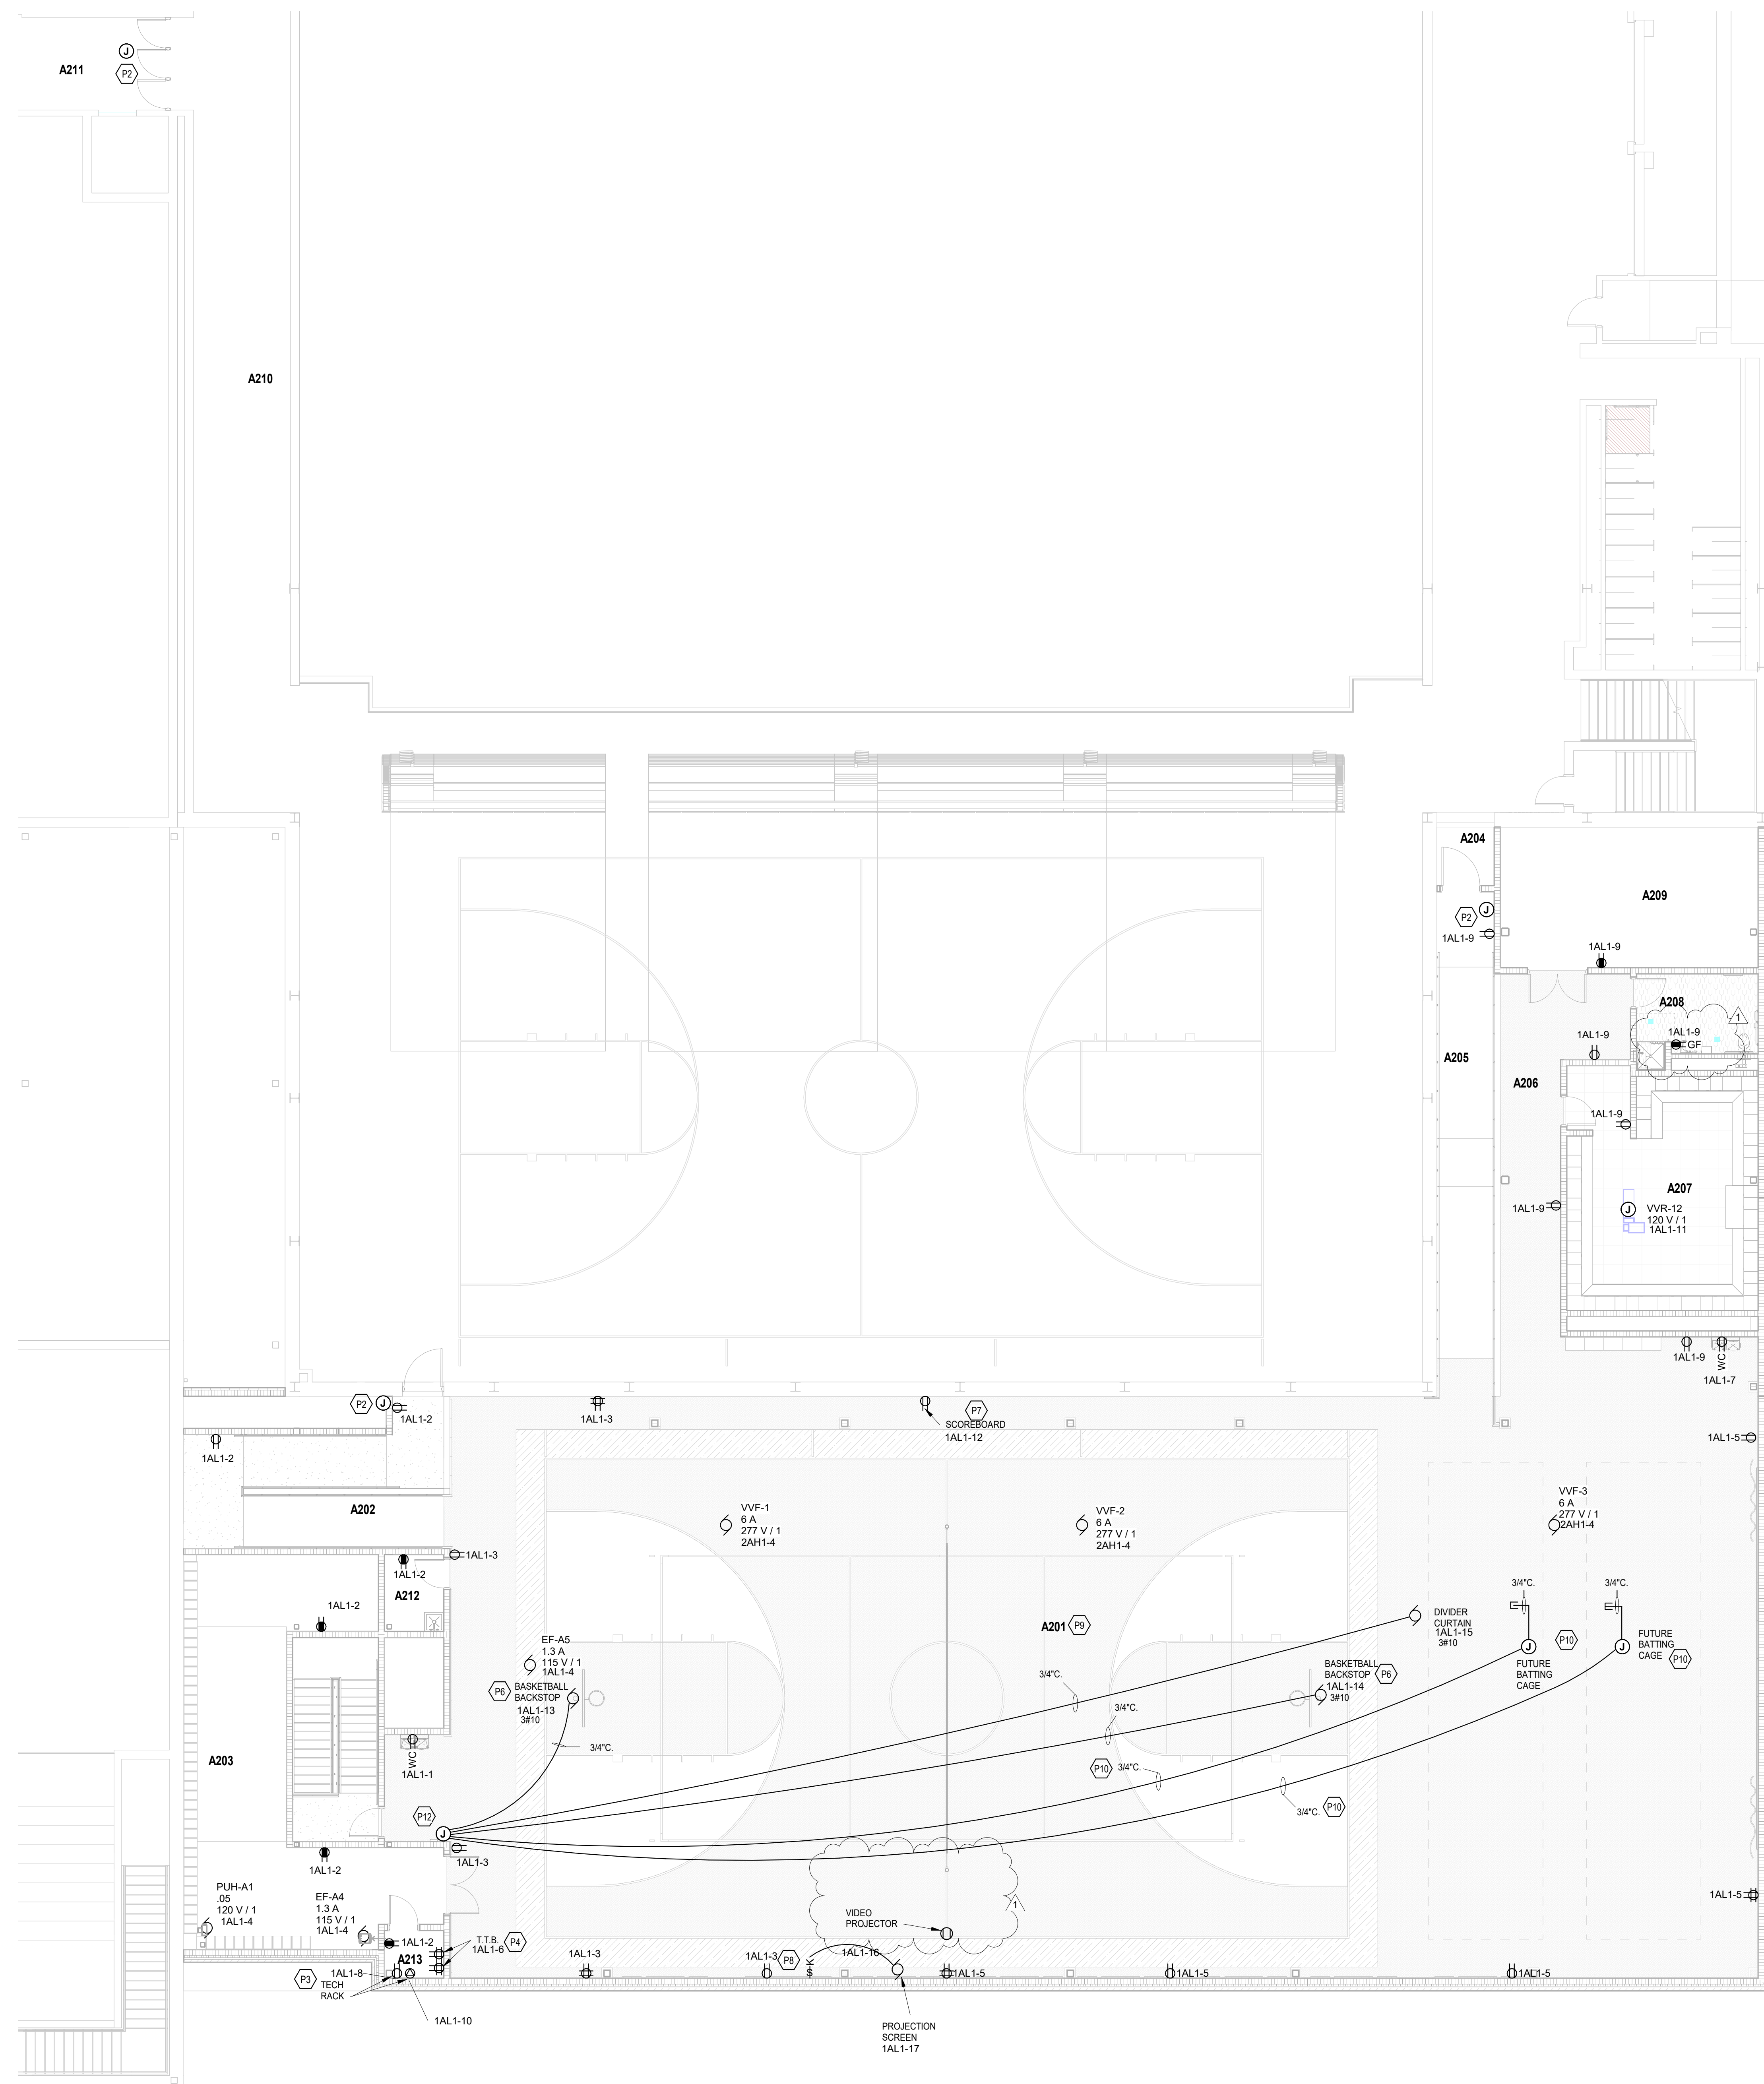

## SECOND FLOOR POWER PLAN

SCALE: 1/8" = 1'-0"



# ZIONSVILLE HS ATHLETIC LOCKER ADDITION

1000 MULBERRY STREET  
ZIONSVILLE, IN 46077


## ZIONSVILLE COMMUNITY SCHOOLS



ARCHITECT




(800) 452-3537 WWW.FHAI.COM  
350 E NEW YORK ST. SUITE 300, INDIANAPOLIS, IN 46204

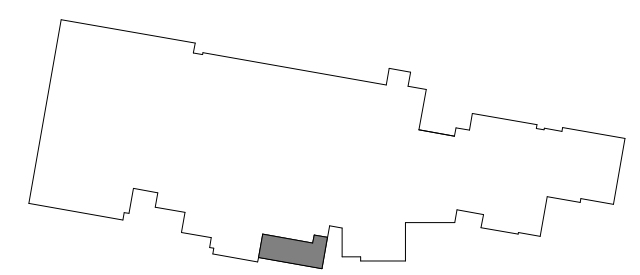

### KEY PLAN

ISSUED FOR BID

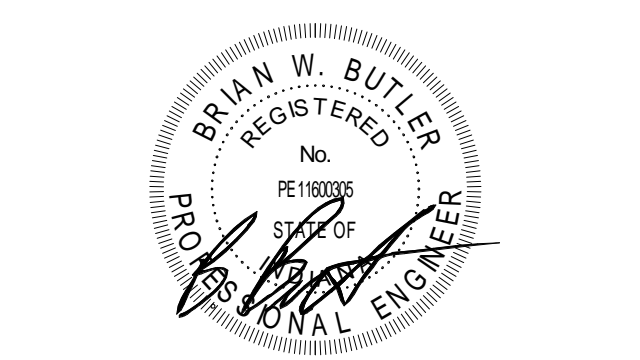

PROJECT MANAGER: JAM  
DRAWN BY: CDT  
PROJECT NUMBER: 224018.00  
PROJECT ISSUE DATE: 01-21-2025

REV. NO.	DESCRIPTION	DATE
1	Addendum #1	2-11-25

### FIRST FLOOR TECHNOLOGY ROUGH-IN PLAN

# ET-11


ROOM LEGEND				ROOM LEGEND			
ROOM NO.	OWNER ROOM NO.	ROOM NAME	AREA (SF)	ROOM NO.	OWNER ROOM NO.	ROOM NAME	AREA (SF)
<b>FIRST FLOOR</b>							
A101	C9	CORRIDOR	1376 SF	A140		STORAGE	134 SF
A102	C9 LAUNDRY	LAUNDRY	515 SF	A141		LOBBY	306 SF
A103	C6 MECH	MECHANICAL	697 SF	A142		OPEN OFFICE	306 SF
A104		VESTIBULE	46 SF	A143		VESTIBULE	108 SF
A105		VESTIBULE	60 SF	A144		OFFICE	250 SF
A106		OFFICE	193 SF	A145		STORAGE	12 SF
A107		LOCKERS	110 SF	A146		RESTROOM	92 SF
A108		RESTROOM	70 SF	A147		LOCKERS	806 SF
A109		VESTIBULE	129 SF	A148		RESTROOM	229 SF
A110		STORAGE	19 SF	A149		VESTIBULE	44 SF
A111		RESTROOM	226 SF	A150		RESTROOM	66 SF
A112		SHOWERS	127 SF	A151		VESTIBULE	105 SF
A113		LOCKERS	668 SF	A152		OFFICE	249 SF
A114		STORAGE	11 SF	A153		STORAGE	12 SF
A115		SERVICE SINK	34 SF	A154		RESTROOM	92 SF
A116		REF RESTROOM	86 SF	A155		LOCKERS	799 SF
A117		REF RESTROOM	99 SF	A156		RESTROOM	229 SF
A118		STORAGE	66 SF	A157		VESTIBULE	44 SF
A119		VESTIBULE	46 SF	A158		VESTIBULE	105 SF
A120		VESTIBULE	80 SF	A159		OFFICE	249 SF
A121		OFFICE	237 SF	A160		STORAGE	12 SF
A122		LOCKERS	110 SF	A161		RESTROOM	88 SF
A123		RESTROOM	70 SF	A162		LOCKERS	799 SF
A124		VESTIBULE	129 SF	A163		RESTROOM	248 SF
A125		STORAGE	19 SF	A164		VESTIBULE	44 SF
A126		RESTROOM	226 SF	A165		RESTROOM	66 SF
A127		SHOWERS	127 SF	A166		VESTIBULE	104 SF
A128		LOCKERS	659 SF	A167		OFFICE	250 SF
A129		STORAGE	10 SF	A168		STORAGE	12 SF
A130		CORRIDOR	1707 SF	A169		RESTROOM	88 SF
A131		STORAGE	92 SF	A170		LOCKERS	794 SF
A132		VESTIBULE	40 SF	A171		RESTROOM	248 SF
A133		LOCKERS	62 SF	A172		VESTIBULE	44 SF
A134		LOCKERS	215 SF	A173		ELECTRICAL	55 SF
A135		RESTROOM	182 SF	A174		TECHNOLOGY	46 SF
A136		VESTIBULE	62 SF	A175	C6	CORRIDOR	1053 SF
A137		LOCKERS	216 SF	A176	C402	TRAINING	703 SF
A138		RESTROOM	182 SF	A177		OFFICE	178 SF
A139		VESTIBULE	40 SF	A178		STORAGE	69 SF
				A179		CORRIDOR	251 SF
				A180	C6	CORRIDOR	257 SF
				A181		VESTIBULE	387 SF
				S1		STAIR	174 SF

### TECHNOLOGY ROUGH-IN GENERAL NOTES

A. DEVICES SHALL BE INSTALLED AT LOCATIONS SHOWN ON DRAWINGS. LOCATIONS OF DEVICES SHALL BE COORDINATED WITH OTHER ELECTRICAL DEVICES/ CASEWORK/ ARCHITECTURAL FEATURES AND OTHER TRADES PRIOR TO ROUGH-IN. IF RELOCATION OF DEVICES IS REQUIRED DUE TO LACK OF COORDINATION BETWEEN ELECTRICAL DRAWINGS AND OTHER TRADES, ANY ASSOCIATED COSTS SHALL BE RESPONSIBILITY OF ELECTRICAL CONTRACTOR.

### ROUGH-IN PLAN NOTES

- (ALL NOTES MAY NOT BE INDICATED ON THIS SHEET)
- SHEET KEYNOTES**
- R1 PROVIDE DOOR CONTACT AS REQUIRED; COORDINATE WITH DOOR SUPPLIER.
  - R2 PROVIDE TWO 2" CONDUIT PATHWAY FOR LOW VOLTAGE CABLING. SEE DETAIL FOR MORE INFORMATION. COORDINATE WITH DIV. 27 CONTRACTOR.
  - R3 COORDINATE WITH DIV. 27 CONTRACTOR FOR POWER REQUIREMENTS FOR DATA RACK.
  - R4 PROVIDE POWER FOR ACCESS CONTROL PANEL. COORDINATE WITH DIV. 27 CONTRACTOR.
  - R5 PROVIDE PATHWAYS FOR DIVISION 27 TO ROUGH IN DOOR CONTROL CABLE AND ALL CONTROL MONITORING HARDWARE TO ALL 8 EXTERIOR DOORS IN DOOR 3 ENTRY. THESE WILL TERMINATE TO VERKADA ACP IN A174.
  - R6 ENSURE THAT EXISTING ADD. CARD READER AND AIRPHONE INTERCOM CAMERA HAS ROUGH IN BOXES WITH NEW WALL GOING IN PLACE.

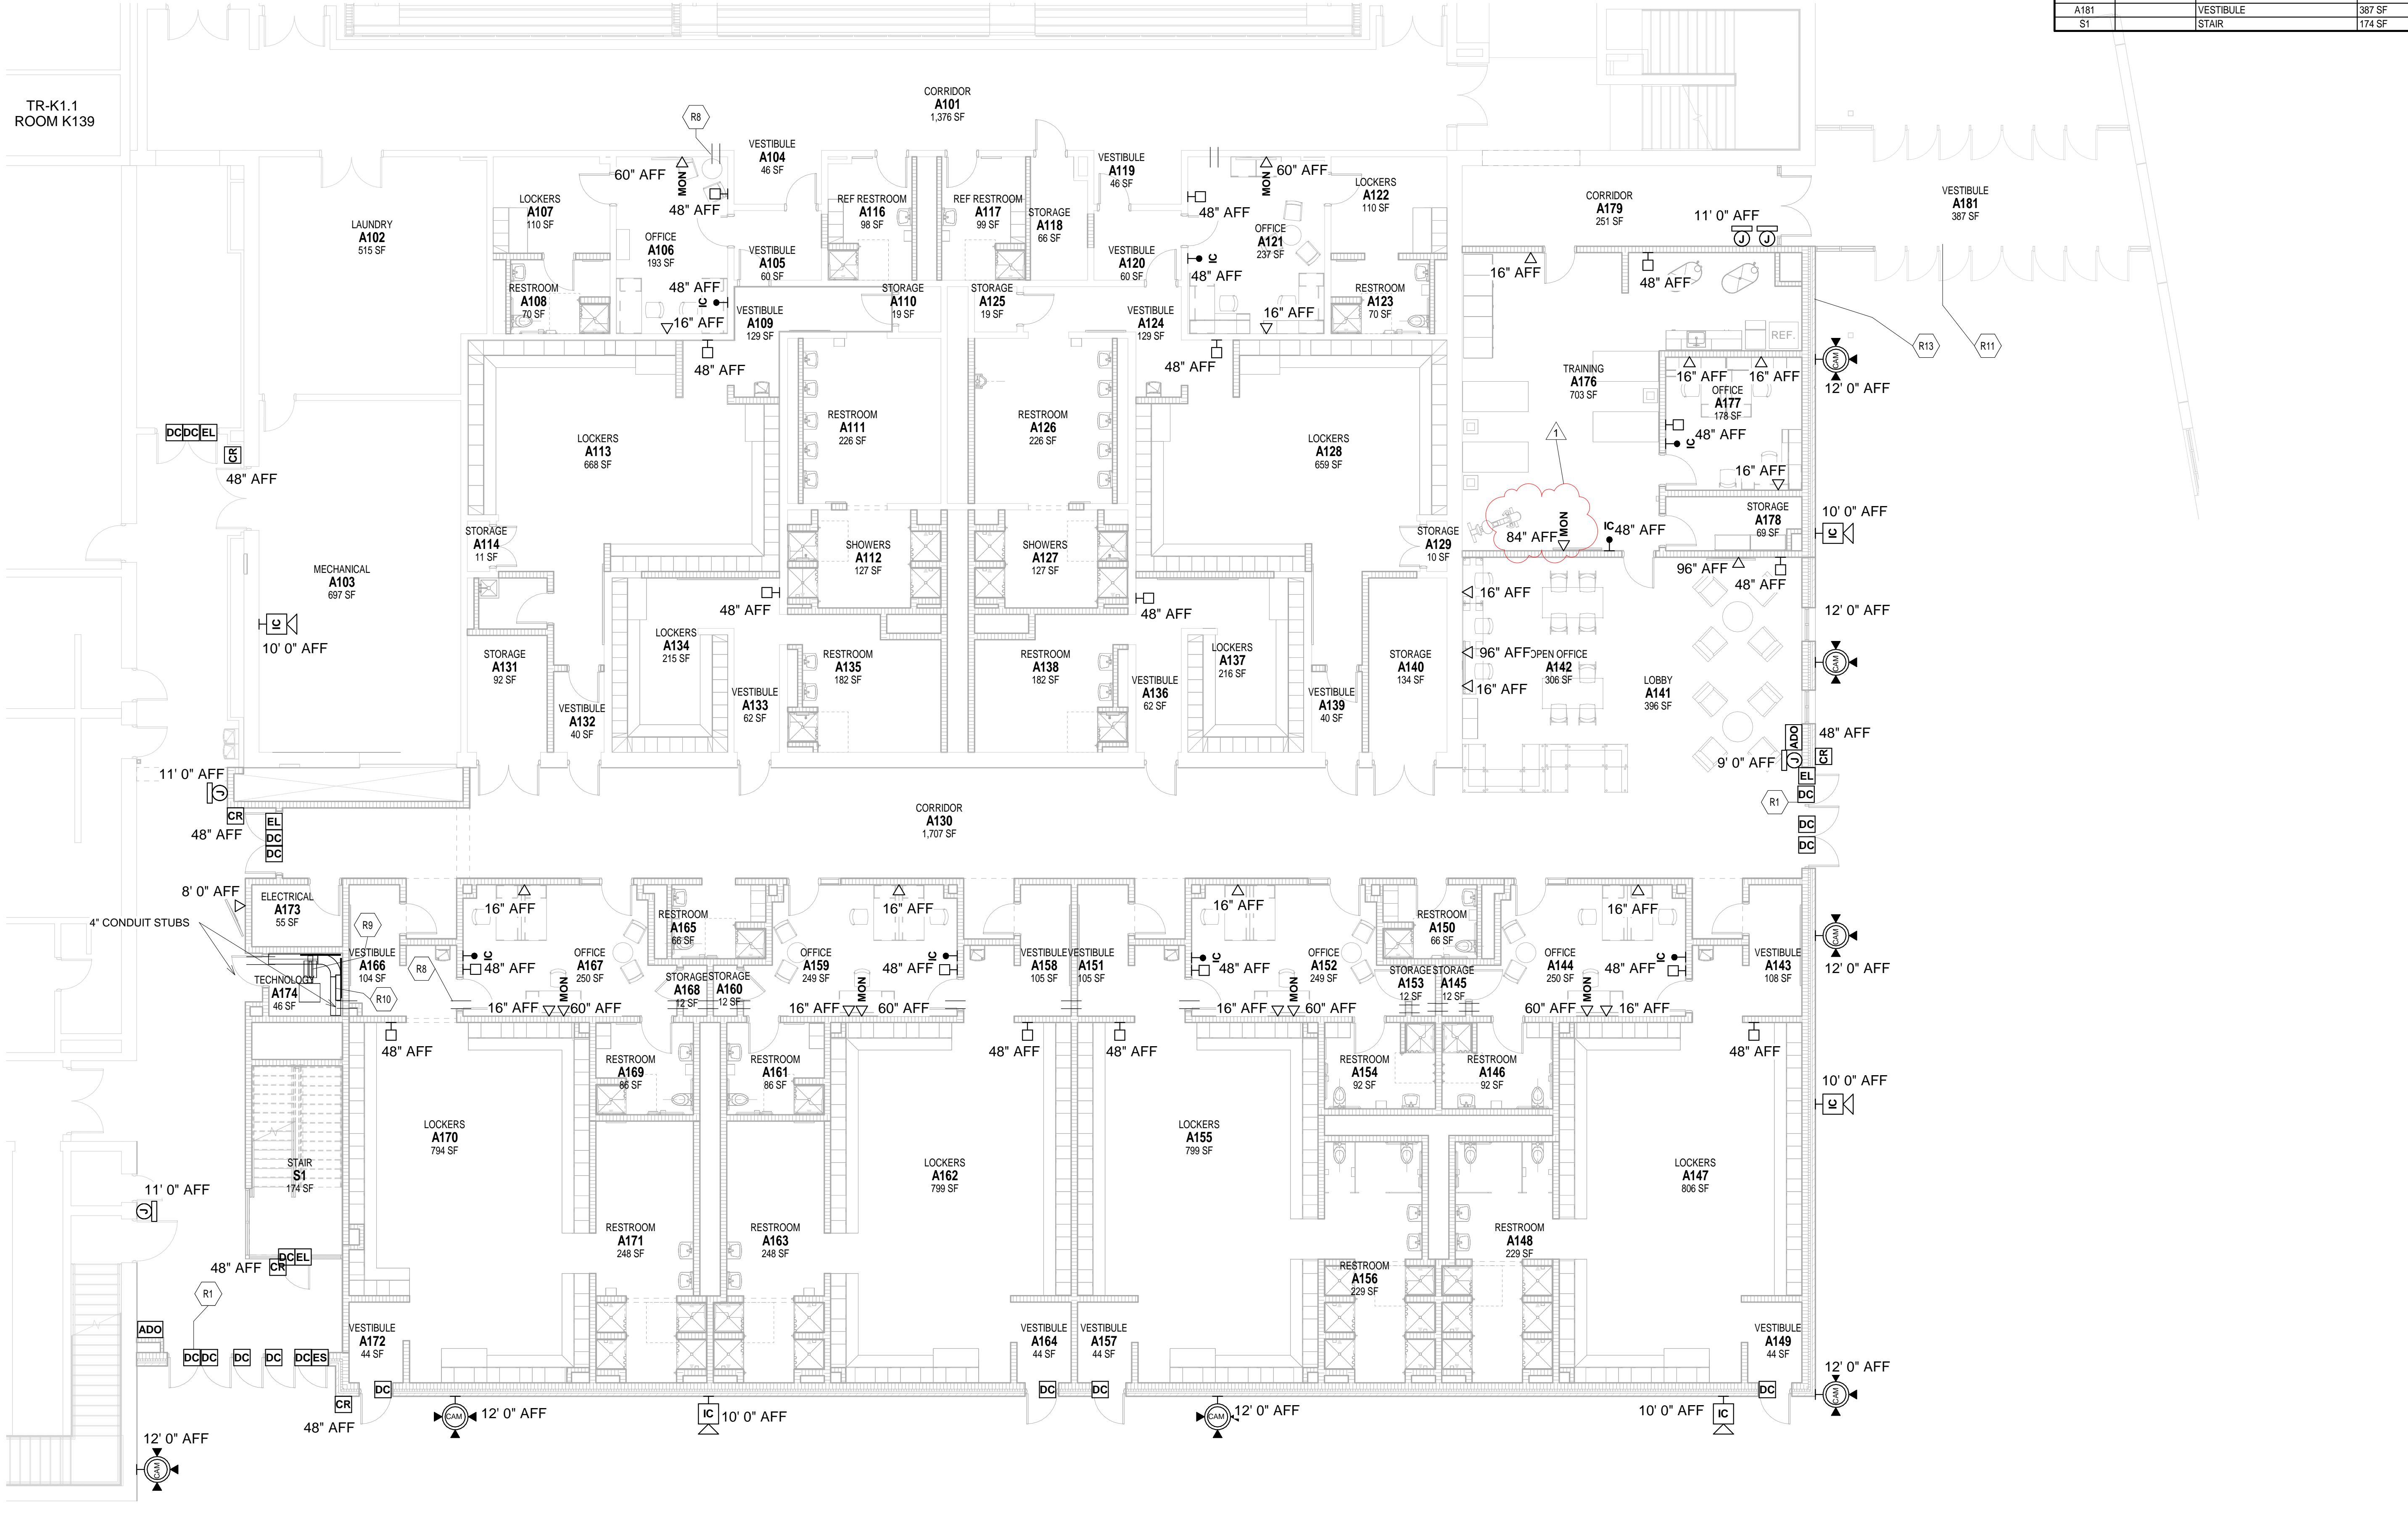

## 1 FIRST FLOOR TECHNOLOGY ROUGH-IN PLANS

SCALE: 1/8" = 1'-0"