

ADDENDUM NO. 02

February 19, 2025

ZHS Locker Room Addition & PVE Site Drainage
1000 Mulberry St., Zionsville, IN 46077 &
4700 S 975 E. Zionsville, IN 46077

TO: ALL BIDDERS OF RECORD

This Addendum forms a part of and modifies the Bidding Requirements, Contract Forms, Contract Conditions, the Specifications, and the Drawings dated January 21, 2025, by Fanning Howey Associates. Acknowledge receipt of the Addendum in the space provided on the Bid Form. Failure to do so may subject the Bidder to disqualification.

This Addendum consists of Pages ADD 2-1 through ADD 2-3 and attached Fanning Howey Associates, Inc. Addendum No. 02, dated February 18, 2025, consisting of 2 pages and 35 drawings.

A. 00 20 00 – INFORMATION AVAILABLE TO BIDDERS

1. Add the following paragraph to be included as part of this specification section:

E. Bidding Contractor question and answer log through February 18, 2025 is included as part of Addendum 02 for reference by Bidding Contractors.

B. 01 12 00 – MULTIPLE CONTRACT SUMMARY

1. Incorporate the following revisions to the Multiple Contract Summary as noted below as part of Addendum 02.

B. BID CATEGORY NO. 02 – GENERAL TRADES AT ZHS

Add the following clarifications:

29. General Trades Contractor is responsible for providing and installing the decorative concrete bollards noted by Plan Note 23 on the Site Plan.

30. General Trades Contractor is responsible for temporary wall partitions as noted in ZHS Locker Room Temporary Construction Plan. Wall construction shall be metal or wood studs spaced 16” on center with 5/8” drywall on both sides. Walls shall not be mechanically fastened

to finished flooring.

31. General Trades Contractor shall provide material and labor for eight (8) knock down door frames, slabs, and hardware to be installed in temporary wall partitions as requested by Construction Manager. Hardware shall be lockable.

32. General Trades Contractor is responsible for concrete jersey barriers with fencing as shown on the ZHS Exterior Logistics Plan. Jersey barriers shall be placed 4'-0" away from temporary construction fencing. Each barrier shall have 18" gap between them to allow pedestrian access to walking path.

33. General Trades Contractor is responsible for painting temporary pavement markings with high-visibility paint within the student pathway noted on ZHS Exterior Logistics Plan.

34. General Trades Contractor is responsible for demolition of existing landscaping and/or hardscaping, removal of topsoil and/or landscape bedding, preparation of subgrade and placing temporary access sidewalk(s) using lean concrete mix. The intent is to place a vapor barrier below the temporary slab to ensure easier demolition when required. Contractor shall reference ZHS Locker Room Temporary Construction Plan and ZHS Site Phasing Plan for extents of these temporary sidewalks

35. General Trades Contract is responsible for the stone access road described on ZHS Site Phasing Plan. The intent is to place 6" of #8 stone capped with 2" of compacted #53 stone in locations where asphalt is demolished in Phase 1 Site Work and within footprint of demolished building. Contractor shall include cost for material and labor for installation and removal.

36. Contractor shall reference ZHS Site Phasing Plan for additional information related to the sequencing of sitework activities.

C. BID CATEGORY NO. 03 – MASONRY

Add the following clarification:

10. Masonry Contractor is responsible for fabrication and installation of loose lintels for the Masonry scope of work.

11. Masonry Contractor shall include a \$25,000 Allowance for Scaffolding & Overhead Protection as shown on ZHS Locker Room Temporary Construction Plan. The intent is to install overhead protection for student / staff access to existing doorway. The protection shall be in place for the duration of time required to complete masonry work at the adjacent section of wall.

E. BID CATEGORY NO. 05 – ROOFING

Add the following clarification:

6. Roofing Contractor is responsible for top of wall parapets at all new and existing walls (both metal stud and masonry walls). This includes the plywood or sheathing, blocking or nailers, membrane flashing, metal coping and flashings, and all necessary fasteners and joint sealants.

7. In locations where existing metal roof coping is scheduled for removal and reinstallation, this removal is to be performed by the Roofing Contractor. Additionally, if the metal coping

cannot be removed without damage, the Roofing Contractor shall provide new coping to match existing at no additional cost.

M. BID CATEGORY NO. 13 – ELECTRICAL & TECHNOLOGY

Add the following clarification:

10. Electrical Contractor shall review the Architectural Door Hardware Schedule and Door Hardware Specification Section for comments or remarks about specific openings scheduled to tie into fire alarm system, access control, security system, etc. Contractor shall include necessary rough-in and cabling to accommodate connections to these systems.

11. Electrical Contractor shall de-energize and salvage existing light pole noted on ZHS Locker Room Temporary Construction Plan. Contractor shall provide an exterior wall-pack light in place of this existing light pole. New exterior light may be wired using existing circuit, run on battery power or solar power at Contractor's discretion. The light must remain in place for duration of project.

12. Electrical Contractor Shall re-install salvaged light pole noted in Clarification #11 above at the end of the project.




ZIONSVILLE
COMMUNITY SCHOOLS


ARCHITECT

FANNING HOWEY

(317) 848-0966 WWW.FHAI.COM
350 EAST NEW YORK ST, STE 300
INDIANAPOLIS, IN 46204

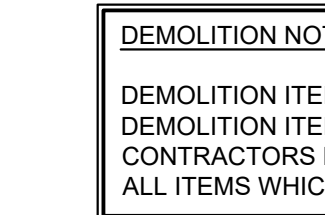
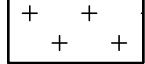
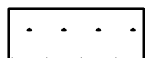
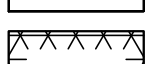
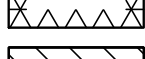
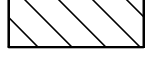
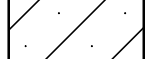
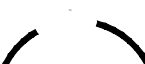



DEMOLITION KEYNOTES

- | | |
|---|---|
| 1. REMOVE EXISTING |  |
| 2. REMOVE EXISTING | |
| 3. REMOVE EXISTING | |
| 4. REMOVE EXISTING | |
| 5. REMOVE EXISTING
(SEE ARCHITECT) | |
| 6. REMOVE EXISTING | |
| 7. PROTECT EXISTING | |
| 8. SAWCUT EXISTING | |
| 9. REMOVE EXISTING | |
| 10. REMOVE EXISTING | |
| 11. REMOVE EXISTING | |
| 12. EXISTING SANITARY
(PROTECT DURING) | |
| 13. EXISTING UNDER
(PROTECT DURING) | |
| 14. REMOVE EXISTING | |
| 15. EXISTING PARKING | |
| 16. EXISTING STORAGE | |
| 17. EXISTING SANITARY SEWER TO REMAIN IN SERVICE (SEE PLUMBING PLANS) | |

DEMOL

Parent Drive

- | | |
|---|---|
|  | APPROXIMATE LIMITS OF PARKING ISLAND REMOVAL |
|  | APPROXIMATE LIMITS OF LANDSCAPING REMOVAL |
|  | EXISTING BUILDING TO BE REMOVED
(SEE ARCHITECTURAL DEMO PLANS) |
|  | CROSS WALK STRIPING TO BE REMOVED |
|  | EXISTING PARKING LOT SURFACE TO BE MILLED 1" FOR RESURFACING |
|  | TREE PROTECTION REQUIRED |
|  | |
|  | TREE TO BE REMOVED |
|  | APPROXIMATE LIMITS OF UTILITY LINE REMOVAL |

PROJECT MANAGER: DBS
DRAWN BY: CDL
PROJECT NUMBER: 224018.00 (TLF JOB #2024-090)
PROJECT ISSUE DATE: 01.21.2025

[illegible]

ZHS Exterior Logistics Plan



**Know what's below.
Call before you dig.**

Call 811 or 1-800-382-5544 Before You Begin Any Digging Project.
Call 48 hours or 2 working days before you dig.
It's Fast, It's Easy and It's the Law in the state of Indiana!

CAUTION !!

THE LOCATIONS OF ALL EXISTING UNDERGROUND UTILITIES SHOWN ON THE PLAN ARE BASED UPON ABOVE GROUND EVIDENCE (INCLUDING, BUT NOT LIMITED TO, MANHOLES, INLETS, VALVES, AND MARKS MADE UPON THE GROUND BY OTHERS) AND ARE SPECULATIVE IN NATURE. THERE MAY ALSO BE OTHER EXISTING UNDERGROUND UTILITIES FOR WHICH THERE IS NO ABOVE GROUND EVIDENCE OR FOR WHICH NO ABOVE GROUND EVIDENCE WAS OBSERVED. THE EXACT LOCATIONS OF EXISTING UNDERGROUND UTILITIES SHALL BE VERIFIED BY CONTRACTOR PRIOR TO ANY AND ALL CONSTRUCTION.

LEGEND:

- Proposed Student / Staff Egress Pattern
- T.P. Temporary Wall Partition (by General Trades)
- Scaffold & Overhead Protection (by Masonry Contractor)
- Temporary Lean Concrete Sidewalk (by General Trades)

close exit
corridor
access

construction/
maintenance
access only

door closed
during
construction

close RRs

closed exit

closed
stair exit

ZCS staff &
maintenance
access only

Renovation Phase:
April 2026 - Sept 2026

Temp. HVAC
Vertical Chace
2nd floor

New Addition Phase:
June 2025 - July 2026

4" lean concrete
sidewalk on vapor
barrier. Continues to
asphalt parking lot. (by
General Trades)

Scaffolding
& Overhead
Protection
(by Masonry
Contractor)

Remove and Infill
landscape island
with 4" lean
concrete
sidewalk on
vapor barrier (by
General Trades)

Light pole to
salvage and
replace with wall
pack (by
Electrical
Contractor)

Edge of Existing
Curb/Walk

Edge of New Addition

- ARCHITECTURAL DEMOLITION GENERAL NOTES
- DEMOLITION IS TO FOLLOW ESTABLISHED CONSTRUCTION SEQUENCE. CONTRACTOR IS TO VERIFY THEIR WORK IN THE FIELD WITH THE DEMOLITION DRAWINGS, NEW CONSTRUCTION DRAWINGS, AND THE EXISTING IN-FIELD CONDITIONS. REPORT DISCREPANCIES TO THE ARCHITECT.
 - "FLOORING" DENOTES FLOOR COVERING MATERIALS INCLUDING BACKINGS, ADHESIVES, BASES, DOWN TO BUT EXCLUSIVE OF FLOOR SLABS AND STRUCTURAL MATERIALS, UNLESS NOTED OTHERWISE.
 - "CEILING" DENOTES CEILING MATERIALS INCLUDING SUSPENSION SYSTEMS, ADHESIVE RESIDUES, MOLDINGS, UP TO BUT EXCLUSIVE OF STRUCTURAL MATERIALS.
 - WALLS TO BE REMOVED SHALL BE REMOVED TO A POINT 2" (MIN) BELOW THE EXISTING FLOOR SLAB UNLESS SETTING ON SLAB. PATCH WITH NEW CONCRETE TO BE FLUSH WITH THE EXISTING FLOOR SLAB.
 - WHEN OPENINGS ARE CUT INTO AN EXISTING WALL, THE OPENING SHALL BE A MINIMUM OF 4" LONGER THAN THE FINISHED OPENING REQUIRED TO ALLOW FOR 8" (MIN) OF NEW CMU TOOTHED-IN AT EDGES.
 - AFTER THE DEMOLITION OF MATERIALS, THE RESULTING EXPOSED SURFACE SHALL BE SMOOTH AND FLUSH WITH EXISTING CONDITIONS.
 - MECHANICAL AND ELECTRICAL ITEMS THAT ARE CAPPED AND ABANDONED SHALL BE LOCATED BEHIND FINAL FINISH SYSTEMS.
 - COORDINATE THIS WORK WITH DEMOLITION WORK ON SITE. STRUCTURAL, PLUMBING, MECHANICAL, AND ELECTRICAL.
 - PROVIDE INTERIOR AND EXTERIOR SHORING, BRACING, OR SUPPORT TO PREVENT MOVEMENT OR SETTLEMENT OF EXISTING STRUCTURES.
 - CONTRACTOR TO FIELD VERIFY PORTIONS OR SECTIONS OF EXISTING WALLS TO BE FILLED IN AND SALVAGE NECESSARY MATERIAL.
 - MATERIALS OF DEMOLITION SHALL BE DISPOSED OF OFF-SITE UNLESS OTHERWISE DIRECTED BY OWNER.
 - OWNER TO REMOVE EXISTING FURNITURE AND MISCELLANEOUS ITEMS NOT SHOWN AND NOT TO BE DEMOLISHED. CONTRACTOR TO NOTIFY OWNER IN ADVANCE WHEN ITEMS NEED TO BE REMOVED. CONTRACTOR IS RESPONSIBLE FOR OTHER ITEMS TO BE REMOVED.
 - ITEMS TO BE PATCHED. REMOVE ALL LOOSE OR DAMAGED MATERIAL. REFINISH TO LIKE NEW CONDITION, OR IF CONDITION WARRANTS REPLACE IN ENTIRETY.
 - THE OWNER SHALL RESERVE RIGHT TO CLAIM ANY MATERIALS THAT ARE BEING DEMOLISHED PRIOR TO THE CONTRACTOR DISPOSING OF THEM OFF SITE.
 - "TURNED OVER TO THE OWNER" DENOTES: 1) TAG AND IDENTIFY ITEMS 2) STORE IN AN ORDERLY FASHION IN A LOCATION DESIGNATED BY THE OWNER.
 - ITEMS MADE OBSOLETE TO ACCOMMODATE NEW CONSTRUCTION OR RENOVATION SHALL BE REMOVED. ITEMS TO BE REMOVED SHALL BE REMOVED IN THEIR ENTIRETY.
 - AFTER REMOVAL OF ITEMS, THE EXISTING WALL SURFACES (IF EXPOSED) SHALL BE REPAIRED/PATCHED AS REQUIRED TO RECEIVE NEW FINISHES.
 - DEMOLISH EXTERIOR LOCKERS BUILDING COMPLETELY. SEE CIVIL SITE DRAWINGS FOR MORE DETAILS.

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**ZIONSVILLE
COMMUNITY HIGH
SCHOOL ATHLETIC
LOCKER ROOMS
ADDITION AND
RENOVATION**

1000 MULBERRY STREET,
ZIONSVILLE, IN 46077


ZIONSVILLE COMMUNITY
SCHOOLS



ARCHITECT

**FANNING
HOWEY**

52-3573 WWW.FHAI.COM
BERRY ST. ZIONSVILLE, IN 46077

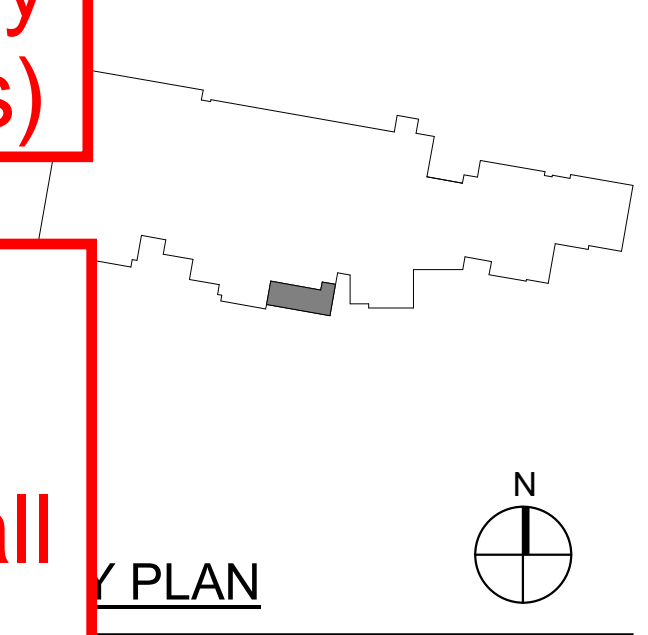

PLAN

PROJECT MANAGER: JM

BY: Author

CT NUMBER: 224018.00


CT ISSUE DATE: 01/21/2025

DESCRIPTION

DATE

ZHS Locker Room
Temporary Construction
Plan

VERIFICATION NOTE
CONTRACTOR SHALL VERIFY ALL DIMENSIONS AND CLEARANCES AND ALL EXISTING FIELD CONDITIONS BEFORE STARTING CONSTRUCTION. COMMENCEMENT OF WORK CONSTITUTES ACCEPTANCE OF CONDITIONS.
SHOULD DIFFERENT CONDITIONS BE ENCOUNTERED, CONTACT THE ARCHITECT BEFORE PROCEEDING WITH WORK.

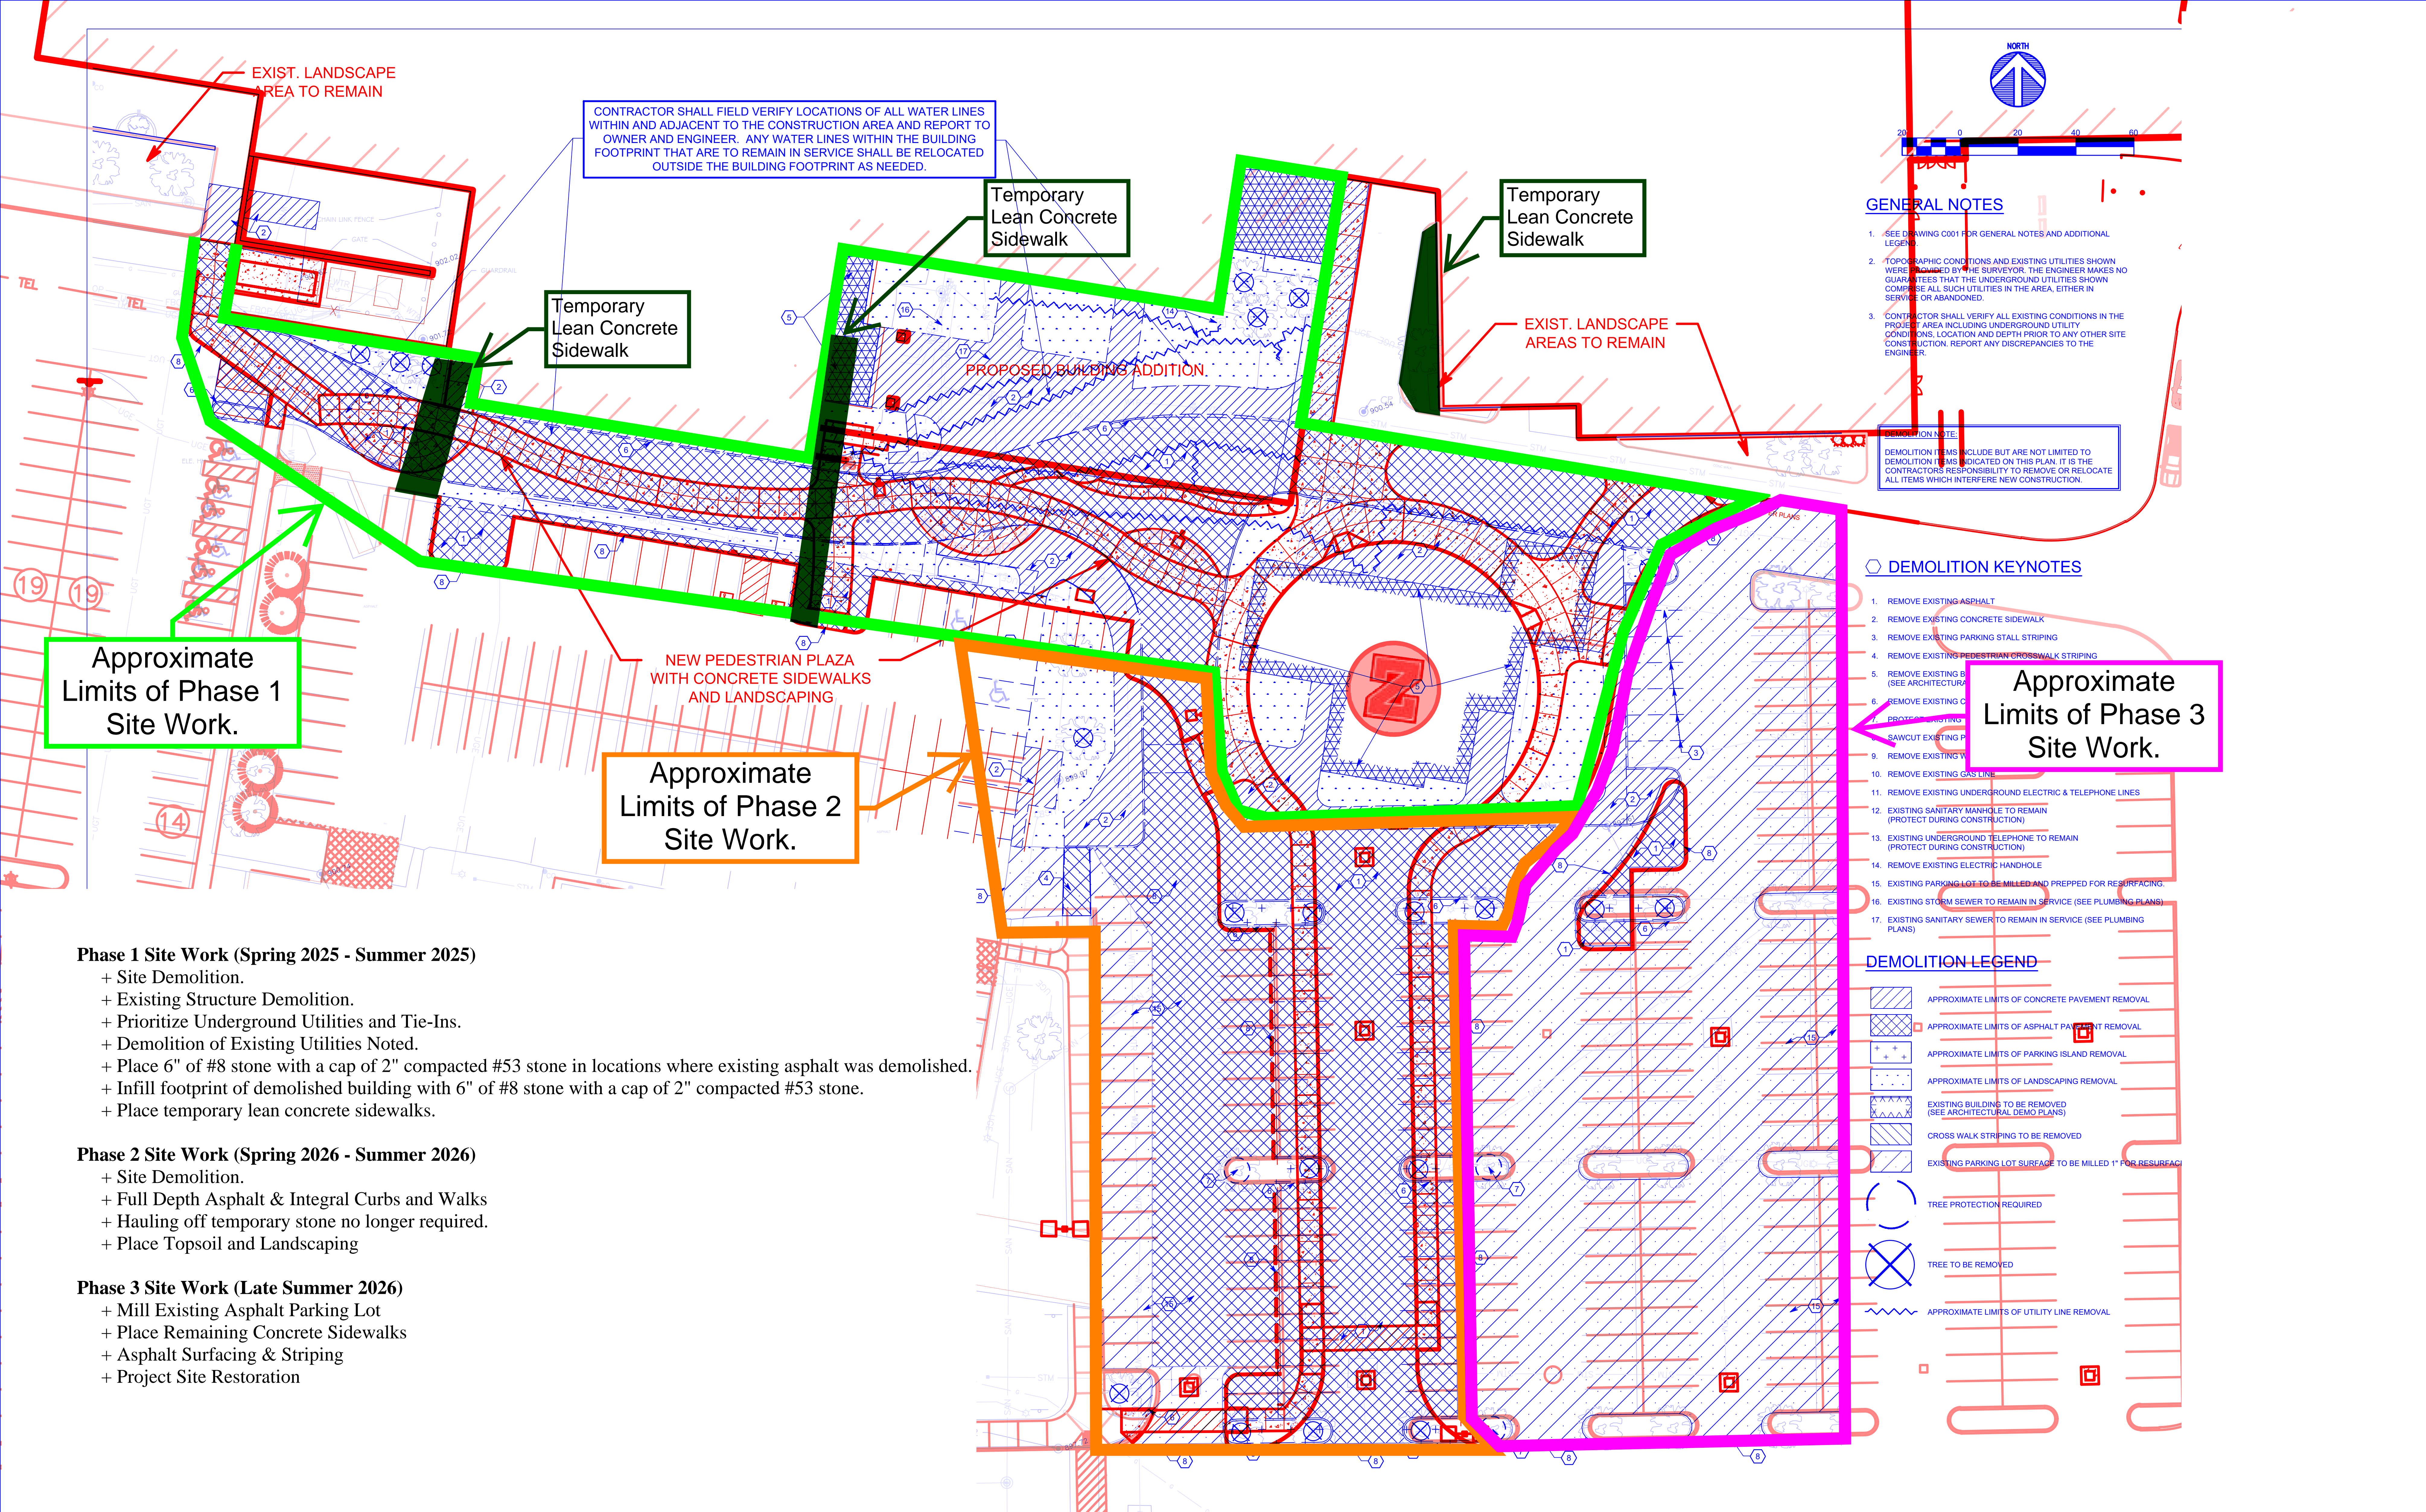

ZHS Site Phasing Plan

ADDENDUM NO. 2

Zionsville Community High School Athletic Locker Room Additions

Pleasant View Elementary School – Site Drainage Improvements

Zionsville Community Schools
Zionsville, Indiana

Project No. 224018.00

Project No. 223126.00

Index of Contents

Addendum No. 2, 10 items, 2 pages

Revised Project Manual Section: 32 12 23 – Imprinted Asphalt

Revised Drawing Sheets: G1-01, G1-02, SU1-0, S4-04, S5-03, S5-04, S5-05, S5-06, S5-07, AD-02, A-12, AC-11, AC-12, A3-03, A3-04, A3-05, A3-10, A3-11, A3-12, A5-01, A5-03, AI-12, AI-22, AI-61, AQ-11, AQ-12, AQ-61, MV-11, MP-11, MP-21, M4-01, M7-01, EP-12, E-61, and T-12
Pre-Bid Clarification Log

Date: February 18, 2025

I hereby certify that this Addendum was prepared by me or under my direct supervision and that I am a duly registered Architect/Engineer under the Laws of the State of Indiana.

FANNING/HOWEY ASSOCIATES, INC.
ARCHITECTS/ENGINEERS/CONSULTANTS



Paul A. Miller
Registration Number AR10800161

TO: ALL BIDDERS OF RECORD

ADDENDUM NO. 2 to Drawings and Project Manual, dated January 24, 2025, for Zionsville Community High School Athletic Locker Room Additions and Various Projects for Zionsville Community Schools, 900 Mulberry Street, Zionsville, Indiana, 46077; as prepared by Fanning/Howey Associates, Inc., Indianapolis, Indiana. This Addendum shall hereby be and become a part of the Contract Documents the same as if originally bound thereto.

The following clarifications, amendments, additions, revisions, changes, and modifications change the original Contract Documents only in the amount and to the extent hereinafter specified in this Addendum.

Each bidder shall acknowledge receipt of this Addendum in his proposal or bid.

NOTE: Bidders are responsible for becoming familiar with every item of this Addendum. (This includes miscellaneous items at the very end of this Addendum.)

RE: ALL BIDDERS

ITEM NO. 1. ADDENDUM NO. 1

- A. Revised Drawing A6S-01: References and notes clouded for Addendum No. 1 indicating “safety glass” shall be changed to the following:

“Security Glazing/Safety Glass”

ITEM NO. 2. REVISED PROJECT MANUAL SECTION

- A. Section 32 12 23 – Imprinted Asphalt has been revised, dated 2/18/24, and is included with and hereby made a part of this Addendum.

ITEM NO. 3. PROJECT MANUAL, SECTION 05 50 00 – METAL FABRICATIONS

- A. Add 2.10, A., 1., 2., and 3., as follows:

- “1. Bent plates for opening jambs, metal wall covers, shall be installed as masonry wall is constructed or within existing wall opening after demolition.
2. Provide with integrally welded steel stop anchors for securing into adjoining masonry. Where indicated provide pre-drilled holes for flat head fasteners/anchors.
3. Prime paint bent plates.

ITEM NO. 4. PROJECT MANUAL, SECTION 08 80 00 - GLAZING

- A. Article 2.8, B., 4: Change “(Security Glazing)” to “(Security Glazing/Safety Glass)”.

ITEM NO. 5. PROJECT MANUAL, SECTION 09 84 33.13 – ABUSE-RESISTANT SOUND-ABSORBING WALL UNITS

- A. Replace 2.3, B., 1., as follows:

- “1. Basis of Design: Tectum Direct Attach standard wall panels.”

ITEM NO. 6. PROJECT MANUAL, SECTION 09 96 00 – HIGH-PERFORMANCE COATINGS

A. Add 3.10, B., 2., d., 3) as follows:

“3) Bent plates/metal wall covers at openings.”

ITEM NO. 7. PROJECT MANUAL, SECTION 10 14 19 – DIMENSIONAL LETTER SIGNAGE

A. Replace 2.2, A., 8., as follows:

“8. Interior and Exterior locations.”

ITEM NO. 8. PROJECT MANUAL, SECTION 11 66 00 – ATHLETIC EQUIPMENT

A. Replace 2.8, A., as follows:

“A. Fully programmable control processor.

1. Products similar to Total System Control, TSC1500XL by Performance Sports Systems.
2. Provide one 5.7 inch touch screen unit, wall mounted and connected to power and system relay panels.
 - a. Allow one touch operation of motorized physical education equipment in the activity space.
 - b. Provide school logo on touch screen.
 - c. Password controlled system.
3. Operation: 120V with controller interface operating on 24 vdc from supplied transformer.
4. Manual control override unit.”

B. Article 2.8, B., 3., a: Change “10 devices” to “5 devices”.

C. Delete 2.8, C., in its entirety.

ITEM NO. 9. ACCEPTABLE MANUFACTURERS

The following manufacturers are to be considered acceptable manufacturers (suppliers and fabricators) for the Sections of the Specifications listed. Listed manufacturers are required to bid on products equal in type and design, size, function, and quality to that originally specified. Final decision as to equality of products specified versus those proposed shall be made by the Architect.

Section 09 67 66 – Fluid-Applied Athletic Flooring

- RFS Sports, Kemah, Texas (2.1, A., 2., Alternate Bid products only, base coat shall be pigmented)

Section 27 13 23 – Communications Fiber Optical Backbone Cabling

- General Cable (Fiber)

- Panduit (Fiber optic patch panels, connectors and closet connector housing panels)

ZIONSVILLE COMMUNITY HIGH SCHOOL ATHLETIC LOCKER ROOM ADDITIONS

ITEM NO. 10. REVISED DRAWING SHEETS

A. Drawing Sheets: G1-01, G1-02, SU1-0, S4-04, S5-03, S5-04, S5-05, S5-06, S5-07, AD-02, A-12, AC-11, AC-12, A3-03, A3-04, A3-05, A3-10, A3-11, A3-12, A5-01, A5-03, AI-12, AI-22, AI-61, AQ-11, AQ-12, AQ-61, MV-11, MP-11, MP-21, M4-01, M7-01, EP-12, E-61, and T-12 have been revised, dated 2/18/25, and are included with and hereby made a part of this Addendum. These Drawings supersede the original documents.

END OF ADDENDUM

Addendum No. 2

Zionsville Community High School Athletic Locker Room Additions
Zionsville Community Schools

SECTION 321223 - IMPRINTED ASPHALT

PART 1 - GENERAL

1.1 SUMMARY

A. Section Includes

1. Imprinting new paving.
2. Imprinting existing paving.

B. Related Requirements:

1. Section 321216 "Asphalt Paving" for new asphalt paving.
2. Section 321723 "Pavement Markings"

1.2 PREINSTALLATION MEETINGS

- ##### A. Preinstallation Conference: Conduct conference at the Site with Contractor, Subcontractor, Engineer, Architect (optional) and Owner optional prior to installation

1.3 ACTION SUBMITTALS

A. Product Data:

1. Coating system.
2. Thermoplastic marking material.

B. Shop Drawings:

1. Indicate imprinted patterns, colors, and dimensions to adjacent work.

C. Samples for Initial Selection: For each type of product requiring color selection.

D. Samples for Verification: For each pattern and color, in manufacturer's standard sizes.

1.4 INFORMATIONAL SUBMITTALS

A. Qualification Data: For Installer.

1.5 QUALITY ASSURANCE

- ##### A. Installer Qualifications: Imprinted-asphalt manufacturer's authorized Installer who is trained and approved for installation of imprinted asphalt required for this Project.

1.6 FIELD CONDITIONS

- ##### A. Environmental Limitations: Proceed with coating imprinted paving only when air temperature is at least 45 deg F and rising and will not drop below 45 deg F within

eight hours of coating application. Proceed only if no precipitation is expected within two hours after applying the final layer of coating.

PART 2 - PRODUCTS

2.1 THERMOPLASTIC OVERLAY

- A. Manufacturers: Subject to compliance with requirements, available manufacturers offering products that may be incorporated into the Work include, but are not limited to, the following:
 - 1. DecoMark by Ennis-Flint, Inc.
- B. Source Limitations: Obtain imprinted asphalt materials from single source from single manufacturer.

2.2 MATERIALS

- A. Coating System: Imprinted-asphalt manufacturer's standard system formulated for exterior application on asphalt paving surfaces. Must be composed of an ester modified rosin resistant to degradation by motor fuels, lubricants, etc. in conjunction with aggregates, pigments, binders and anti-skid/slip elements. Pigments and anti-skid/slip elements must be uniformly distributed throughout the material.
 - 1. Pattern: Zionsville Schools "Z" logo as indicated on Drawings
 - 2. Top Coating: Epoxy-modified acrylic polymer blended with sand and aggregate, formulated for exterior application on asphalt paving surfaces.
 - 3. Colorant: UV-stable pigment blend, added to each coating layer.
 - 4. Color: as specified and approved by Owner.
- B. Thermoplastic Marking Material: The thermoplastic material shall conform to AASHTO designation M249, with the exception of the relevant differences due to the material being supplied in a preformed state, being non-reflective, and potential being of a color different from white or yellow.
 - 1. Anti-Skid/Anti-Slip Elements: The material must be a resilient preformed thermoplastic product which contains a minimum of thirty percent (30%) intermixed anti-skid/anti-slip elements and where the top surface contains anti-skid/anti-slip elements. These anti-skid/anti-slip elements must have a minimum hardness of 9 (Mohs scale).
 - 2. Pigments: White: The material shall be manufactured with sufficient titanium dioxide pigment to meet FHWA Docket No. FHWA-99-6190 Table 5 and Table 6 as revised and corrected. Red, Blue and Yellow: The material shall be manufactured with sufficient pigment to meet FHWA Docket No. FHWA-99-6190 Table 5 and Table 6 as revised and corrected. The pigment system must not contain heavy metals nor any carcinogen, as defined in 29 CFR 1910.1200 in amounts exceeding permissible limits as defined in relevant Federal Regulations. Other Colors: The pigment system must not contain heavy metals nor any carcinogen, as defined in 29 CFR 1910.1200 in amounts exceeding permissible limits as defined in relevant Federal Regulations.
- C. Heating Indicators: The top surface of the material shall have regularly spaced indents. The closing of these indents during application, shall act as a visual cue that the

material has reached a molten state allowing for satisfactory adhesion and proper embedment of the slip/skid resistant elements, and a post-application visual cue that the proper application procedures have been followed.

- D. Skid Resistance: The surface of the preformed thermoplastic material shall contain factory applied non-skid material with a minimum hardness of 9 (Mohs scale). Upon application the material shall provide a minimum static coefficient of 0.6 when tested according to ASTM C 1028 (wet and dry), and a minimum static coefficient of 0.6 when tested according to ASTM C 2047.
- E. Thickness: The material must be supplied at a minimum thickness of 125 mil (3.18 mm).
- F. Environmental Resistance: The material must be resistant to deterioration due to exposure to sunlight, water, salt or adverse weather conditions and impervious to oil and gasoline
- G. Interconnected: If multicolored, the material must consist of interconnected individual pieces of preformed thermoplastic material, which through a variety of colors and patterns make up the desired design. The individual pieces in each material segment, typically 24 in. (.6 m) by 36 in (.91 m), must be factory assembled with a compatible material and interconnected so that in the field it is no necessary to assemble the individual pieces within a material segment.

PART 3 - EXECUTION

3.1 EXAMINATION

- A. Verify that asphalt paving is dry and in suitable condition to begin imprinting process in accordance with manufacturer's written instructions.
- B. Proceed with asphalt imprinting only after unsatisfactory conditions have been corrected.
- C. Verify that utilities, traffic loop detectors, and other items requiring a cut and installation beneath the asphalt surface or repairs to the asphalt surface have been completed and that asphalt surface is flush with adjacent asphalt prior to beginning installation of imprinted asphalt.

3.2 APPLICATION

- A. The material shall be applied using the heating method recommended by the manufacturer. The material must be applied at ambient and road temperatures down to 45 deg F (7 deg C) without any preheating of the pavement to a specific temperature. A 2-component sealer specified by the manufacturer must be applied to the substrate prior to material application to assure proper adhesion. A thermometer shall not be required during the application process. The pavement shall be clean, dry and free of debris. Supplier must enclose application instructions with each box/package.
 - 1. Direct flame heaters are not permitted.
- B. Applying Coating: After imprinted surface has cooled, apply coating per manufacturers instructions. Do not allow traffic until coating has completely dried and cured.



- C. Applying Thermoplastic Marking Material: Position thermoplastic marking material aligned with marked pattern and slowly heat until marking material begins to liquefy and flow. Do not allow traffic until coating has been applied and completely dried and cured.
- D. Repairs: Perform repairs to defective locations in accordance with manufacturer's instructions.

END OF SECTION 321223

PRE-BID REQUEST FOR INTERPRETATION/CLARIFICATION LOG				
RFI#	Date Received	Request for Interpretation Item	Dwg./Spec.	Response
Project No. 224018.00 - Zionsville Community High School Athletic Locker Room Additions and Renovations and Various Projects				
1	2/10/25	Sheet S4-05 is missing from the documents. It's not noted in the sheet index, but it's called-out on structural (see S1-01). Please provide the missing sheet.		Sheet S4-05 Will be added as part of addendum 1
2	2/10/25	Please advise on the size of the building expansion joint (keynote 8 on A-11). Enlarged detail 8 on A5-03 does not provide any information.		Addressed in addendum 1
3	2/10/25	The exterior wall detail on AP-01 shows 2-1/8" rigid insulation over Air Barrier. Details on A6-01 point to the masonry cavity insulation calling it " <i>Thermal and Air Barrier Assembly</i> ". There is no spec for insulation as air barrier system, but there is a " <i>Vapor-Permeable, Fluid-Applied Membrane Air Barrier</i> " spec section. It's our understanding that the detail on AP-01 is correct (separate insulation and air barrier products), but can you please confirm?		Addressed in addendum 1
4	2/10/25	There are a few areas in the new building addition that do not have wall tags. Most of the rooms are shown on A4-02 and A4-03, but areas at Vestibule and Office (such as A166 and A167) do not have tags. Please provide.		Addressed in addendum 1
5	2/10/25	On sheet A3-11 section 1, there is a note regarding demo of existing counterflashing. Is removal of existing masonry required, or can the flashing be cut flush with the face of the brick, mortar joint grinded-out and tuck-pointed?		Addressed in addendum 1
6	2/10/25	Is the existing brick, that will be visible to the new interior, required to be cleaned?		Addressed in addendum 1
7	2/10/25	Is there a vertical reinforcement requirement for the interior walls that sit on thicken slab? Detail 5 on S3-03 does not indicate any, but detail 2 on S4-01 says "see plan", but nothing noted on the plans. Please note, almost all of the walls are partial height walls, extending 4" above ceiling.		Addendum 2

8	2/11/25	Acoustical ceiling clouds on the RCP. Can you please ask the Architect what they want for perimeter trim and what size?		Refer to Section 09 51 13, Article 2.6 B.
9	2/14/25	Spec 098433.13 – abuse-resistant sound-absorbing wall units list the product but then says to refer to the “list of finishes” for the color and the design. There is nothing on the finish list drawing for the products in this spec, AR-AWT1&2. Can you please have the architect provide clarification on the color and product number for the design for these panels?		Addendum 2
10	2/14/25	The 095113 acoustical ceiling spec call out 10 ga, 0.135” hanger wire. This is something that is “above and beyond” in this market and is quite expensive in terms of material and labor. The manufacturer recommends using 12 ga which is more suited for applications such as this. Can you please have the architect confirm that 12 ga, 0.103”, hanger wire is acceptable?		The specification will not change.
11	2/14/25	I went through this project thoroughly yesterday and could not identify the different locker types. There are 4 locker types: A, B, C and E. What I am requesting is elevation drawings for these locker types. The specs are not clear nor do they identify different locker types or sizes. One additional question is are we to include the lockers in Restrooms A116 and A117? These restrooms show lockers, but not identify by a type as the locker rooms show.		AQ-11, keynote #3 Locker details and elevations, see 2-AQ-61.
12	2/14/25	Spec Section 230900 Page 11 2.9B1 states MSTP and IP is acceptable and then 2.9B2 states that all Bacnet devices shall connect via Ethernet. Is it the intent to do all Ethernet-based controllers on this project? This would be a first for this district and will add additional cost to the project.		This is typical in our specifications, no changes.
13	2/14/25	Spec Section 230900 Page 16 Section H1 states that a Central Integrated Server to NAC shall be provided. There is currently a Trane Ensemble Server onsite and the plan is to integrate this job into that. Is that acceptable?		Acceptable.

[illegible]

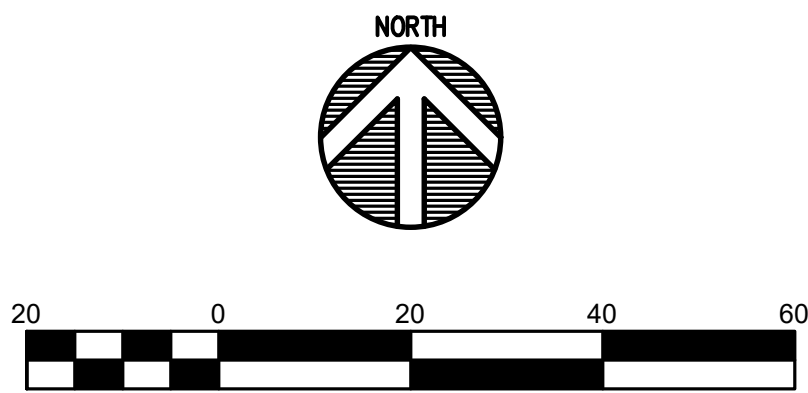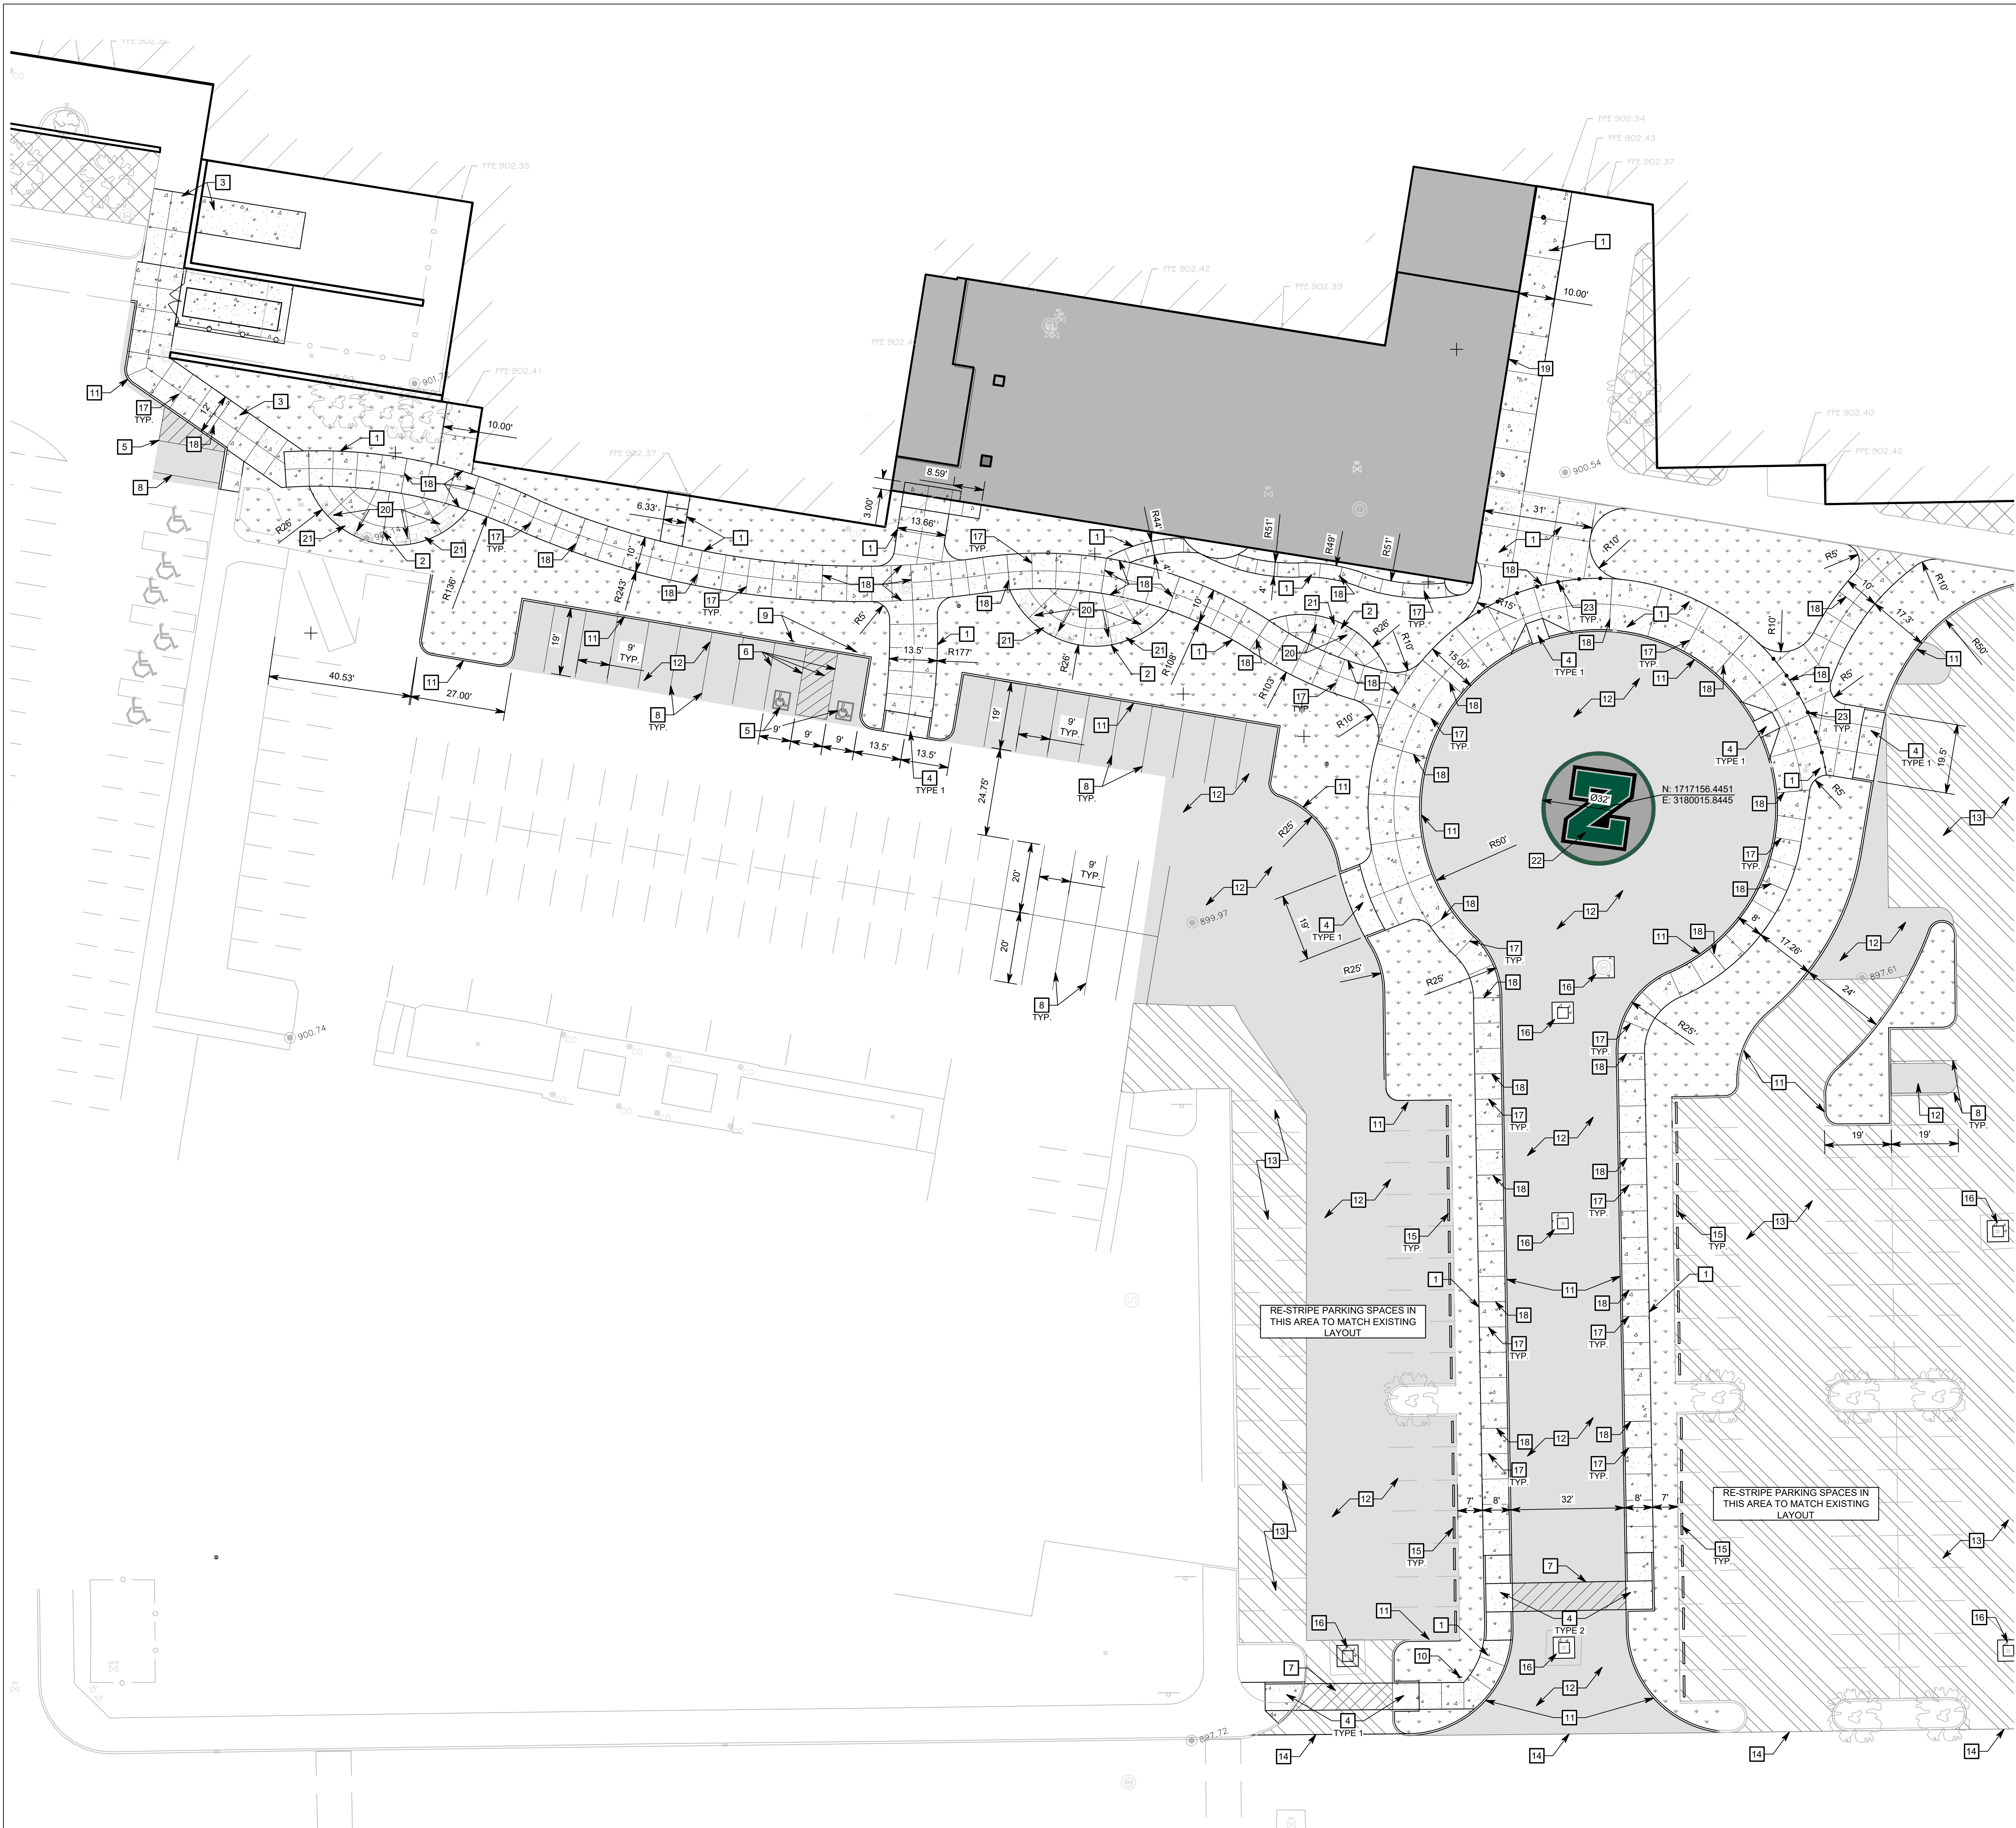

GENERAL NOTES


1. SEE DRAWING G0-01 FOR GENERAL NOTES AND ADDITIONAL LEGEND.
2. TOPOGRAPHIC CONDITIONS AND EXISTING UTILITIES SHOWN WERE PROVIDED BY THE SURVEYOR. THE ENGINEER MAKES NO GUARANTEES THAT THE UNDERGROUND UTILITIES SHOWN COMPRISE ALL SUCH UTILITIES IN THE AREA, EITHER IN SERVICE OR ABANDONED.
3. CONTRACTOR SHALL VERIFY ALL EXISTING CONDITIONS IN THE PROJECT AREA INCLUDING UNDERGROUND UTILITY CONDITIONS, LOCATION AND DEPTH PRIOR TO ANY OTHER SITE CONSTRUCTION. REPORT ANY DISCREPANCIES TO THE ENGINEER.

SITE KEYNOTES


1. CONCRETE SIDEWALK. SEE DETAIL A/G4-00.
2. CONCRETE PEDESTRIAN PLAZA. SEE DETAIL A/G4-00.
3. TEMPORARY SIDEWALK PATH TO BE REMOVED DURING NEXT PROJECT PHASE. SEE DETAIL A/G4-00.
4. ADA RAMP WITH DETECTABLE WARNING STRIP. SEE DETAIL J/G4-00.
5. ADA PARKING SYMBOL. SEE DETAIL D/G4-00.
6. ADA PARKING STRIPING (BLUE). SEE DETAIL E/G4-00.
7. CROSS WALK STRIPING (WHITE). SEE DETAIL F/G4-00.
8. PARKING STALL STRIPING (4" YELLOW PAINT).
9. ADA PARKING SIGN. SEE DETAIL G/G4-00.
10. STOP SIGN. SEE DETAILS G/G4-00 & H/G4-00.
11. 6" CONCRETE CURB. SEE DETAIL B/G4-00.
12. NEW ASPHALT PAVEMENT. SEE DETAIL C/G4-00.
13. RESURFACED ASPHALT PAVEMENT. SEE DETAIL C/G4-00.
14. PAVEMENT INTERFACE WITH EXISTING. SEE DETAIL M/G4-00.
15. CONCRETE PARKING BUMPER. SEE DETAIL S/G4-00.
16. CONCRETE COLLAR AT INLET. SEE DETAIL K/SU2-00.
17. SIDEWALK CONTROL JOINT. SEE DETAIL N/G4-00.
18. SIDEWALK EXPANSION JOINT. SEE DETAIL N/G4-00.
19. ISOLATION JOINT. SEE DETAIL Q/G4-00.
20. SITE FURNISHING - BENCH. SEE DETAIL R/G4-00.
21. SITE FURNISHING - TRASH RECEPTACLE. SEE DETAIL P/G4-00.
22. THERMOPLASTIC INLAY "Z" LOGO (ENNIS FLINT BY PPG DURATHERM OR APPROVED EQUAL).
23. DECORATIVE CONCRETE BOLLARD - SPACED 6' ON CENTER.

PROPOSED SITE LEGEND

- NEW BUILDING
- EXISTING BUILDING
- LIGHT DUTY ASPHALT PAVEMENT
- NEW LANDSCAPING/GRASS AREA
- CONCRETE SIDEWALK/PAVEMENT
- NEW TRAFFIC CONTROL STRIPING
- RESURFACED PARKING LOT AREA

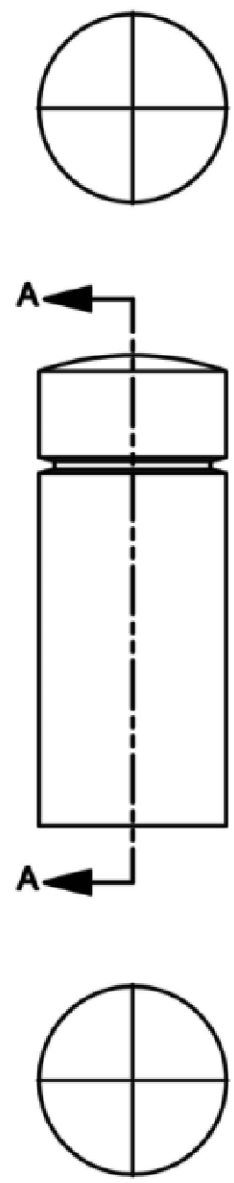

DECORATIVE CONCRETE BOLLARD DETAIL
NO SCALE

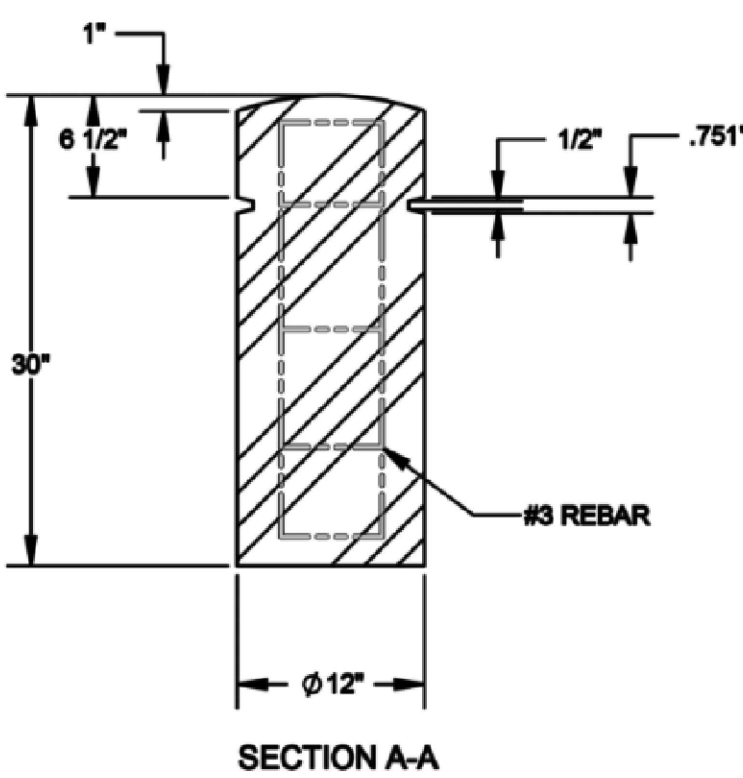

NOTES:
INSTALLATION SHALL BE A HOLLOW CORE OVER CONCRETE FILLED 4" STEEL PIPE EMBEDDED IN CONCRETE WALK WITH BONDING AGENT APPLIED TO CORE AND/OR PIPE AS WELL AS BOTTOM OF BOLLARD.

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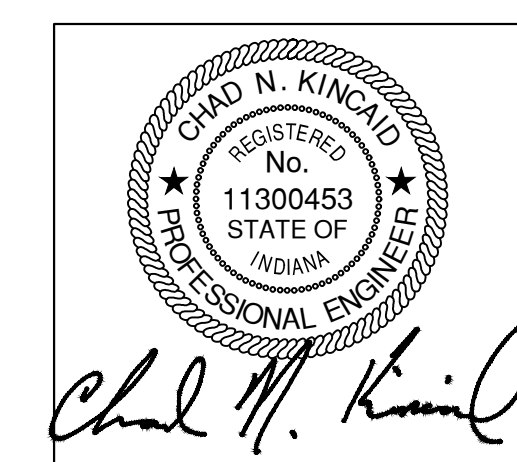
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ISSUED FOR BID



PROJECT MANAGER: DBS
DRAWN BY: CDL
PROJECT NUMBER: 224018.00 (TLF JOB #2024-090)
PROJECT ISSUE DATE: 01.21.2025

REV. NO.	DESCRIPTION	DATE
1	ADDENDUM #1	02-11-2025
2	ADDENDUM #2	02-18-2025

SITE PLAN

G1-01



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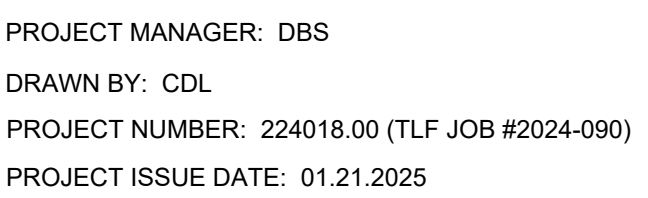
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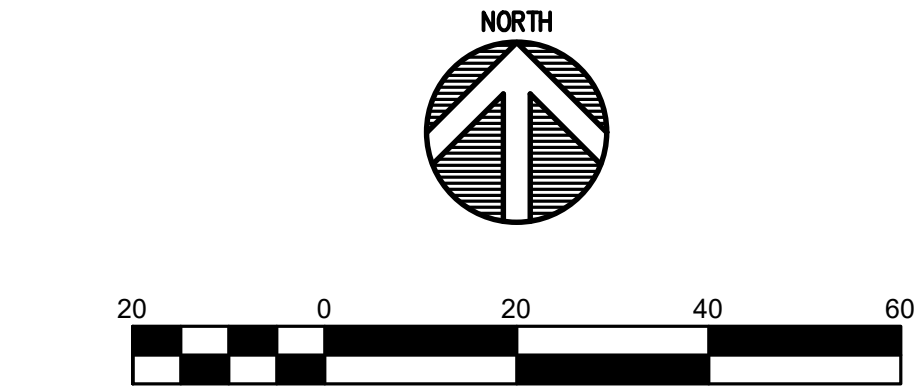
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SITE PLAN


G1-02



1. SEE DRAWING G0-01 FOR GENERAL NOTES AND ADDITIONAL LEGEND.
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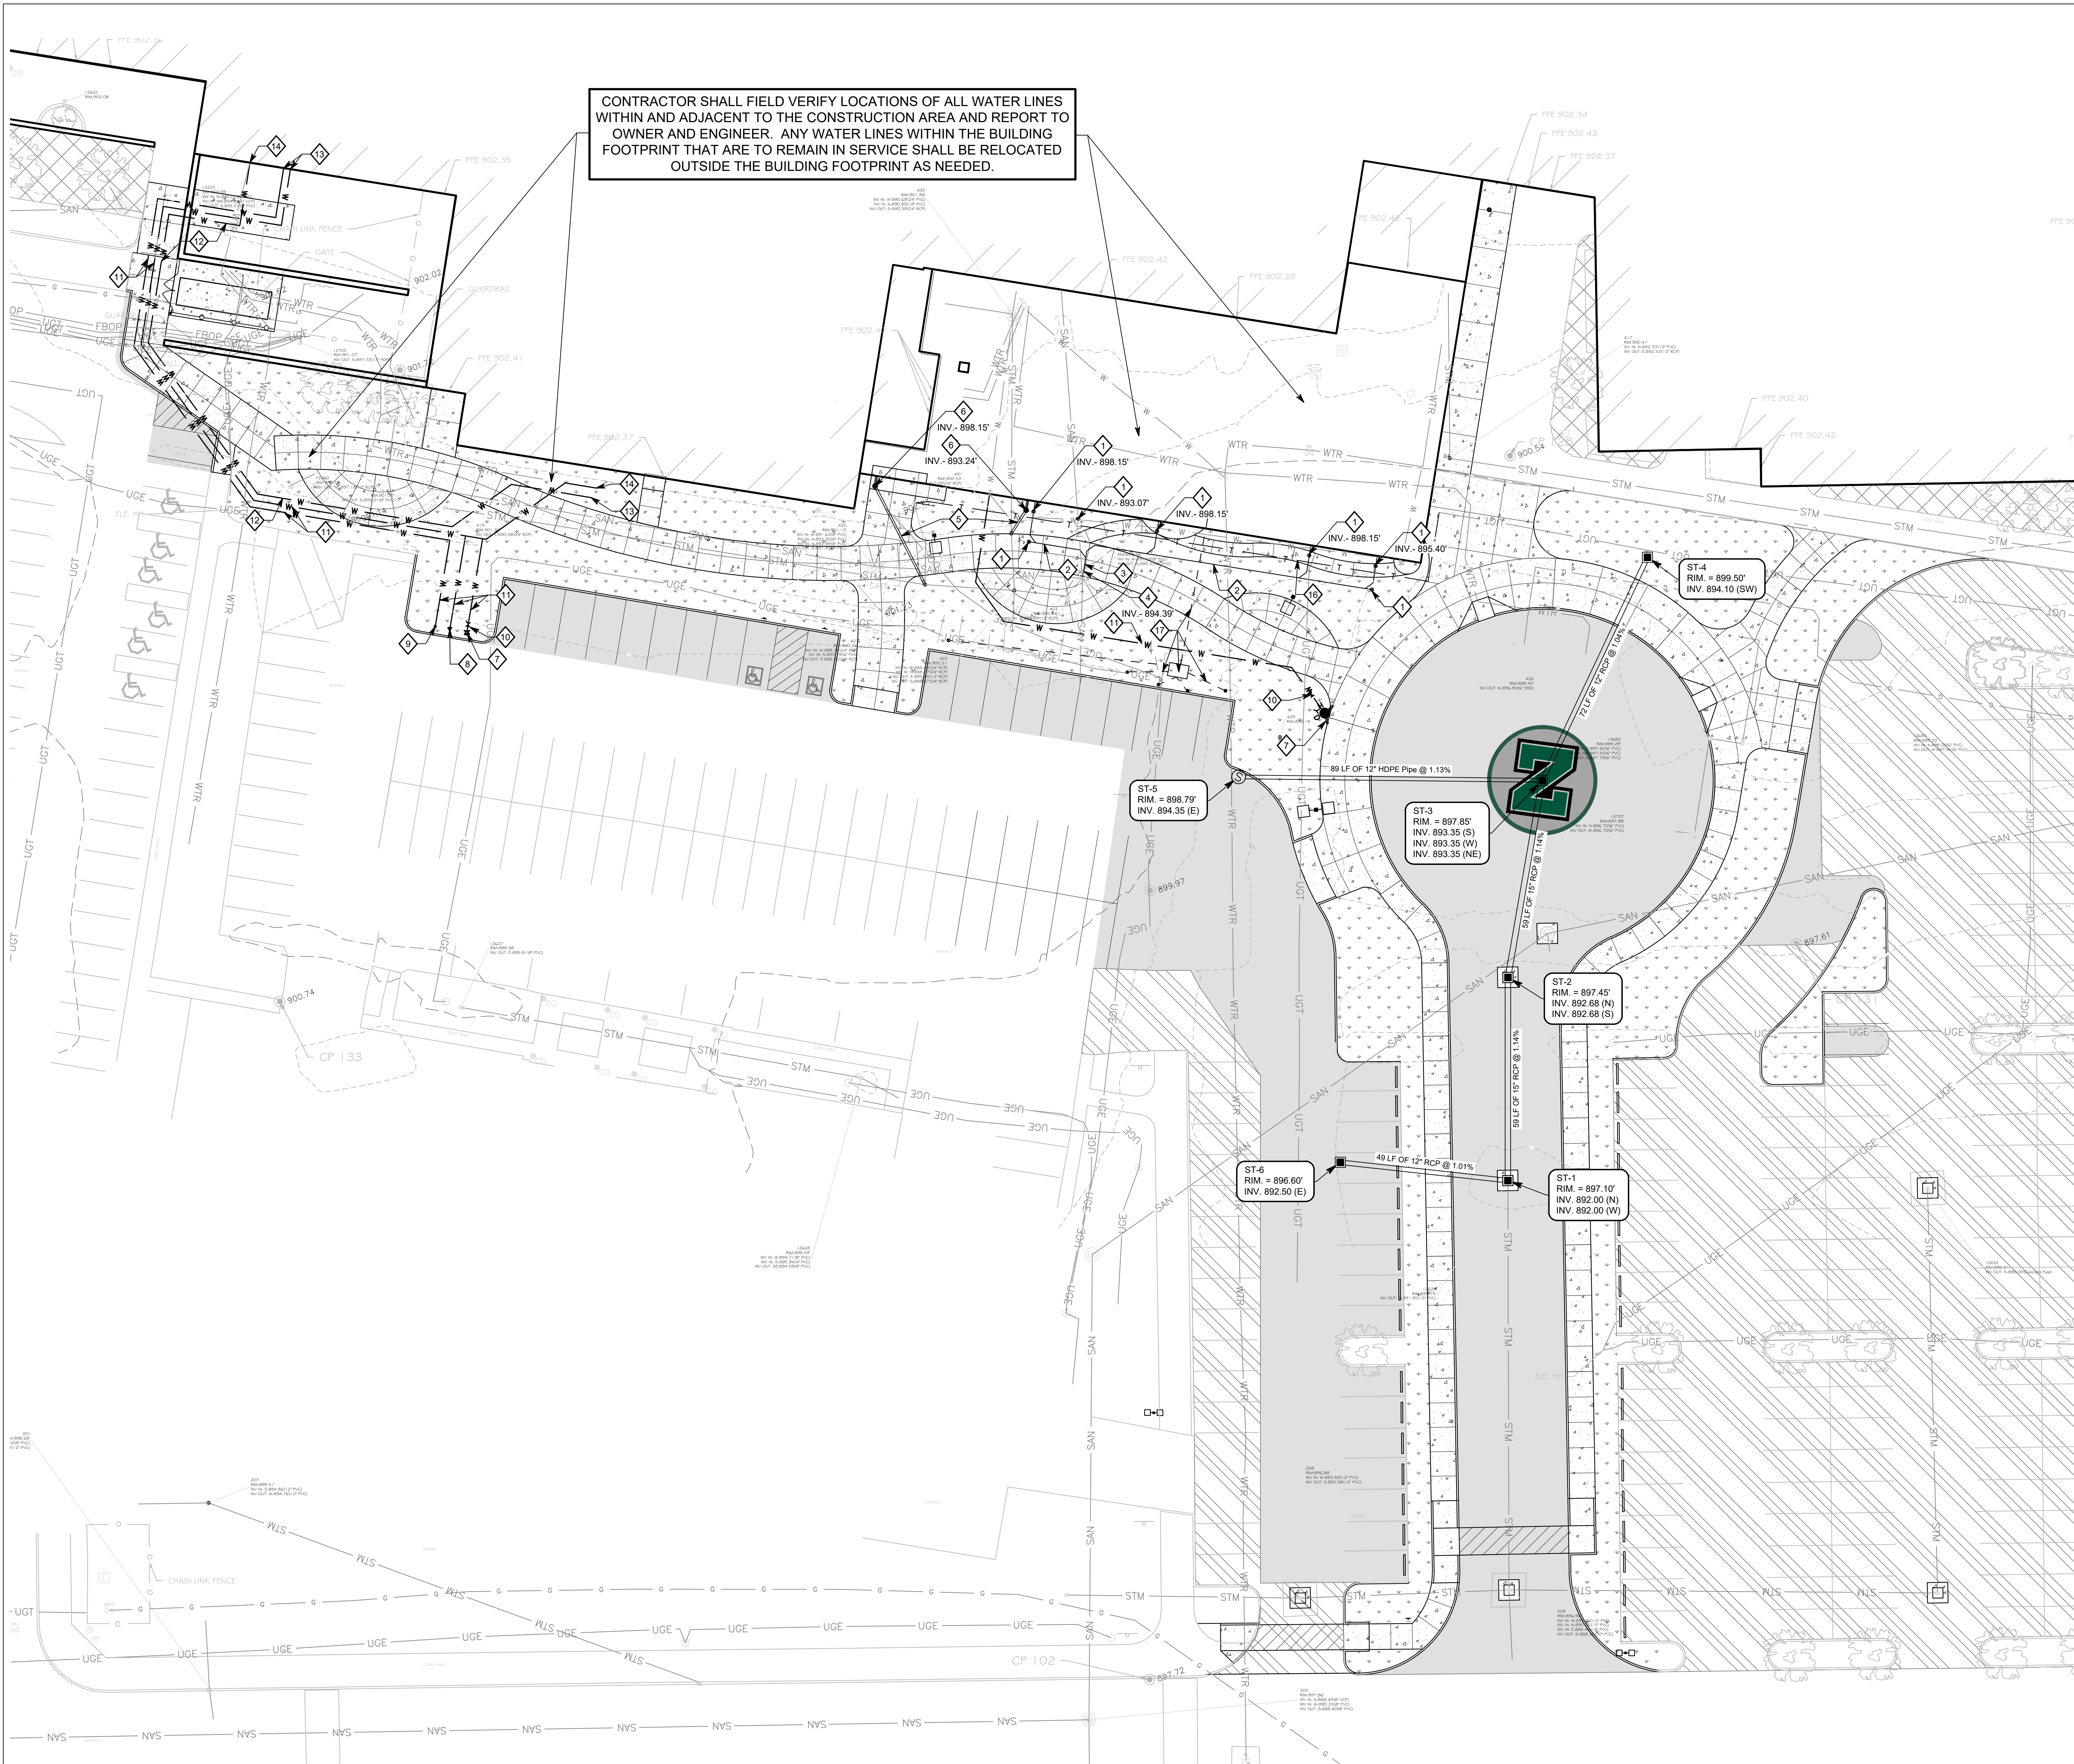


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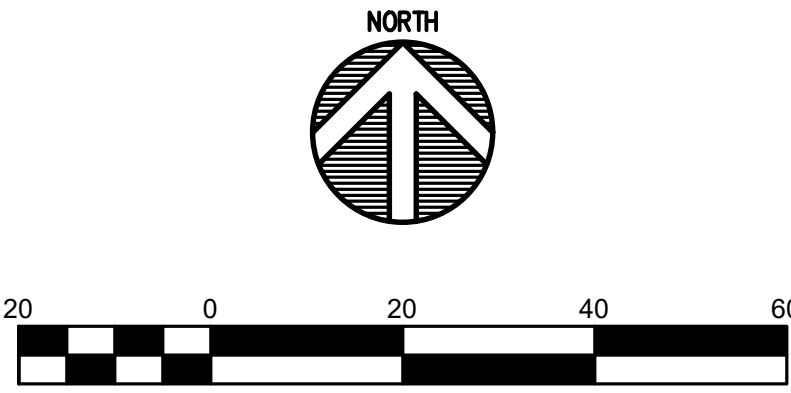
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CONTRACTOR SHALL FIELD VERIFY LOCATIONS OF ALL WATER LINES WITHIN AND ADJACENT TO THE CONSTRUCTION AREA AND REPORT TO OWNER AND ENGINEER. ANY WATER LINES WITHIN THE BUILDING FOOTPRINT THAT ARE TO REMAIN IN SERVICE SHALL BE RELOCATED OUTSIDE THE BUILDING FOOTPRINT AS NEEDED.



GENERAL NOTES


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UTILITY KEYNOTES

- NEW SANITARY CLEANOUT. SEE DETAIL G/SU2-0
- 6" PVC SANITARY LATERAL @ 1.04% SLOPE MIN. SEE DETAIL E/SU2-0
- 8" PVC SANITARY LATERAL @ 1.04% SLOPE MIN. SEE DETAIL E/SU2-0
- SANITARY CONNECTION TO EXISTING MANHOLE
- 6" PVC STORM ROOF DRAIN @ 1.04% SLOPE MIN. SEE DETAIL C/SU2-0
- NEW STORM CLEANOUT. SEE DETAIL D/SU2-0
- NEW FIRE HYDRANT. SEE DETAIL H/SU2-0
- POST INDICATOR VALVE - COORDINATE W/ ZIONSVILLE FIRE DEPT.
- FIRE DEPARTMENT CONNECTION - COORDINATE W/ ZIONSVILLE FIRE DEPT.
- WATER VALVE
- NEW 6" C900 PVC WATER LINE. SEE DETAIL J/SU2-0
- NEW 8" C900 PVC WATER LINE. SEE DETAIL J/SU2-0
- CONNECT TO EXISTING DOMESTIC WATER SERVICE (FIELD VERIFY LOCATION & SIZE).
- CONNECT TO EXISTING FIRE PROTECTION LINE (FIELD VERIFY LOCATION & SIZE).
- NEW ELECTRICAL LINE. SEE ELECTRICAL SITE PLANS
- NEW TELEPHONE/COMMUNICATIONS LINE. SEE ELECTRICAL SITE PLANS
- CONDUITS AND PULL BOX FOR FUTURE EV CHARGING STATIONS. SEE ELECTRICAL SITE PLANS

UTILITY LEGEND

- CHW PROPOSED CHILLED WATER LINE
- E PROPOSED ELECTRICAL LINE
- G PROPOSED GAS LINE
- SAN PROPOSED SANITARY SEWER LINE
- STM PROPOSED STEAM LINE
- ST PROPOSED STORM SEWER LINE
- RD PROPOSED ROOF DRAIN LINE
- T PROPOSED TELEPHONE LINE
- W PROPOSED WATER LINE
- PROPOSED FIRE HYDRANT
- PROPOSED POST INDICATOR VALVE
- PROPOSED FIRE DEPARTMENT CONNECTION
- PROPOSED STORM INLET
- PROPOSED STORM MANHOLE
- PROPOSED LIGHT POLE

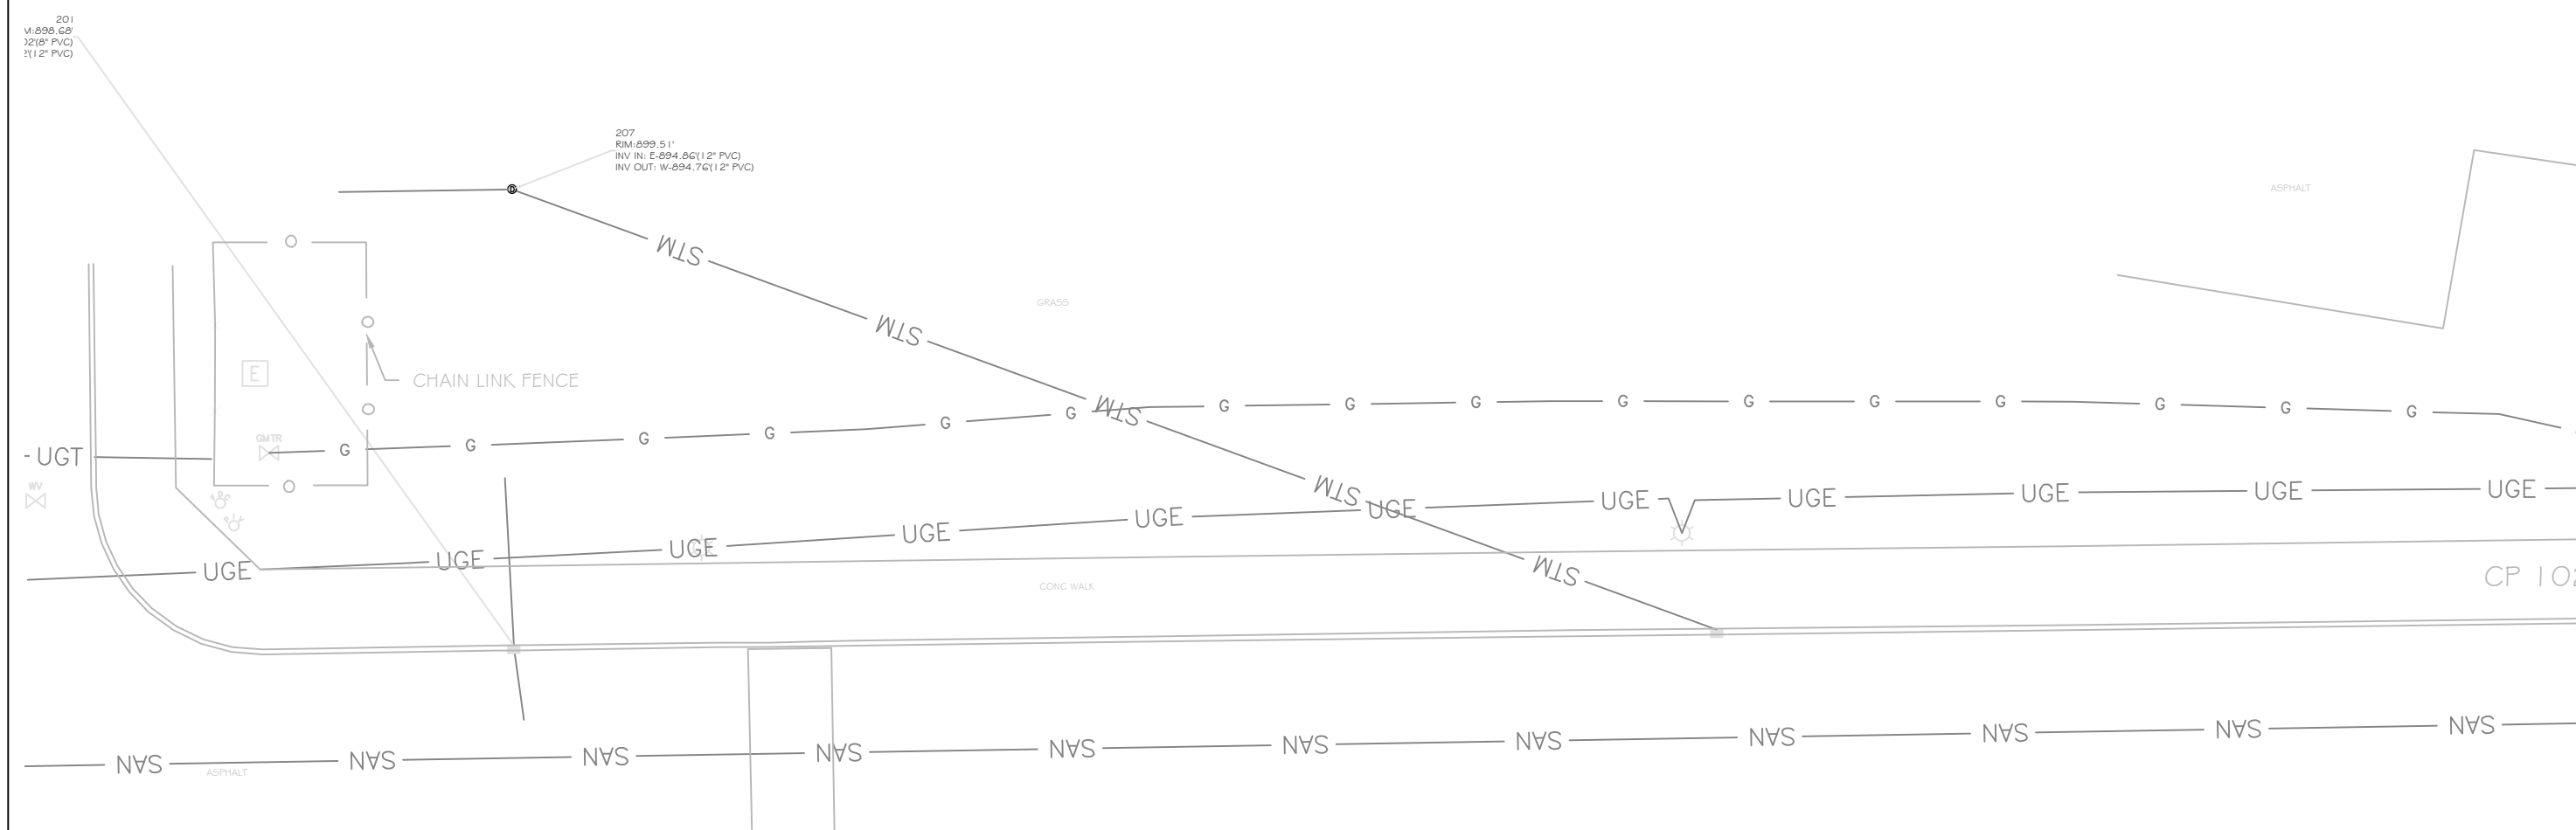

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PROJECT MANAGER: DBS
DRAWN BY: CDL
PROJECT NUMBER: 224018.00 (TLF JOB #2024-090)
PROJECT ISSUE DATE: 01.21.2025

REV. NO.	DESCRIPTION	DATE
2	ADDENDUM #2	02-18-2025

UTILITY PLAN

SU1-0

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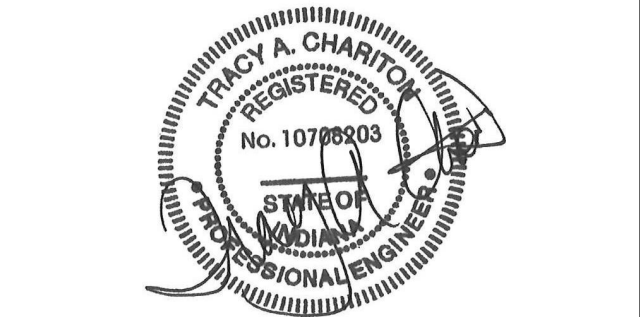


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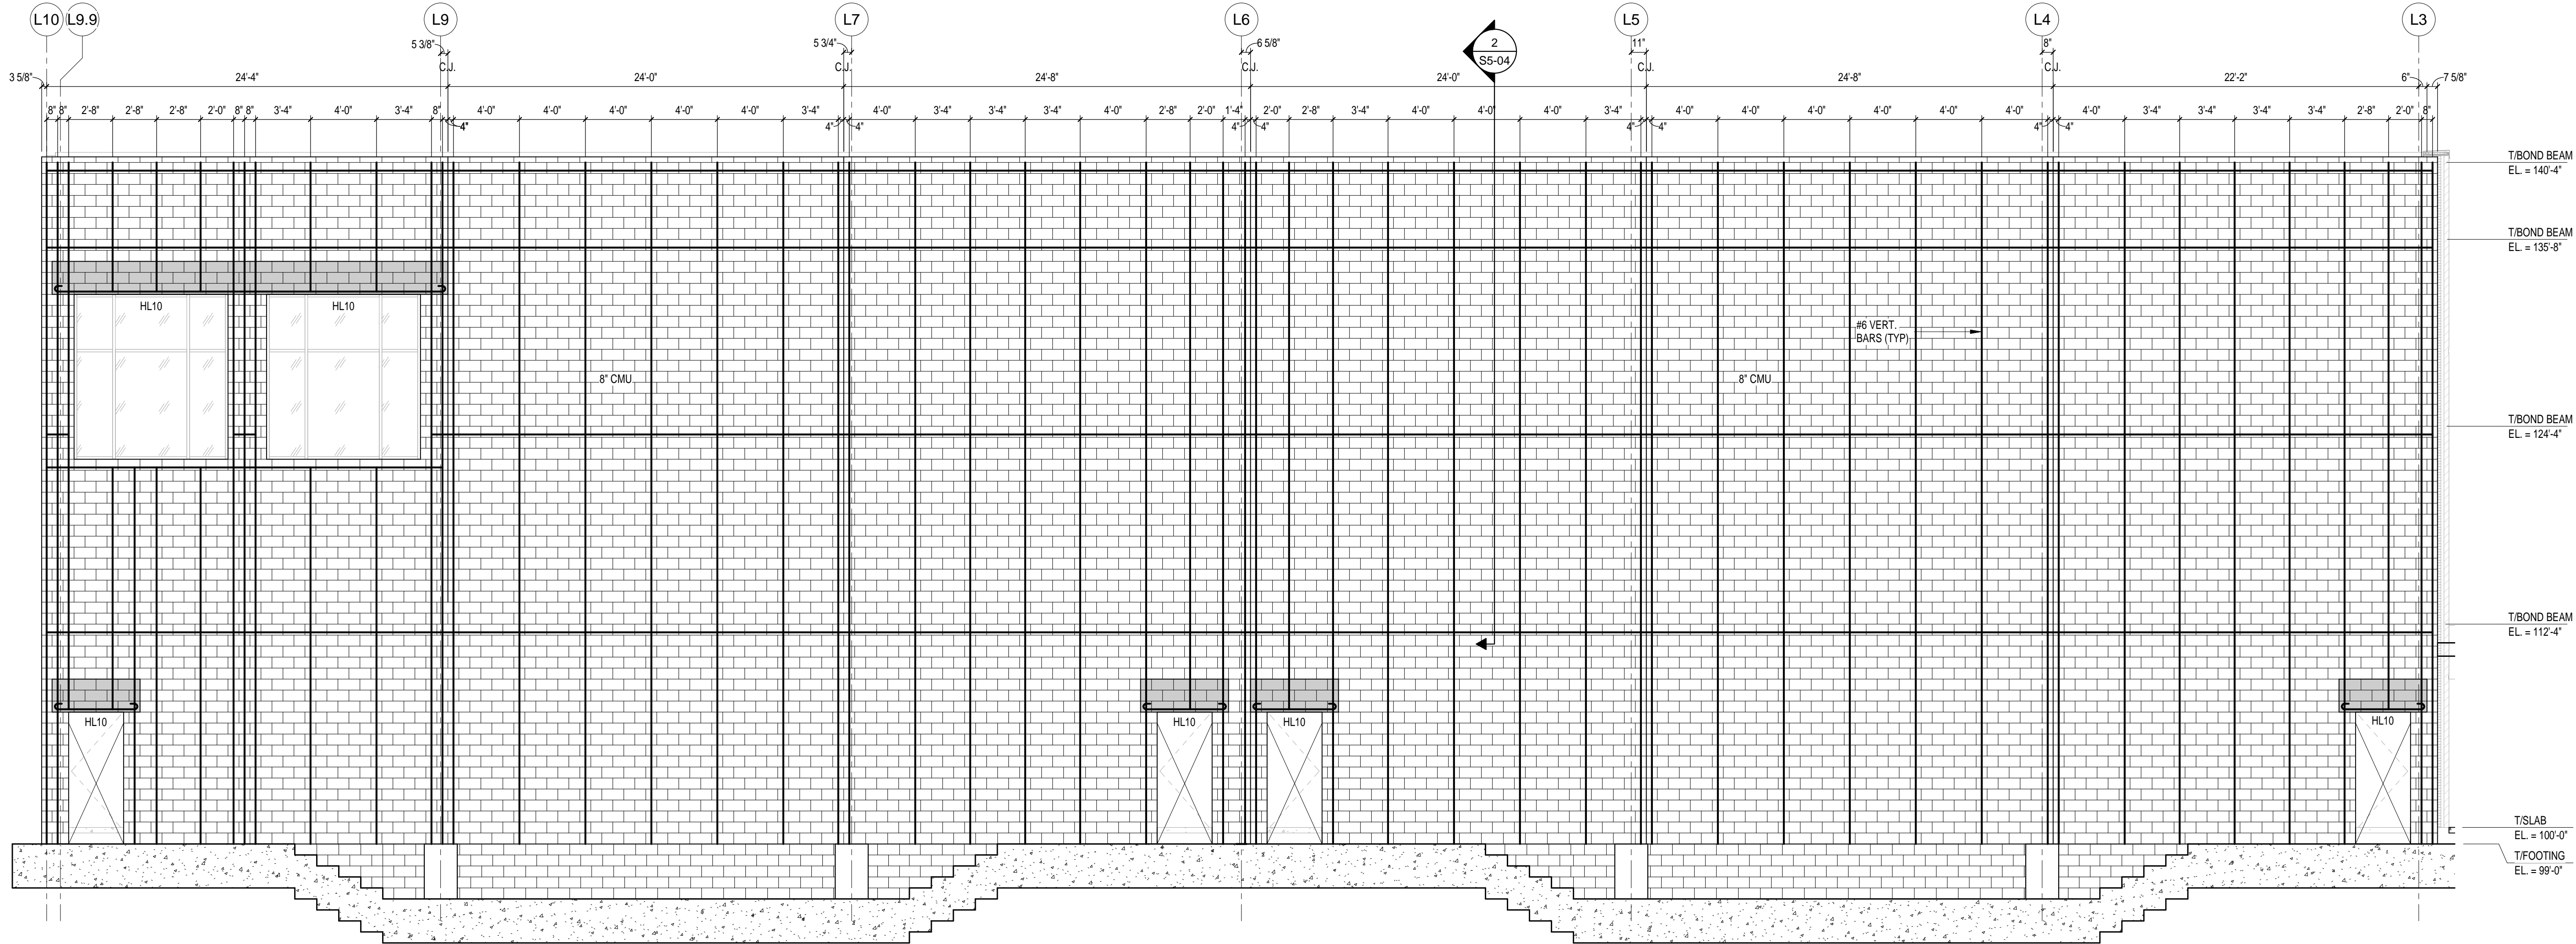


PROJECT MANAGER: JM
DRAWN BY: TLF
PROJECT NUMBER: 224018.00
PROJECT ISSUE DATE: 01/21/2025


REV. NO.	DESCRIPTION	DATE
2	ADDENDUM #2	02-16-2025

MASONRY WALL ELEVATIONS

S4-04


















A MASONRY WALL ELEVATION
SCALE: 3/16" = 1'-0"

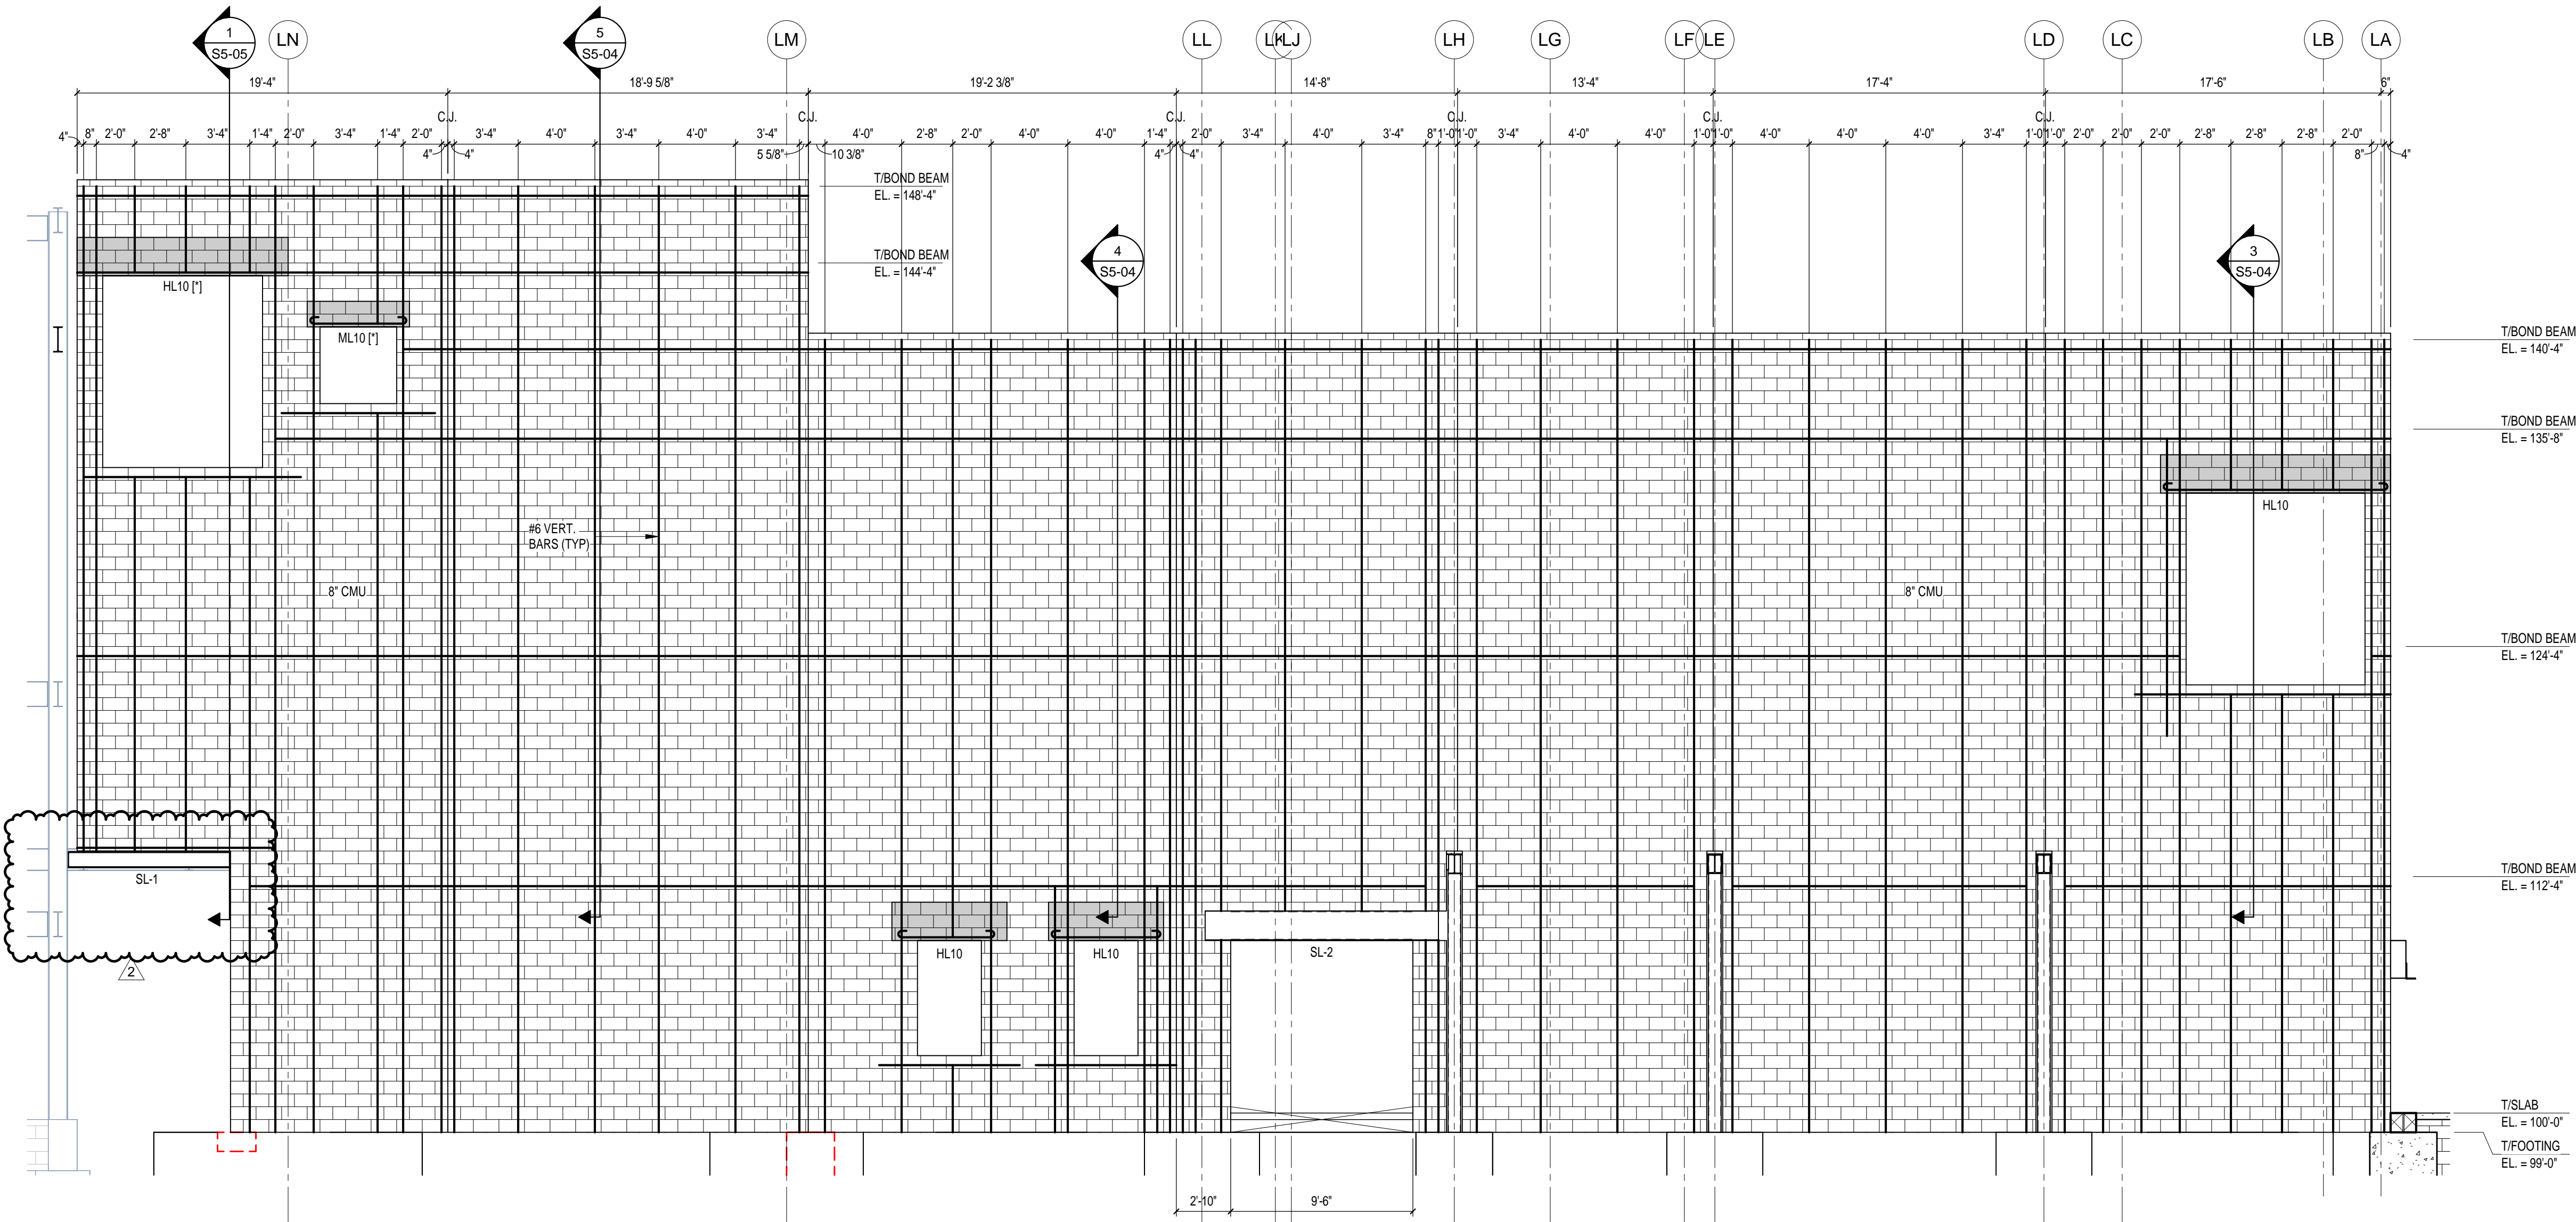

B MASONRY WALL ELEVATION
SCALE: 3/16" = 1'-0"

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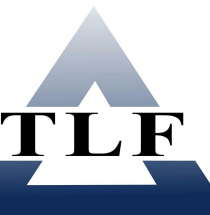
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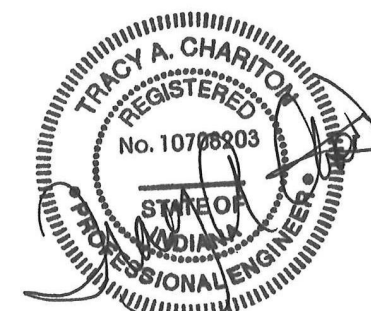
CONSULTANT

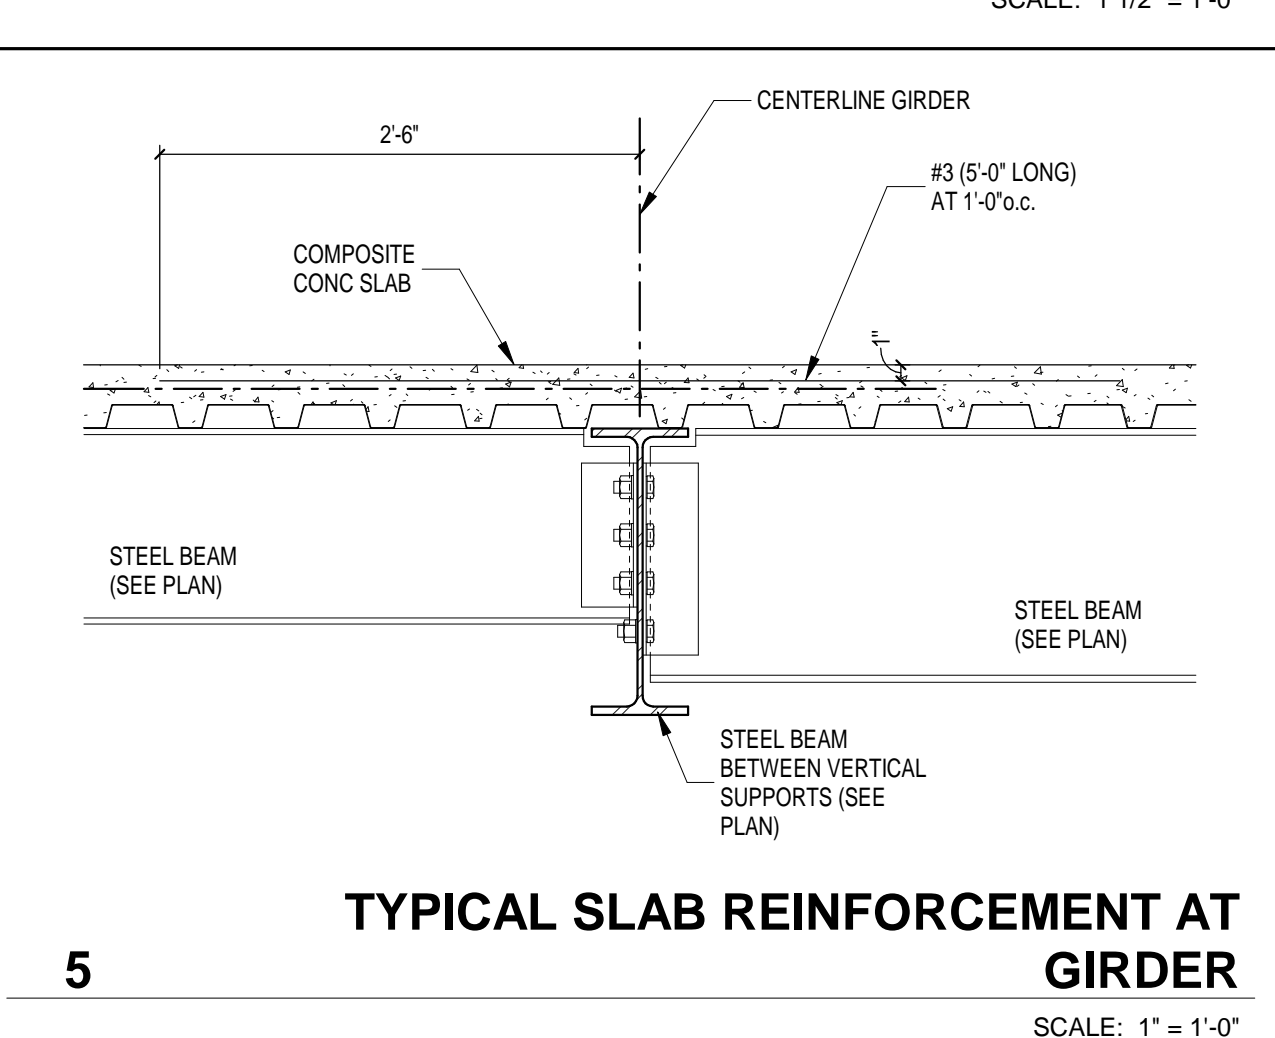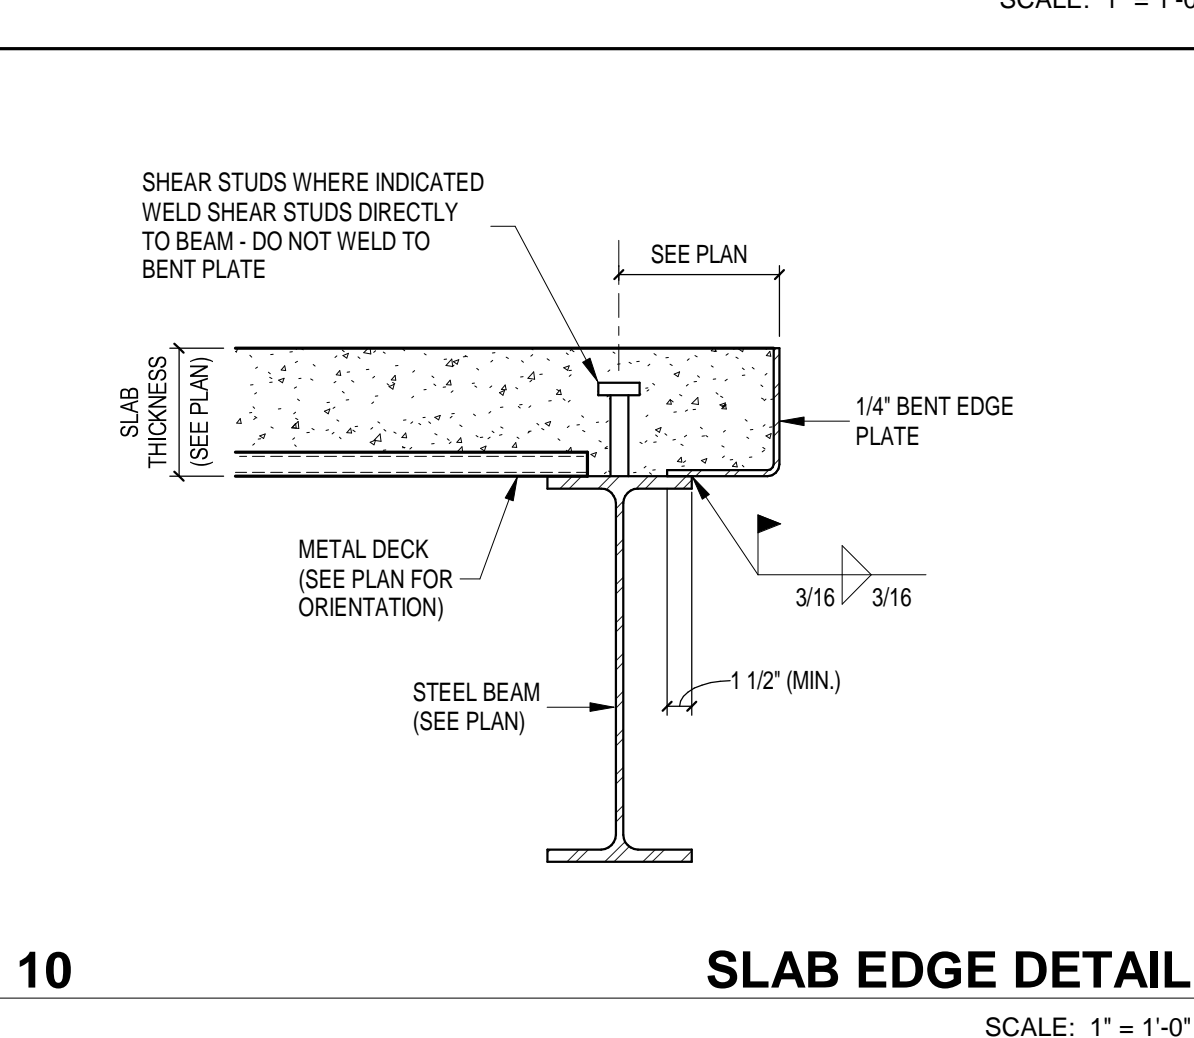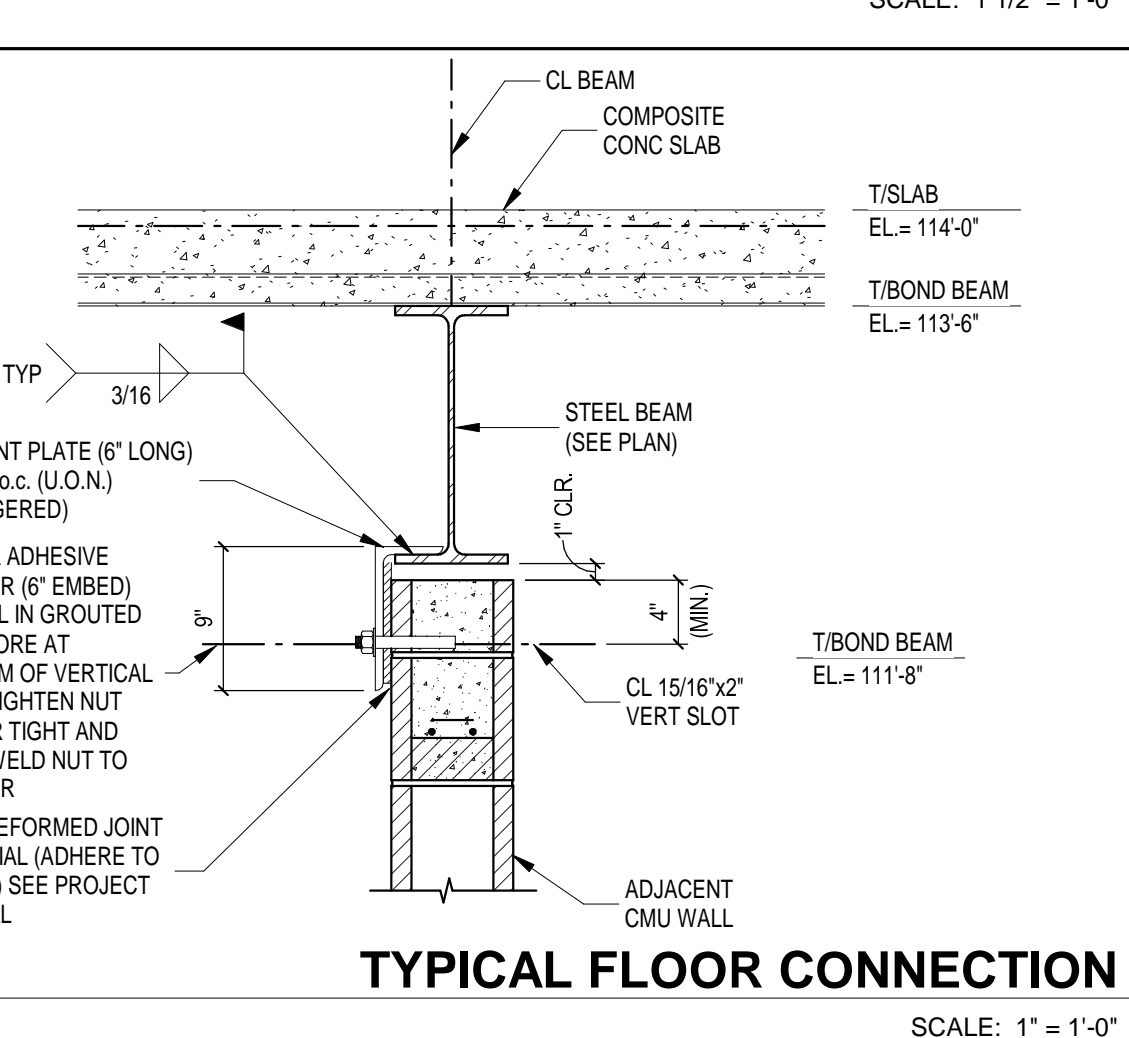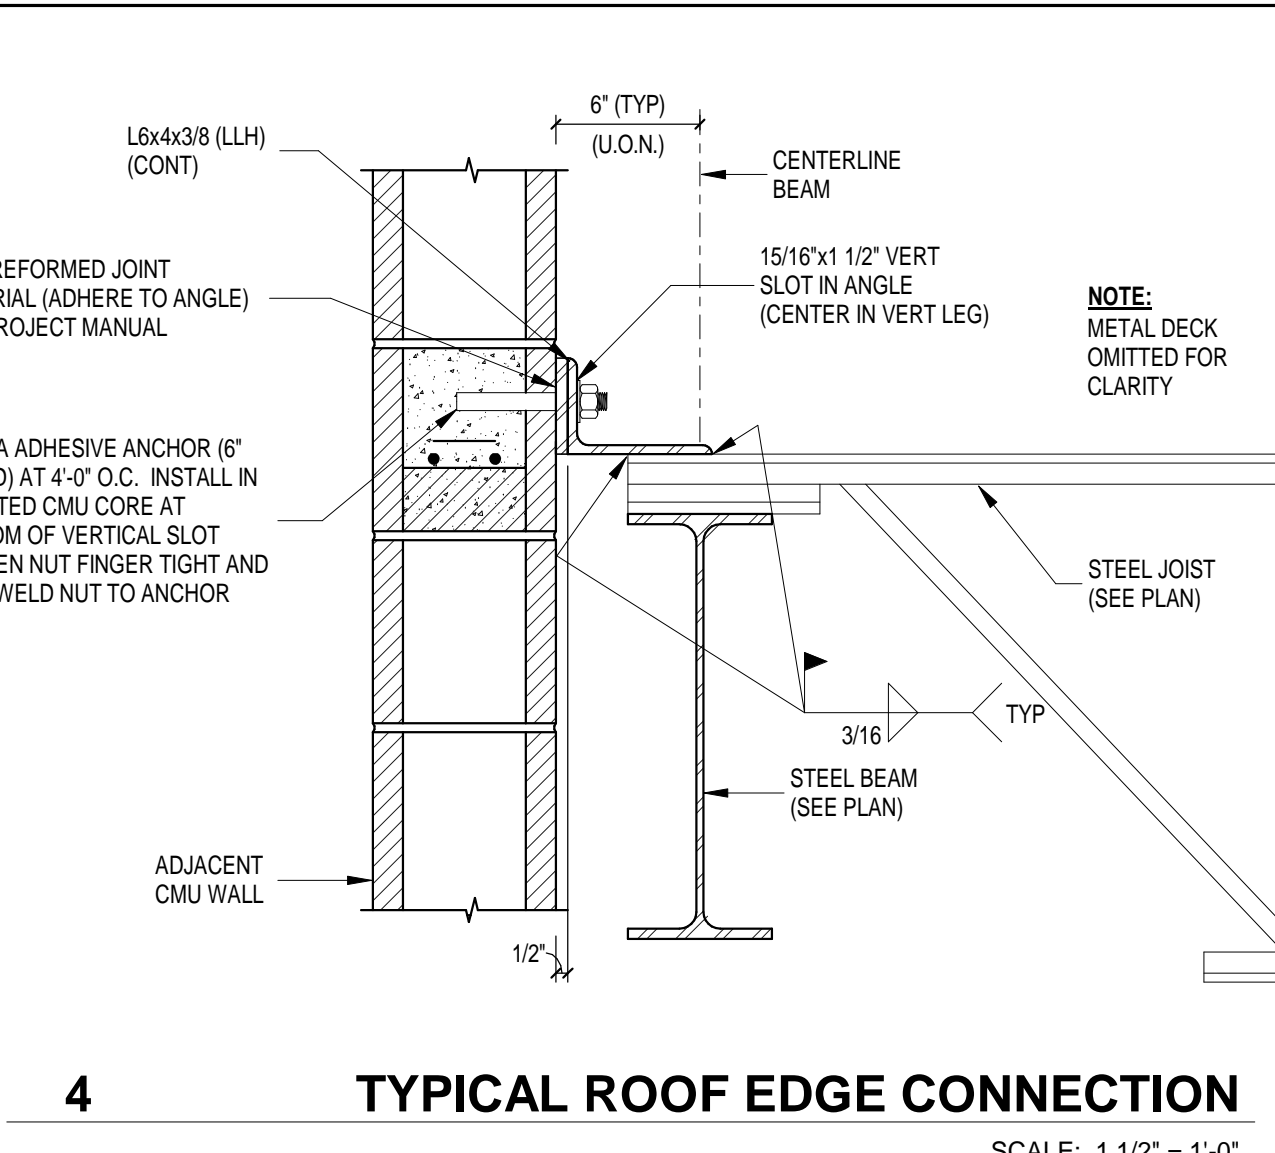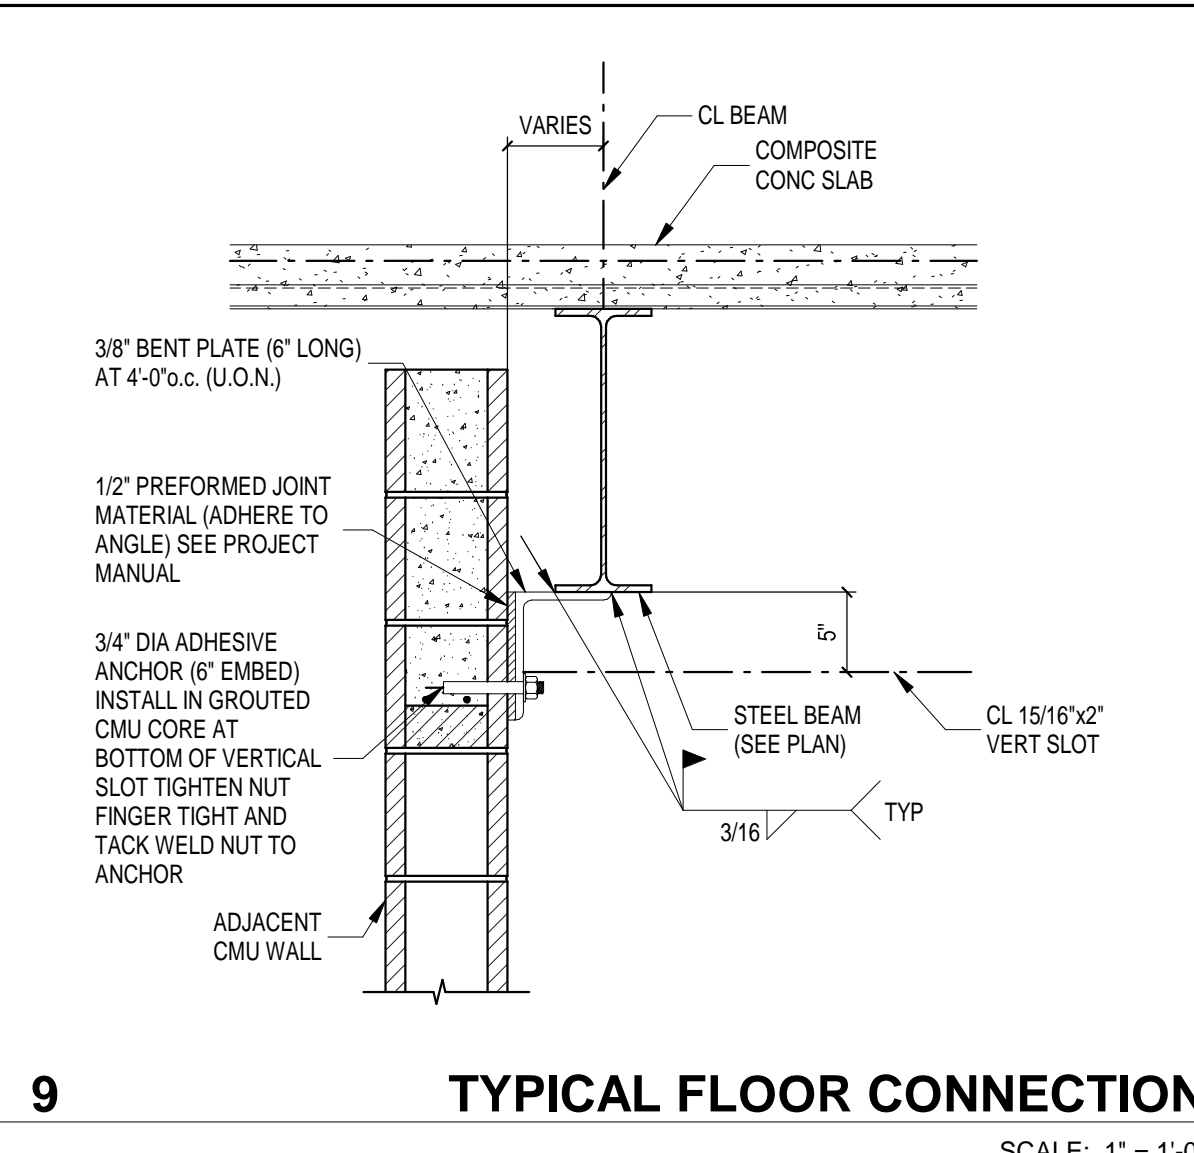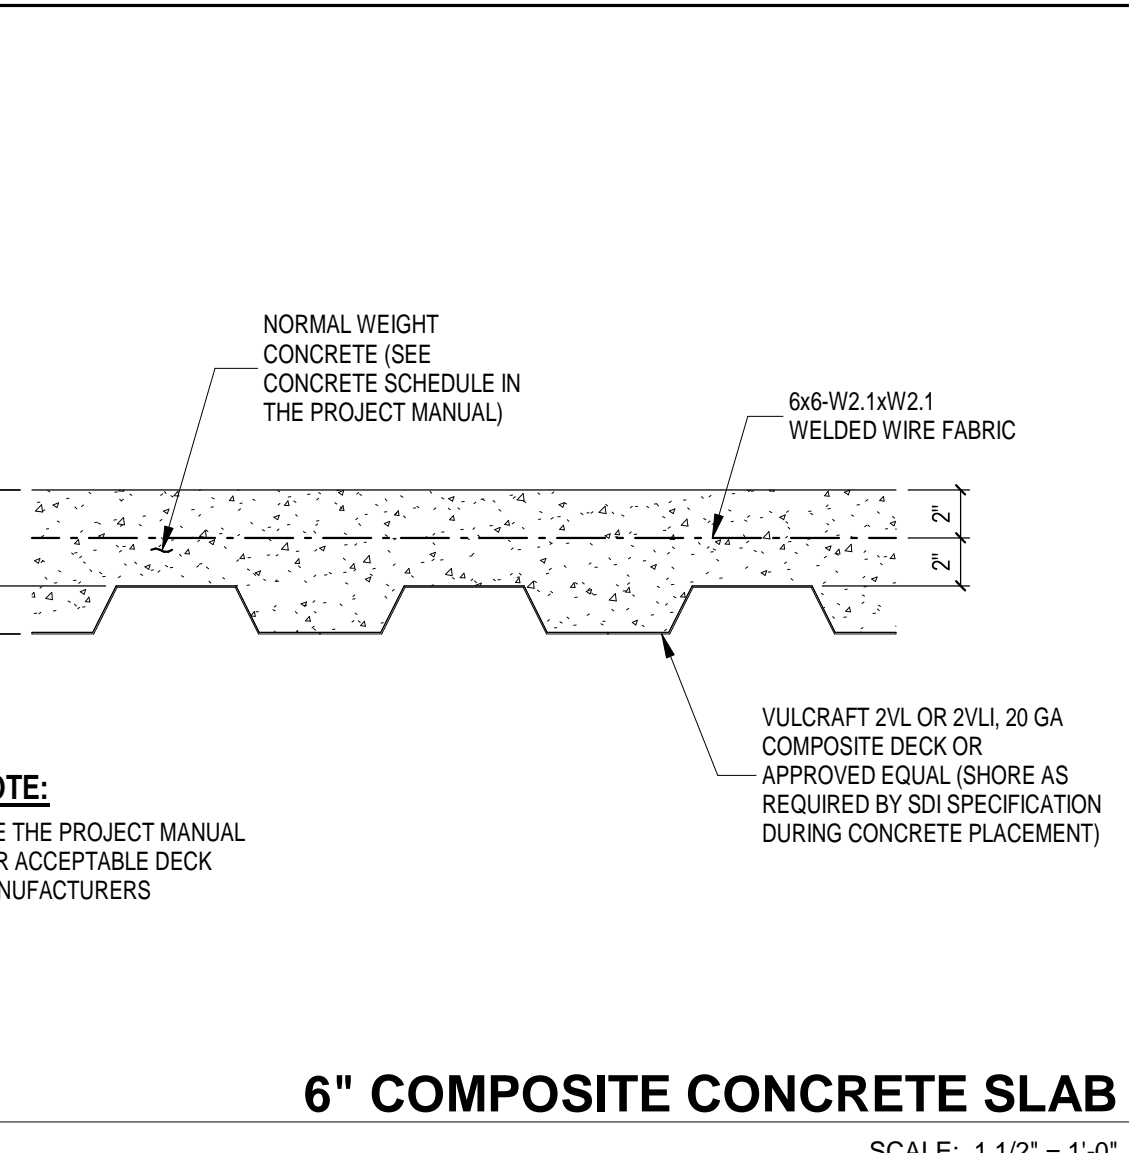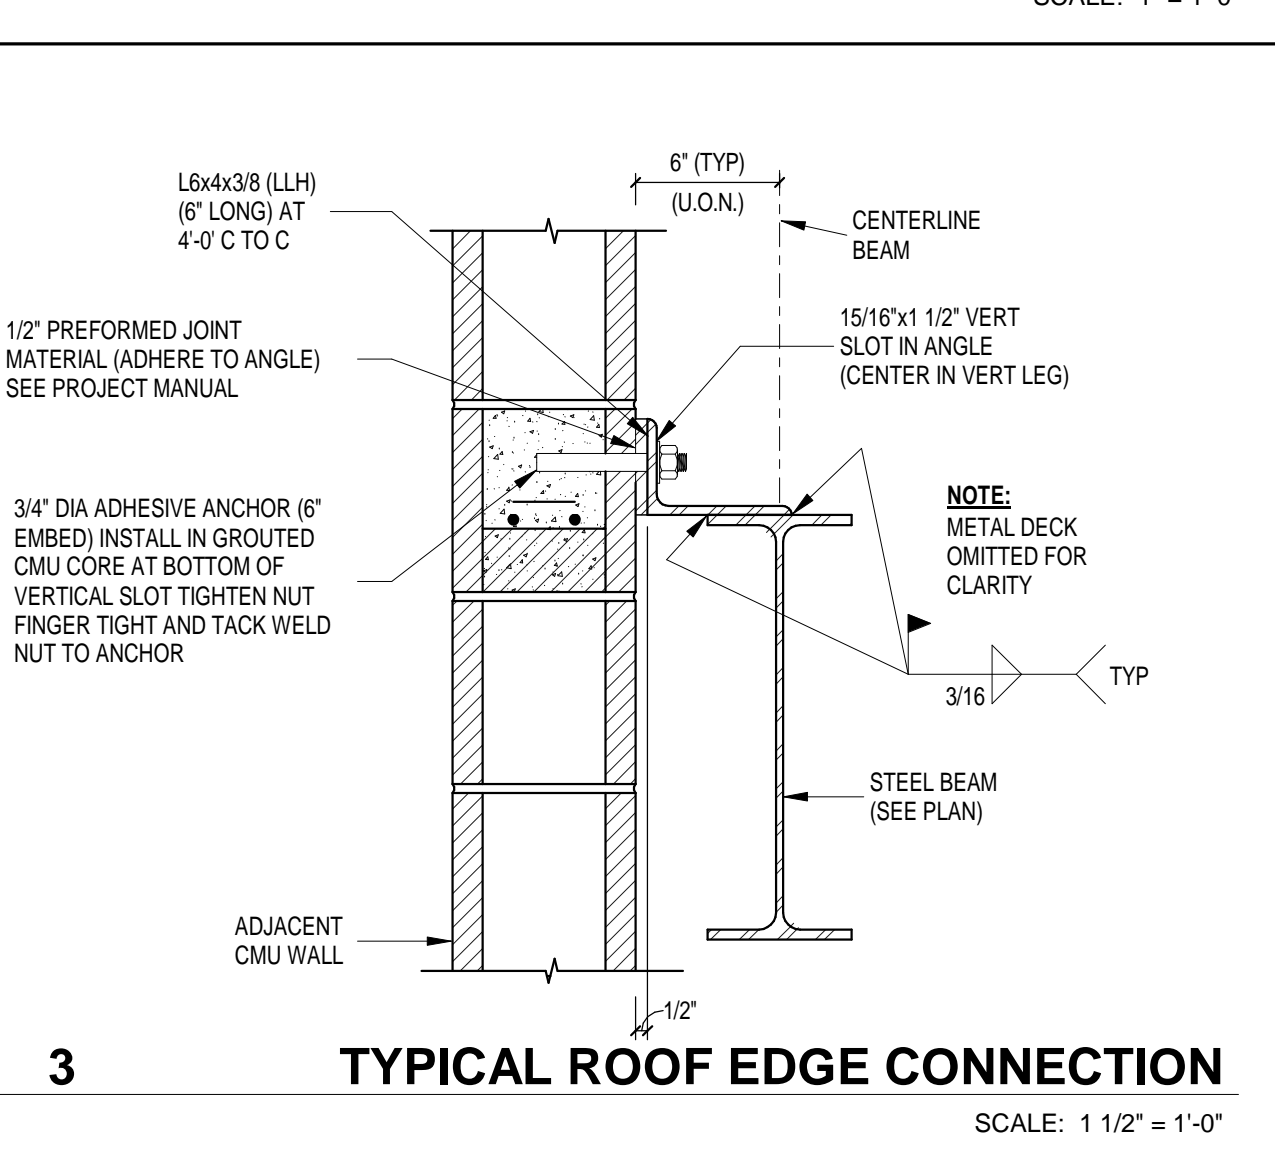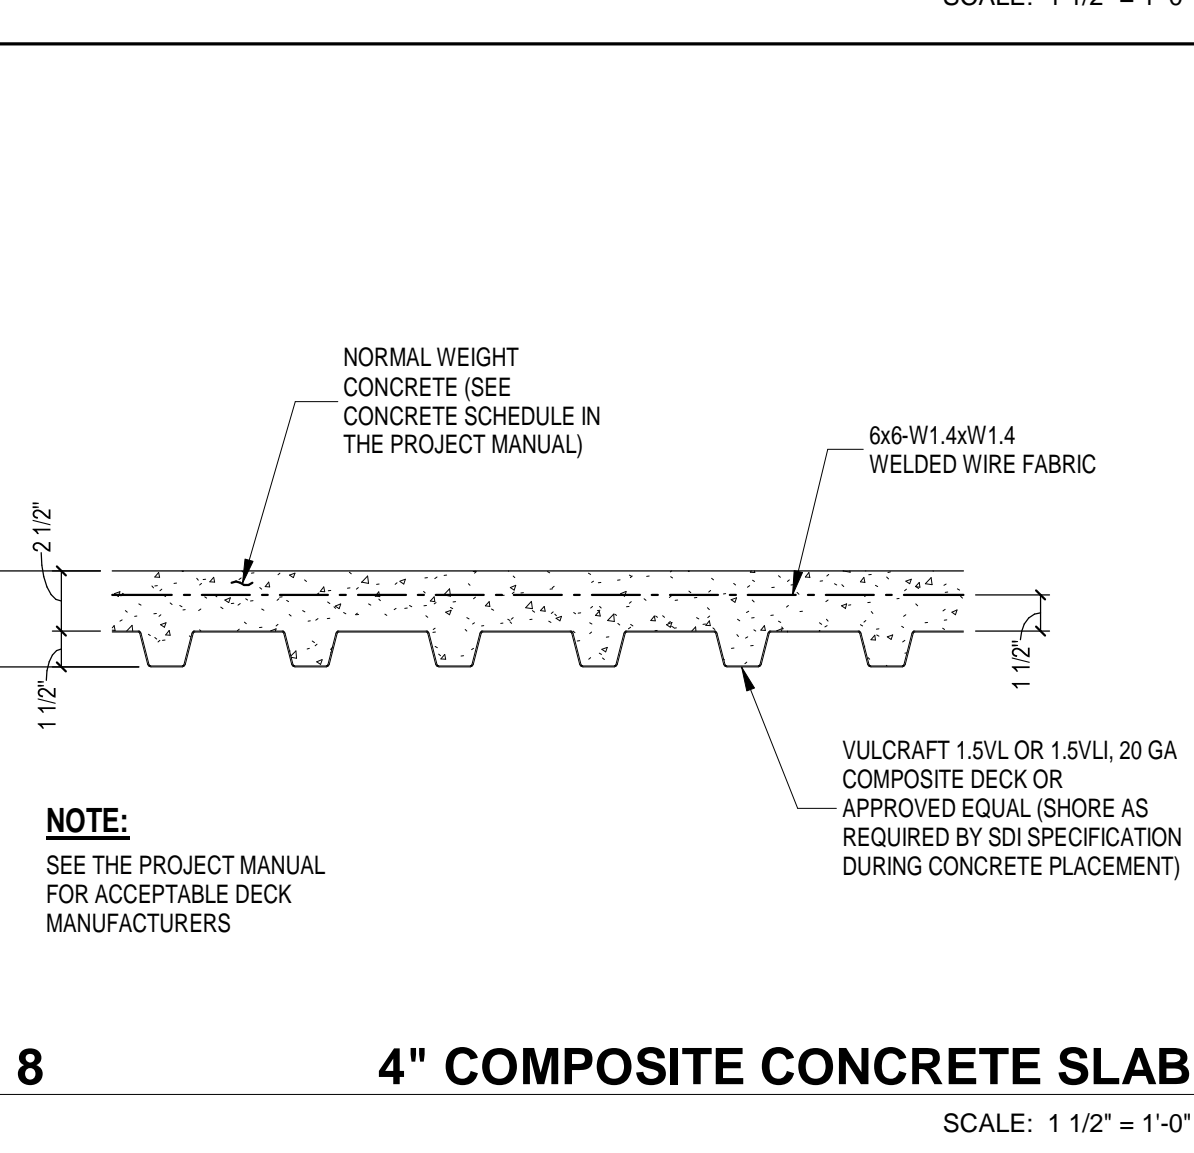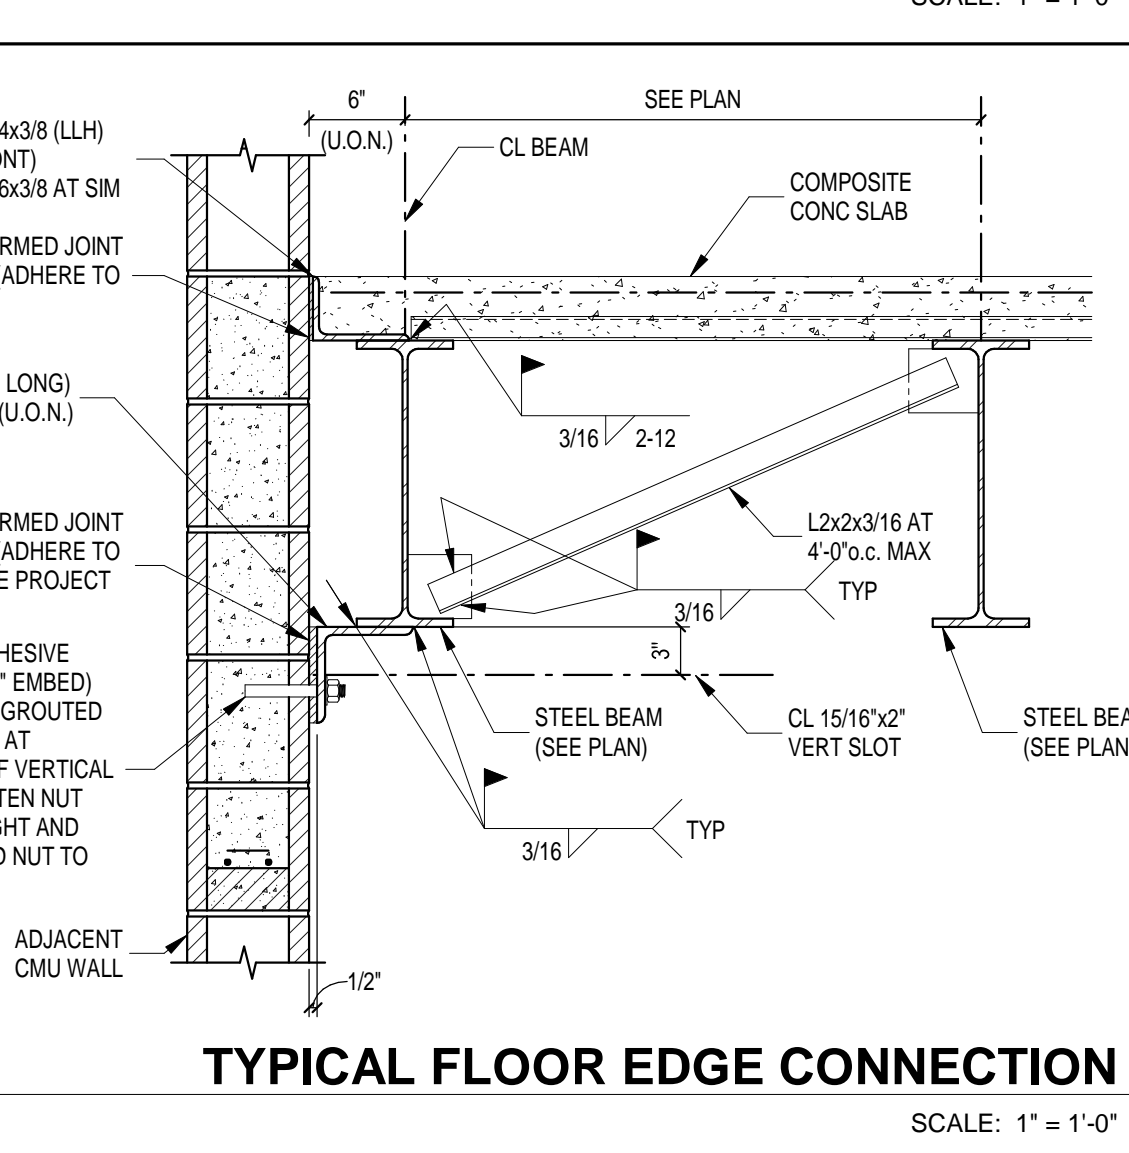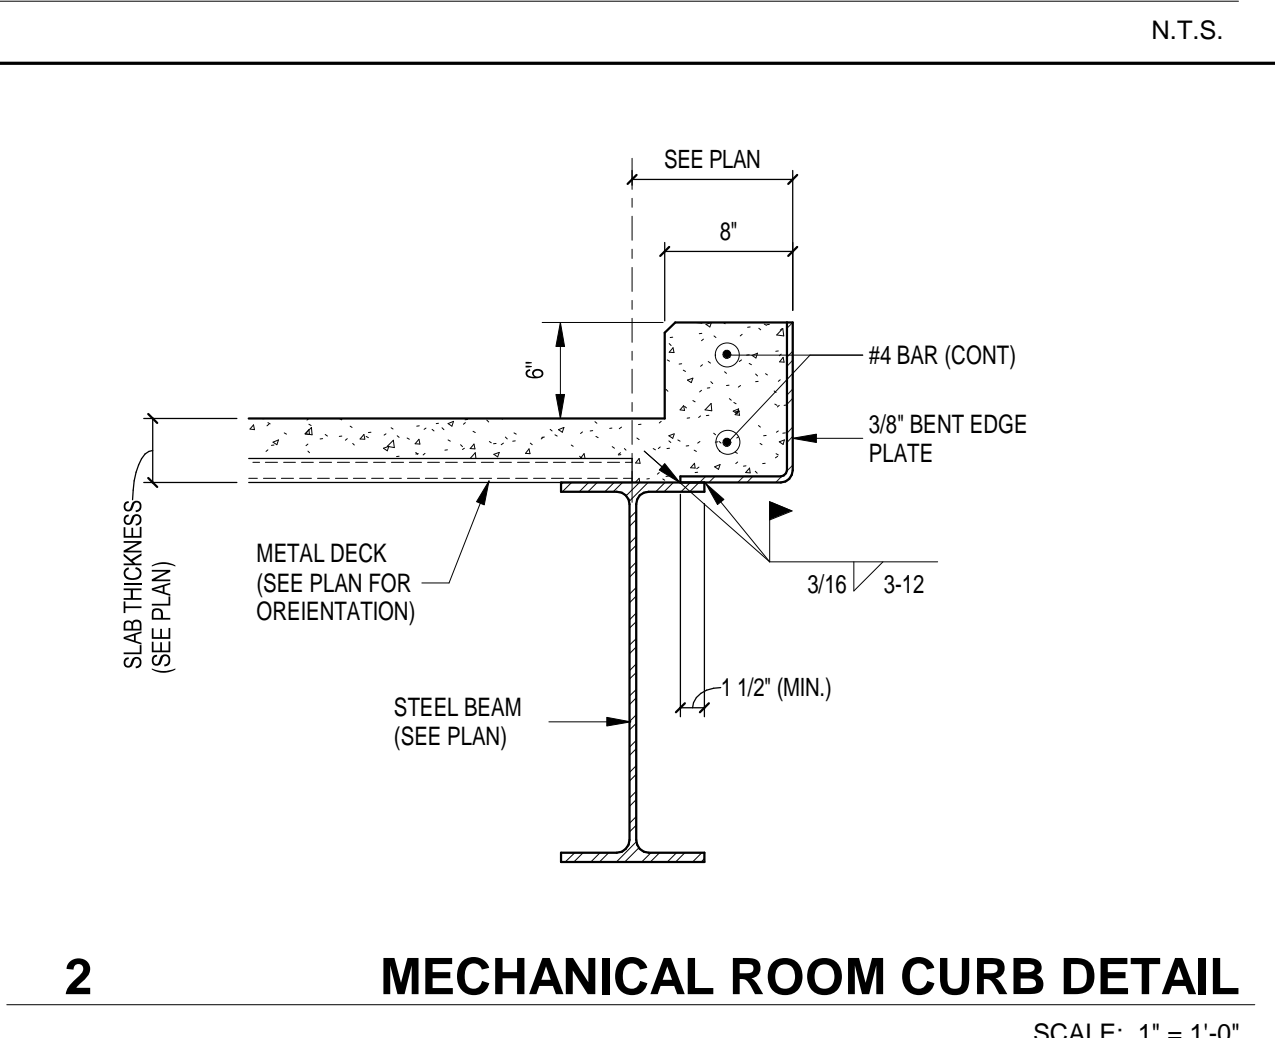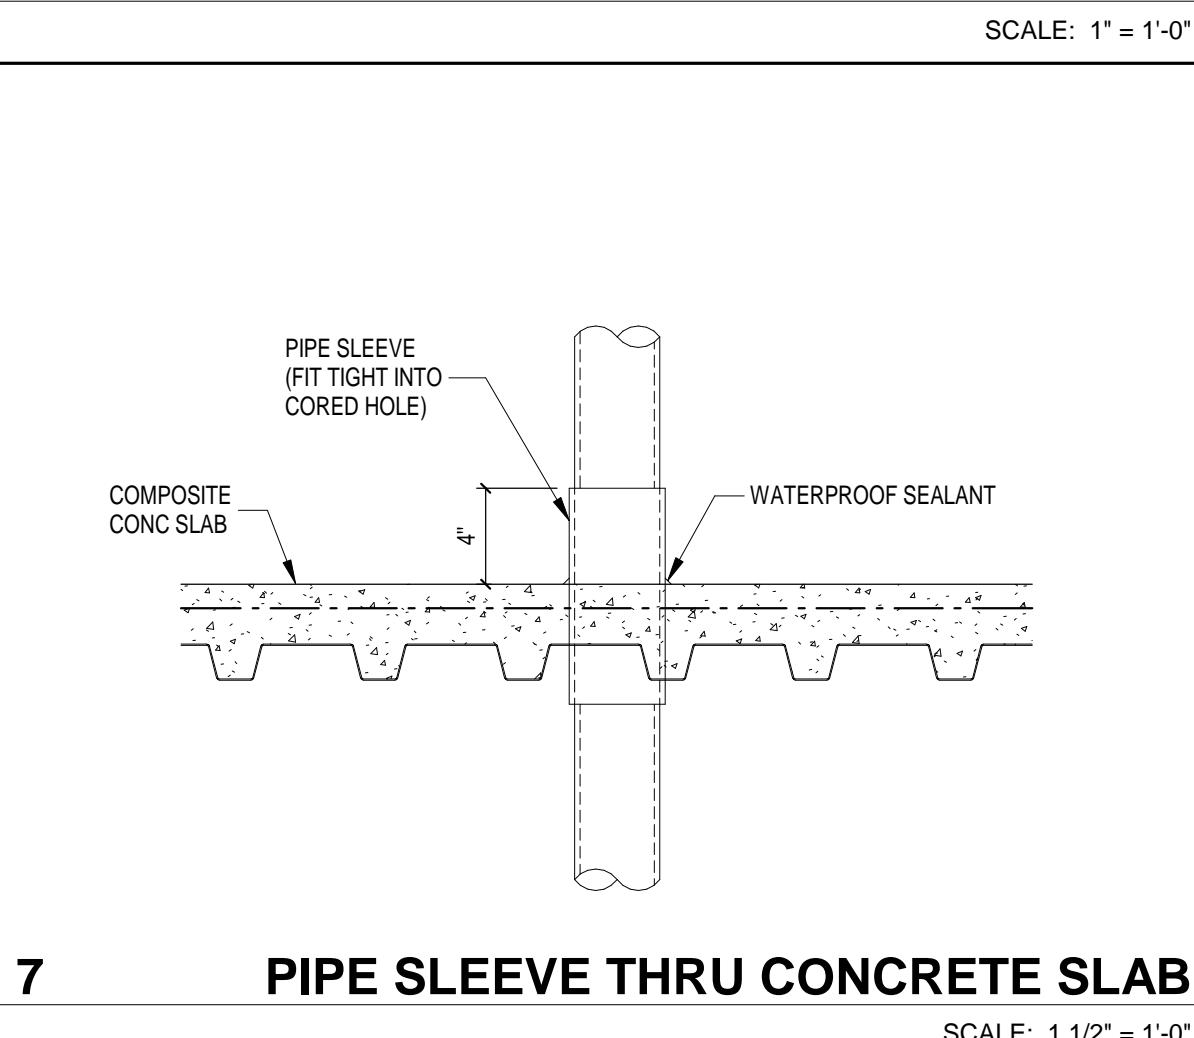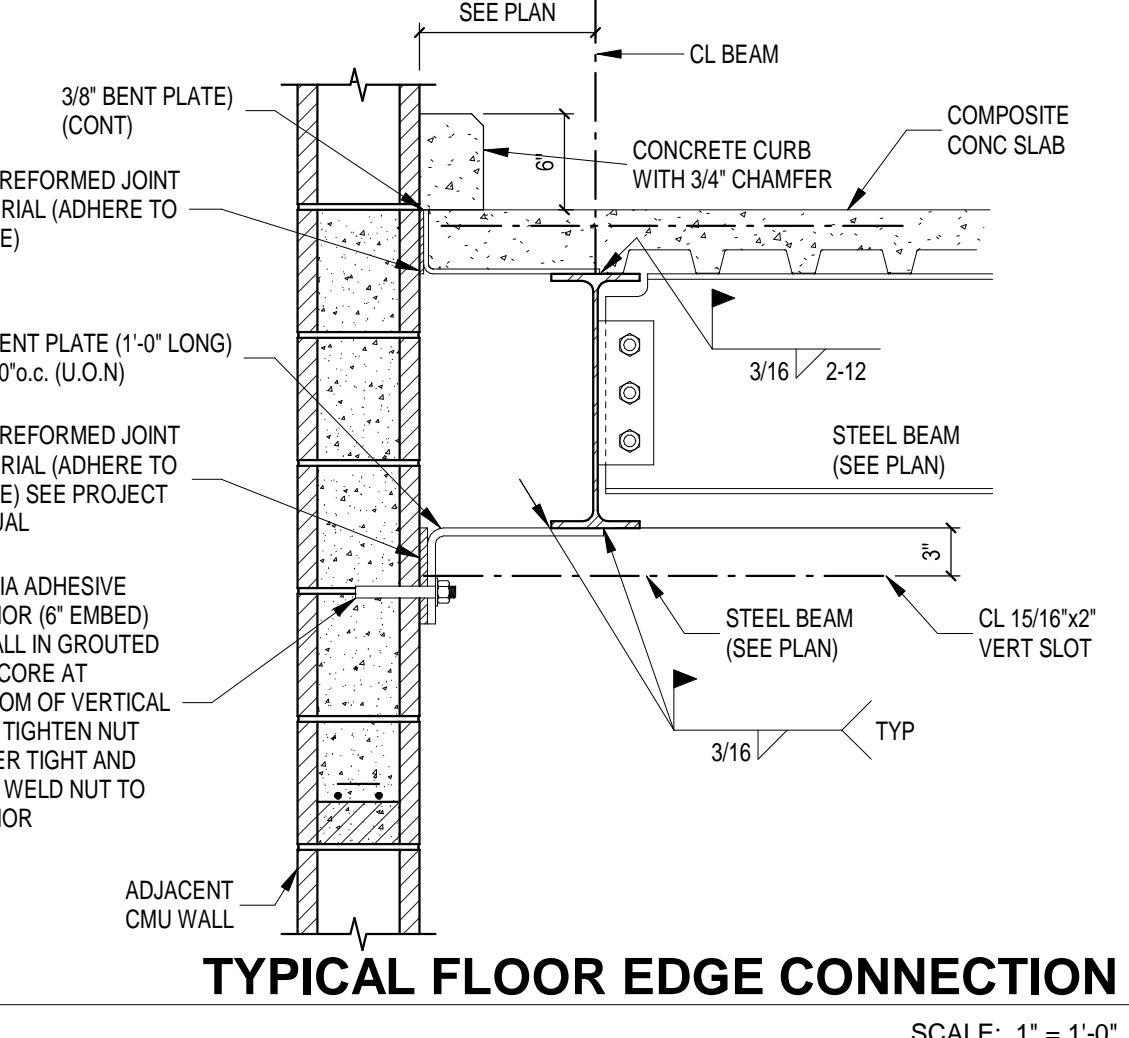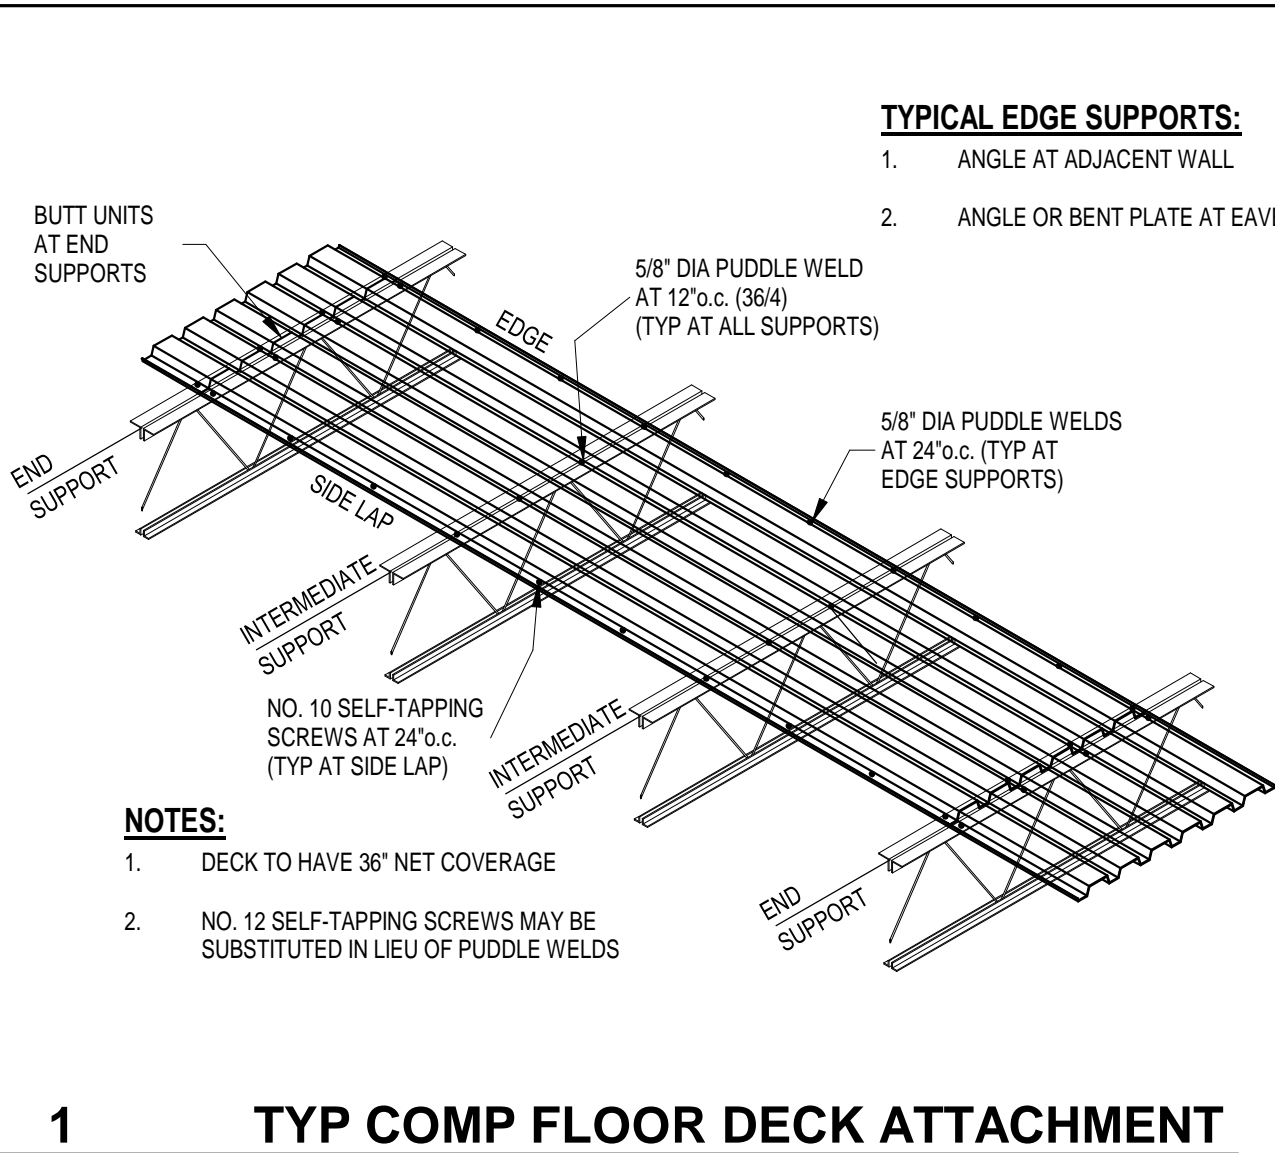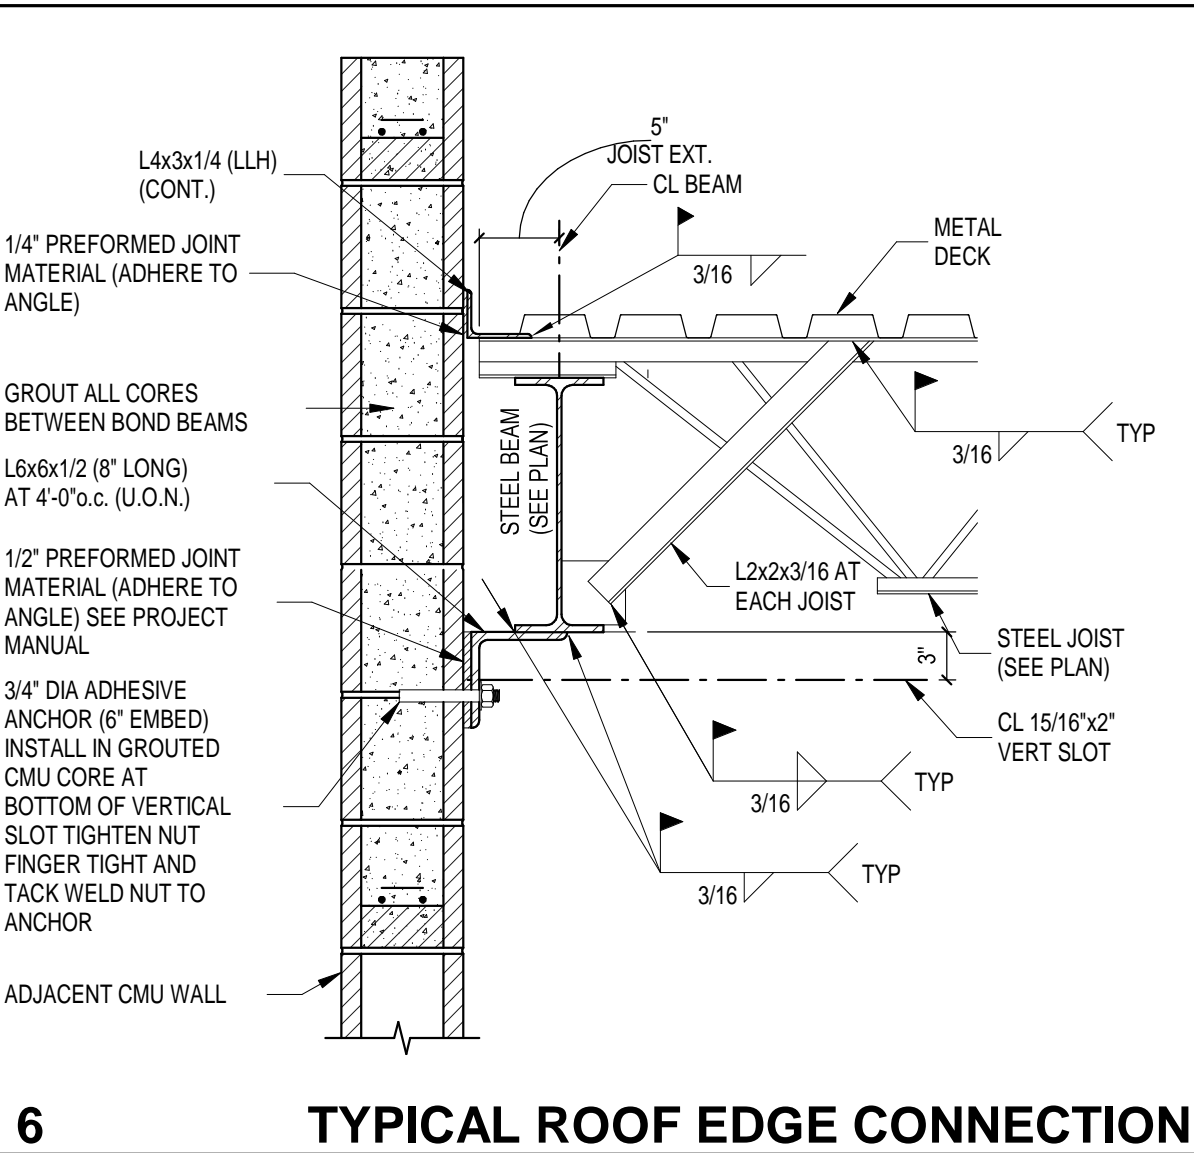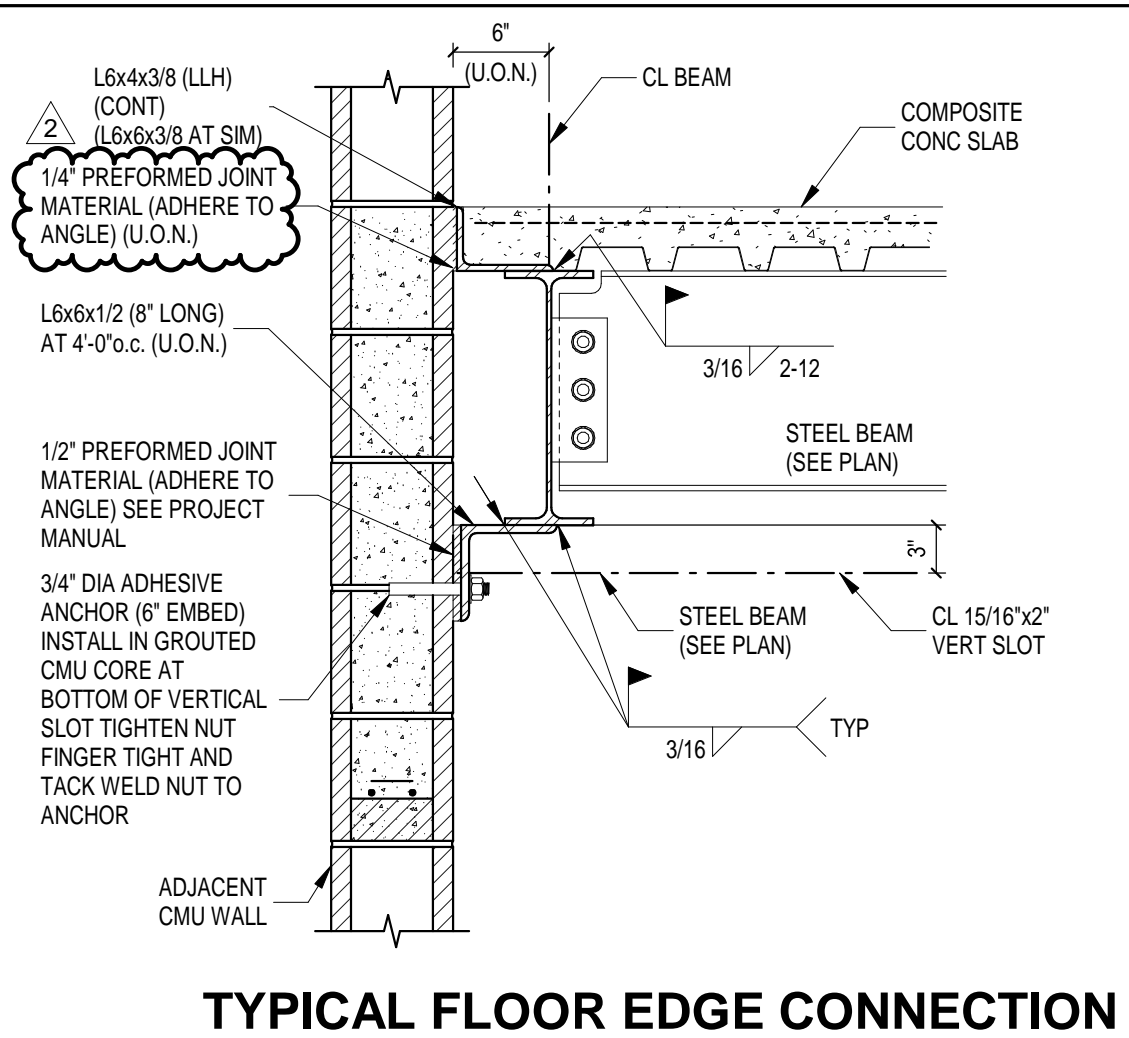

TLF, INC.

3901 West 96th Street, Suite 200
Indianapolis, Indiana 46268
Phone: 317-334-1500
Fax: 317-334-1552
TLF Job No: 2024-090

ISSUED FOR BID



PROJECT MANAGER: JM
DRAWN BY: TLF
PROJECT NUMBER: 224018.00
PROJECT ISSUE DATE: 01/21/2025

REV. NO.	DESCRIPTION	DATE
2	ADDENDUM #2	02-18-2025

FRAMING DETAILS

S5-03

ZIONSVILLE
COMMUNITY HIGH
SCHOOL ATHLETIC
LOCKERS
ADDITION AND
RENOVATION

1000 MULBERRY STREET,
ZIONSVILLE, IN 46077

ZIONSVILLE COMMUNITY
SCHOOLS



ZIONSVILLE
COMMUNITY SCHOOLS

ARCHITECT

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HOWEY

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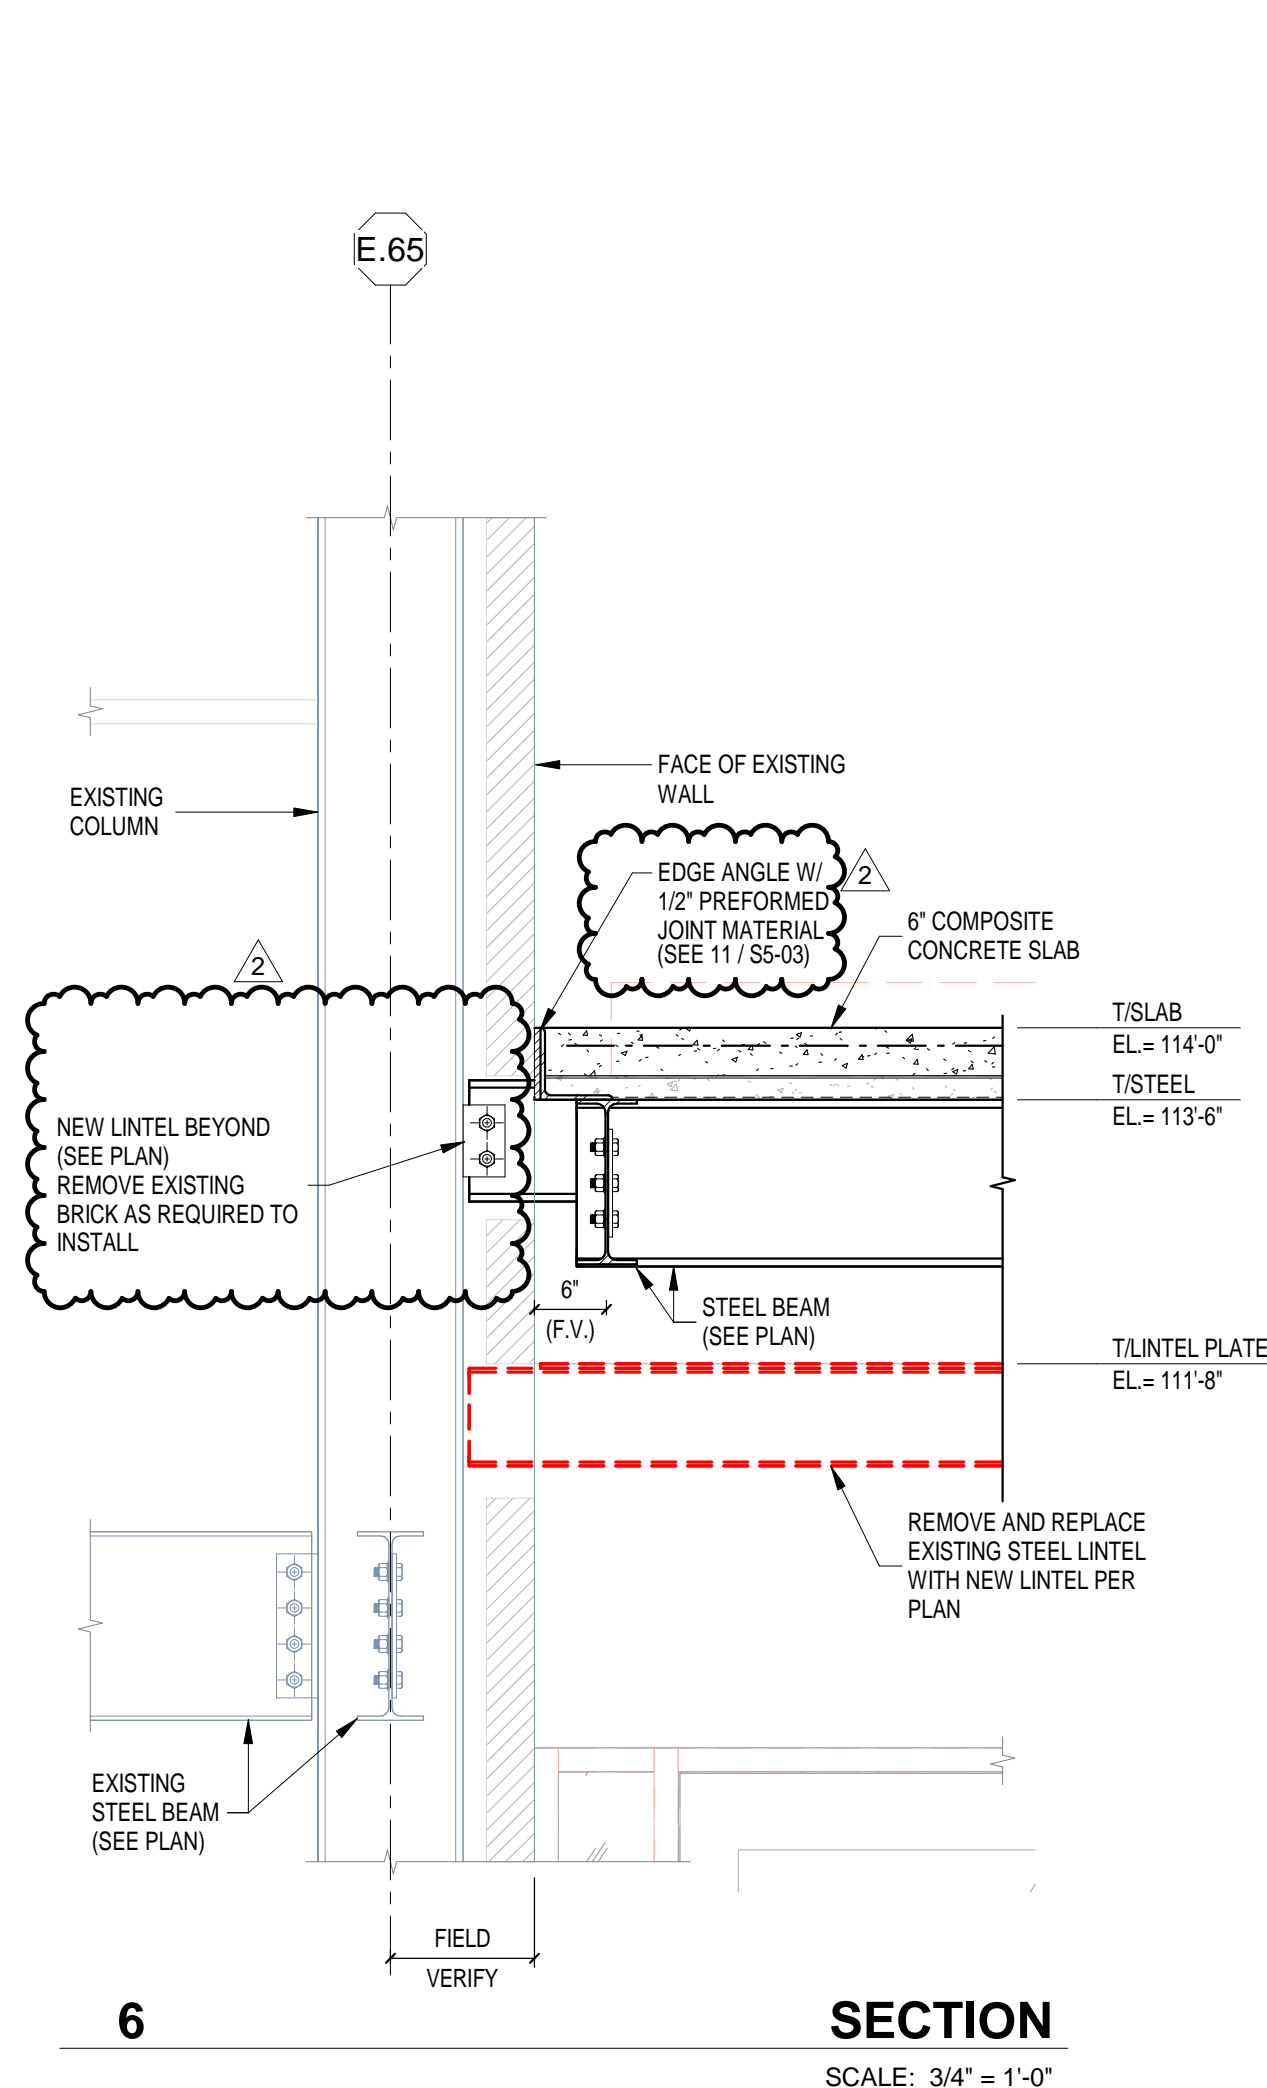
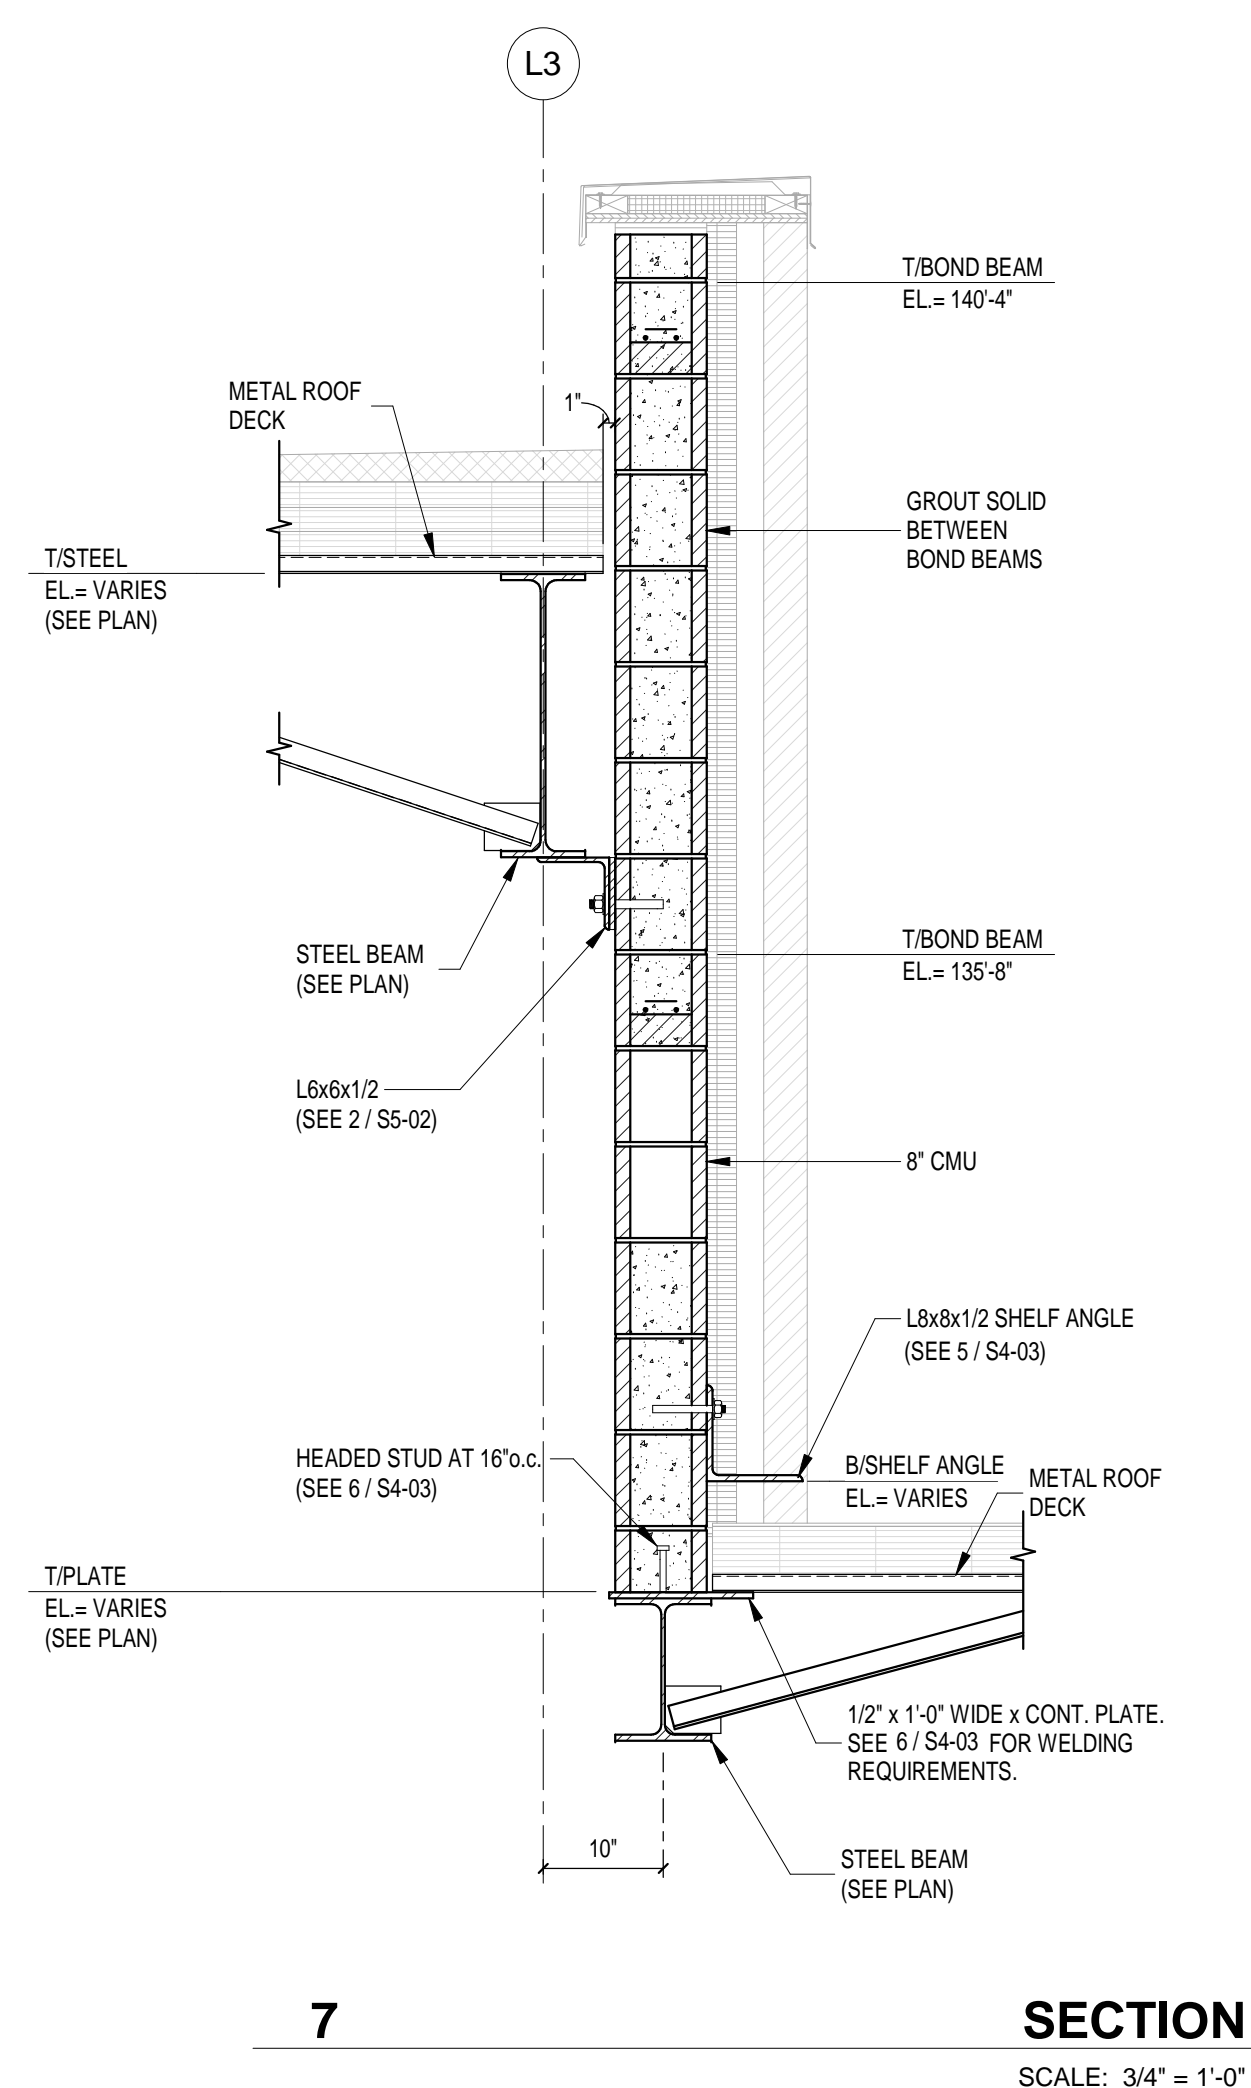
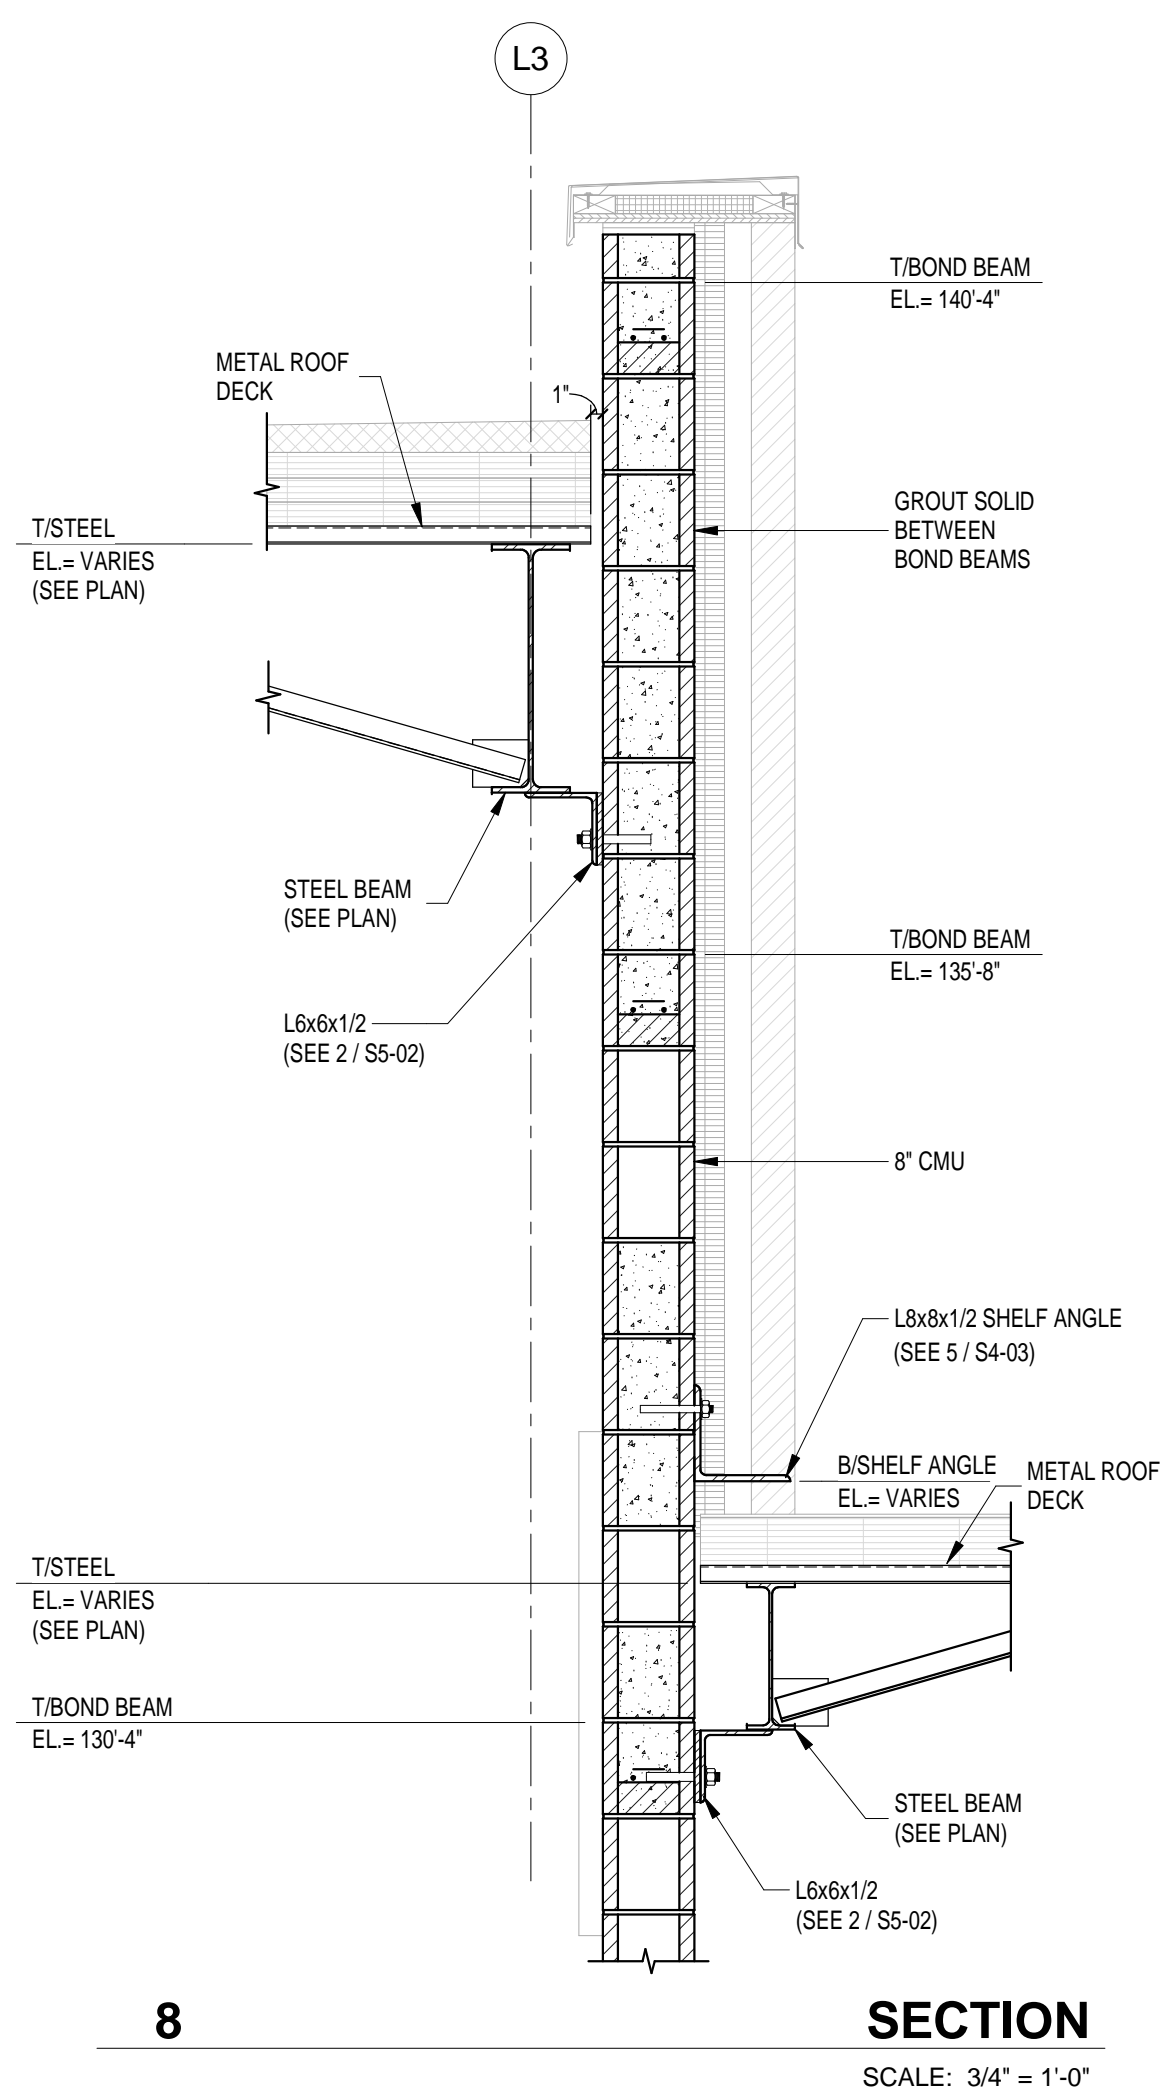
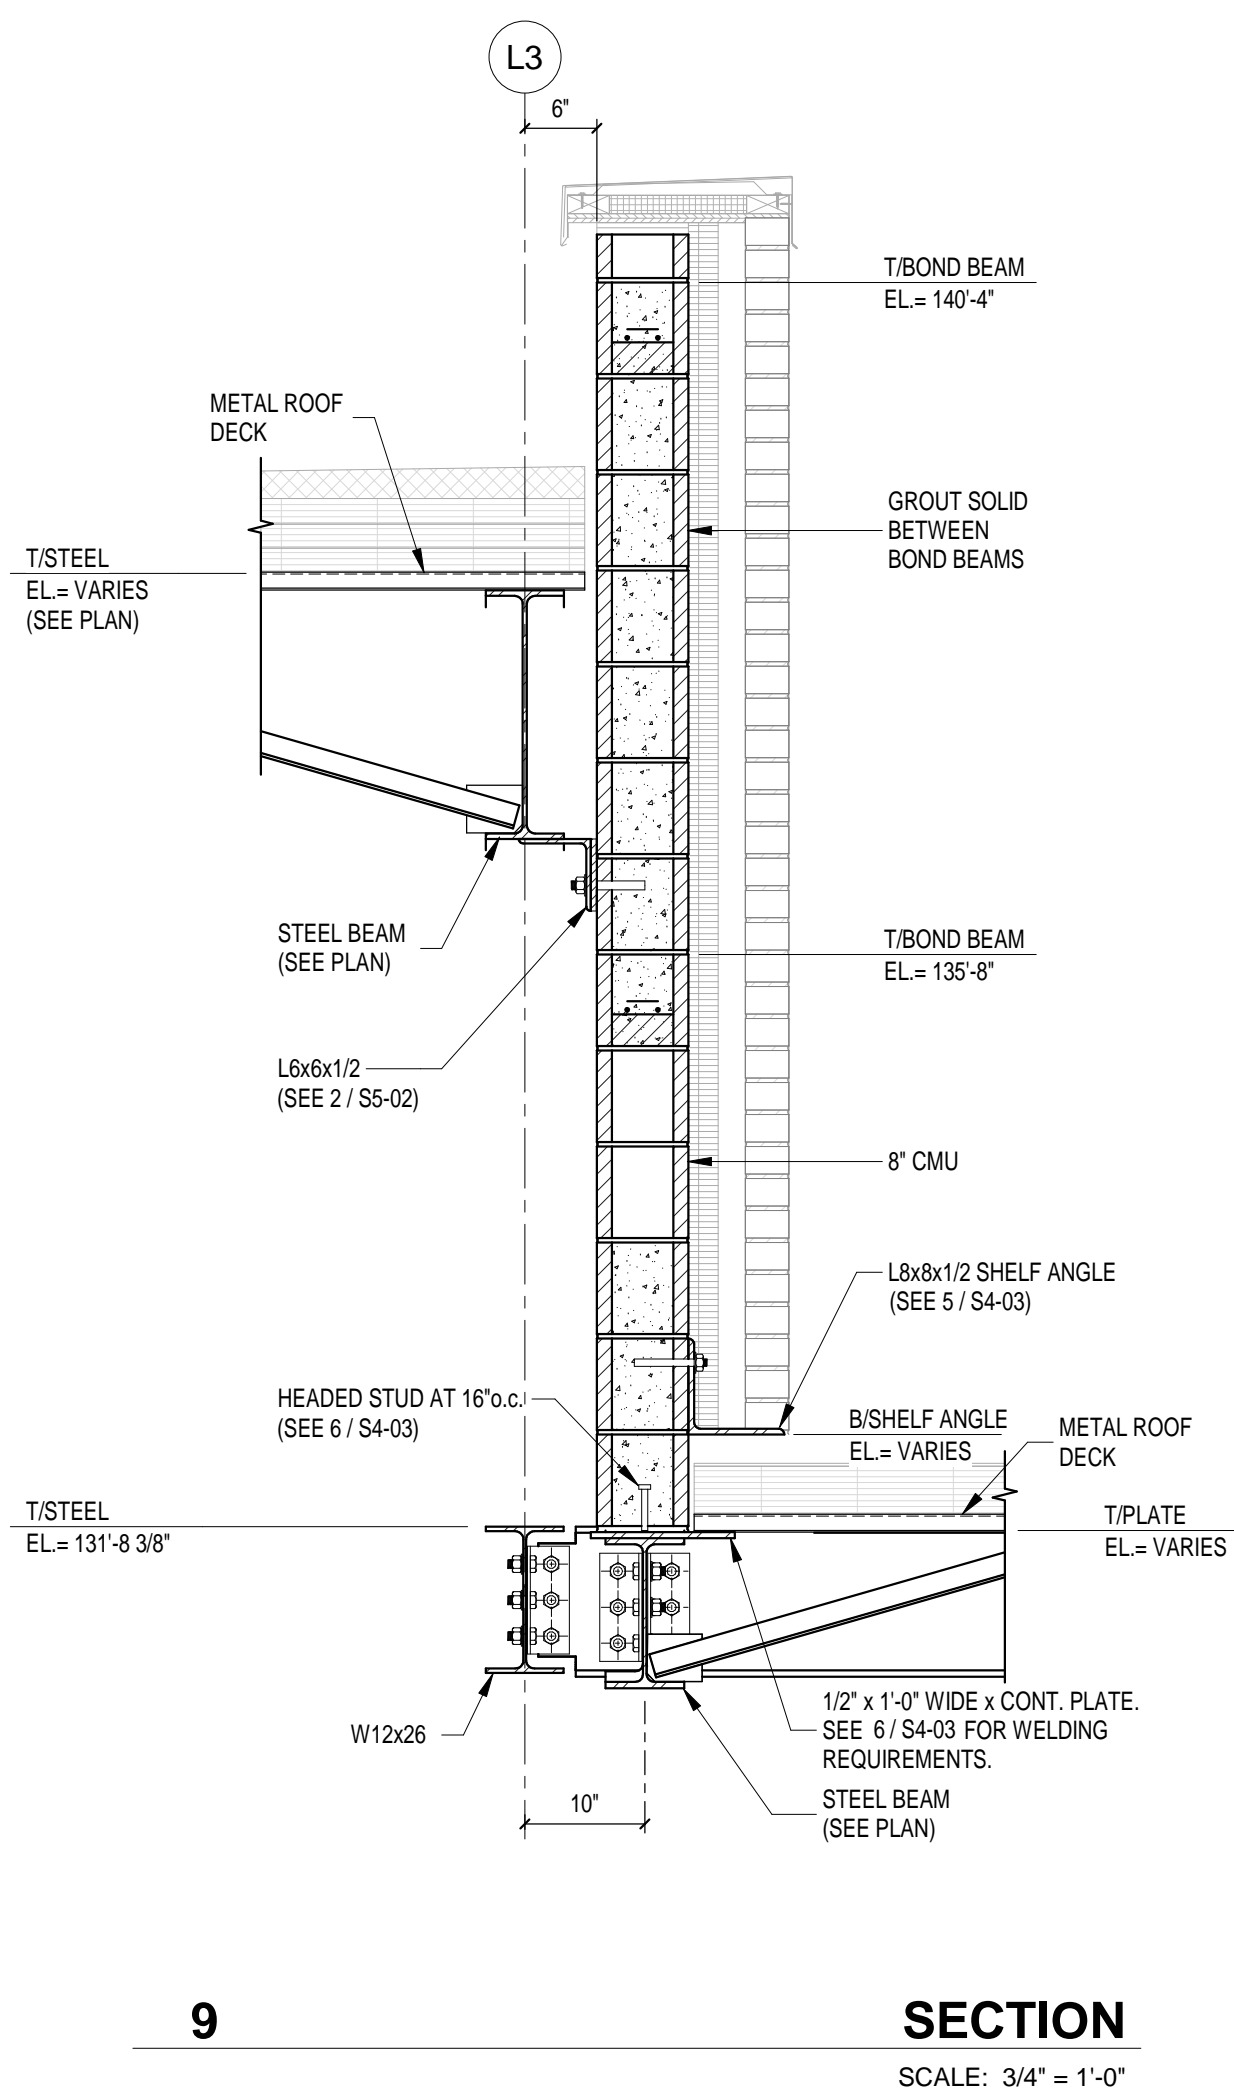
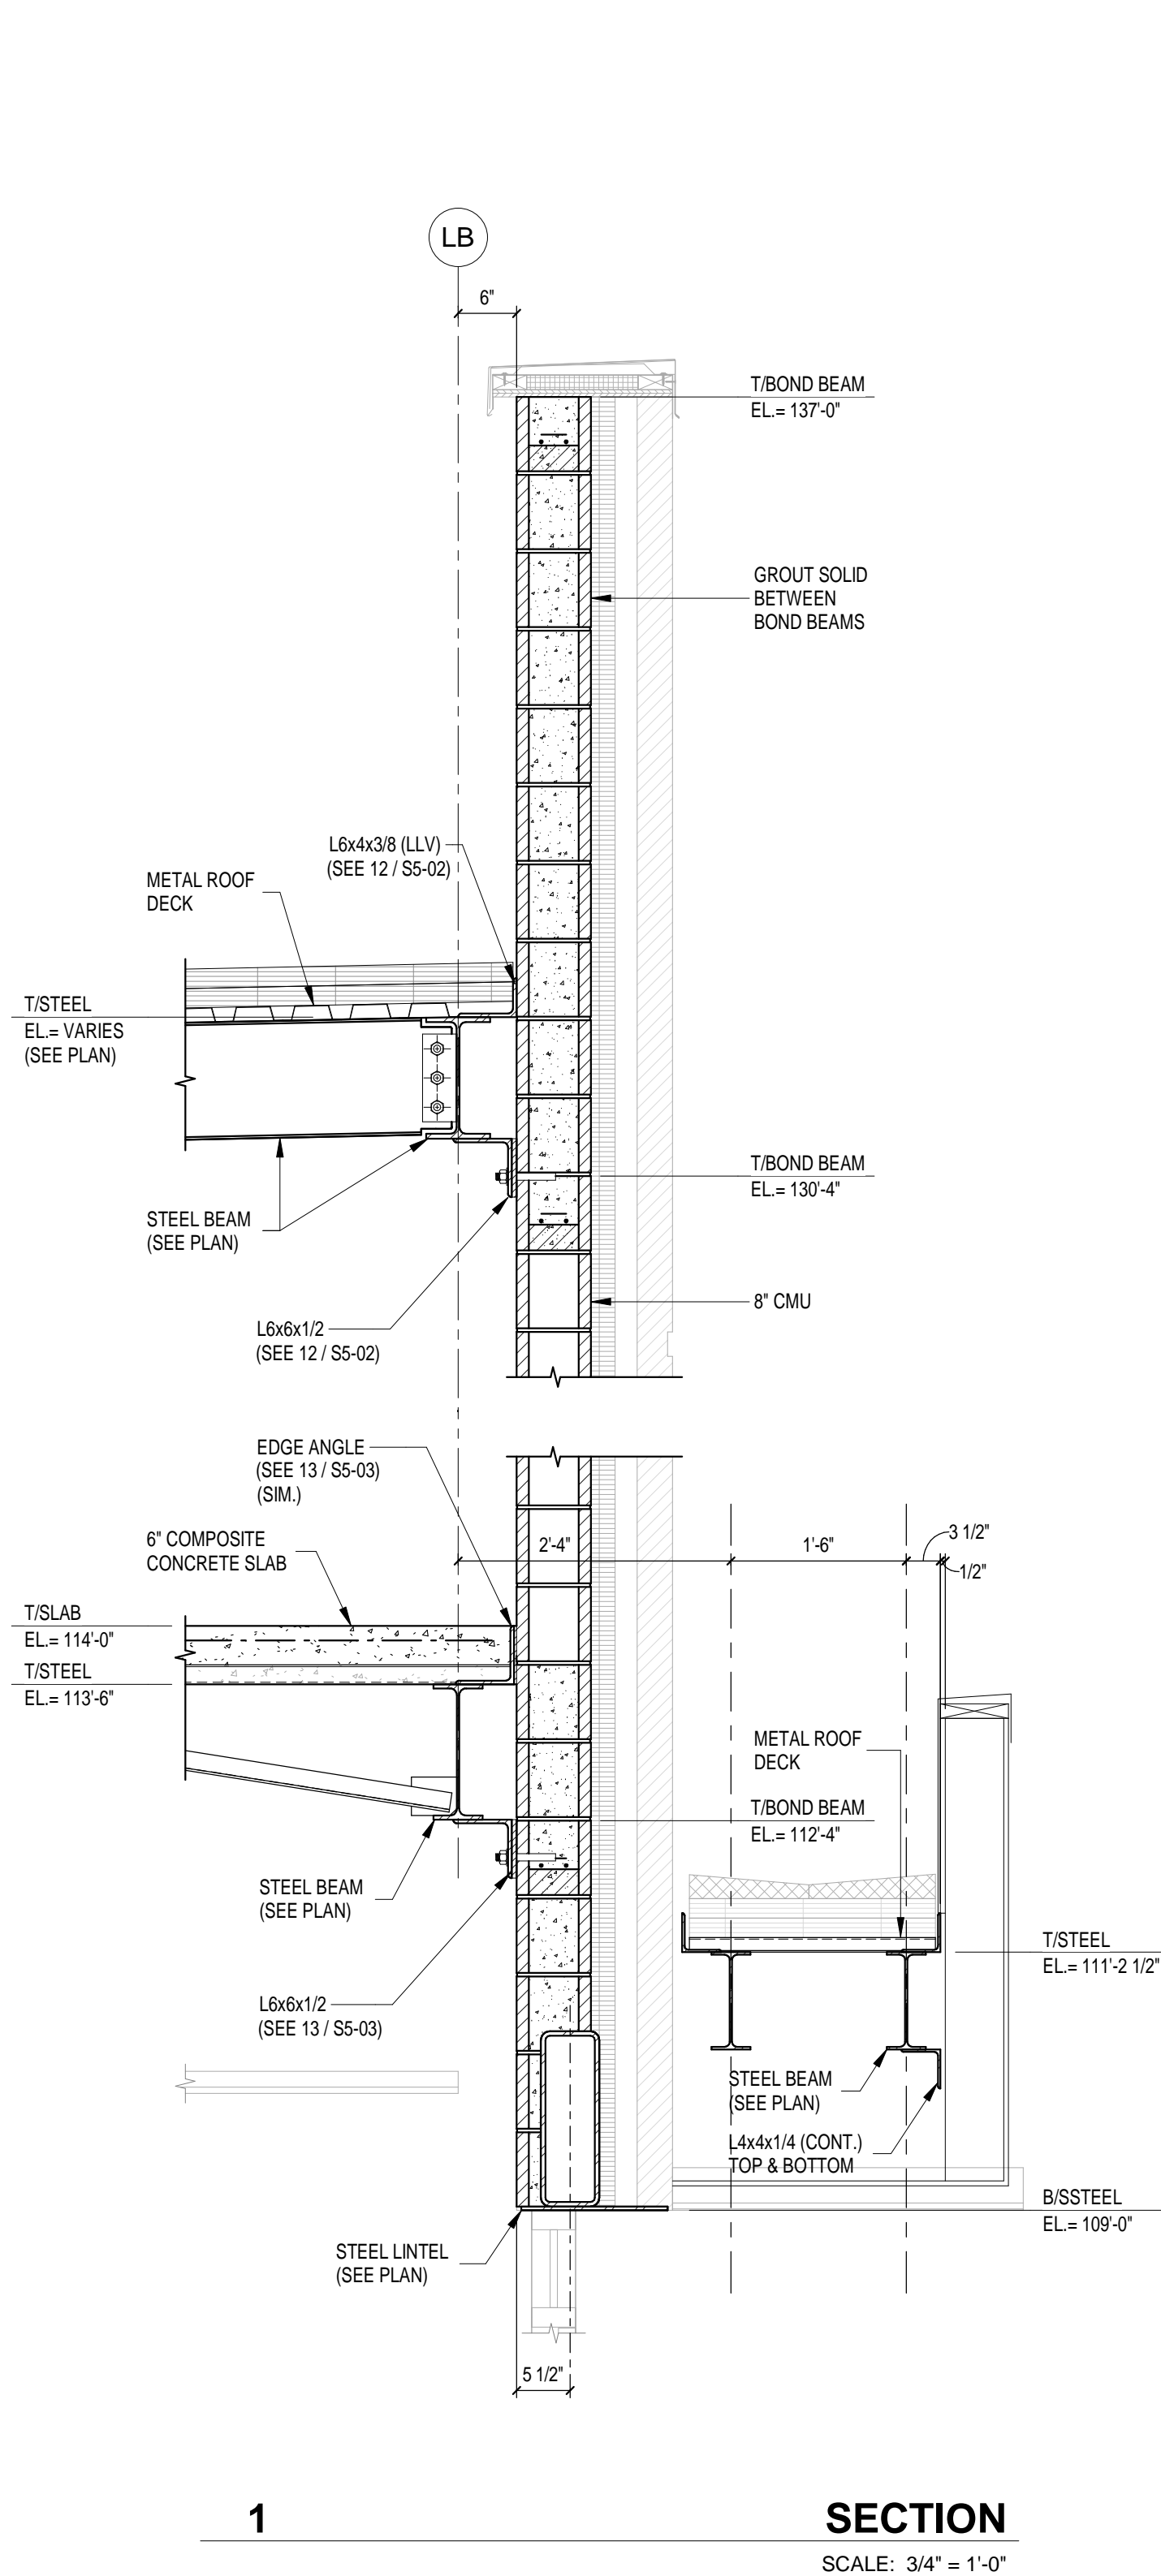
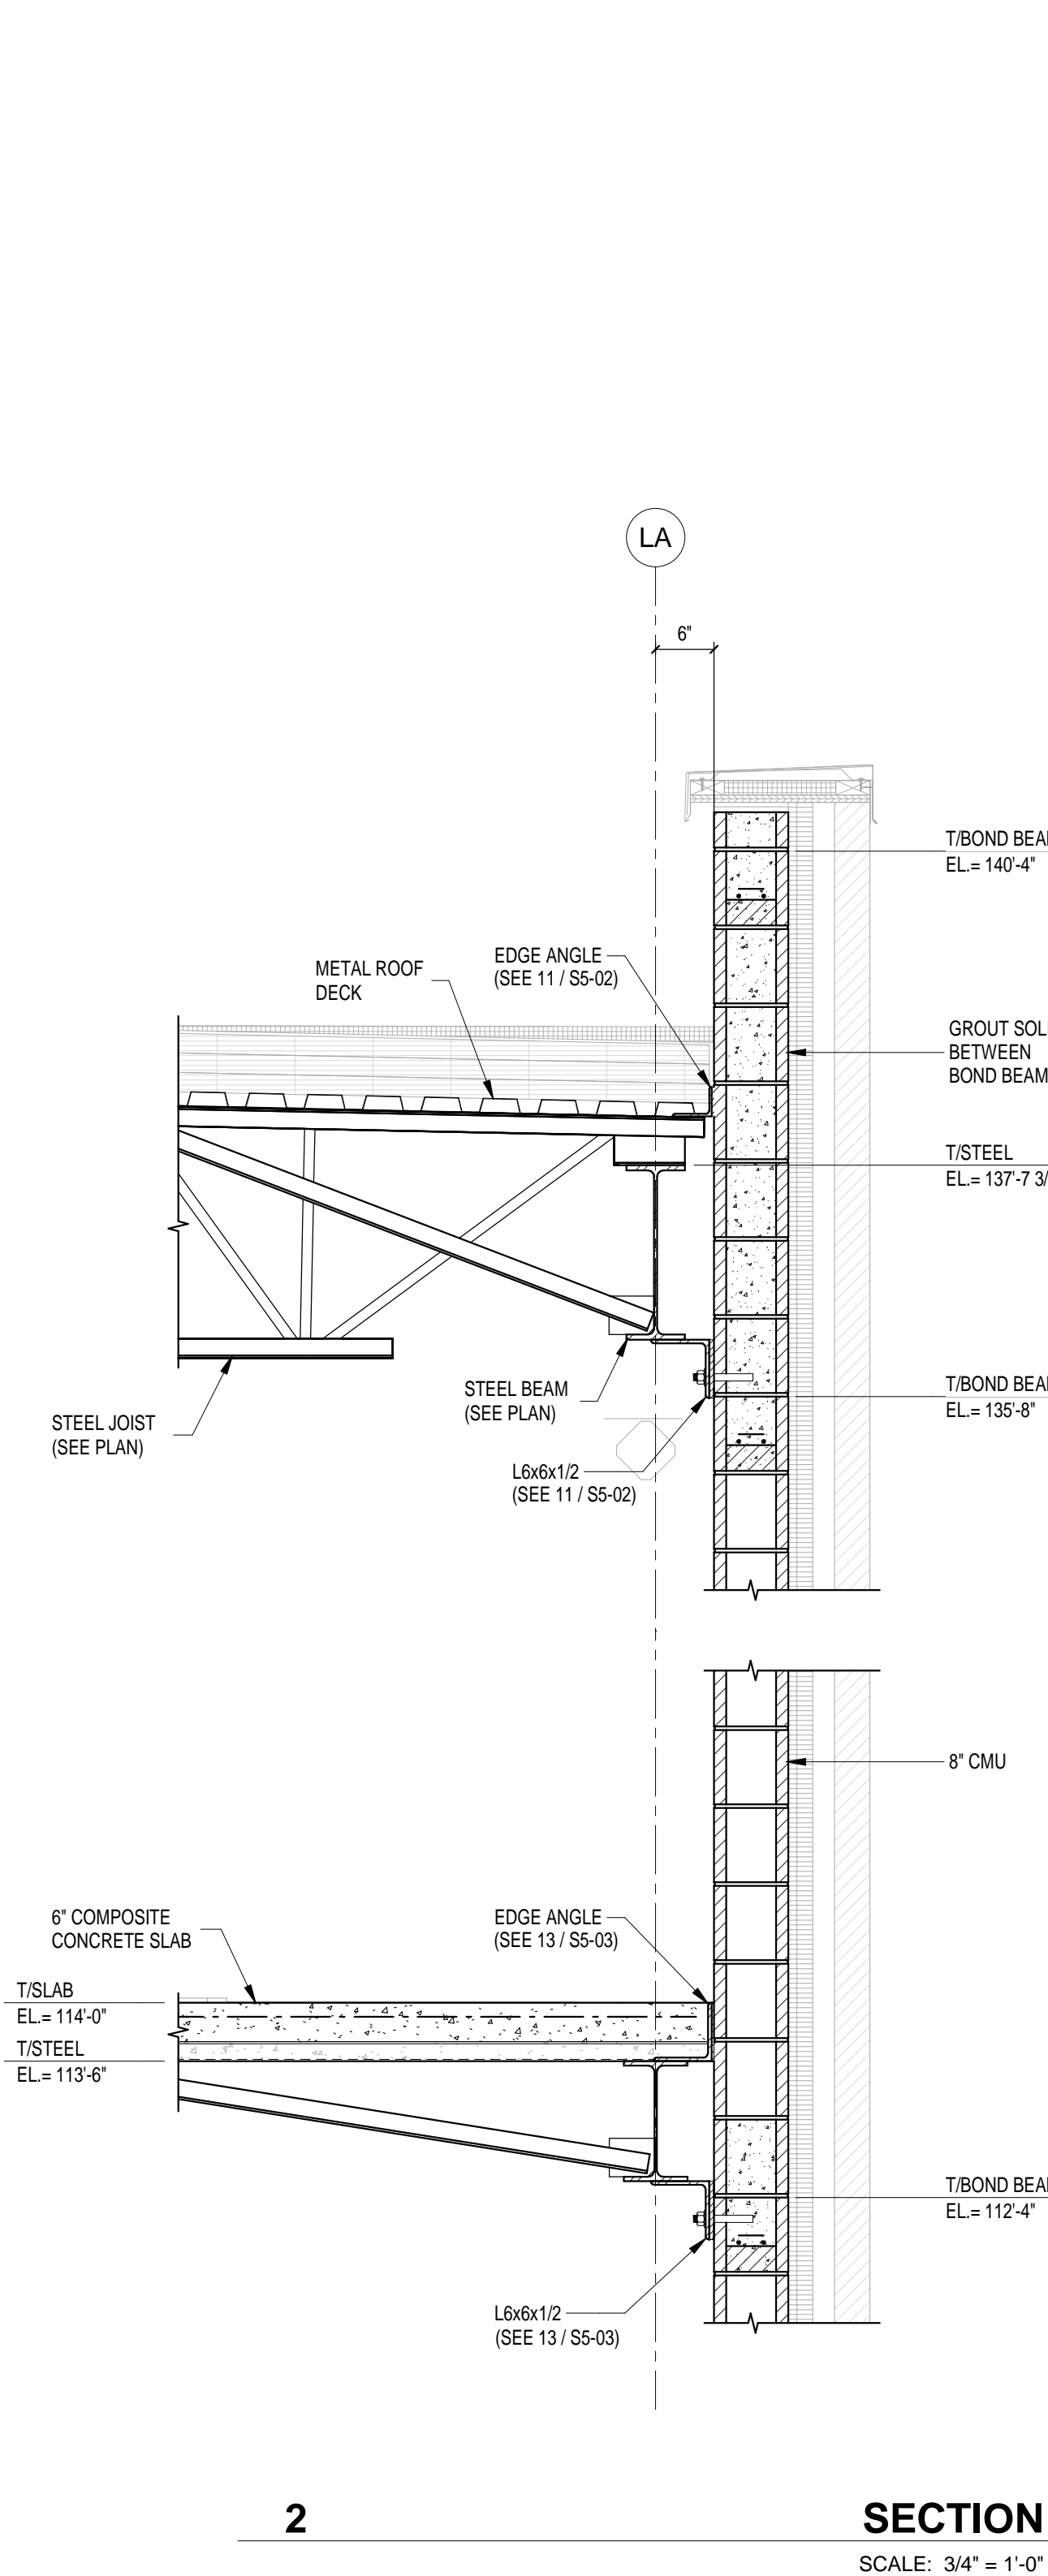
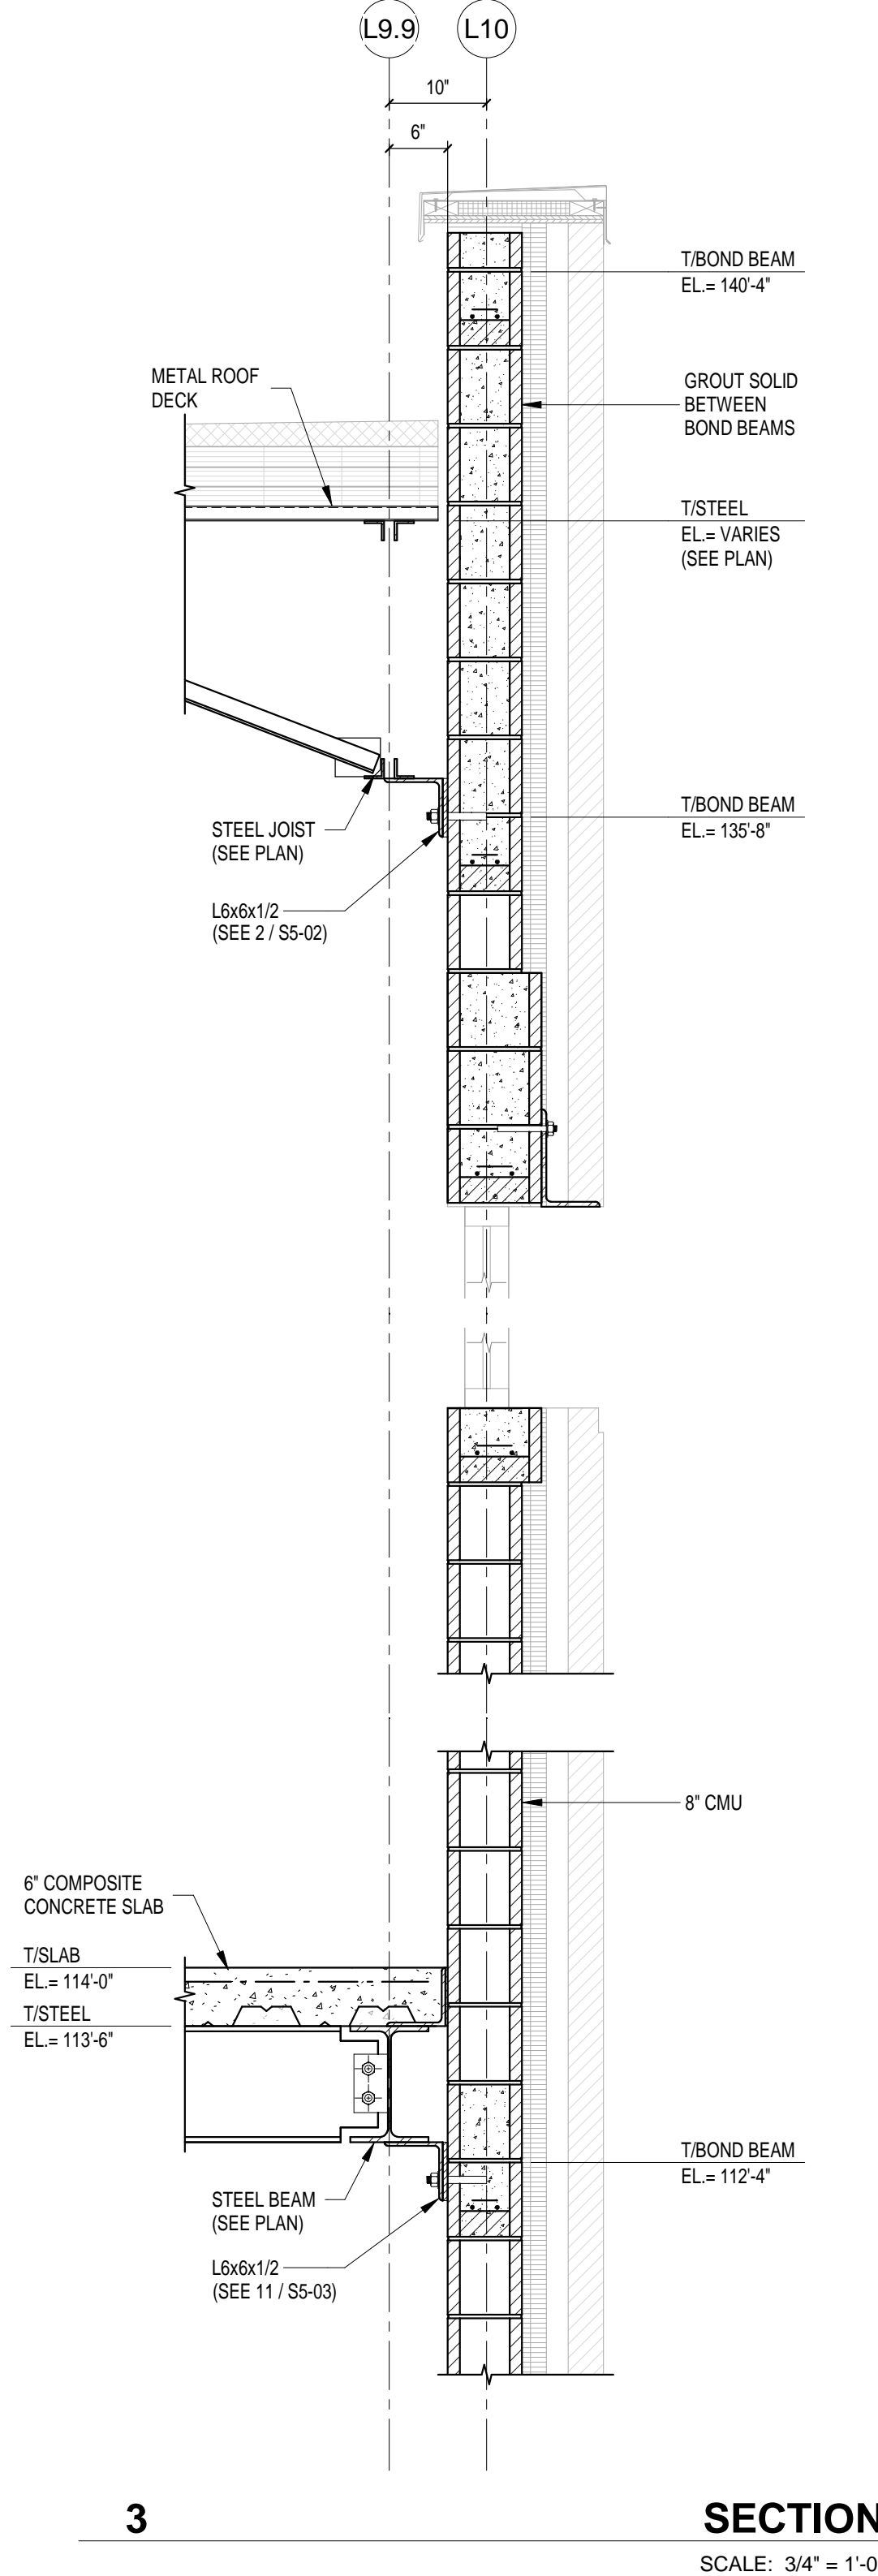
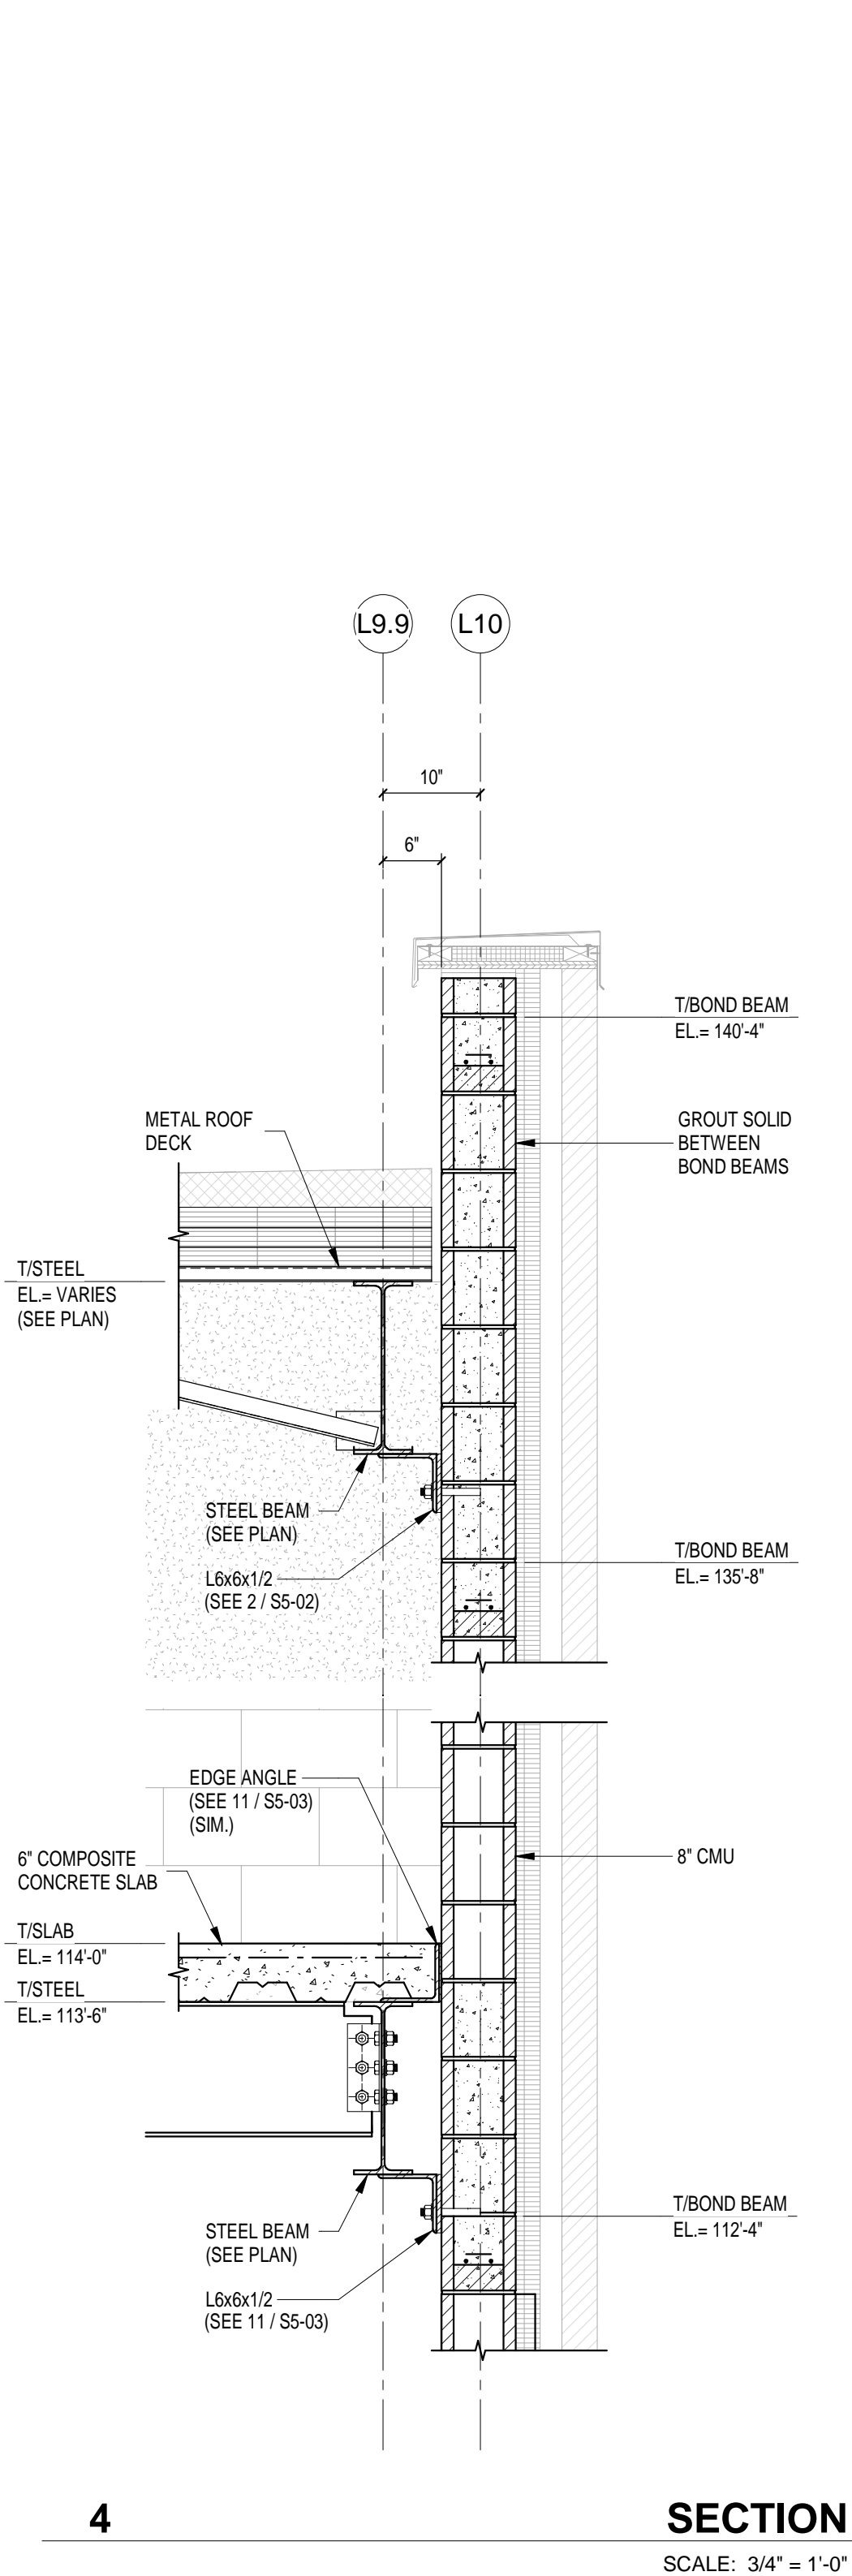
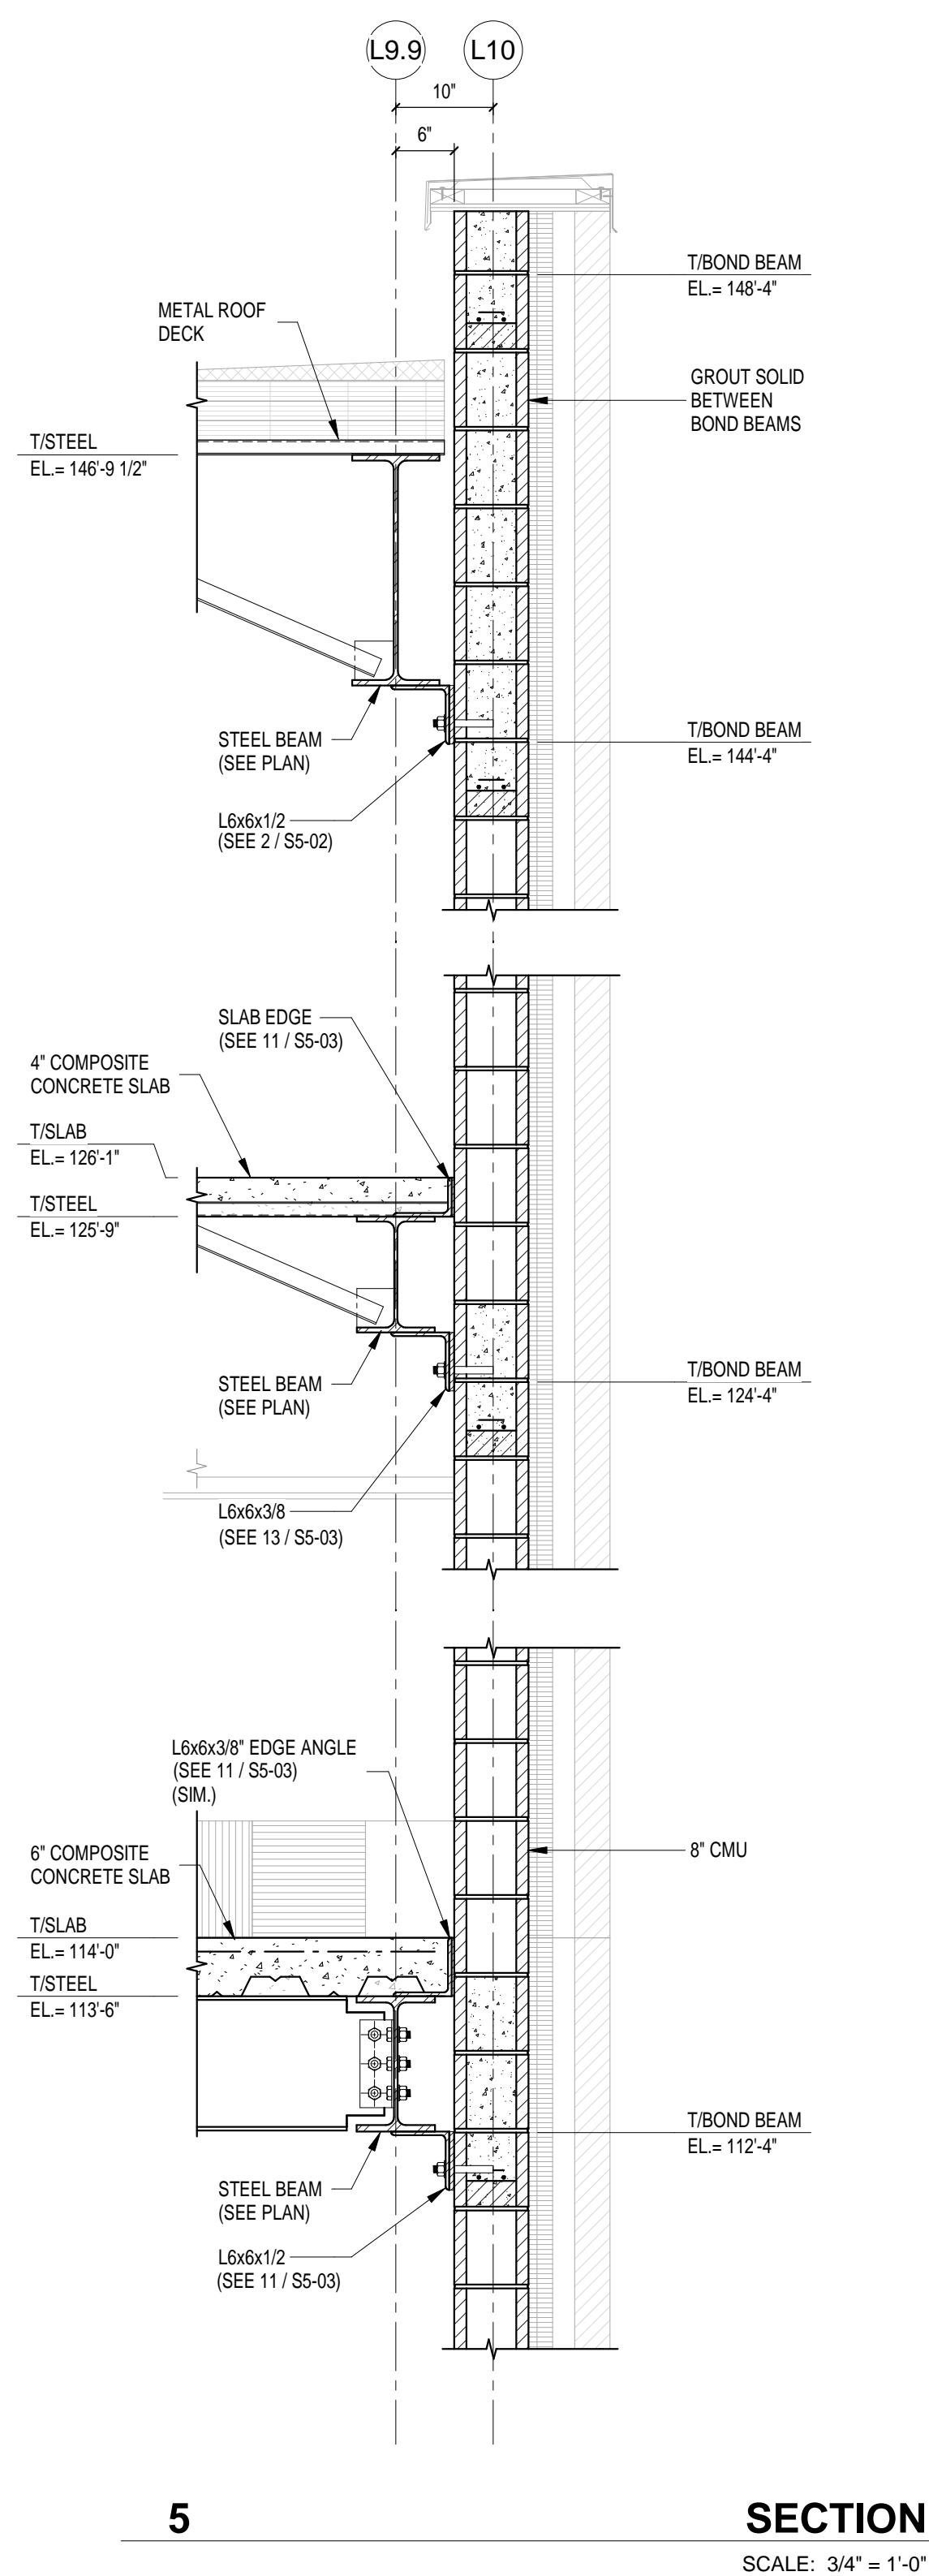


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2	ADDENDUM #2	02-18-2025

SECTIONS AND DETAILS

S5-04



ZIONSVILLE
COMMUNITY HIGH
SCHOOL ATHLETIC
LOCKERS
ADDITION AND
RENOVATION

1000 MULBERRY STREET,
ZIONSVILLE, IN 46077

ZIONSVILLE COMMUNITY
SCHOOLS



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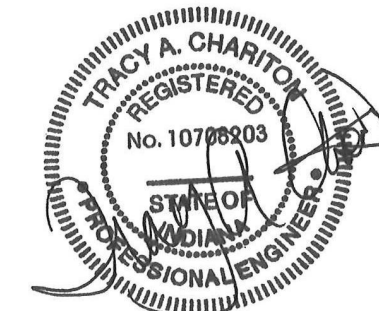
CONSULTANT



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TLF Job No: 2024-090

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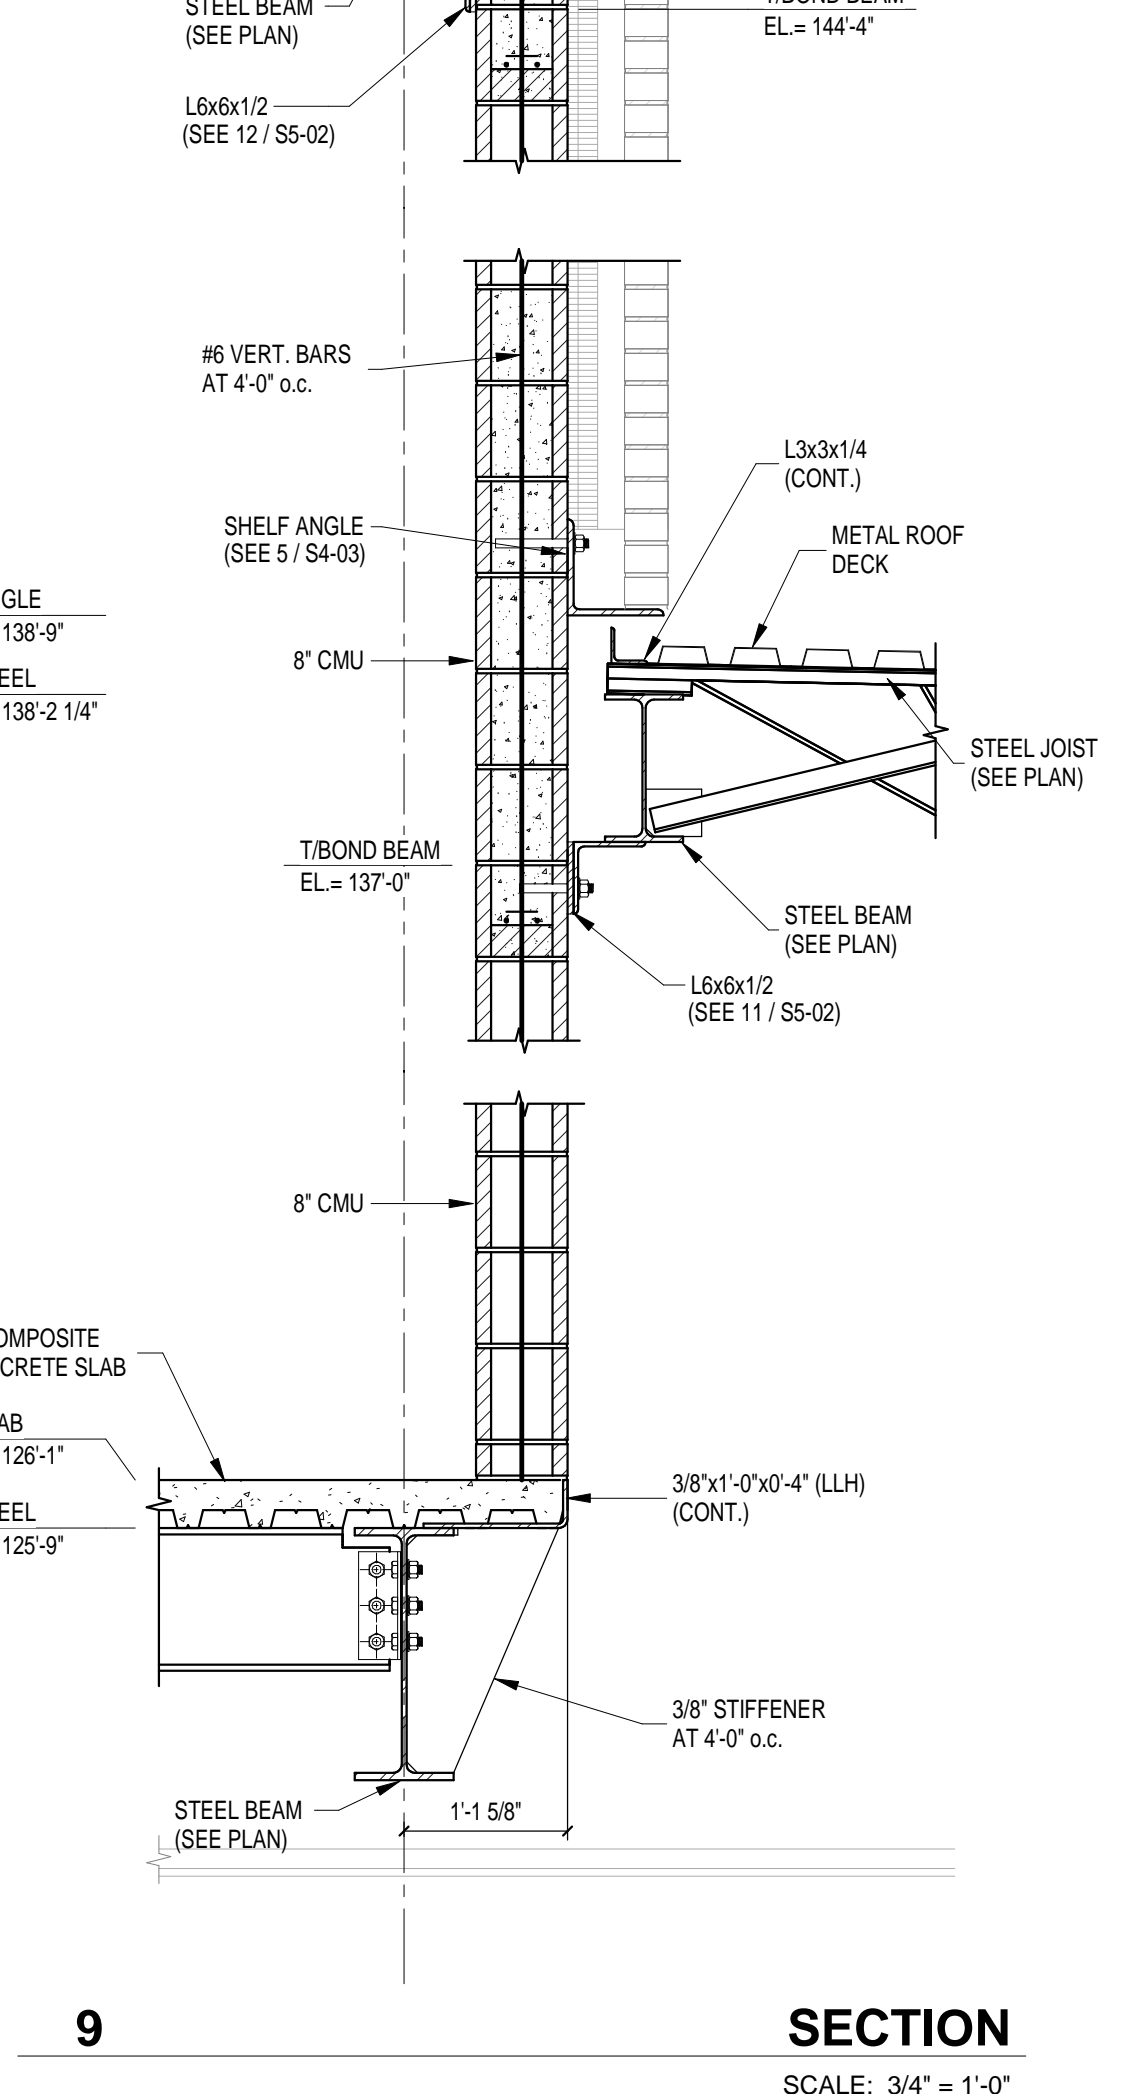
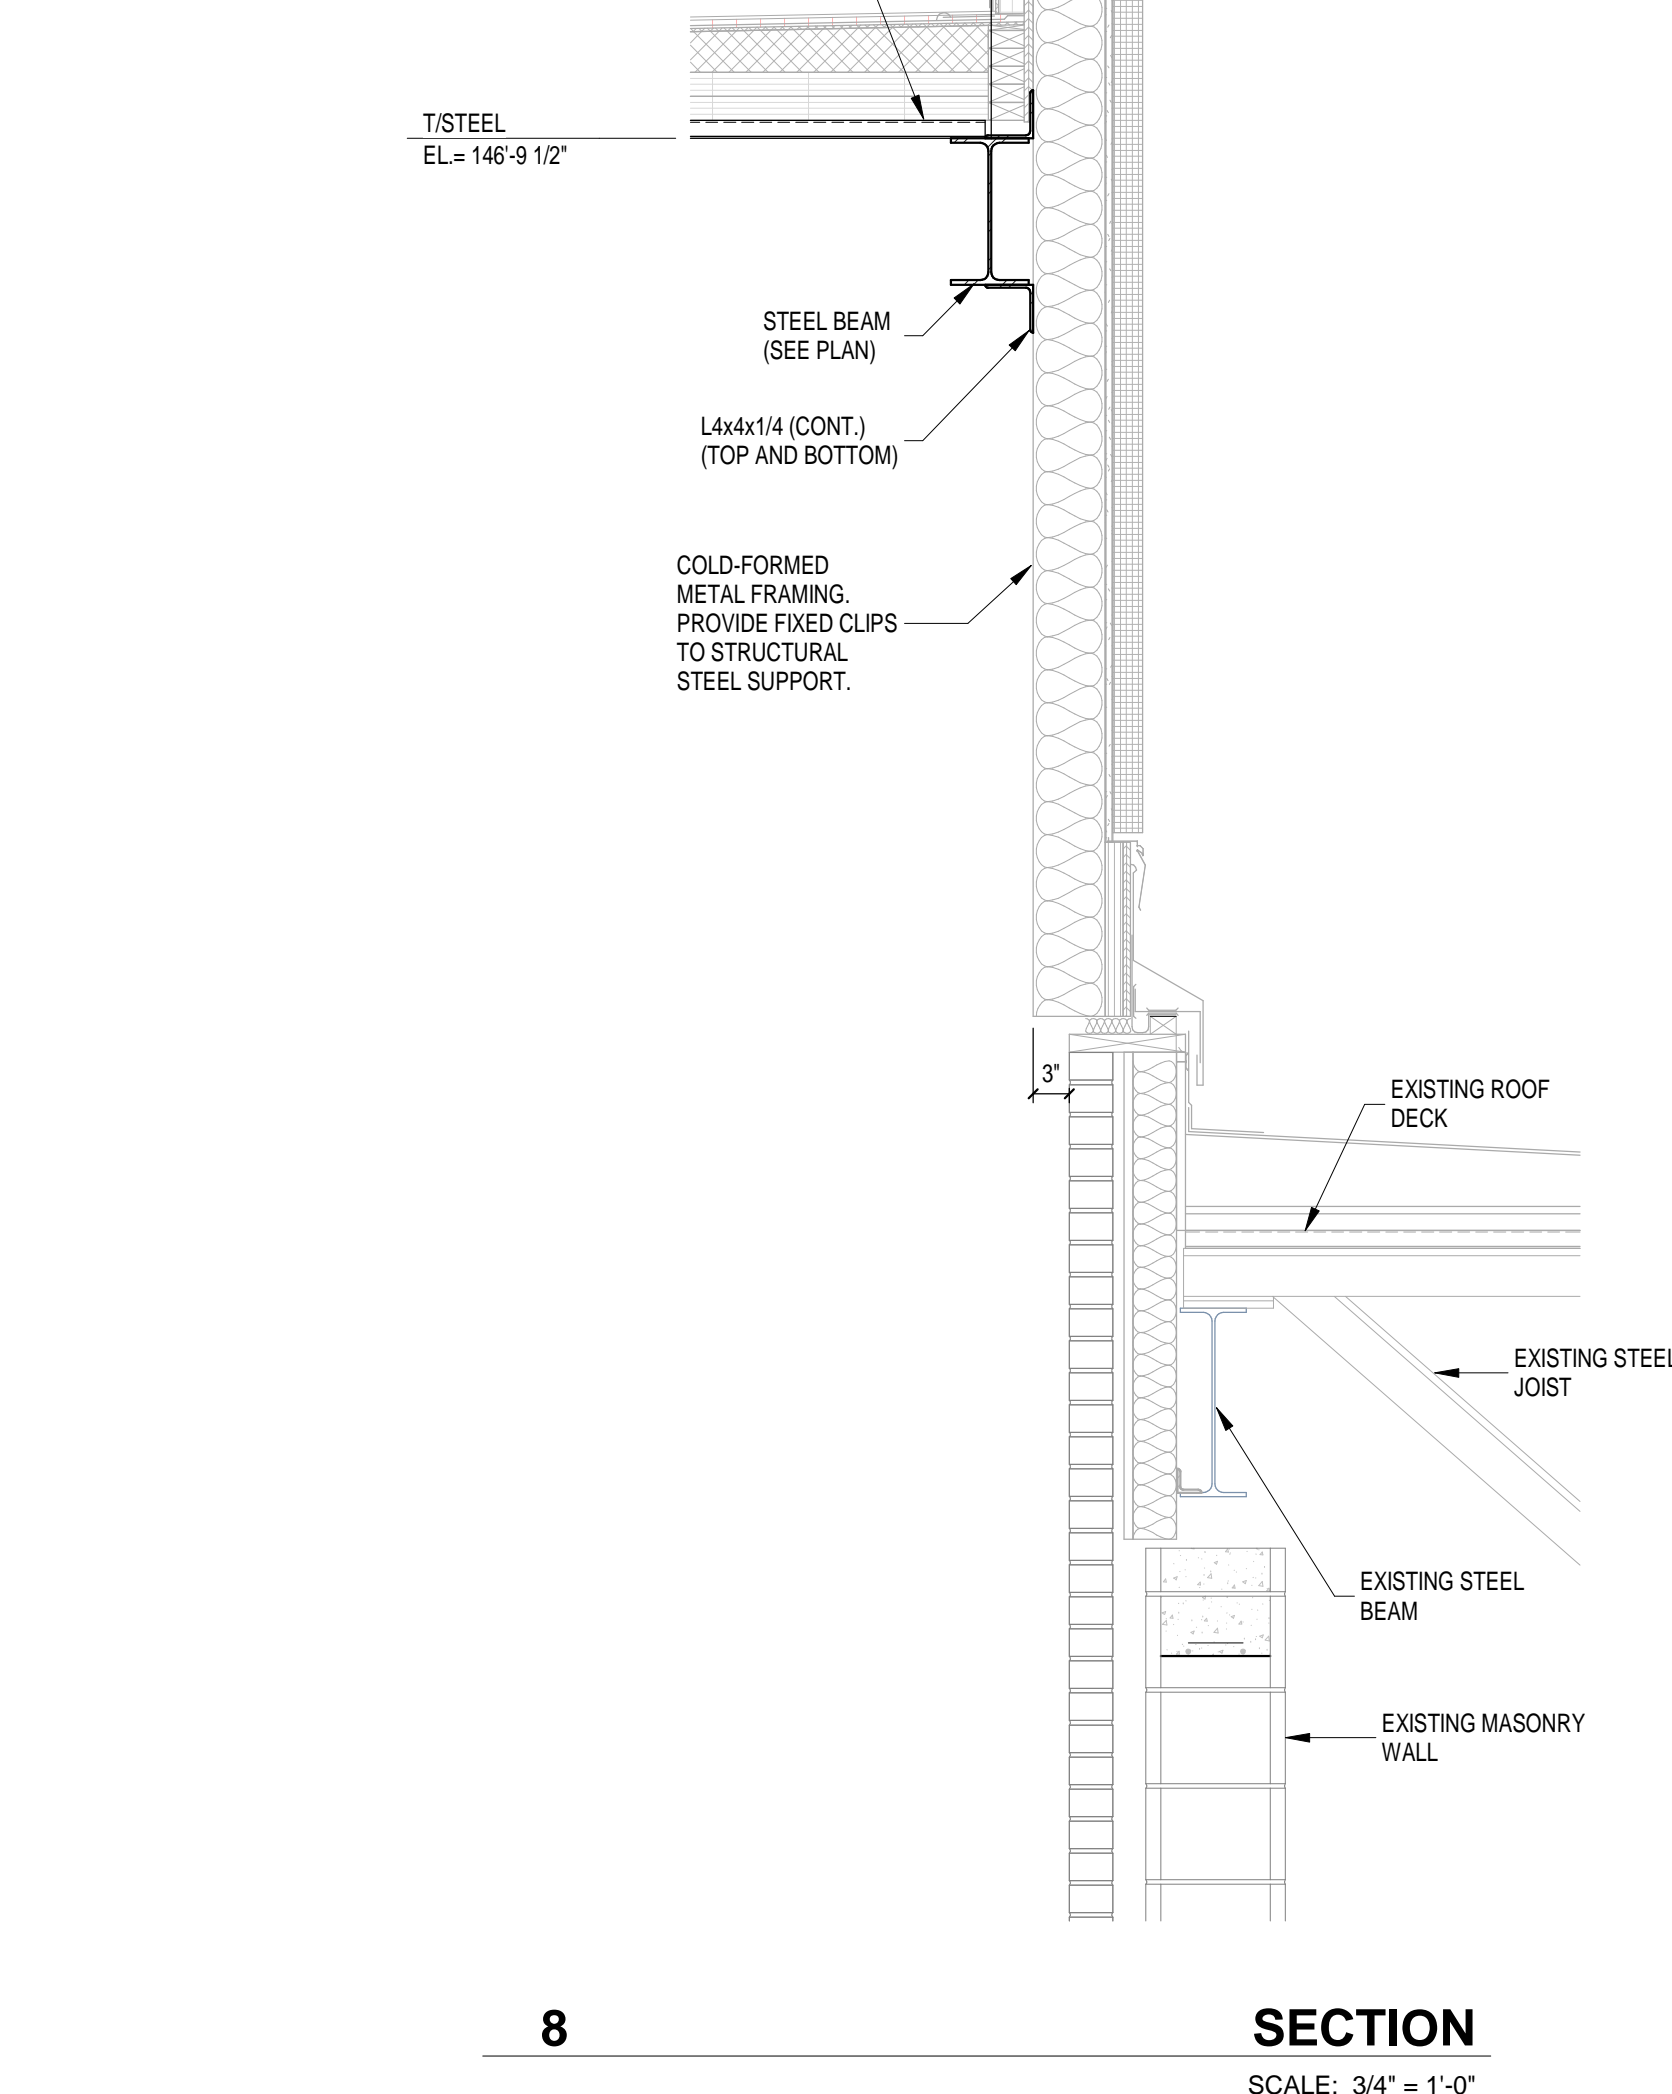
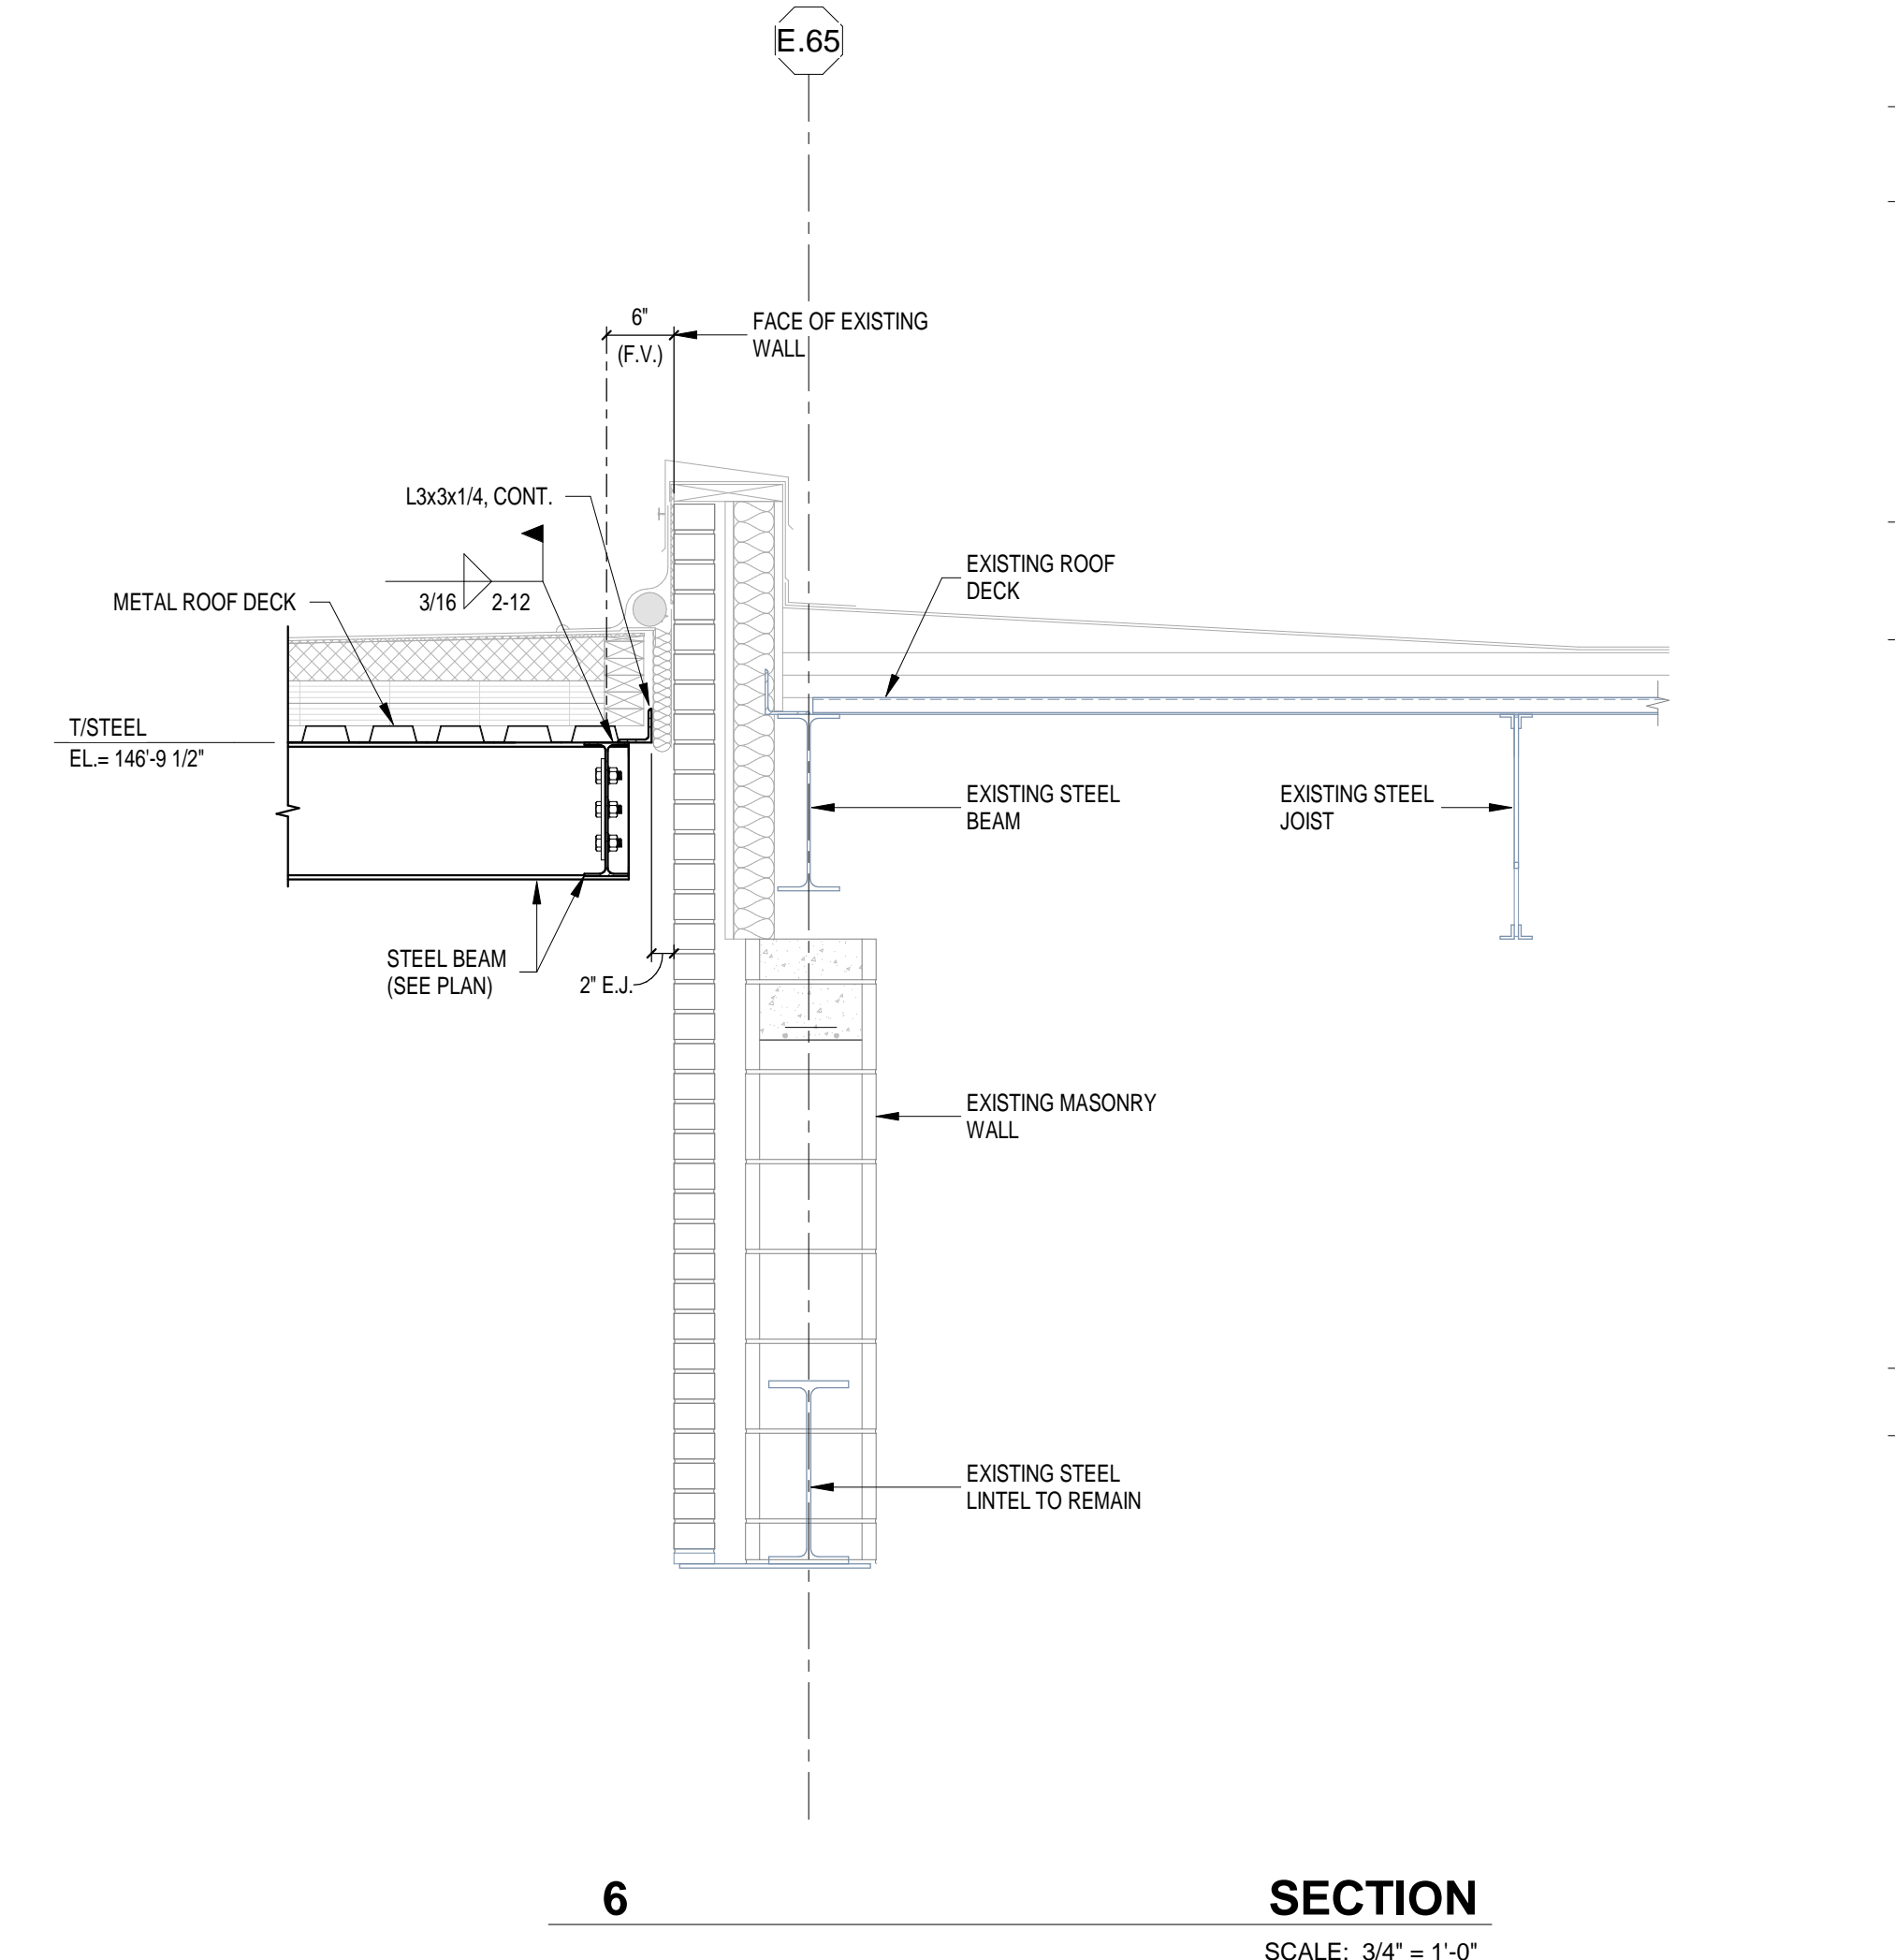
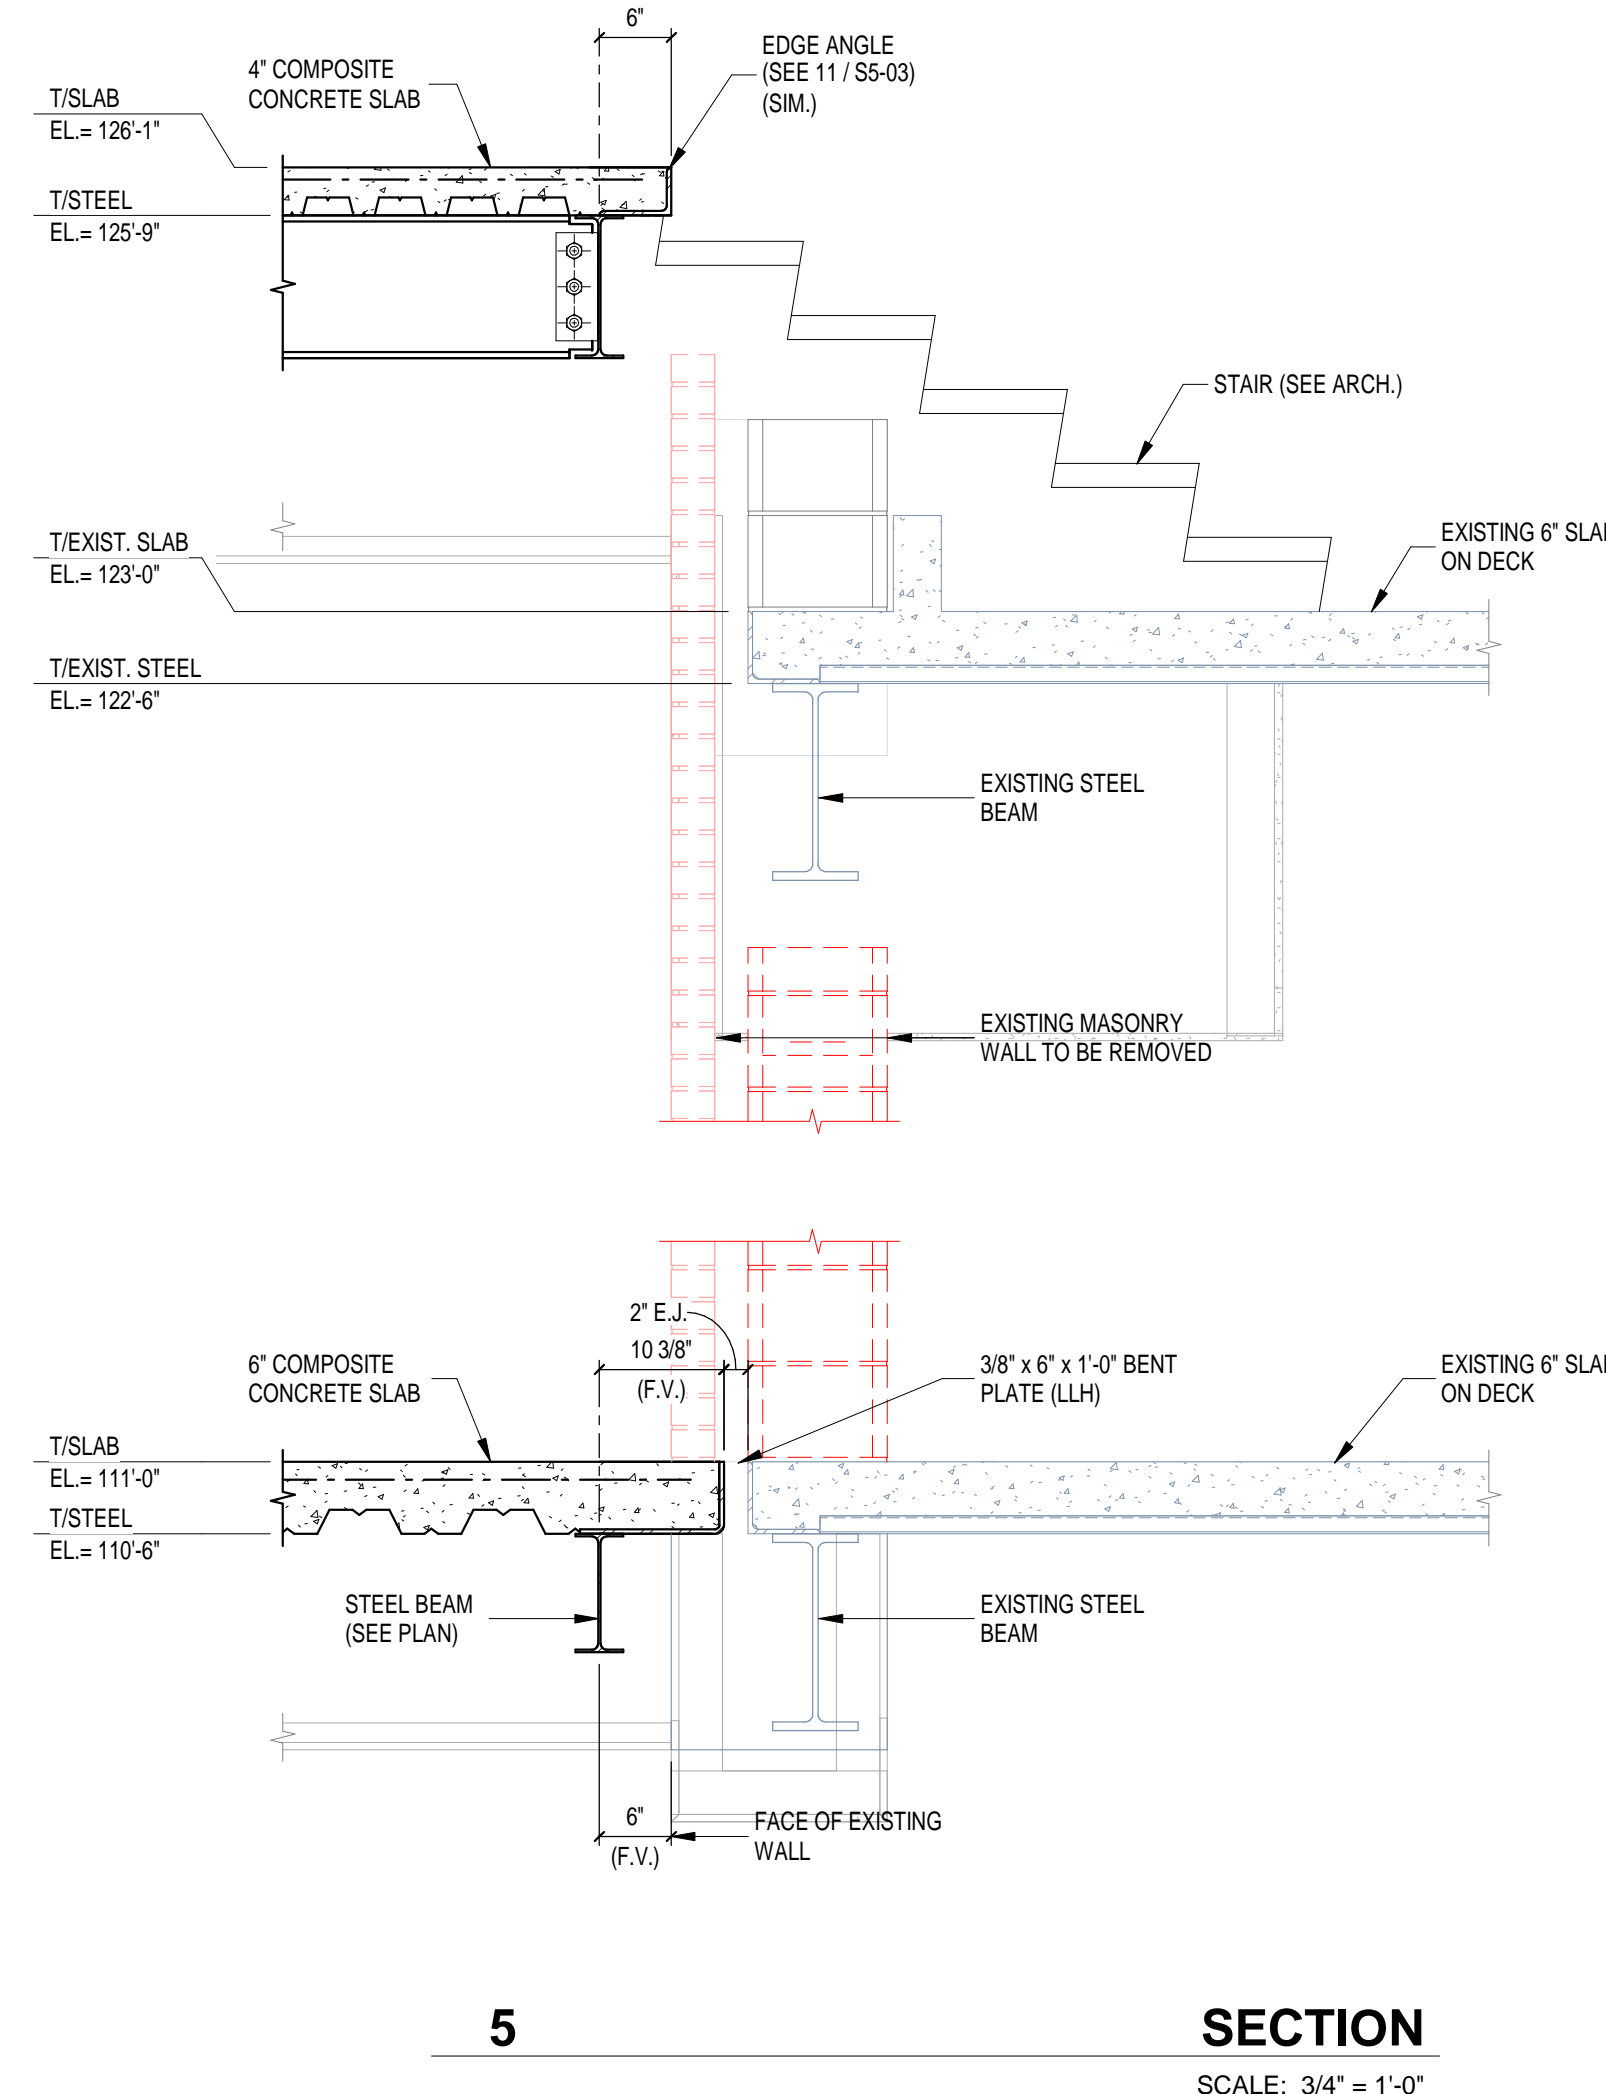
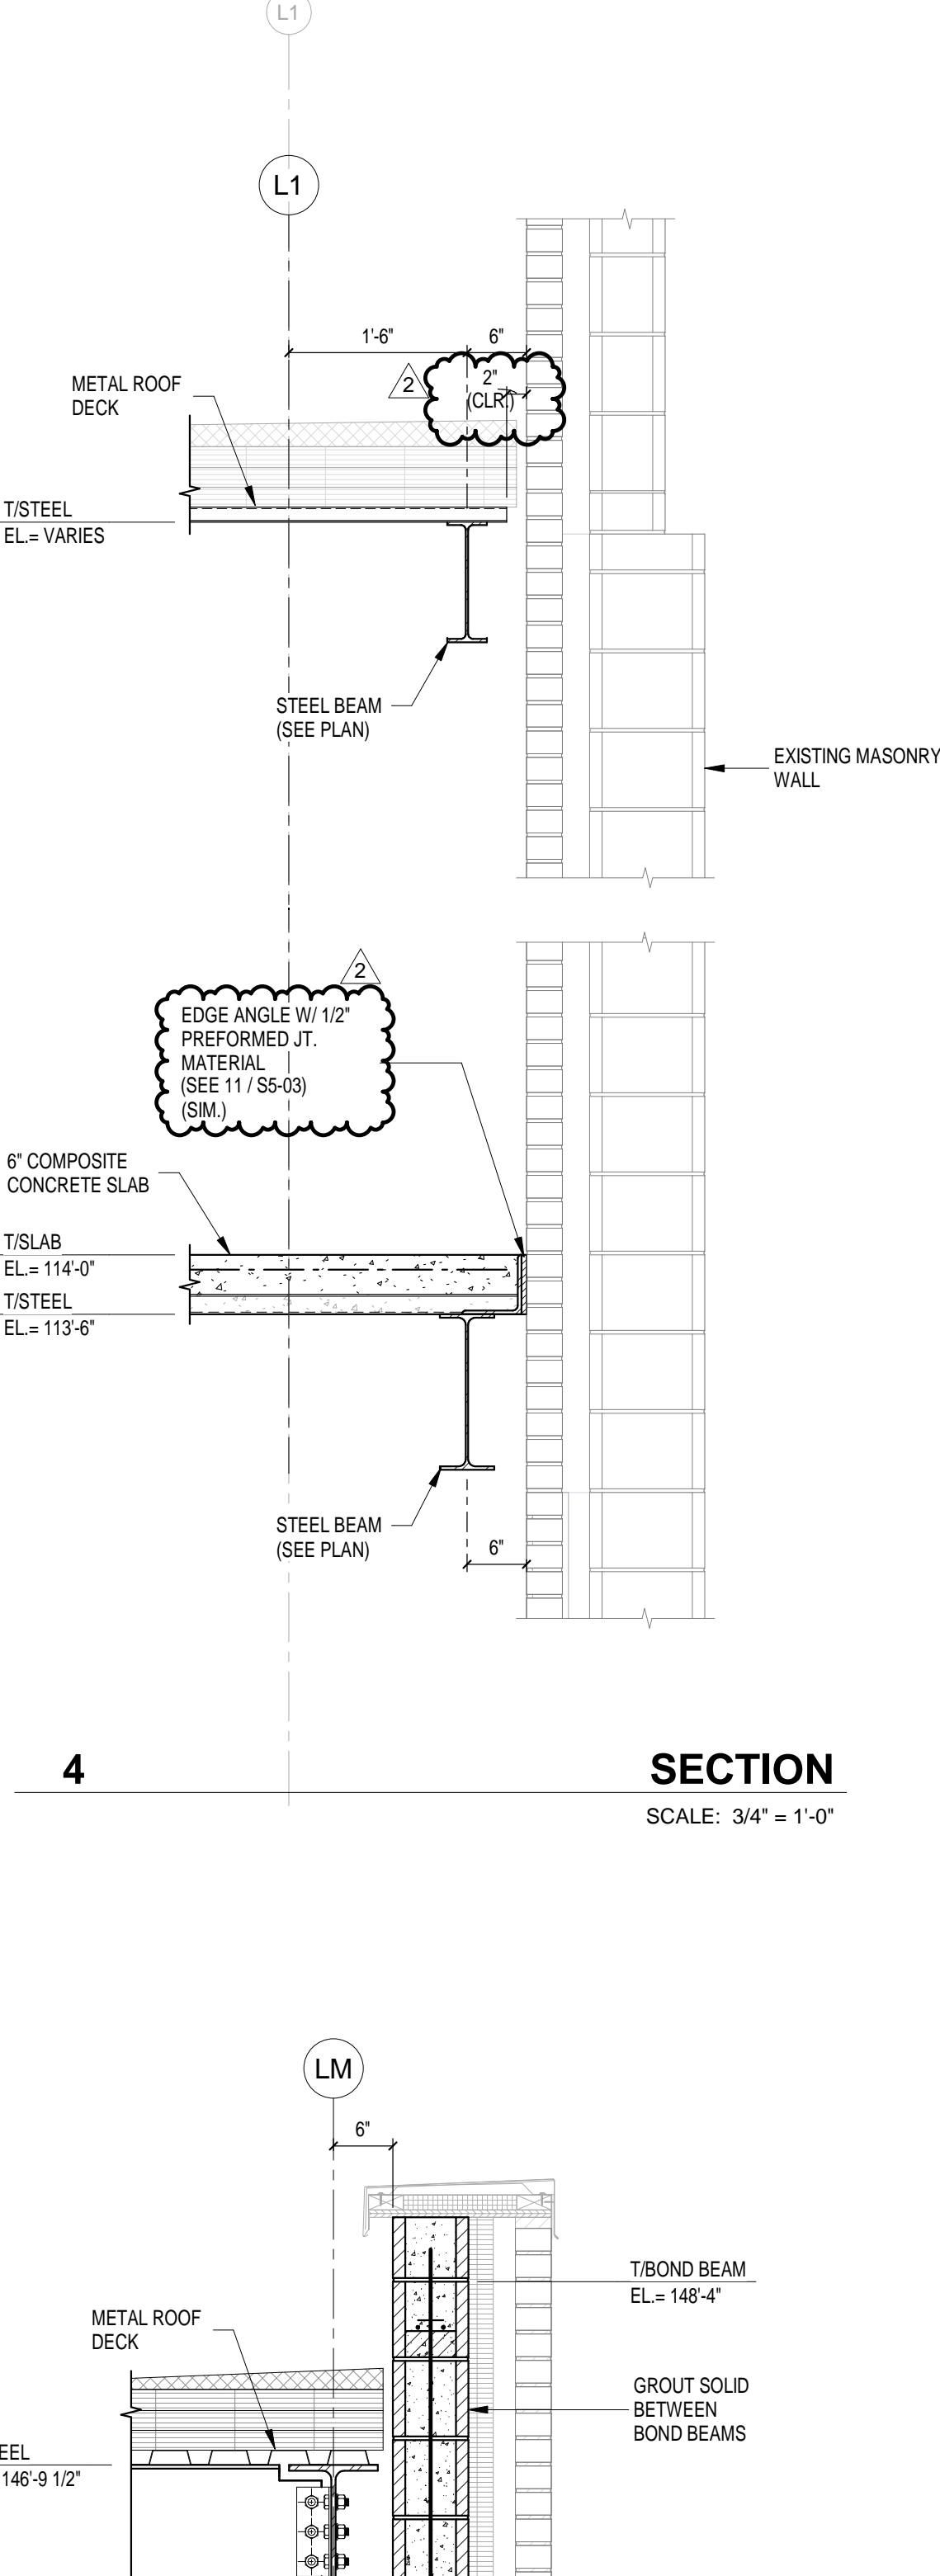
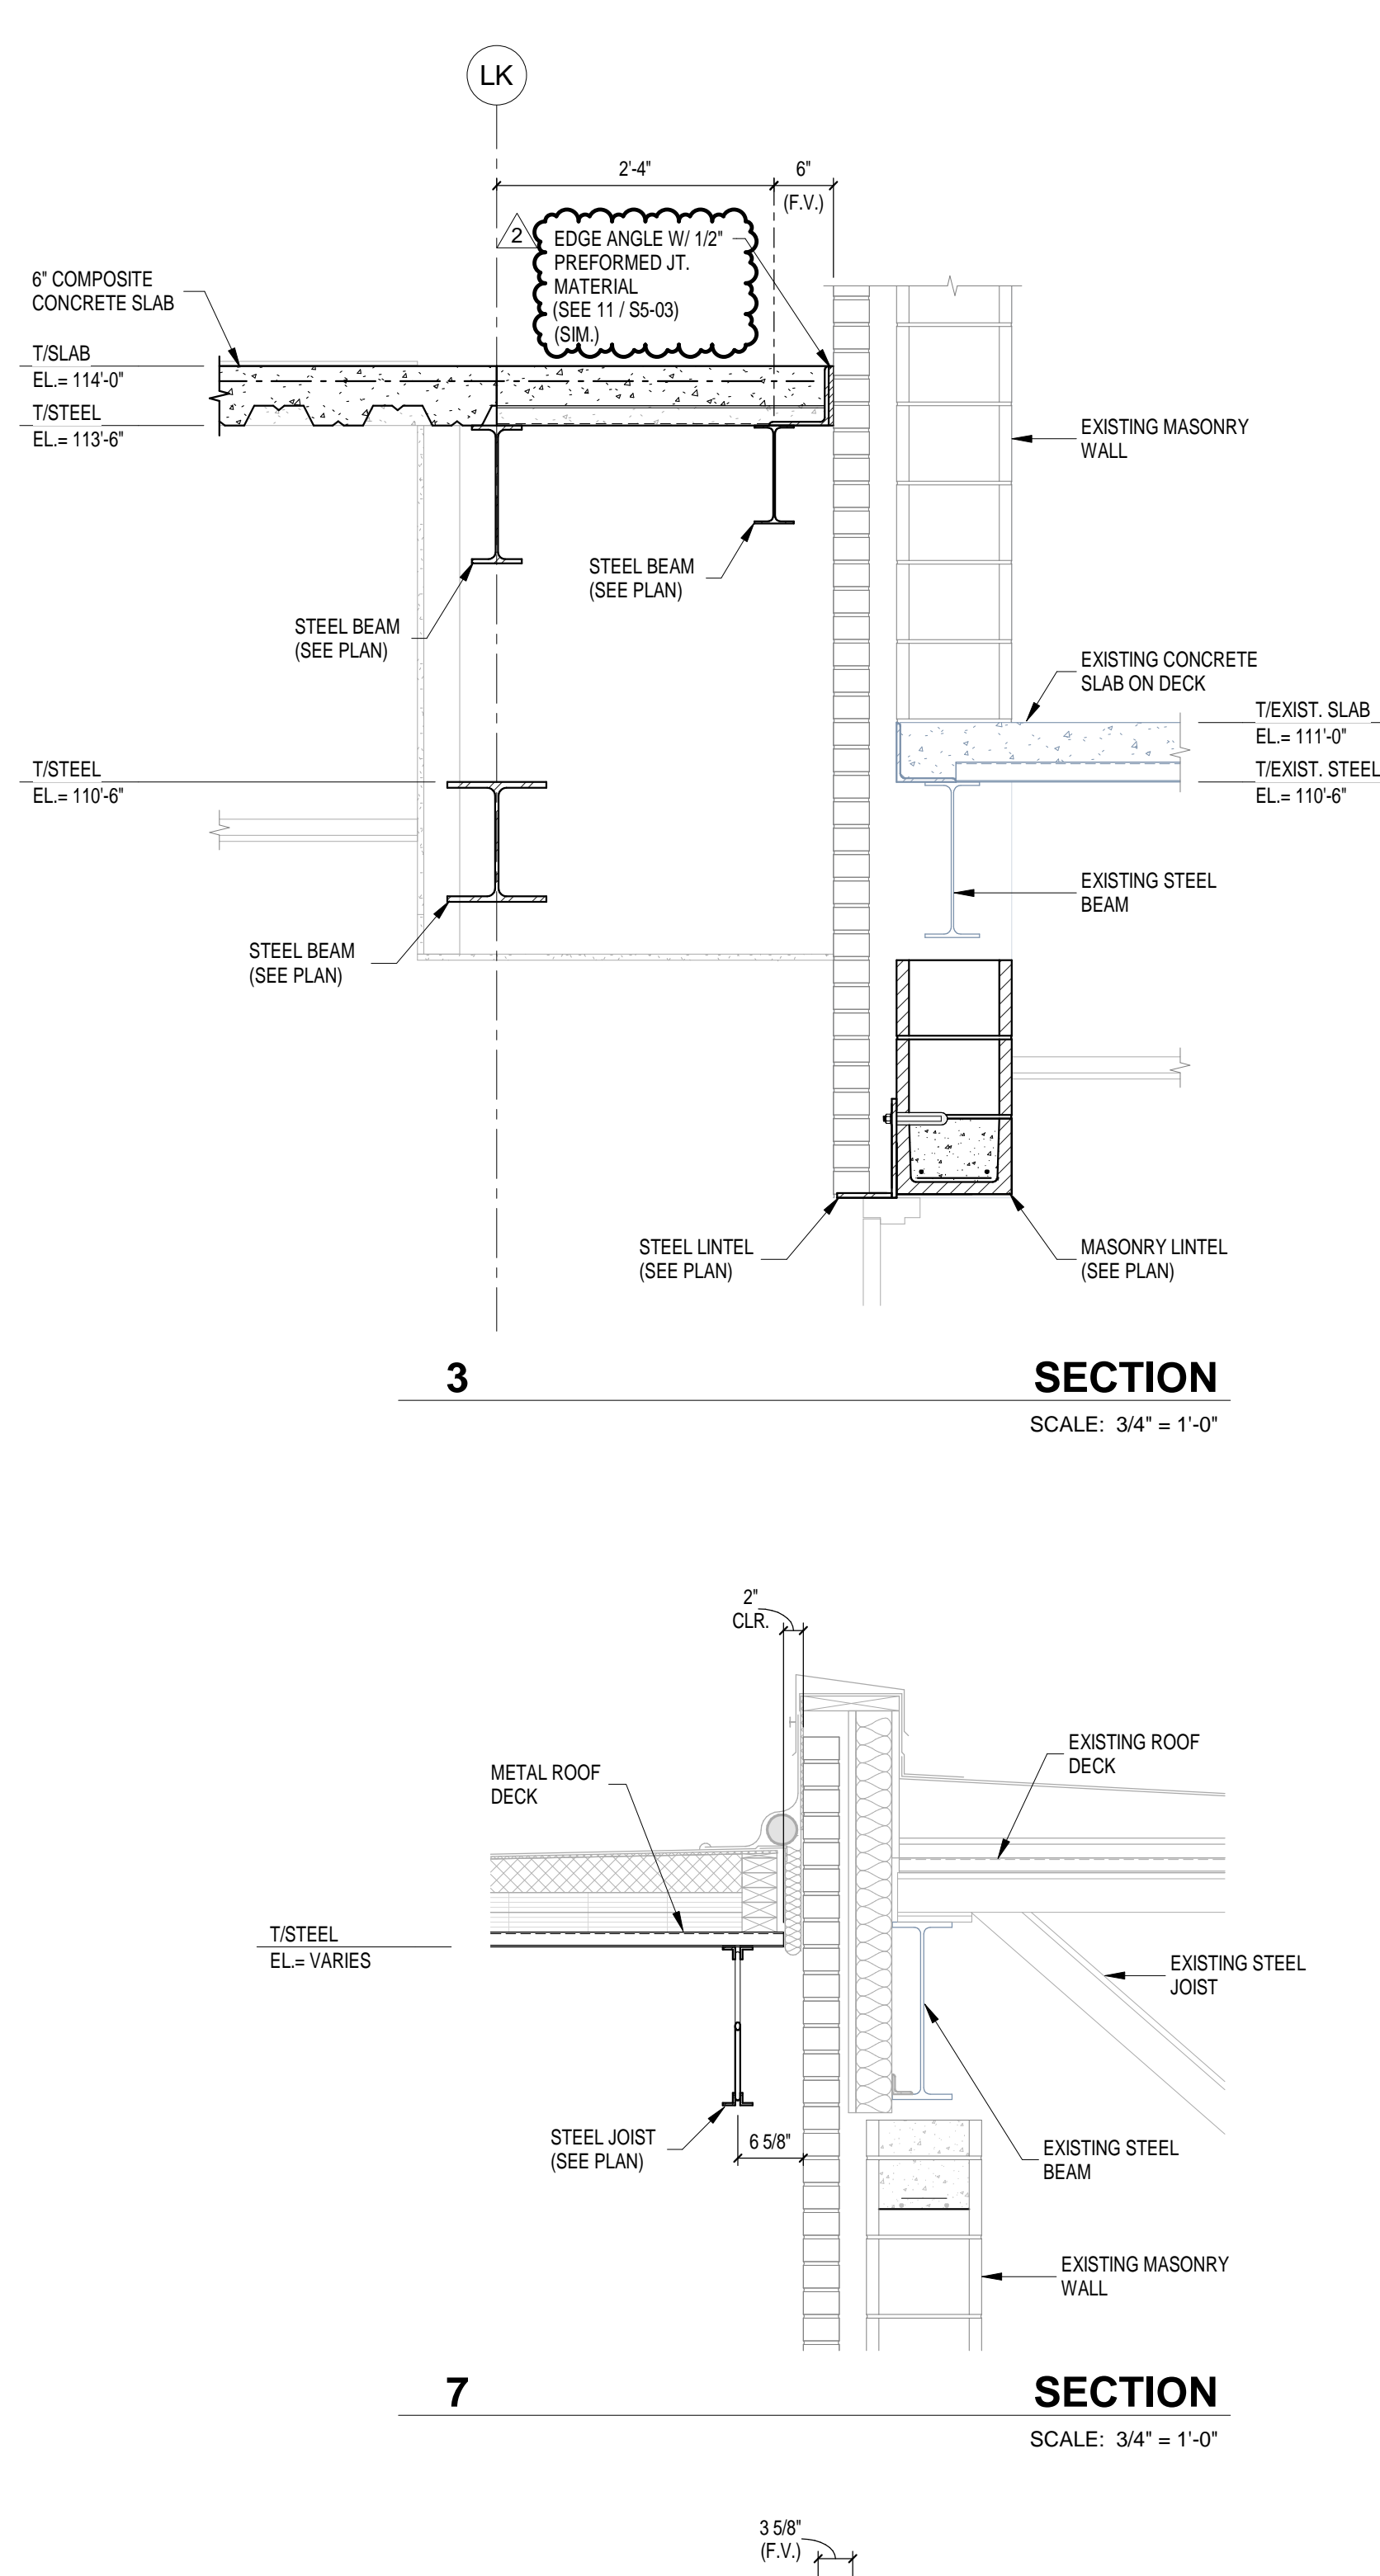
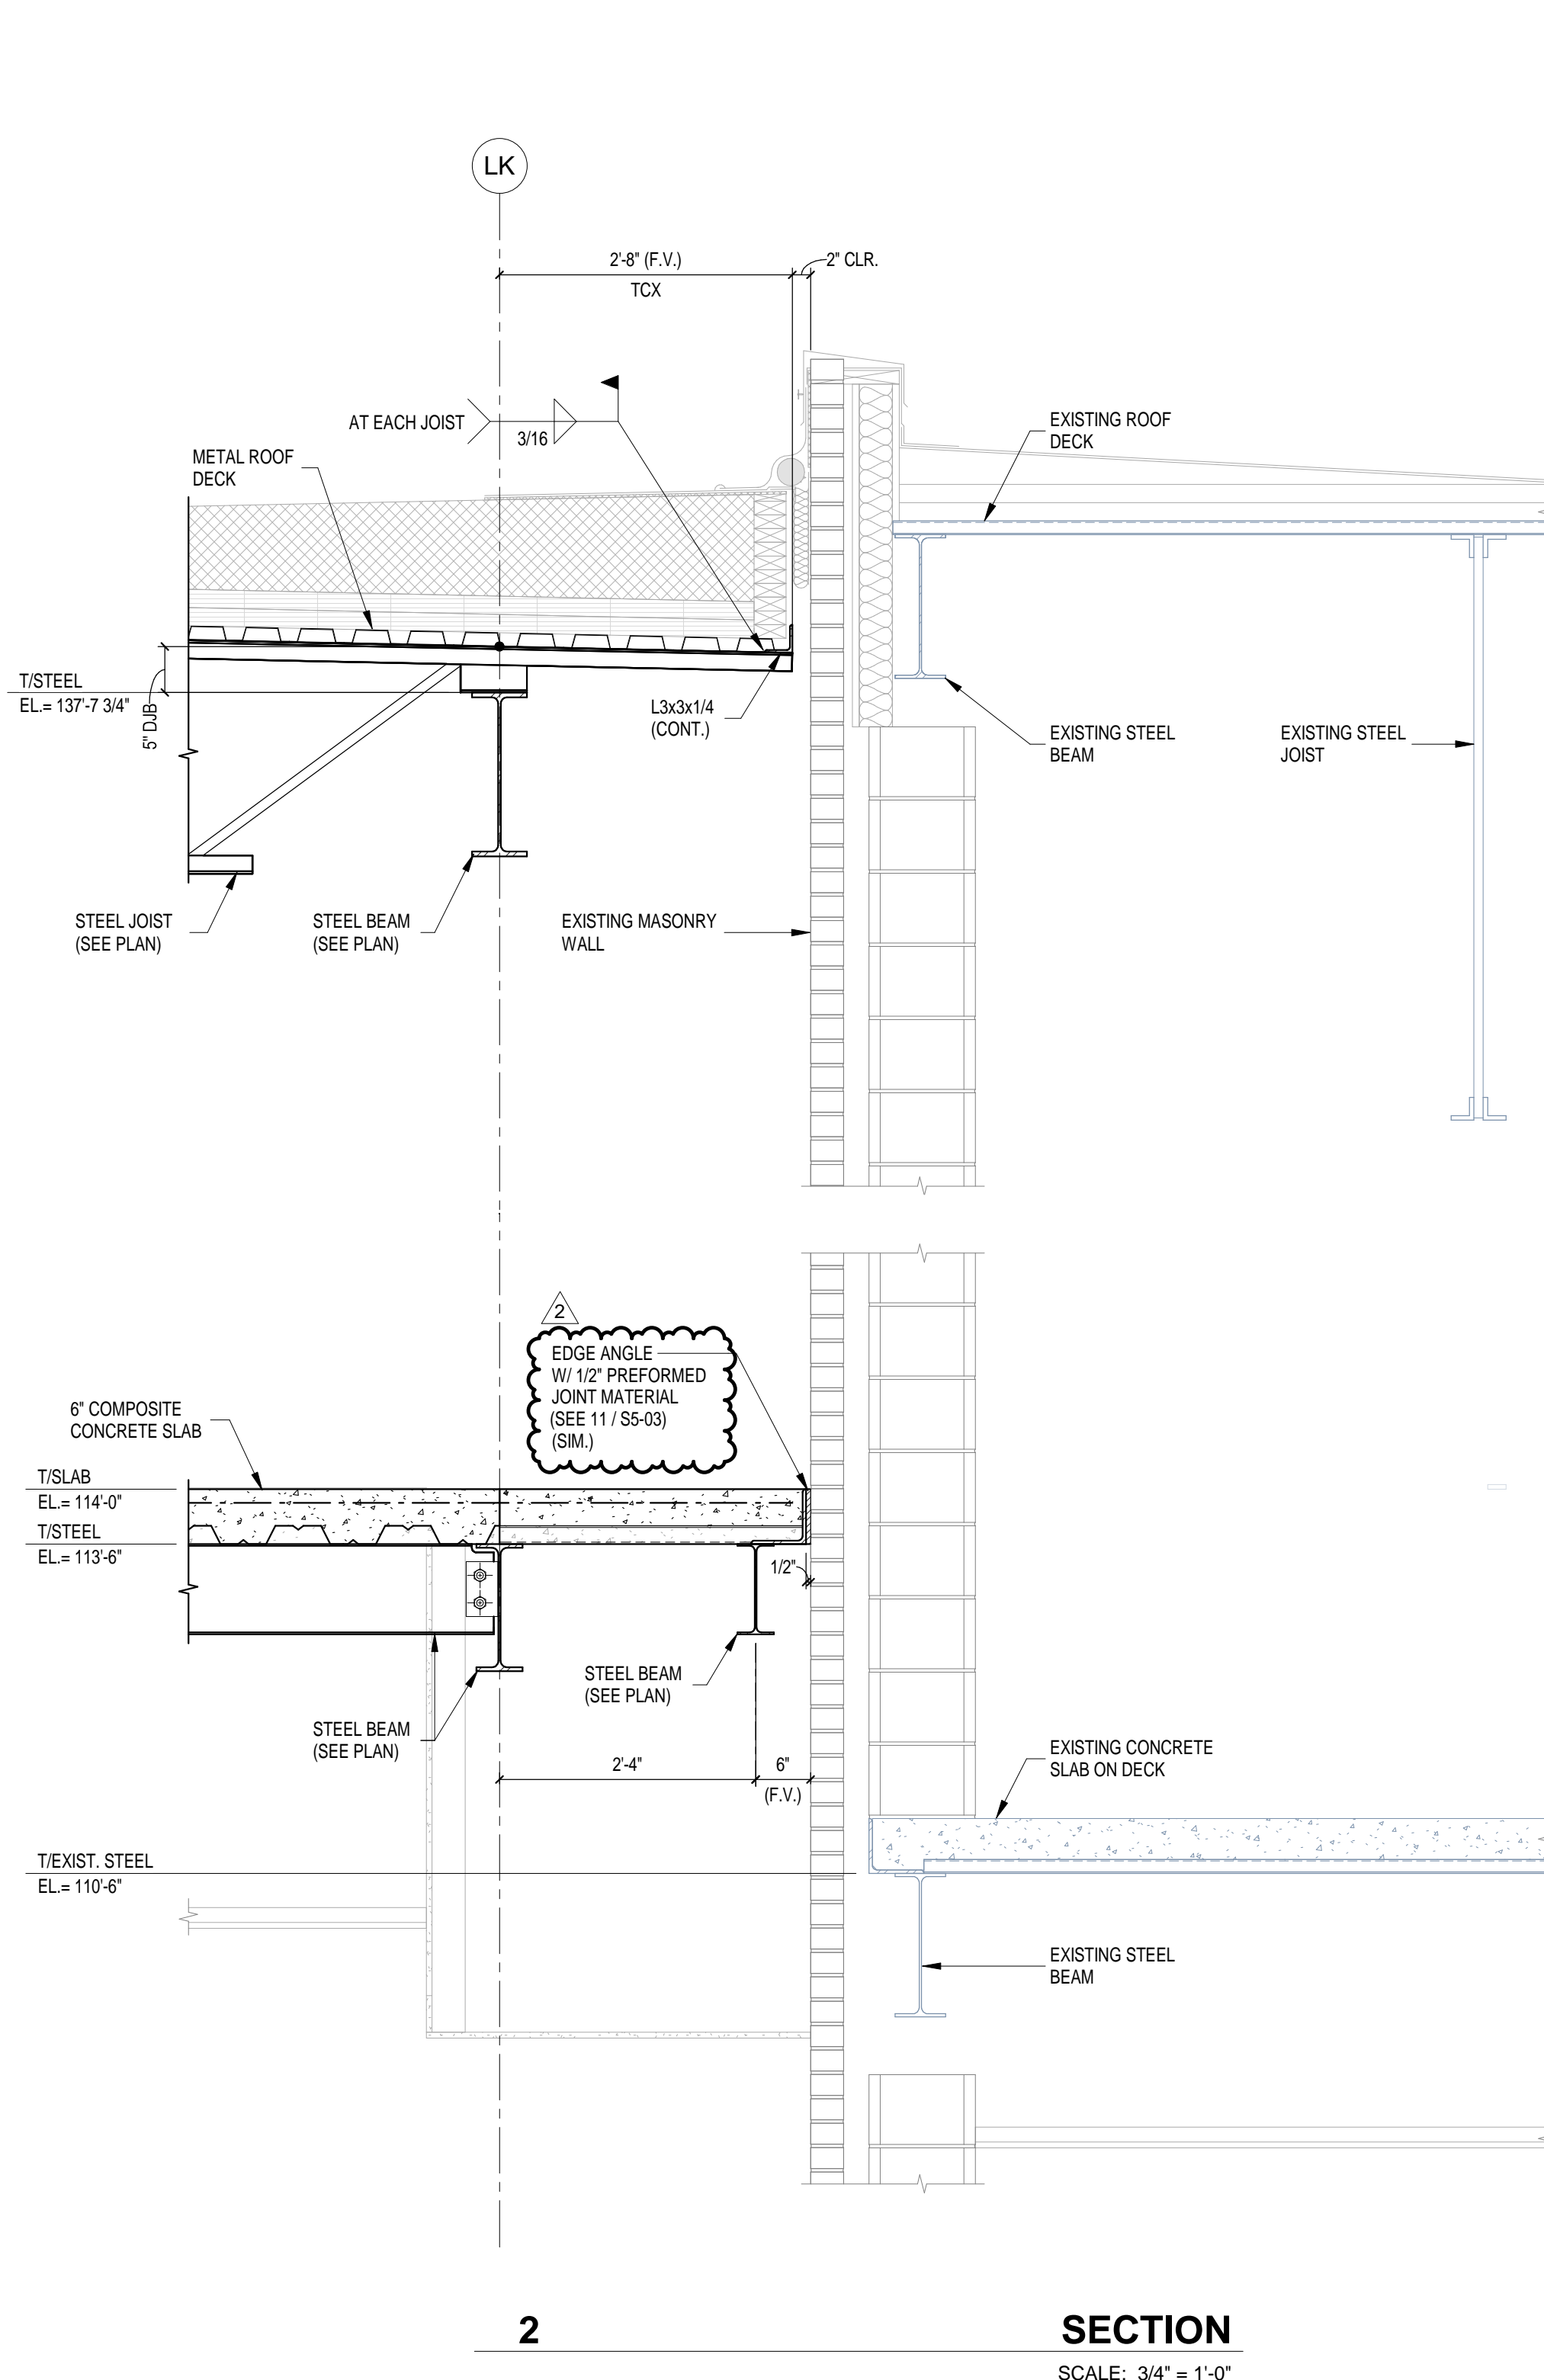
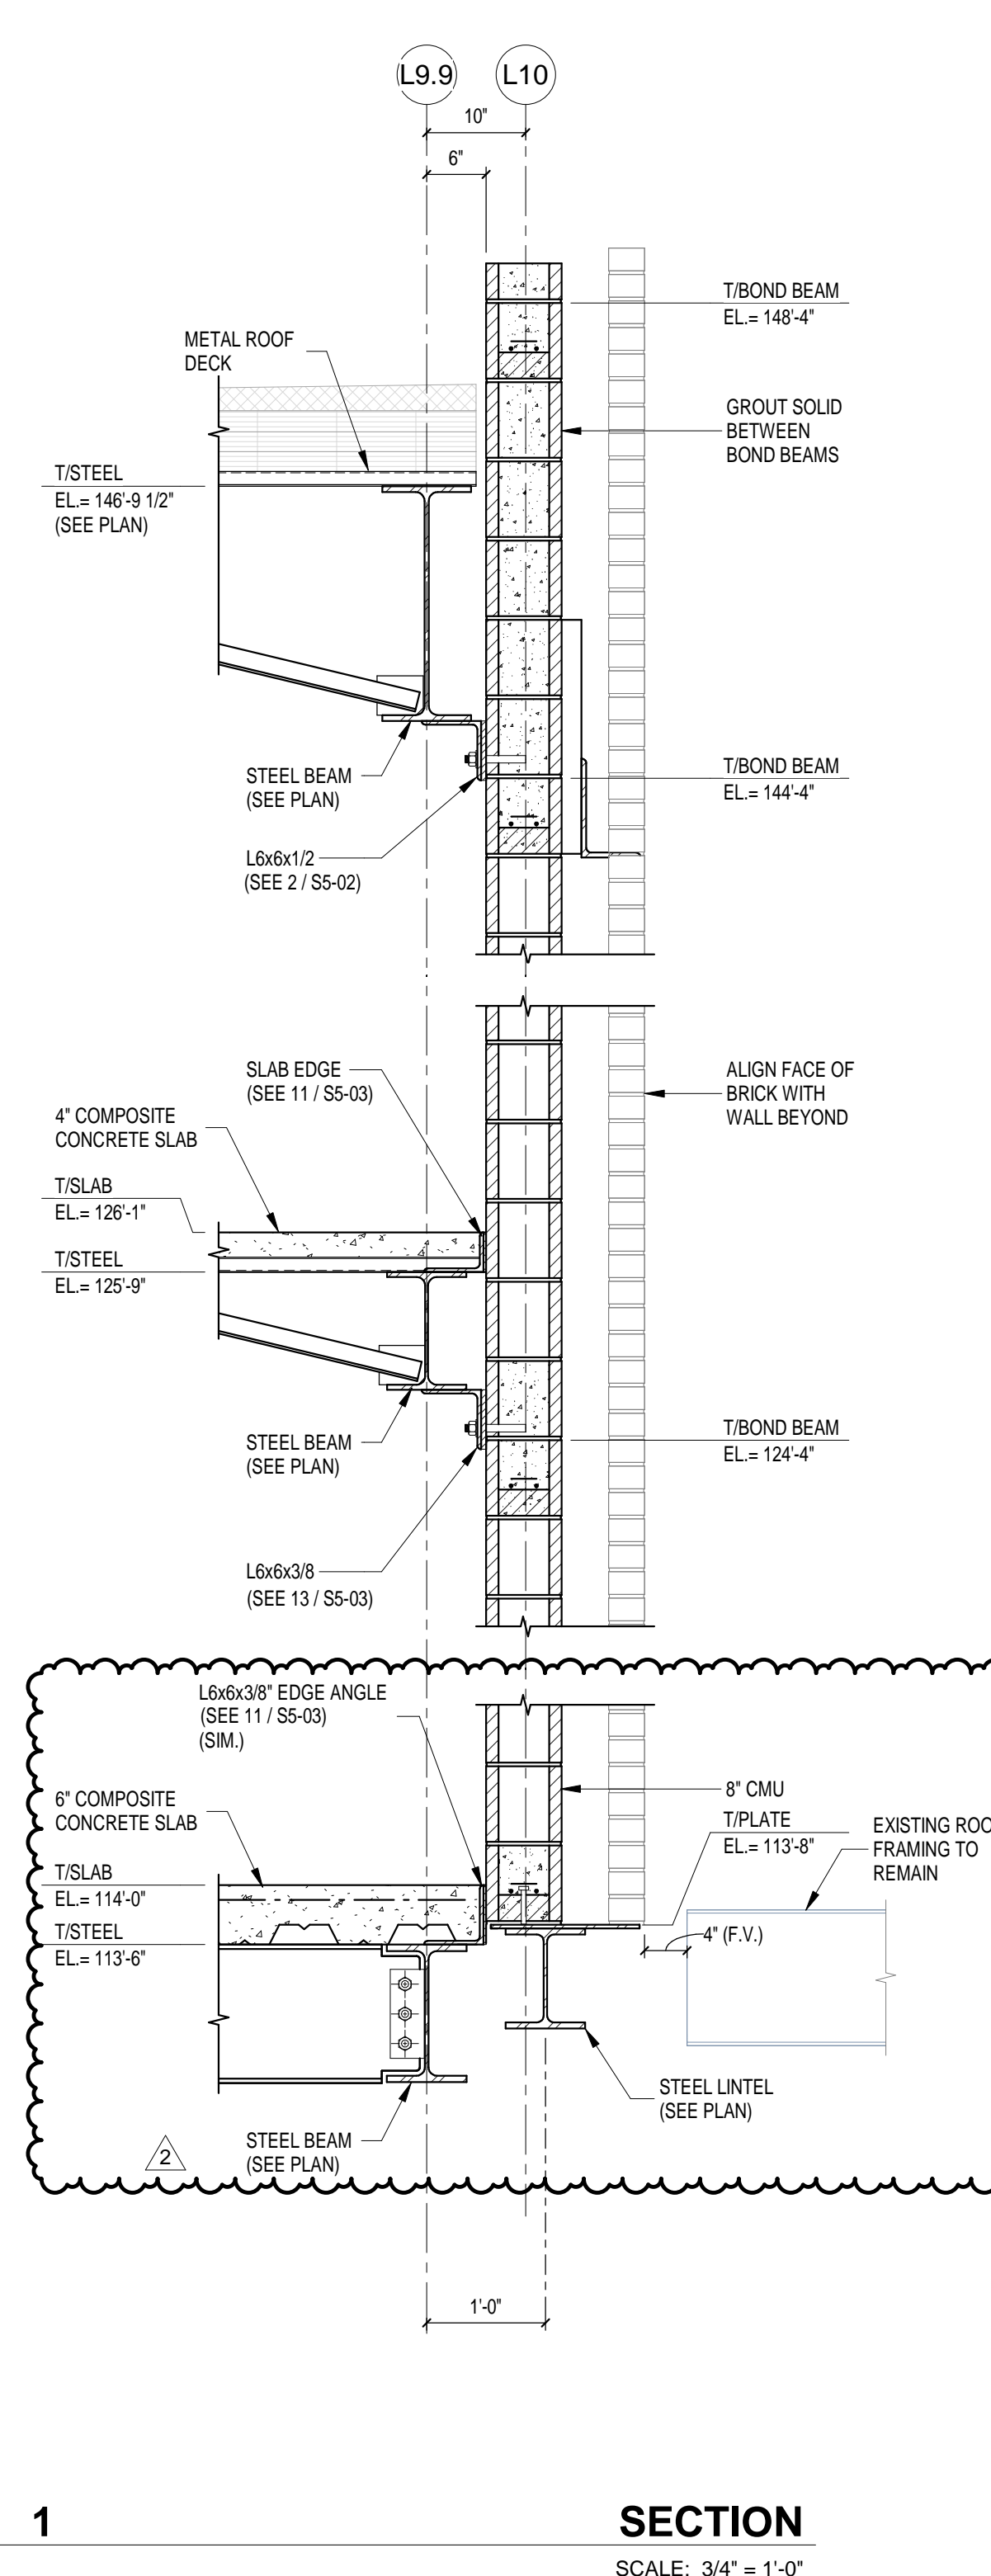


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SECTIONS AND DETAILS

S5-05



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COMMUNITY HIGH
SCHOOL ATHLETIC
LOCKERS
ADDITION AND
RENOVATION

1000 MULBERRY STREET,
ZIONSVILLE, IN 46077

ZIONSVILLE COMMUNITY
SCHOOLS



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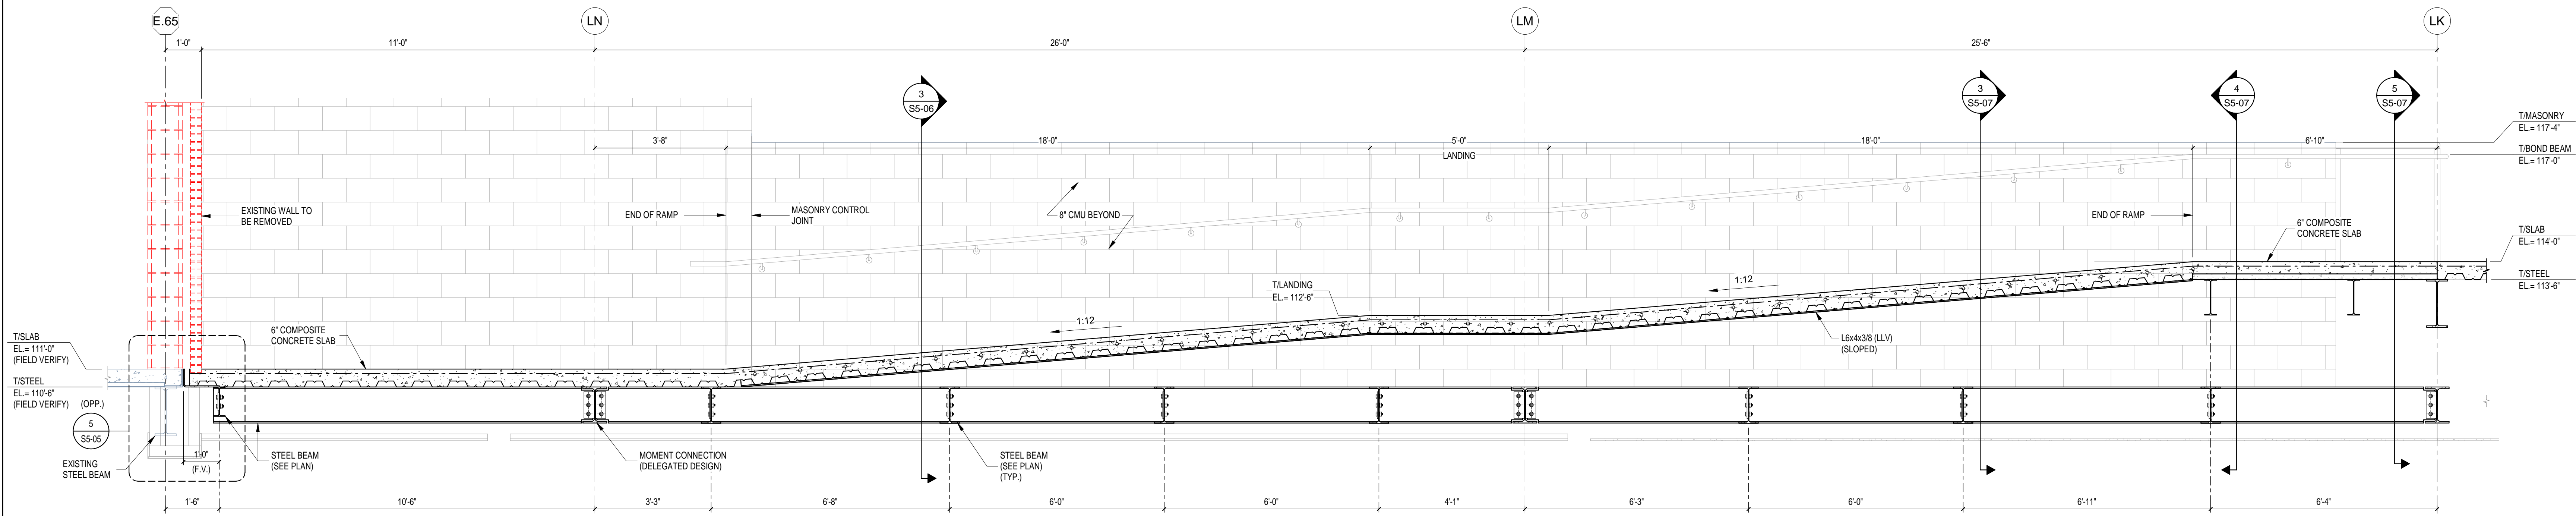


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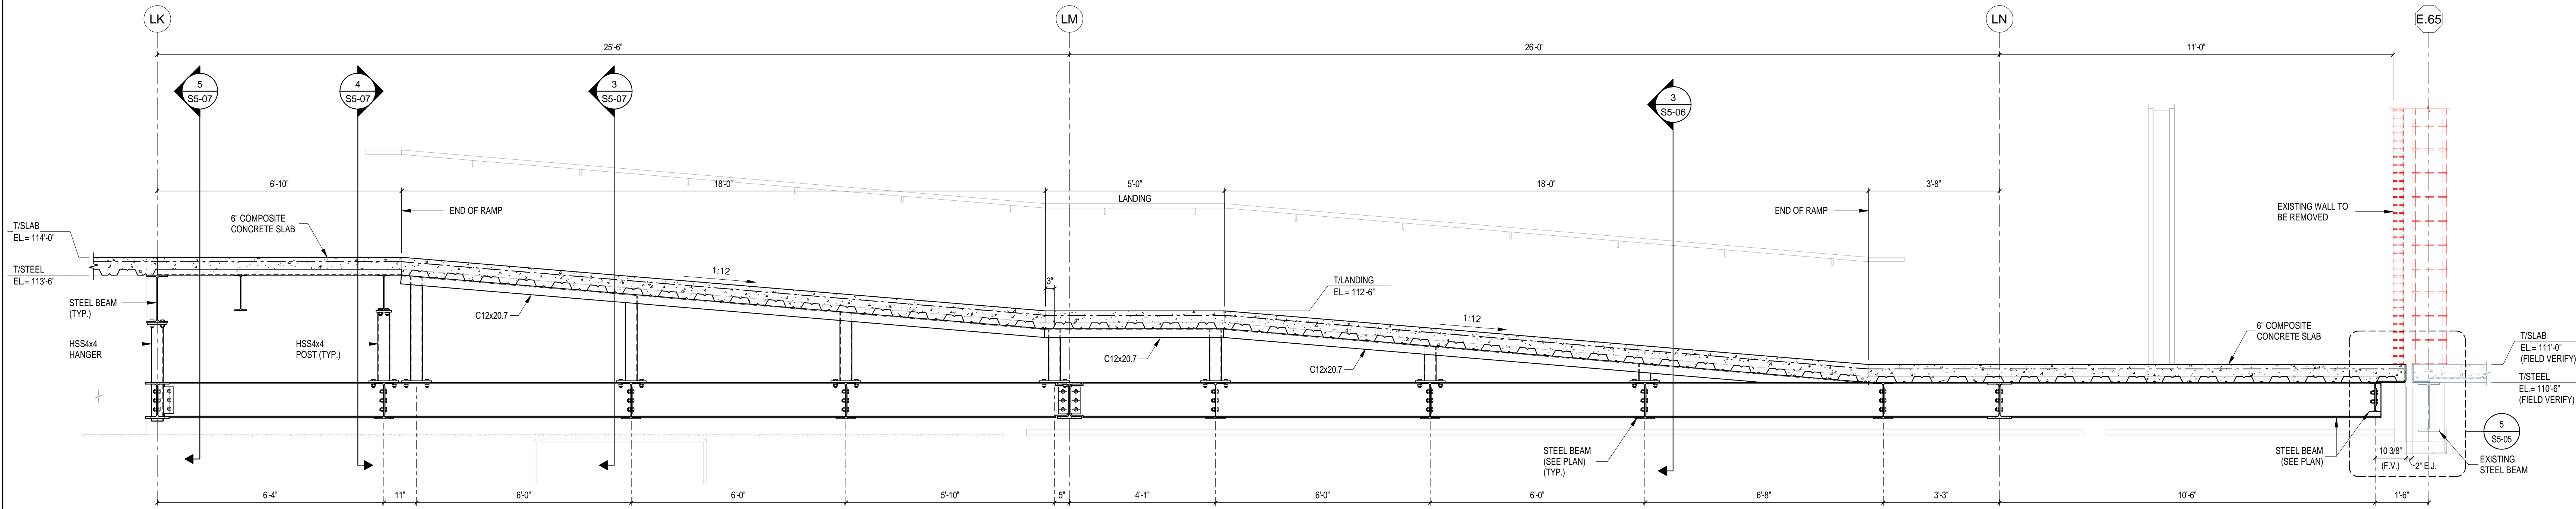
REV. NO.	DESCRIPTION	DATE
2	ADDENDUM #2	02-18-2025

SECTIONS AND DETAILS


S5-06



1 SECTION
SCALE: 1/2\"/>



2 SECTION
SCALE: 1/2\"/>

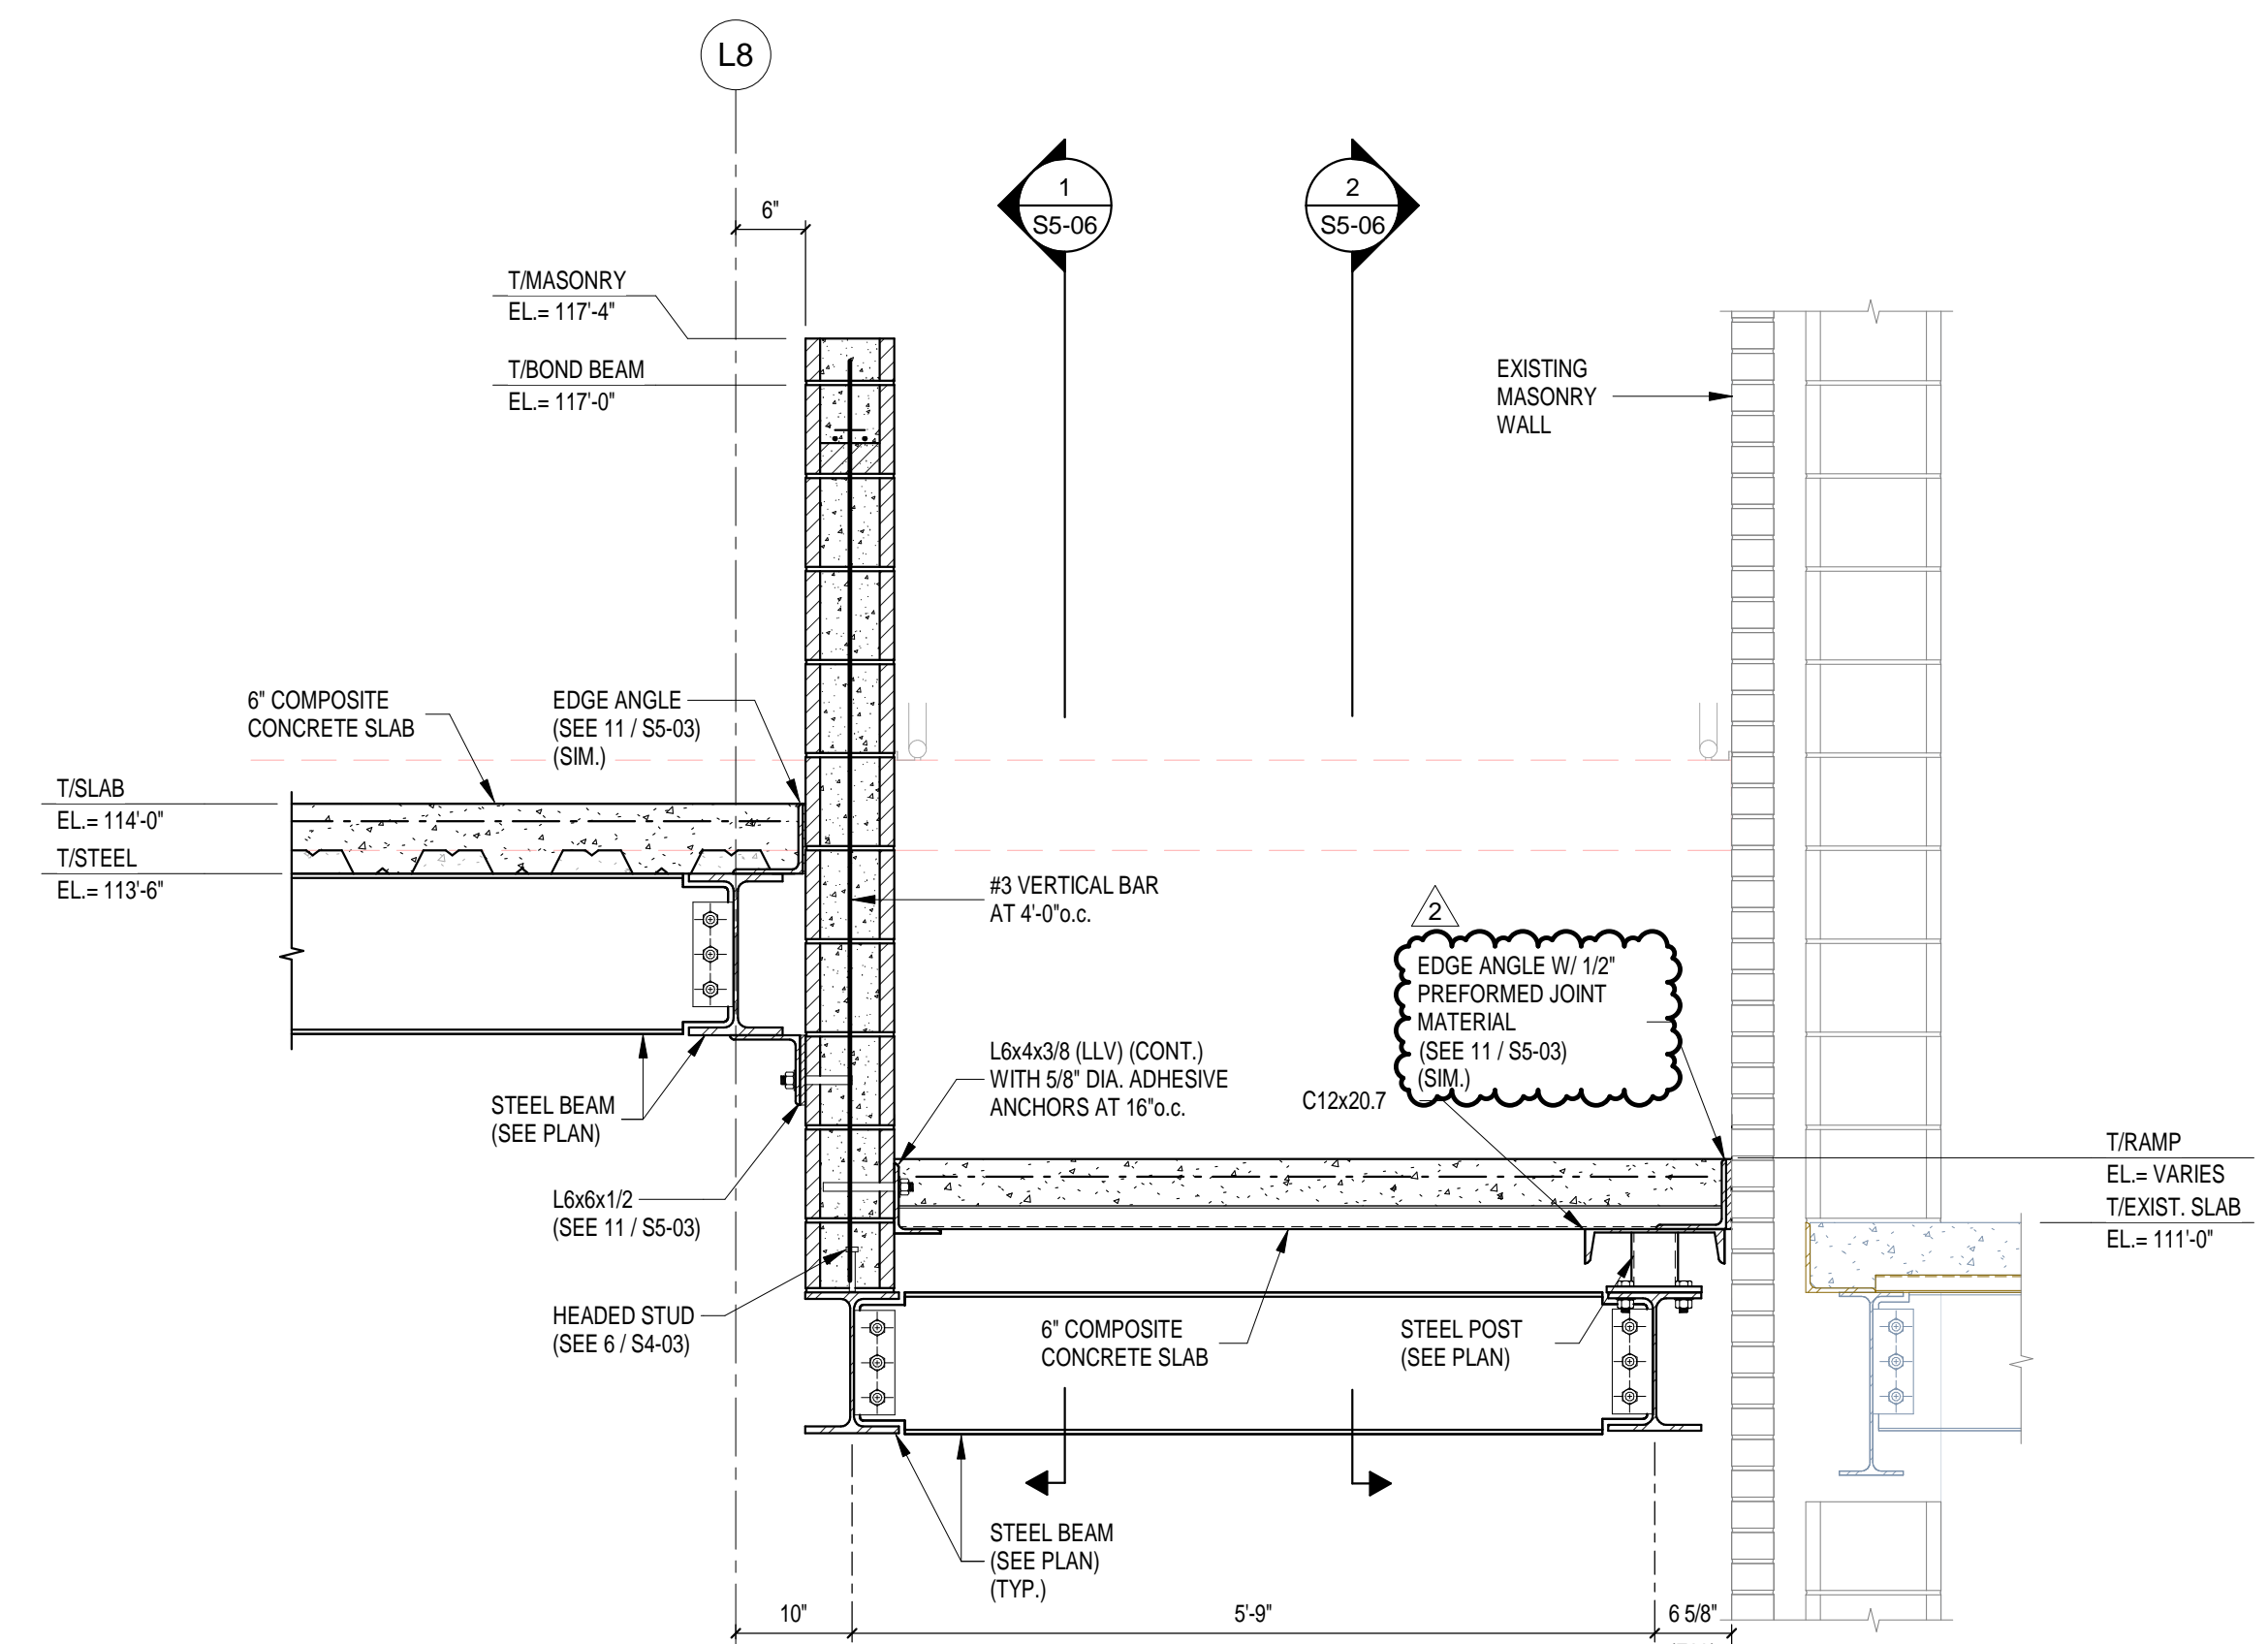

3 SECTION
SCALE: 3/4\"/>

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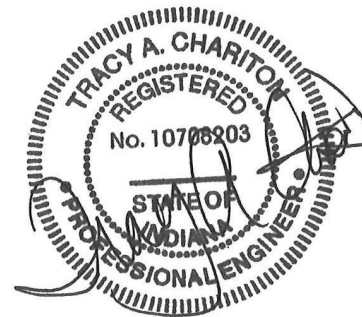
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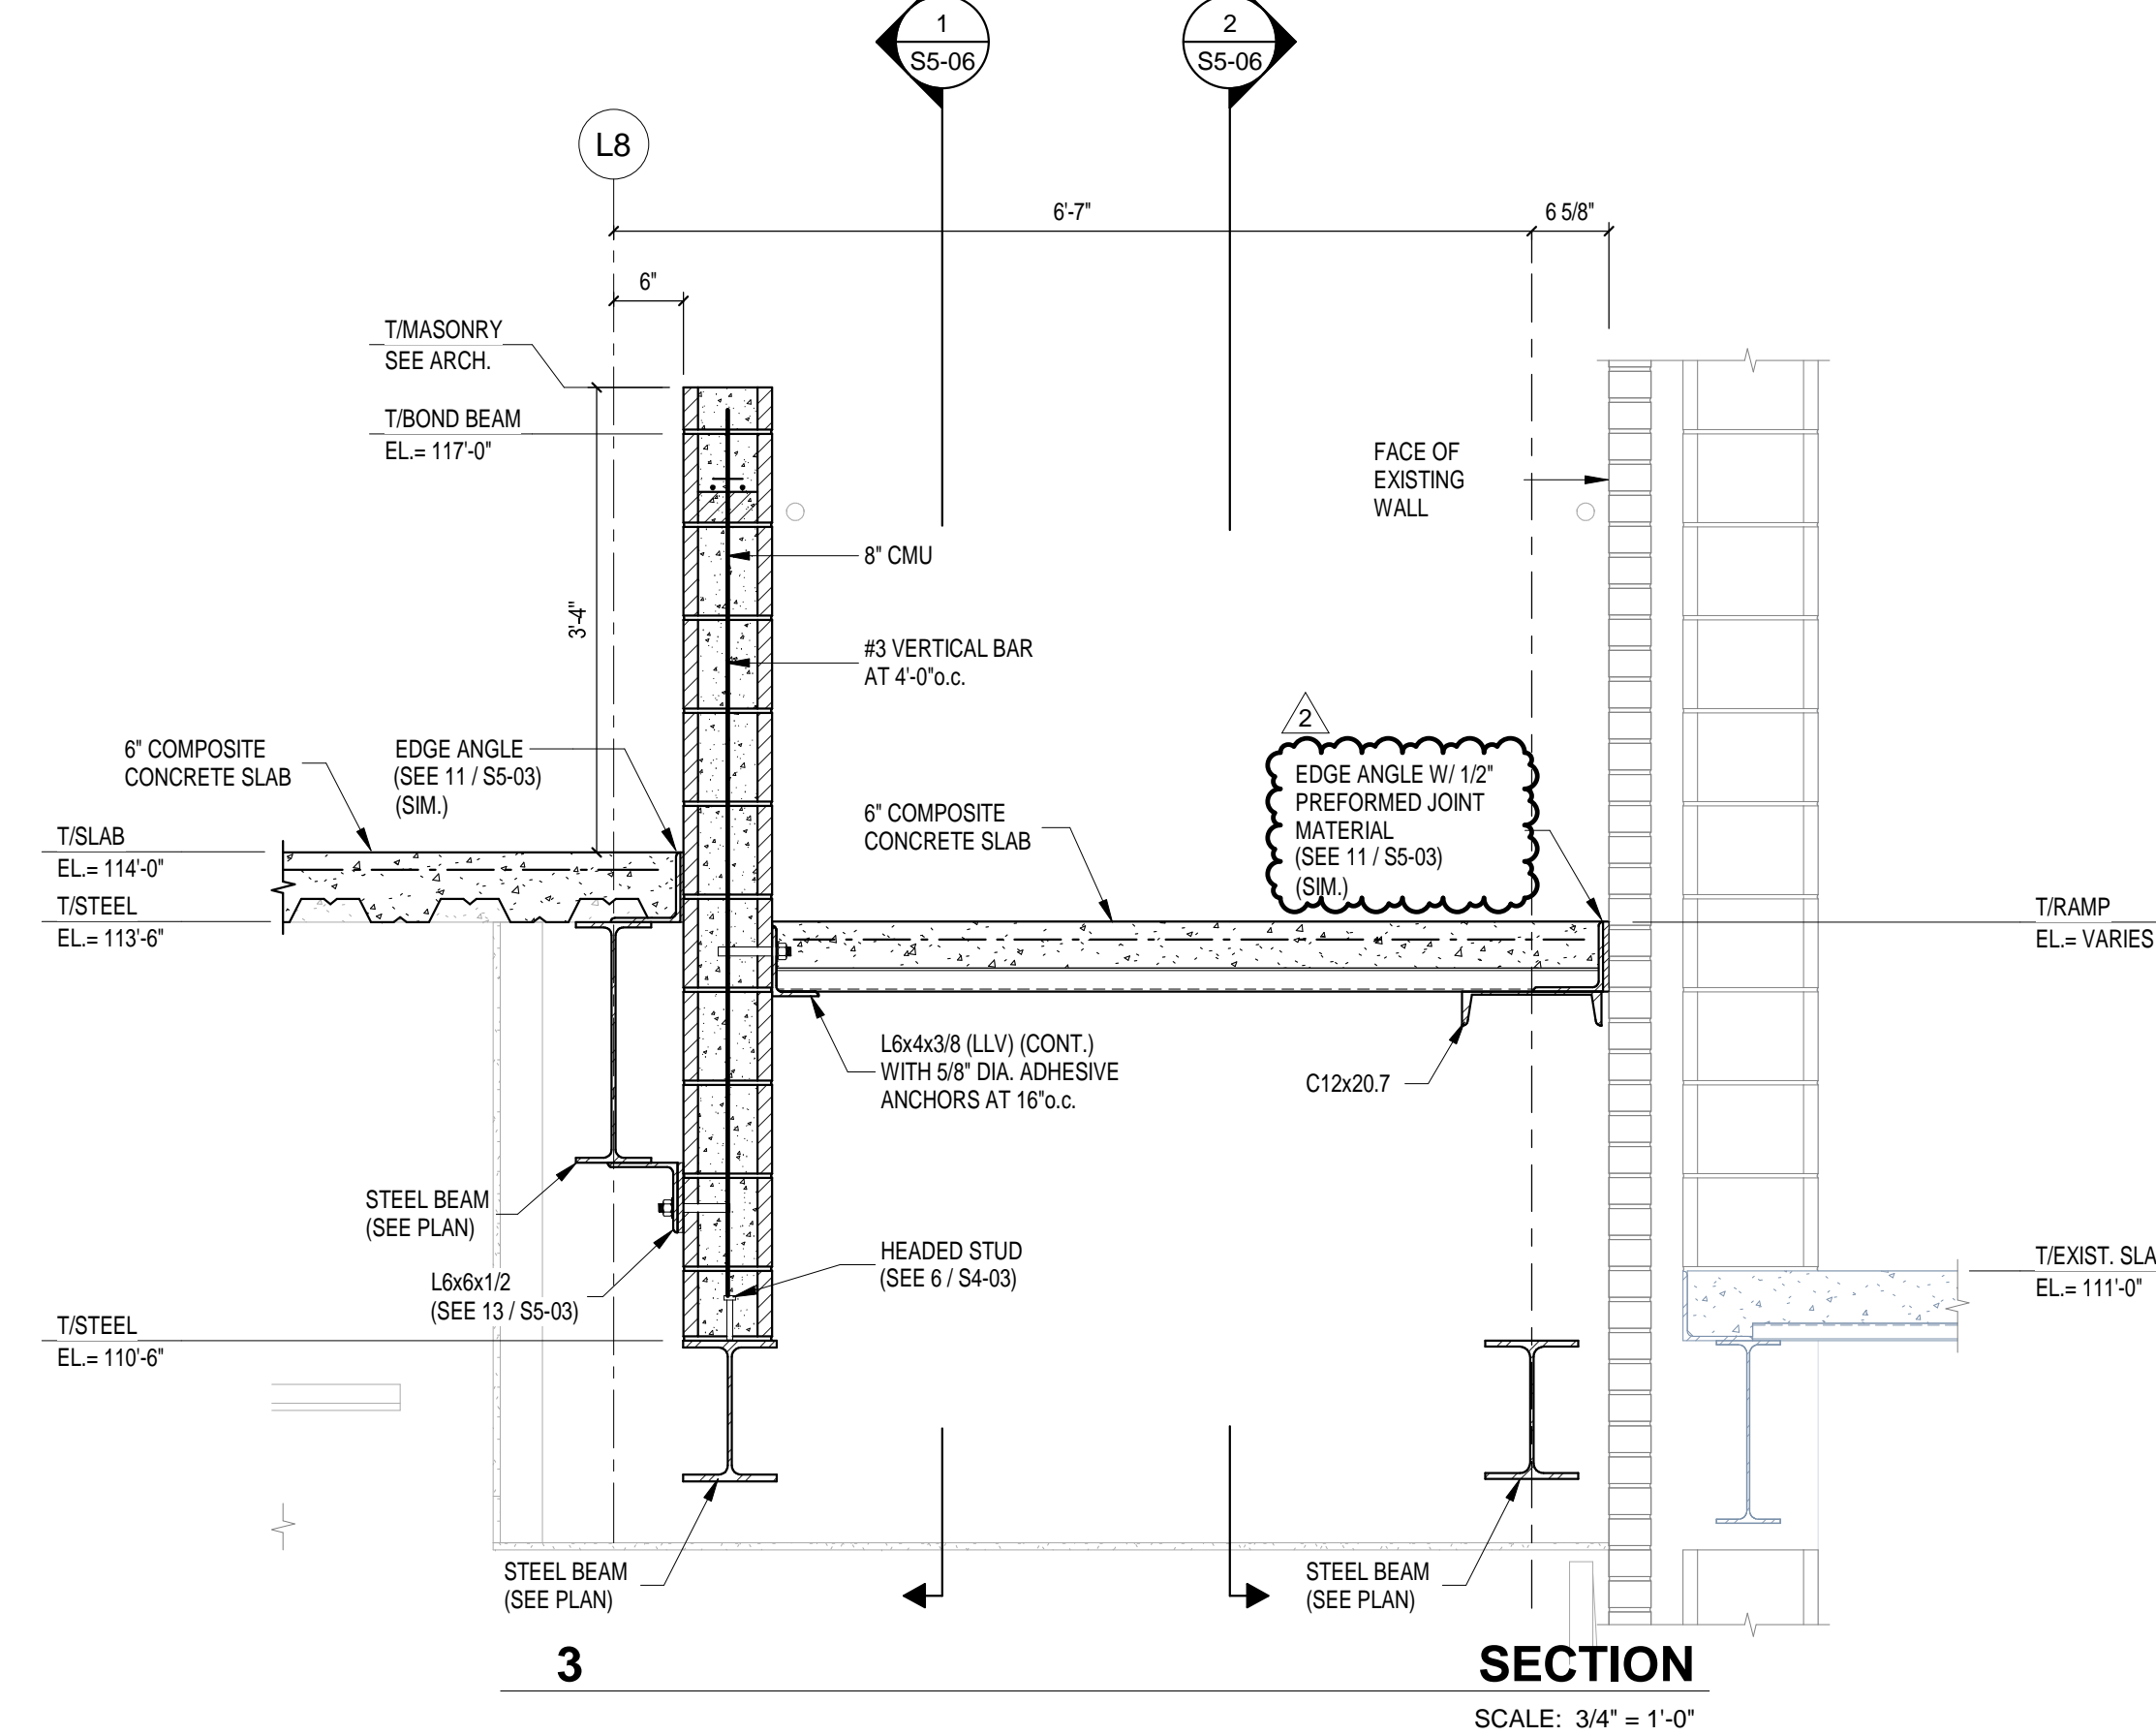
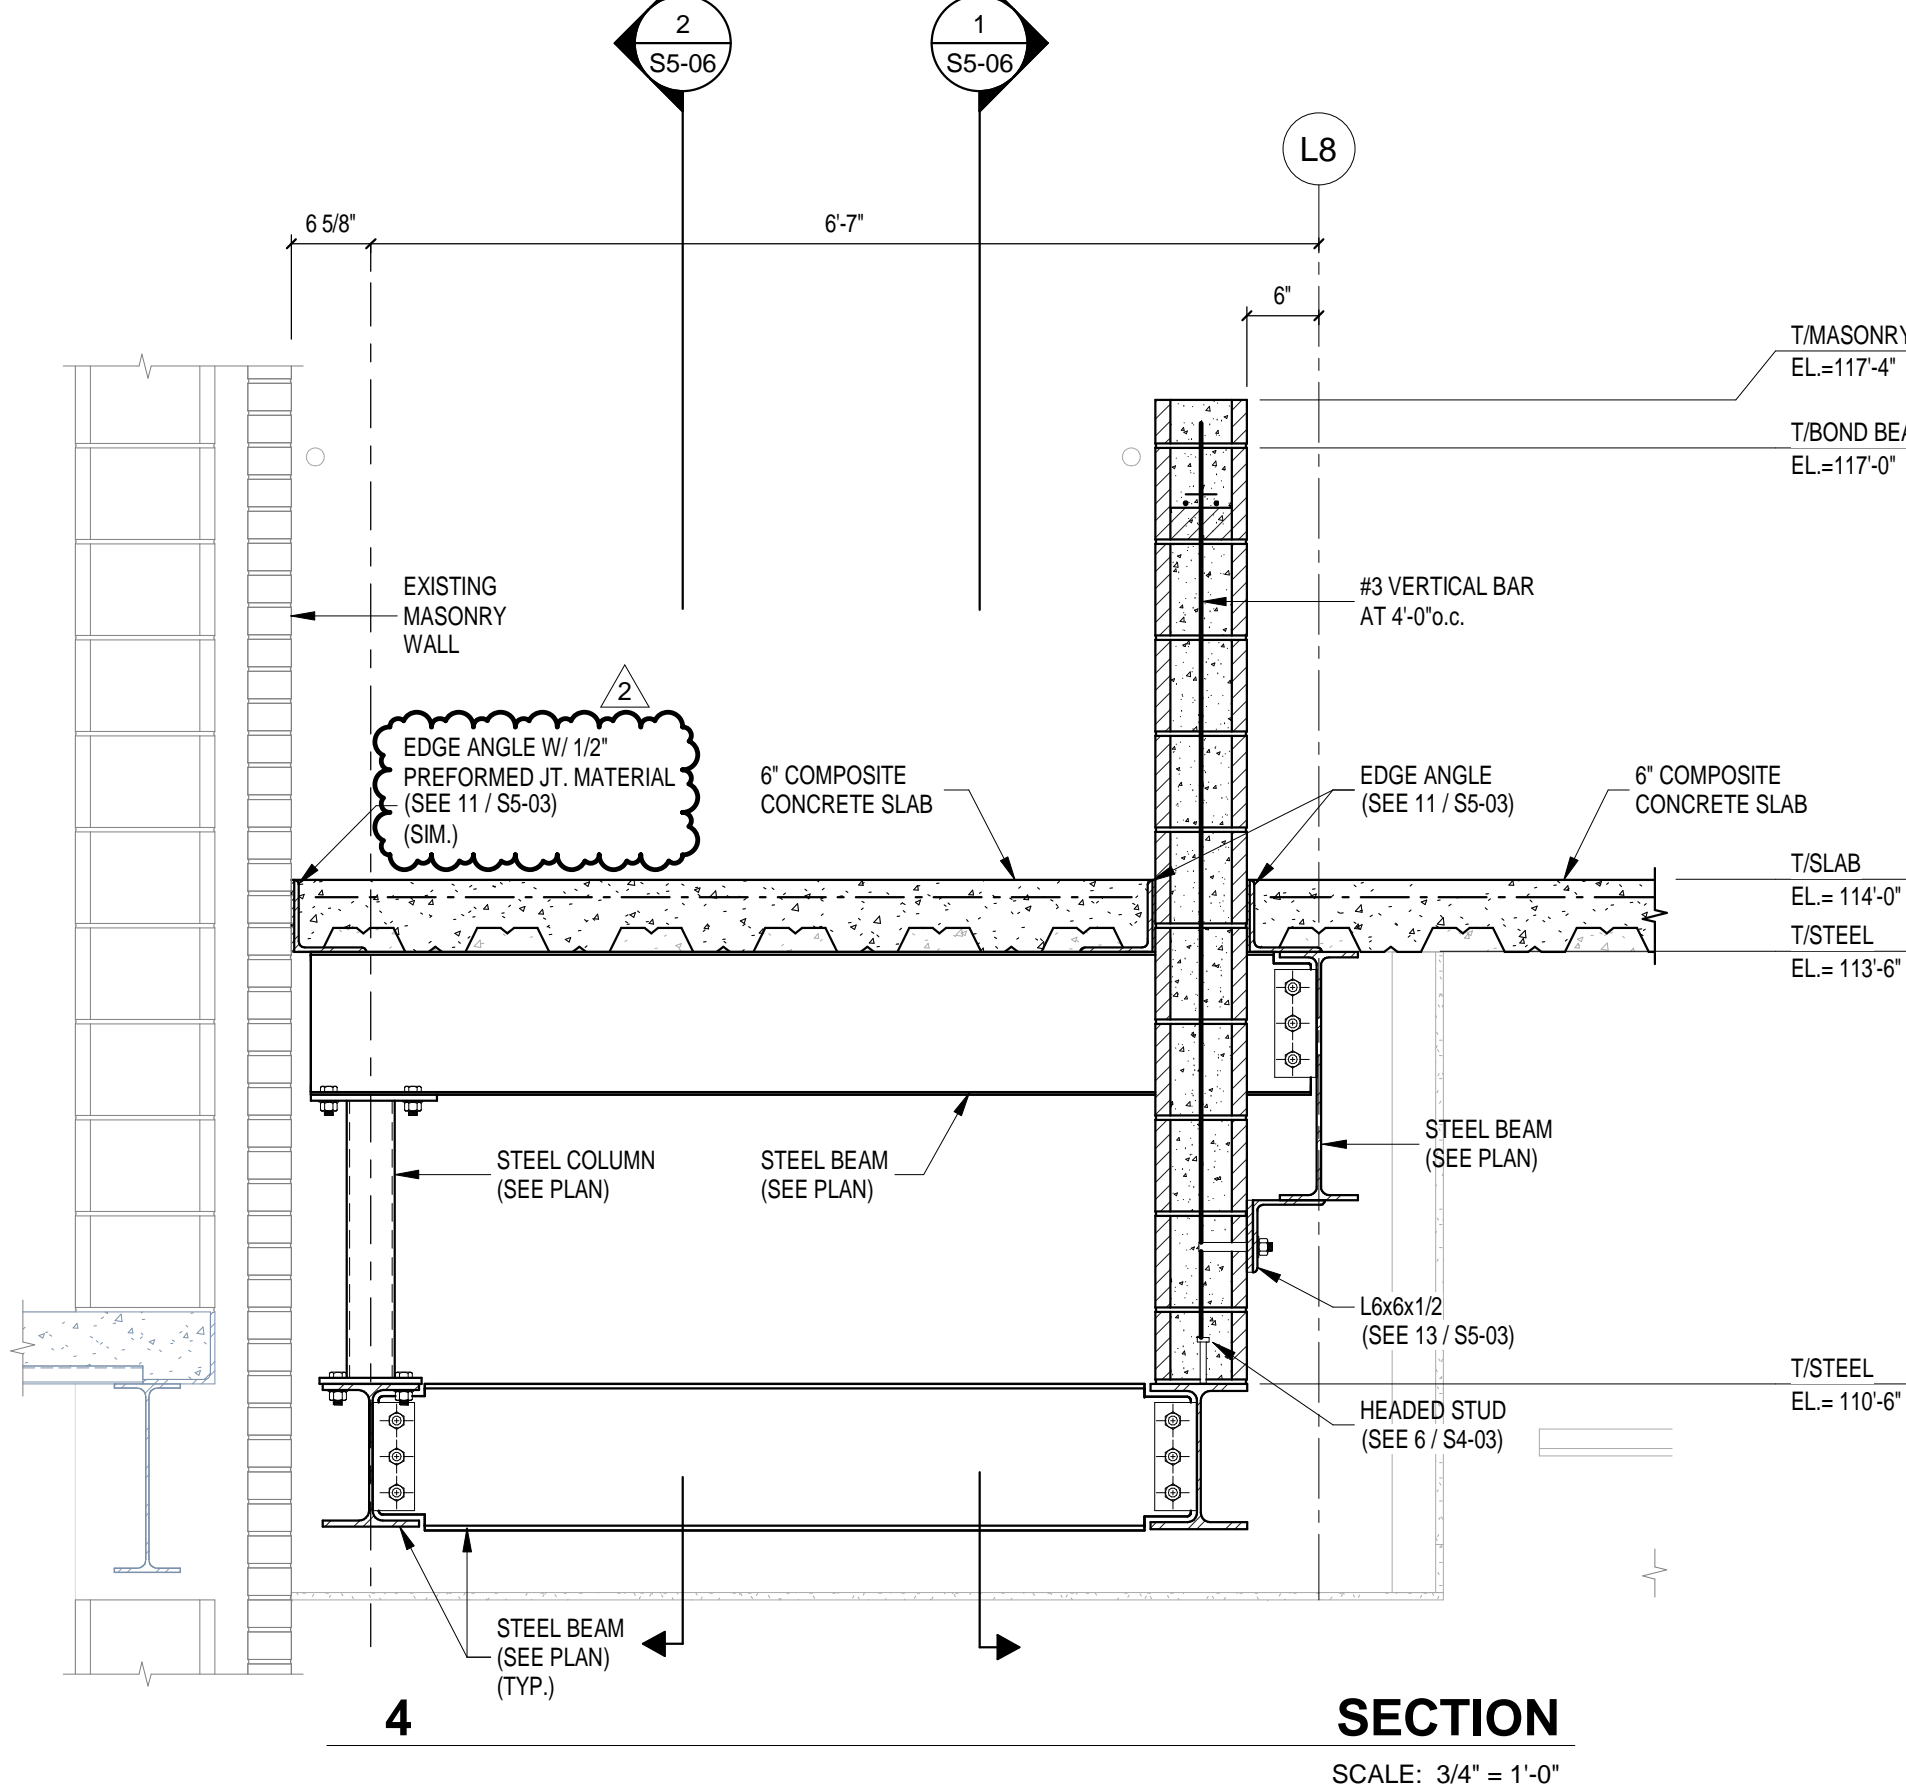
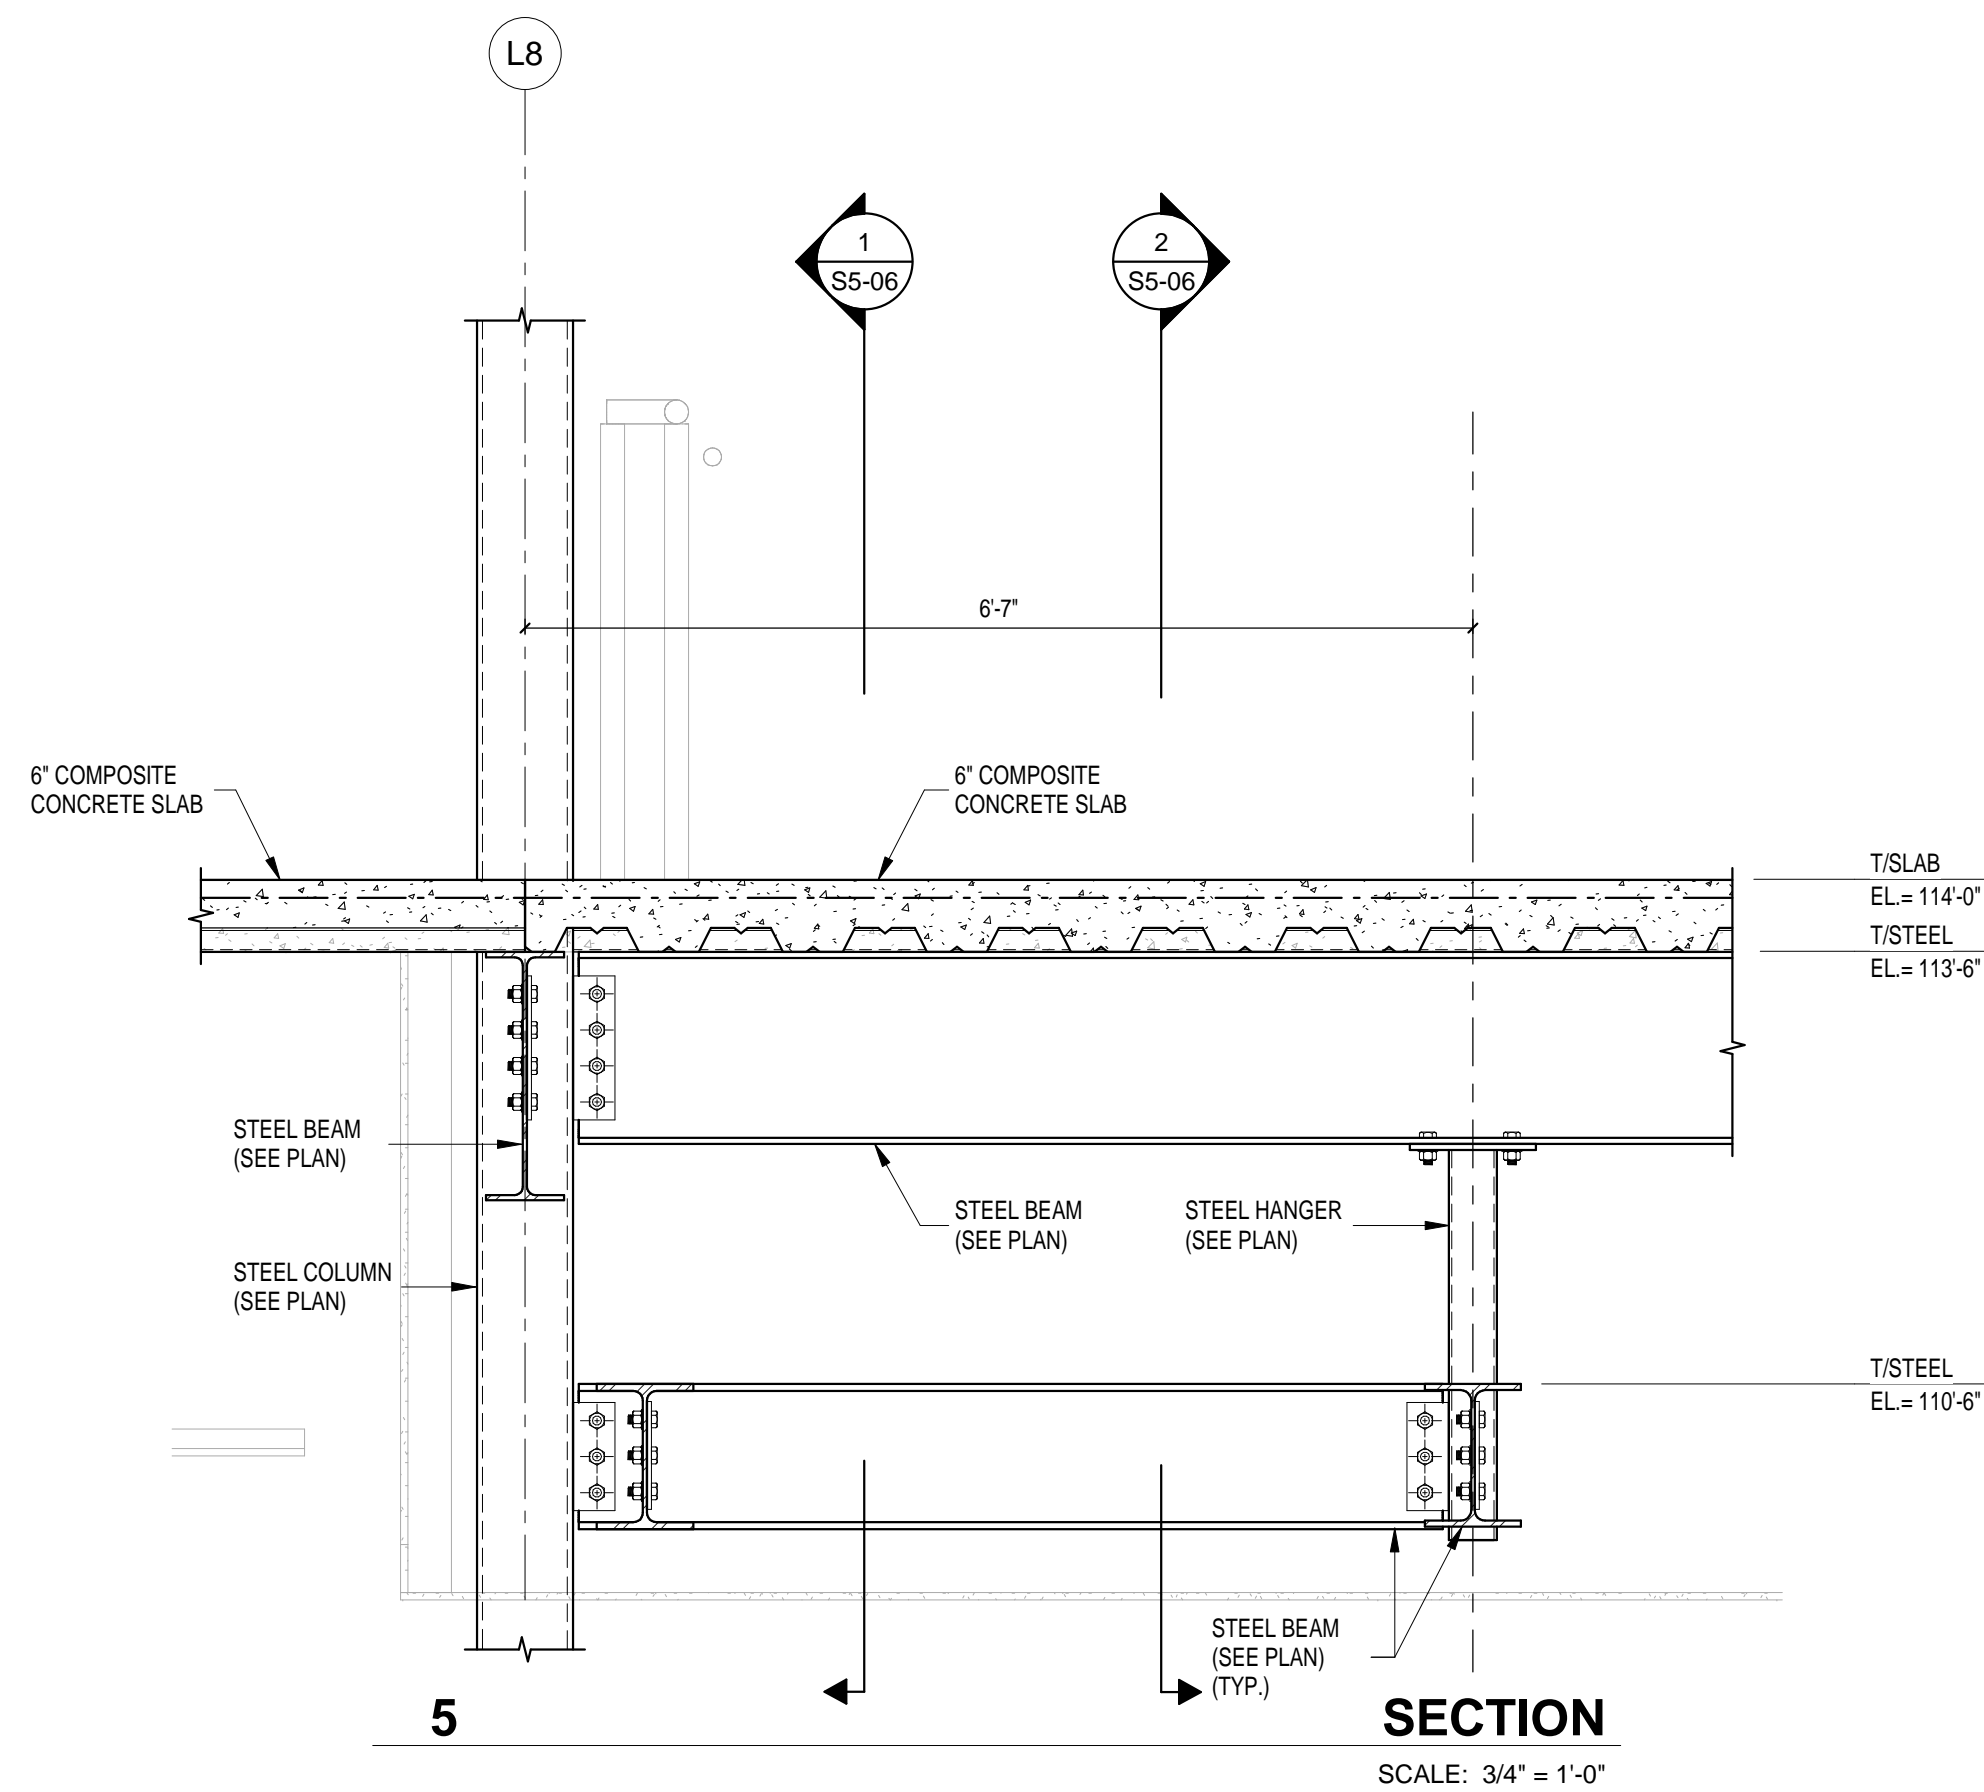
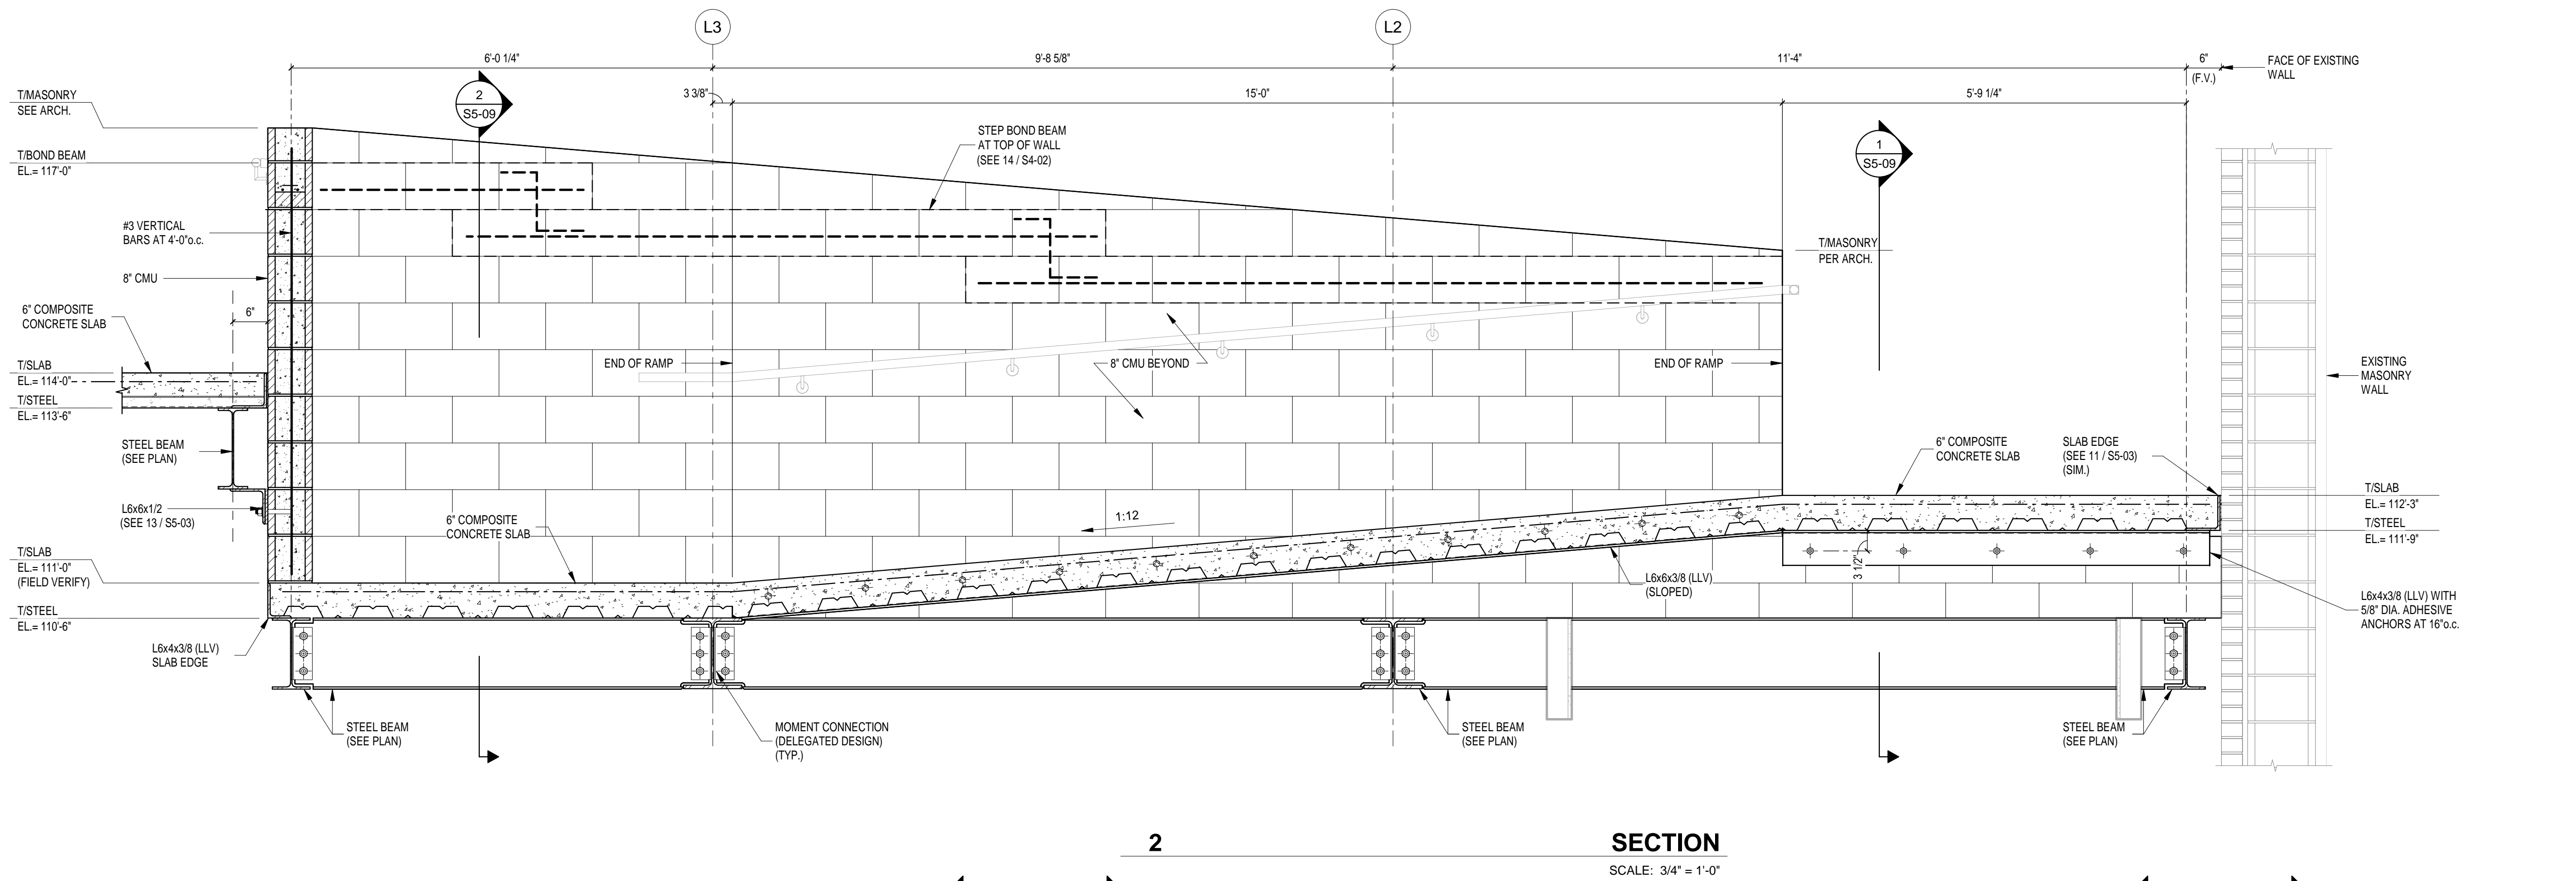
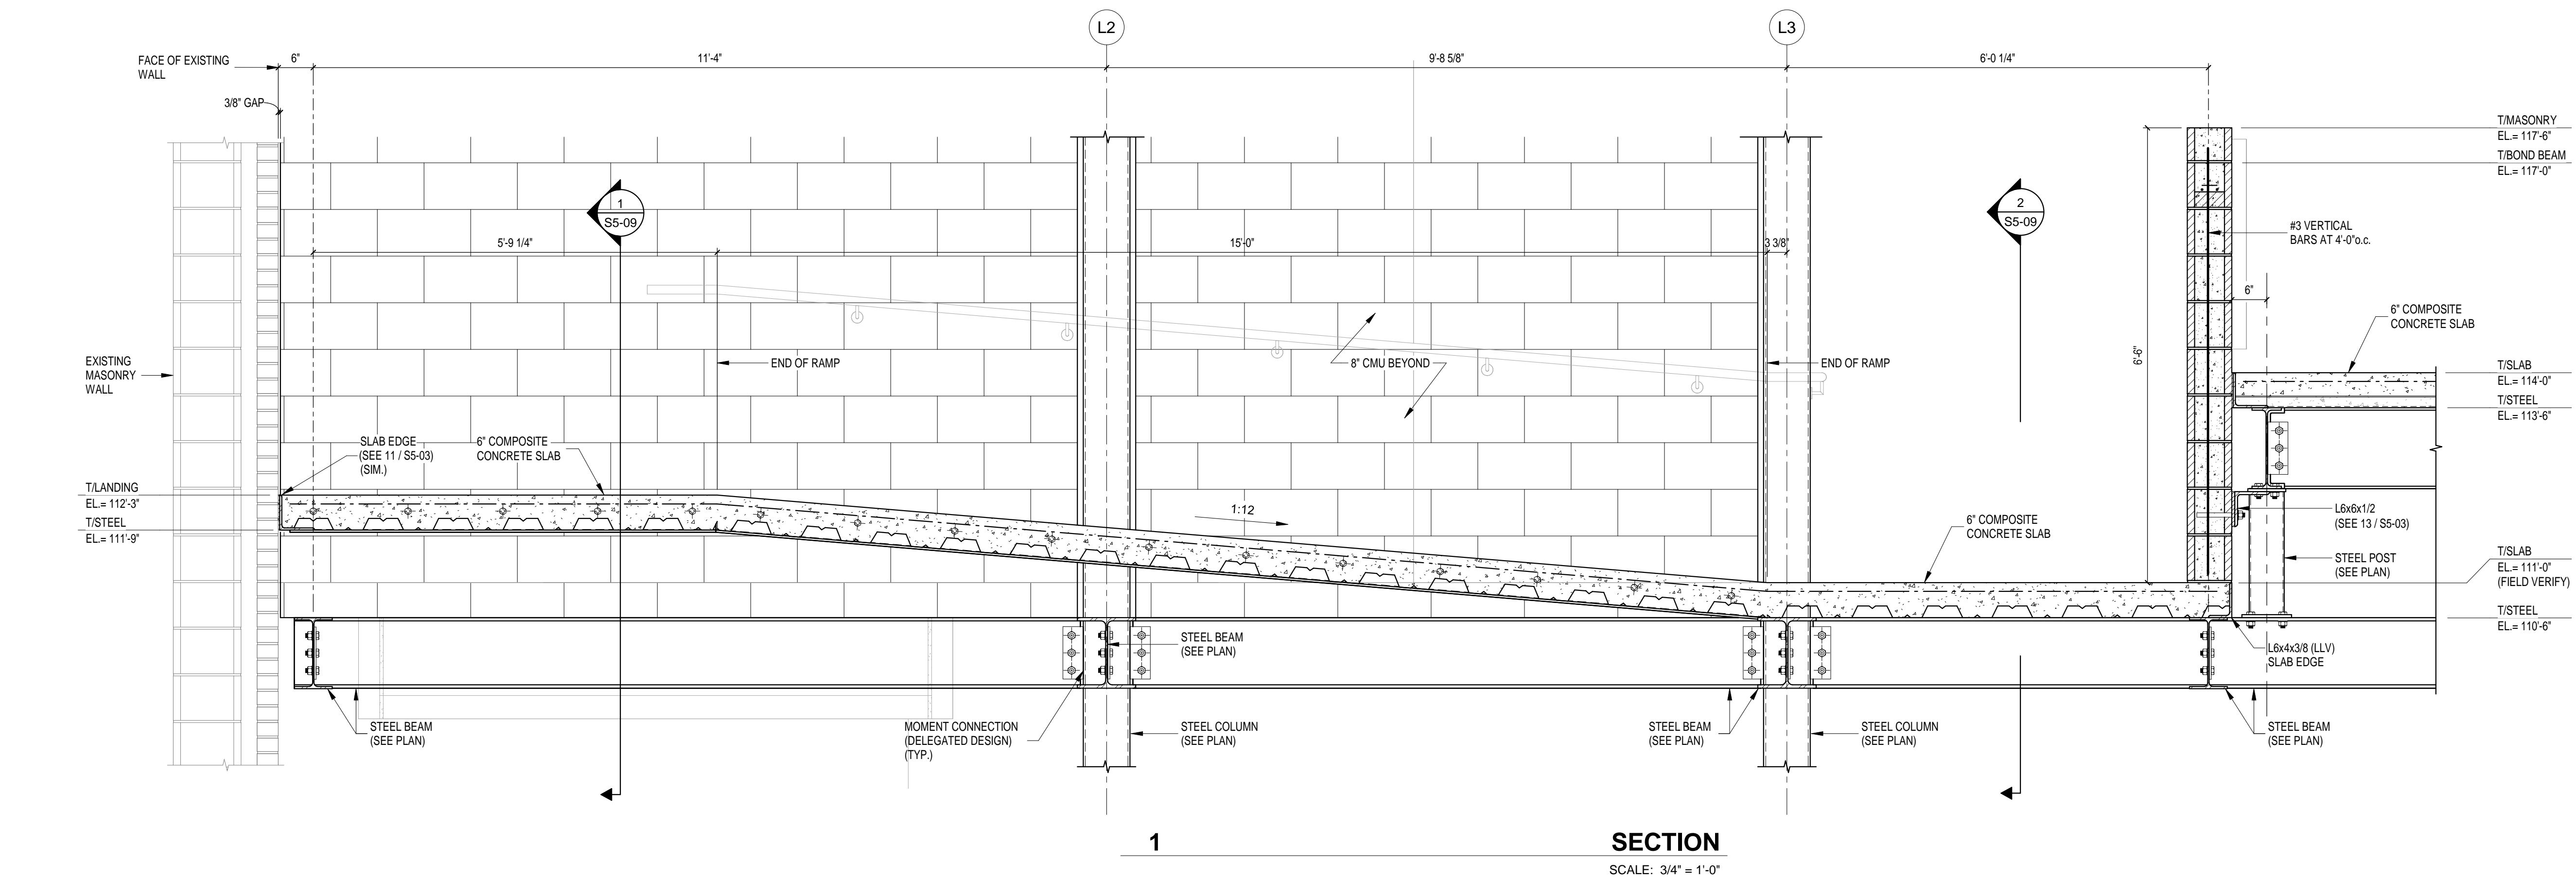


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SECTIONS AND DETAILS

S5-07




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AD-02

DEMOLITION IS TO FOLLOW ESTABLISHED CONSTRUCTION SEQUENCE. CONTRACTOR IS TO VERIFY THEIR WORK IN FIELD WITH THE EXISTING CONSTRUCTION DOCUMENTS. THE EXISTING IN-PLACE CONDITIONS, REPORT DISCREPANCIES TO THE ARCHITECT. CONTRACTOR TO REMOVE ALL EXISTING MATERIALS INCLUDING BASEMENTS, ADHESIVES, BASES, DOWN TO BUT EXCLUDING OF FLOOR SLABS AND STRUCTURAL MATERIALS, UNLESS NOTED OTHERWISE. CONTRACTOR TO "CEILING" TO EXPOSE CEILING MATERIALS INCLUDING CONCRETE, GYPSUM SYSTEMS, JOISTS, TRUSSES, BEAMS, AND ALL OTHERS. CONTRACTOR TO REMOVE ALL EXISTING MATERIALS ON WALLS TO BE REMOVED SHALL BE REMOVED TO A FINISH WITHIN THE EXISTING WALL. CONTRACTOR TO REMOVE SETTING ON PATCH, SWITCH WITH NEW CONCRETE TO A POINT WITH THE EXISTING FLOOR SLAB.

OPENING TO BE EXPOSED EXISTING WALL, THE OPENING SHALL BE A MINIMUM OF 1'-4" LONGER THAN THE FINISHED OPENING REQUIRED TO ALLOW FOR (6" MIN) OF MAU (MINIMUM) OVER THE OPENING.

AFTER THE DEMOLITION OF MATERIALS, THE RESULTING EXPOSED SURFACE SHALL BE SMOOTH AND FLUSH WITH EXISTING CONDITIONS.

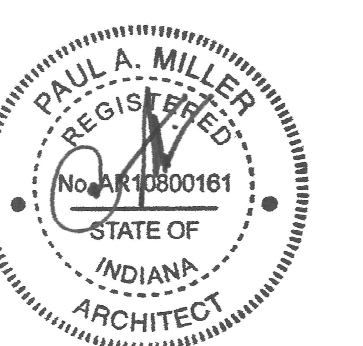MECHANICAL AND ELECTRICAL ITEMS THAT ARE CAPPED AND ABANDONED SHALL BE LOCATED BEHIND FINAL FINISH SURFACES.

COORDINATE THIS WORK WITH DEMOLITION WORK ON SITE, STRUCTURAL, PLUMBING, MECHANICAL, AND ELECTRICAL.

PROVIDE INTERIOR AND EXTERIOR SHORING, BRACING, OR OTHER TEMPORARY MOVEMENT OR SETTLEMENT OF EXISTING STRUCTURES.

CONTRACTOR TO FIELD VERIFY PORTIONS OR SECTIONS OF EXISTING MATERIALS TO BE FILLED IN AND DISPOSED OF NECESSARY MATERIAL.

MATERIALS OF DEMOLITION SHALL BE DISPOSED OF OFF-SITE IN ACCORDANCE WITH ALL APPLICABLE REGULATIONS.

OWNER TO REMOVE EXISTING FURNITURE AND MISCELLANEOUS ITEMS NOT SHOWN AND NOT TO BE DEMOLISHED. CONTRACTOR TO REMOVE ITEMS IN ADVANCE WHEN ITEMS NEED TO BE REMOVED.

CONTRACTOR IS RESPONSIBLE FOR OTHER ITEMS TO BE REMOVED.

ITEMS TO BE PATCHED, REMOVE ALL LOOSE OR DAMAGED MATERIAL, REFINISH TO LIKE NEW CONDITION OR, OR REPAIR OR REPLACE TO MEET THE SAME CONDITION.

THE OWNER SHALL RESERVE RIGHT TO CLAIM ANY MATERIALS THAT ARE BEING DEMOLISHED PRIOR TO THE CONTRACTOR'S DISPOSAL.

1) "TURNED OVER TO THE OWNER" DENOTES: 1) TAG AND IDENTIFY THE CONTRACTOR'S WORK, 2) REMOVE THE WORK IN LOCATION DESIGNATED BY THE OWNER.

ITEMS MADE OBSOLETE TO ACCOMMODATE NEW CONSTRUCTION OR REPAIRS TO EXISTING WORK. REMOVED ITEMS TO BE REMOVED SHALL BE REMOVED IN THEIR ENTIRETY.

AFTER REMOVAL OF ITEMS, THE EXISTING WALL SURFACES (IF EXPOSED) SHALL BE REPAIRED/PATCHED AS REQUIRED TO RECEIVE NEW FINISHES.

CONTRACTOR SHALL REMAIN RESPONSIBLE BUILDING COMPLETELY, SEE CIVILITE SURVIVAL DRAWINGS FOR MORE DETAILS.


(ALL NOTES MAY NOT BE INDICATED ON THIS SHEET)

- 1 DEMOLISH PORTION OF EXISTING WALL LOCATION MARKED IN
DASHED LINES. PATCH AND REPAIR ADJACENT SURFACES AT
REMOVED LOCATION.
- 2 DEMOLISH EXISTING LOCKERS & LOCKERS BENCH (WOOD OR
CONCRETE) PATCH AND REPAIR ADJACENT SURFACES AT
REMOVED BENCH LOCATION.
- 3 DEMOLISH EXISTING DOOR AND FRAME. REINSTALL NEW
DOOR & FRAME AT SAME OPENING LOCATION.
- 4 DEMOLISH EXISTING DOOR AND FRAME.
- 5 REMOVE EXISTING SHOWER AND ALL RELATED TIES,
WALLS & L.S. ACCESSORIES INCLUDING FINISHES. REMOVE
DETAILS. REFER TO PLUMBING DRAWINGS FOR MORE
DETAILS.
- 6 REMOVE EXISTING WALL, HOLLOW METAL STOREFRONT
ASSEMBLY INCLUDING DOOR, FRAME AND GLASS.
- 7 REMOVE ONE-STORY EXTERIOR WALL AND ASSOCIATED
DOORS, WINDOWS, UNDERNEATH FOOTINGS, FOUNDATIONS
AND ALL REED STRUCTURE, COLUMNS, JOISTS AND
OTHER ELEMENTS COMPLETE.
- 8 DEMOLISH EXISTING PLUMBING FIXTURES REFER TO
PLUMBING DRAWINGS.
- 9 DEMOLISH PORTION OF EXISTING ROOF AND ASSOCIATED
STRUCTURE COMPLETE. REFER TO STRUCTURAL DRAWINGS
FOR NEW ROOF DETAILS.
- 10 REMOVE BUILDUP COMPLETE - CONTRACTOR TO
DISCONNECT AND REMOVE ALL ASSOCIATED ELECTRICAL,
MECHANICAL, PLUMBING SANITARY AND SUPPLY COMPLETE
REFER TO PLUMBING DRAWINGS FOR DISCONNECTS. RUN
LINES BACK TO NEAREST CONNECTION POINT. PROTECT ALL
EXISTING LINES TO REMAIN. NOTIFY ARCHITECT OF ANY
CONCERNING OR INFORMATION CONCERNING CONDUITS.
- 11 DISCONNECT AND REMOVE EXISTING FEEDERS AND
CONDUITS TO EXISTING BUILDING.
- 12 REMOVE EXISTING INSTANTANEOUS WATER HEATER
COMPLETE. CLEAN AND STORE WHERE REQUIRED FOR
RELOCATION TO MAIN BUILDING. REFER TO NEW-WORK
PLUMBING DRAWINGS FOR NEW LOCATION.
- 13 REMOVE ALL PLUMBING EQUIPMENT AND ALL ASSOCIATED
VALVES, PIPING, SUPPORTS AND TRIM COMPLETE WITHIN
ENTIRE BUILDING, UNLESS NOTED OTHERWISE.
- 14 REMOVE INCOMING WATER SERVICE TO BELOW SLAB
AND BACK TO THE MAIN CAN.
- 15 REMOVE INCOMING NATURAL GAS SERVICE AND ASSOCIATED
METERS, VALVES AND SUPPORT. REMOVE PIPING DOWN
TO BELOW SLAB AND BACK TO THE MAIN CAN.
- 16 REMOVE ALL SANITARY WASTE, SANITARY VENT AND STORE
WATER PIPING AND SUPPORT WITHIN ENTIRE BUILDING
COMPLETE. REMOVE SANITARY SYSTEMS DOWN TO
BELOW SLAB PLAC. REFER TO SITE/CIVIL DRAWINGS FOR
MORE DETAILED INFORMATION REGARDING BELOW GRADE
PLUMBING UTILITY SERVICE TO REMAIN.
- 17 DEMOLISH EXISTING CEILING GRID AND ACOUSTICAL CEILING
TILES COMPLETELY.
- 18 DEMOLISH PORTION OF EXISTING CANOPY & STOREFRONT
TEMPORARILY DURING DEMOLITION. REFER TO
STRUCTURAL FOR FRAMING TO REMAIN.
- 19 DEMOLISH EXISTING MECHANICAL DUCTWORK OVER AT
MEZZANINE LEVEL COMPLETELY.
- 20 REMOVE EXISTING EXTERIOR DOOR, TRIM AND RESILIENT
BASE.
- 21 REMOVE EXISTING VINYL COMPOSITION TILE AND RESILIENT
BASE.
- 22 NO FINISH WORK IN THIS AREA LINE INDICATES EXTENTS OF
EXISTING FINISH TO REMAIN.
- 23 REMOVE EXISTING CARPET AND RESILIENT BASE.
- 24 REMOVE ALL PLUMBING ASSOCIATED WITH WHIRLPOOL.
TURN WHIRLPOOL OVER TO OWNER.
- 25 REMOVE RAISED FLOOR.
- 26 REMOVE BASE AND WALL CASEWORK, COUNTERTOP, AND
RELATED PLUMBING ACCESSORIES.
- 27 DEMOLISH EXISTING THICKEST CERAMIC MOSAIC TILE
TYPICALLY 6" X 6" X 1/2" THICK. INCLUDE SETTING
MATERIALS. INFILL APPROXIMATELY 1/2" X 2" THICK
RECESS WITH NEW CEMENT. DEPENDING ON NEW
TYPING TYPE AREA IS TO BE LEFT IN PLACE TO CREATE A
FLUSH CONDITION. PREPARE SLAB FOR NEW FLOOR
FINISHES AS NOTED ON A-111.
- 28 DEMOLISH PORTION OF EXISTING EXTERIOR, BRICK VENEER
INSULATION BEHIND IT TO THE BOUNDARY OF NEW WALL
INSTALLATION AT FIRST FLOOR LEVEL. BACKFILL WITH 6"
CMU.
- 29 CLEAN EXTERIOR BRICK VENEER AT EXTERIOR WALLS AS
REQUIRED.
- 30 REMOVE EXISTING COPPER ASSEMBLY AND STORE FOR
REINSTALLATION.
- 31 PROTECT EXISTING CANOPY COLUMN TO REMAIN DURING
CONSTRUCTION.

CONTRACTOR SHALL VERIFY ALL DIMENSIONS AND CLEARANCES AND ALL EXISTING FIELD CONDITIONS BEFORE STARTING CONSTRUCTION. COMMENCEMENT OF WORK CONSTITUTES ACCEPTANCE OF CONDITIONS.

SHOULD DIFFERENT CONDITIONS BE ENCOUNTERED, CONTACT THE ARCHITECT BEFORE PROCEEDING WITH WORK.

SCALE: 1/8" = 1'-0"

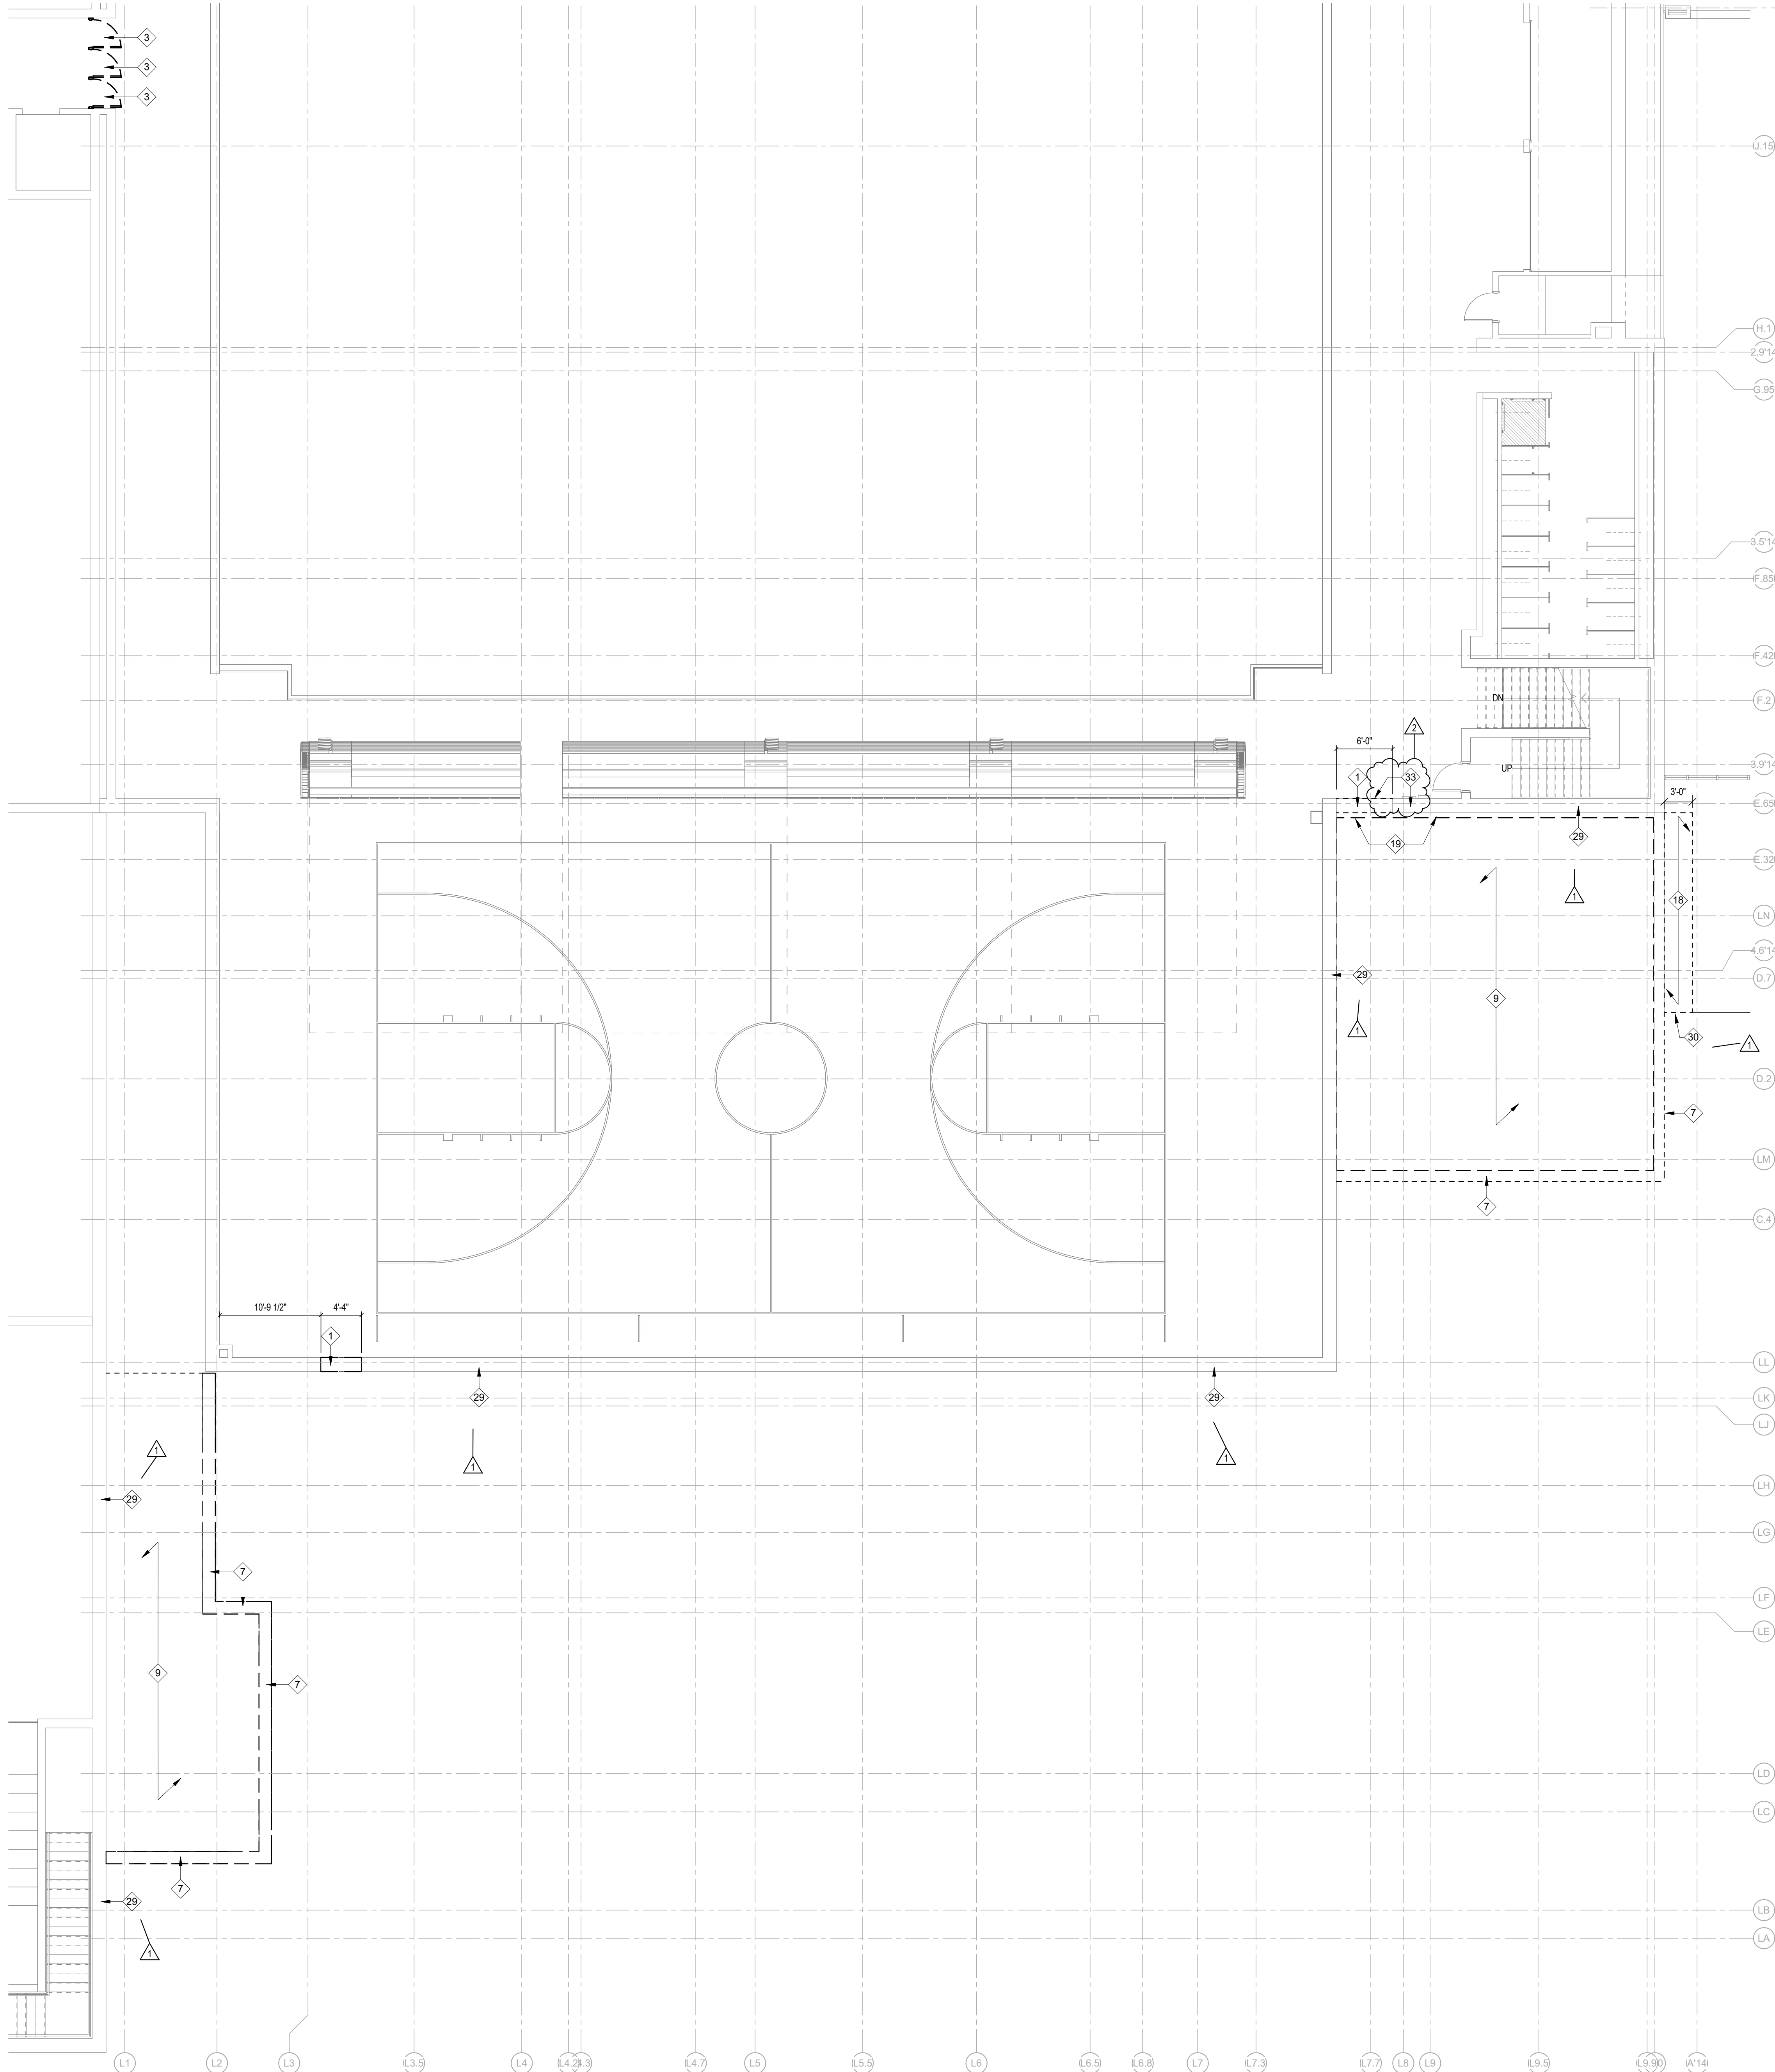


ZIONSVILLE COMMUNITY SCHOOLS




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HOWEY**

30 E NEW YORK ST, SUITE 300, INDIANAPOLIS, IN 46204

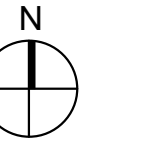

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A-12

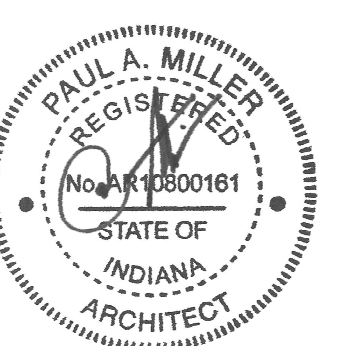[illegible]

—**W#** INDICATES WALL TYPE. REFER TO SHEET A-00 FOR WALL THICKNESS, HEIGHT, AND COMPOSITION. ALL UNTAGGED WALLS ARE TO BE W&2 UNLESS NOTED OTHERWISE ON PLANS.

ALL INTERIOR WALLS TO START WITH 4" CMU COURSING

- 1 INFILL WALL EXPANSION AT REMOVED DOOR AND FRAME WITH
- 2 CMU. REFER TO WALL TYPE FOR DETAILS
- 3 NEW DOOR AND FRAME TO BE INSTALLED WITH SPRING AND
- 4 NEW WALL MOUNTED 1 1/2" DIAMETER ALUMINUM HANDRAIL.
- 5 BACKFILL DEMOLISHED BRICK VENEER LOCATION WITH 6"
- 6 CMU
- 7 (NEW DOORS AND FRAME IN EXISTING WALL OPENING
- 8 REQUIRES SWING FROM EXISTING CONDITION)
- 9 INSTALL NEW STAIR AT DEMOLISHED LOUVER LOCATION.
- 10 REFER TO WALL SECTION 24.01 FOR DETAILS
- 11 NEW CRAWLER TO BE INSTALLED TO EQUIPMENT PLAN
- 12 INSTALL 2" BUILDING EXPANSION JUNT WITH PREFORMED
- 13 JUNT SEAL, EXPANSION JUNT BETWEEN NEW AND
- 14 EXISTING WALL
- 15 MODIFY EXISTING DOOR FRAME AS REQUIRED TO RECEIVE
- 16 NEW UPDATED TECH DEVICES. SEE TECHNOLOGY SHEETS
- 17 FOR FURTHER DETAILS
- 18 ADD CARD READER AND REQUIRED WIRING TO EXISTING
- 19 DOOR AND FRAME
- 20 PAINT EXISTING MASONRY CMU AROUND NEW DOOR
- 21 AND FRAME TO INTERIOR SURFACE FOR DETAILS
- 22 REINSTALL EXISTING STOREFRONT FRAMING AND GLAZING
- 23 REPAIR EXISTING COLUMN AFTER COMPLETION
- 24 OF CONSTRUCTION
- 25 WALL COATING TO MATCH EXISTING COURSE
- 26 PROVIDE 2" EXPANSION JUNT WITH EXPANSION JUNT COVER
- 27 BETWEEN EXISTING AND NEW FLOOR

VERIFICATION NOTE


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SCALE: 1/8" = 1'-0"

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1 FIRST FLOOR CEILING PLAN
SCALE: 1/8" = 1'-0"

ROOM LEGEND			
ROOM NO.	OWNER ROOM NO.	ROOM NAME	AREA (SF)
A101	C9	CORRIDOR	1,376 SF
A102	C9 LAUNDRY	LAUNDRY	515 SF
A103	C9 MECH	MECHANICAL	897 SF
A104		VESTIBULE	46 SF
A105		VESTIBULE	60 SF
A106		OFFICE	193 SF
A107		LOCKERS	110 SF
A108		RESTROOM	70 SF
A109		VESTIBULE	129 SF
A110		STORAGE	19 SF
A111		RESTROOM	226 SF
A112		SHOWERS	127 SF
A113		LOCKERS	668 SF
A114		STORAGE	11 SF
A115		SERVICE SINK	34 SF
A116		REF RESTROOM	98 SF
A117		REF RESTROOM	98 SF
A118		STORAGE	66 SF
A119		VESTIBULE	46 SF
A120		VESTIBULE	60 SF
A121		OFFICE	237 SF
A122		LOCKERS	110 SF
A123		RESTROOM	70 SF
A124		VESTIBULE	129 SF
A125		STORAGE	19 SF
A126		RESTROOM	226 SF
A127		SHOWERS	127 SF
A128		LOCKERS	668 SF
A129		STORAGE	10 SF
A130		CORRIDOR	1,707 SF
A131		STORAGE	92 SF
A132		VESTIBULE	40 SF
A133		VESTIBULE	62 SF
A134		LOCKERS	215 SF
A135		RESTROOM	182 SF
A136		VESTIBULE	62 SF
A137		LOCKERS	215 SF
A138		RESTROOM	182 SF
A139		VESTIBULE	40 SF
A140		STORAGE	134 SF
A141		LOBBY	396 SF
A142		OPEN OFFICE	306 SF
A143		VESTIBULE	108 SF
A144		OFFICE	250 SF
A145		STORAGE	12 SF
A146		RESTROOM	92 SF
A147		LOCKERS	806 SF
A148		RESTROOM	228 SF
A149		VESTIBULE	44 SF
A150		RESTROOM	86 SF
A151		OFFICE	249 SF
A152		OFFICE	249 SF
A153		STORAGE	12 SF
A154		RESTROOM	92 SF
A155		LOCKERS	799 SF
A156		RESTROOM	229 SF
A157		VESTIBULE	44 SF
A158		VESTIBULE	105 SF
A159		OFFICE	249 SF
A160		STORAGE	12 SF
A161		RESTROOM	86 SF
A162		LOCKERS	799 SF
A163		RESTROOM	248 SF
A164		VESTIBULE	44 SF
A165		RESTROOM	86 SF
A166		VESTIBULE	104 SF
A167		OFFICE	250 SF
A168		STORAGE	12 SF
A169		RESTROOM	86 SF
A170		LOCKERS	794 SF
A171		RESTROOM	248 SF
A172		VESTIBULE	44 SF
A173		ELECTRICAL TECHNOLOGY	55 SF
A174		TECHNOLOGY	46 SF
A175	C9	CORRIDOR	1,253 SF
A176	C402	TRAINING	703 SF
A177	C402A	OFFICE	178 SF
A178		STORAGE	69 SF
A179		CORRIDOR	251 SF
A180	C9	CORRIDOR	251 SF
A181		VESTIBULE	387 SF
S1		STAIR	174 SF

REFLECTED CEILING PLAN NOTES

- A. PROVIDE REVEAL DRYWALL TRIM AT ALL LOCATIONS WHERE GYPSUM WALL BOARD (GWB) ABUTS A DISSIMILAR MATERIAL. TYPICAL UNLESS NOTED OTHERWISE.
- B. BULKHEAD FRAMING SHALL BE ATTACHED TO STRUCTURAL SUPPORTS AND NOT TO THE ROOF DECK.

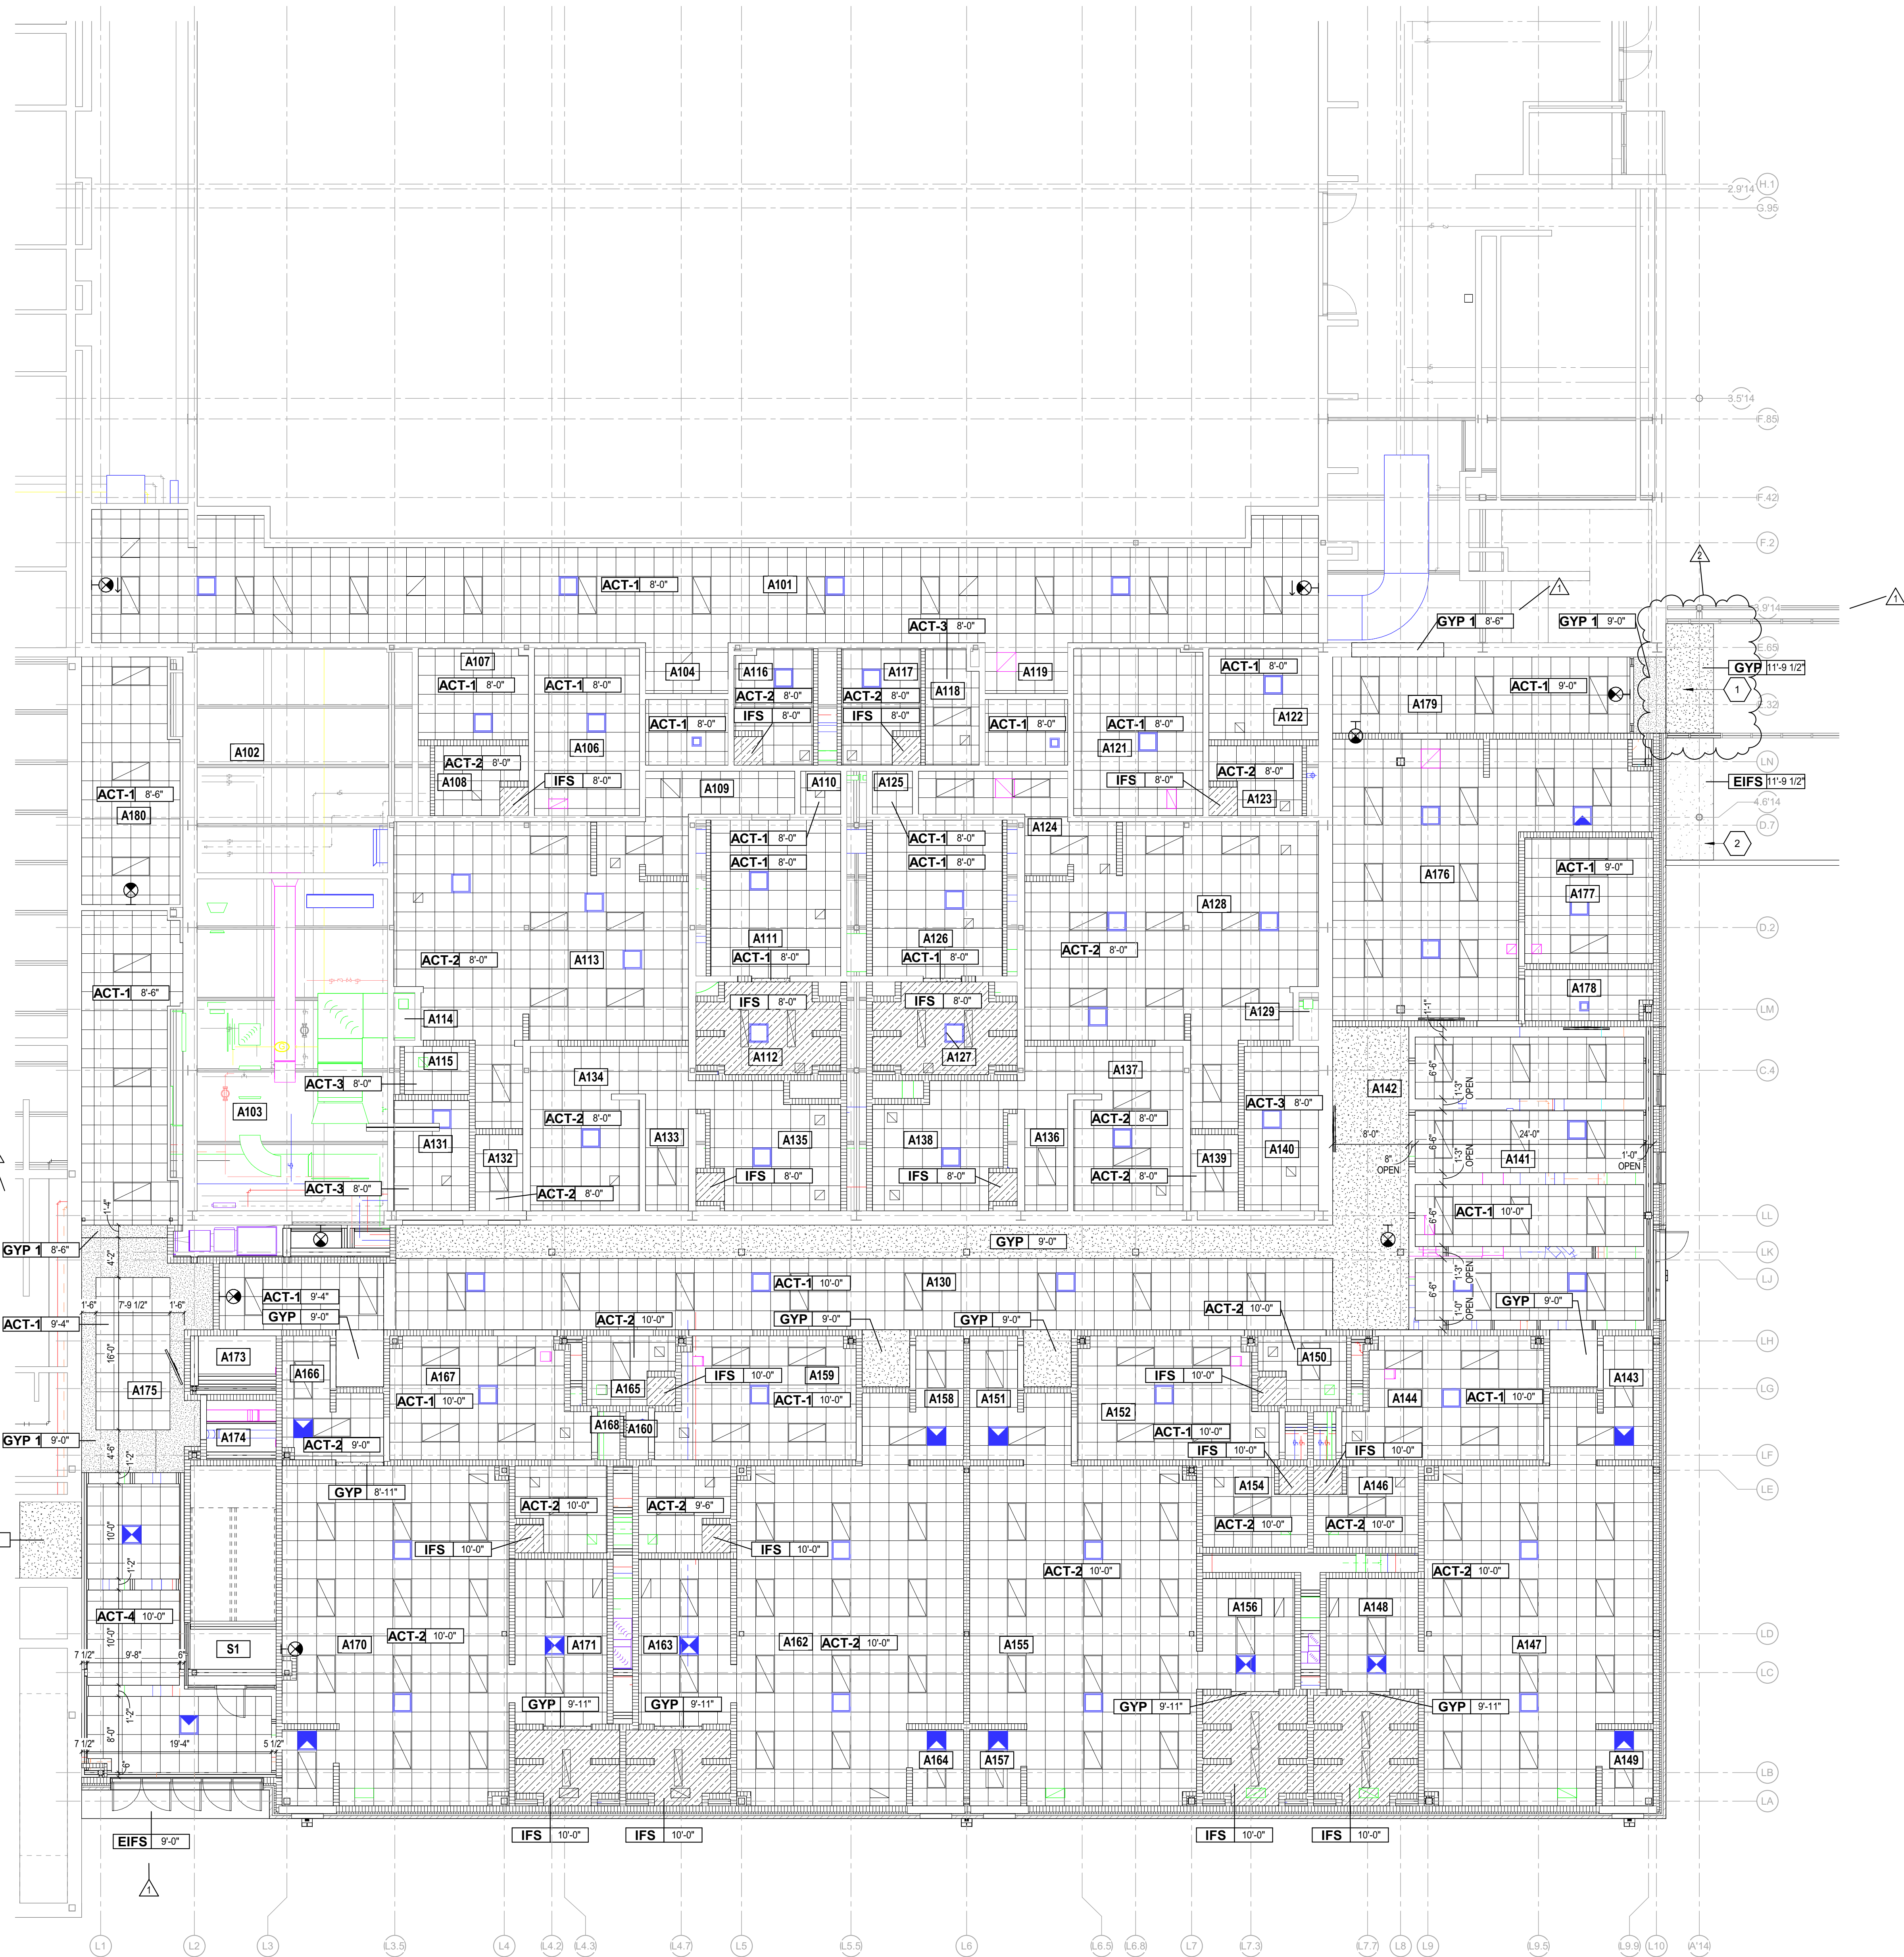REFLECTED CEILING NOTES

- (ALL NOTES MAY NOT BE INDICATED ON THIS SHEET)
1. INSTALL NEW CEILING IN PLACE OF DEMOLISHED PORTION OF CEILING. CONVERT TO EXISTING CEILING.
2. PROVIDE NEW EFS SOFFIT ASSEMBLY AS REQUIRED TO MATCH EXISTING CEILING TYPE AND CONSTRUCTION.
3. ALIGN BULKHEAD WITH THE EDGE OF THE WALL (COLUMN/BEAM).
4. ALIGN BULKHEAD WITH EDGE OF EXISTING STRUCTURE (COLUMN/BEAM).

REFLECTED CEILING PLAN LEGEND

- 10'-4" INDICATES ELEVATION HEIGHT
- XX-XX INDICATES CEILING HEIGHT
- X1 XX-XX INDICATES ACOUSTIC PANEL CEILING TYPE AND HEIGHT. REFER TO PROJECT MANUAL FOR "TYPE"

- LIGHT FIXTURE - REFER TO ELECTRICAL DRAWINGS
- LIGHT FIXTURE - REFER TO ELECTRICAL DRAWINGS
- LIGHT FIXTURE - REFER TO ELECTRICAL DRAWINGS
- CLOCK - REFER TO TECHNOLOGY DRAWINGS
- MECHANICAL DIFFUSER - REFER TO MECHANICAL DRAWINGS
- MECHANICAL RETURN AIR GRILLE - REFER TO MECHANICAL DRAWINGS
- CEILING MOUNTED MECHANICAL UNIT - REFER TO MECHANICAL DRAWINGS
- MECHANICAL UNIT HEATER - REFER TO MECHANICAL DRAWINGS
- RECESSED CEILING SPEAKER
- MOTION DETECTOR
- CEILING MOUNTED EXIT LIGHT
- CEILING MOUNTED CAMERA
- WIRELESS ACCESS POINT (WAP)
- CONTROL JOINT IN GYPSUM BOARD CEILING OR BULKHEAD
- SOUND REINFORCEMENT SPEAKER
- FIRE ALARM HEAT DETECTOR
- FIRE ALARM HORN STROBE
- FIRE ALARM SPEAKER STROBE
- FIRE ALARM STROBE
- FIRE ALARM SMOKE DETECTOR
- OCCUPANCY SENSOR
- ACOUSTICAL CEILING TILE (ACT)
- ACOUSTICAL CEILING TILE (ACT)
- GYPSUM WALL BOARD BULKHEAD / CEILING EXTERIOR FINISH SYSTEM (E.F.S.)
- EXTERIOR INSULATION FINISH SYSTEM (E.I.F.S.)
- INTERIOR FINISH SYSTEM (I.F.S.)
- EXTERIOR FINISH SYSTEM SOFFIT (E.F.S.)

VERIFICATION NOTE

CONTRACTOR SHALL VERIFY ALL DIMENSIONS AND CLEARANCES AND ALL EXISTING FIELD CONDITIONS BEFORE STARTING CONSTRUCTION. COMMENCEMENT OF WORK CONSTITUTES ACCEPTANCE OF CONDITIONS.

SHOULD DIFFERENT CONDITIONS BE ENCOUNTERED, CONTACT THE ARCHITECT BEFORE PROCEEDING WITH WORK.

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1000 MULBERRY STREET,
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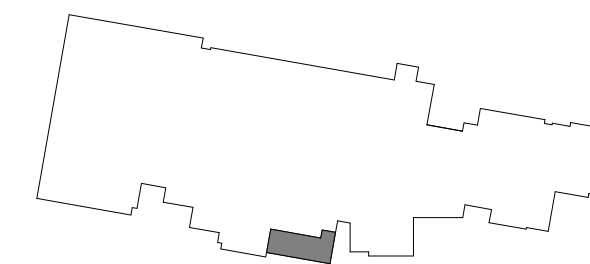
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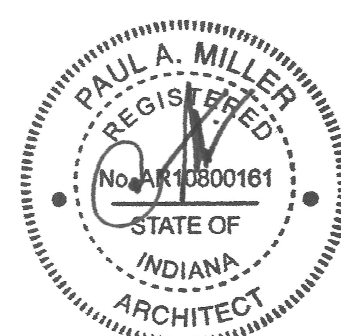
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350 E NEW YORK ST, SUITE 300, INDIANAPOLIS, IN 46204



KEY PLAN

ISSUED FOR BID



PROJECT MANAGER: JM
DRAWN BY: Author
PROJECT NUMBER: 224018.00
PROJECT ISSUE DATE: 01/21/2025

REV. NO.	DESCRIPTION	DATE
1	ADDENDUM #1	02/11/2025
2	ADDENDUM #2	02/18/2025

FIRST FLOOR REFLECTED CEILING PLAN

AC-11

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ROOM LEGEND			
ROOM NO.	OWNER ROOM NO.	ROOM NAME	AREA (SF)
A201		MULTIPURPOSE	8,618 SF
A202		RAMP 1	345 SF
A203		STORAGE	182 SF
A204		VESTIBULE	46 SF
A205		RAMP 2	317 SF
A206		CORRIDOR	310 SF
A207		LOCKERS	494 SF
A208		BATHROOM	112 SF
A209		STORAGE	399 SF
A210		EXISTING CORRIDOR	1,422 SF
A211		EXISTING CORRIDOR	1,219 SF
A212		SERVICE	50 SF
A213		IT CLOSET	31 SF
S1		STAIR	174 SF

REFLECTED CEILING PLAN NOTES

A. PROVIDE REVEAL DRYWALL TRIM AT ALL LOCATIONS WHERE GYPSUM WALL BOARD (GWB) ABUTS A DISSIMILAR MATERIAL. TYPICAL UNLESS NOTED OTHERWISE.

B. BULKHEAD FRAMING SHALL BE ATTACHED TO STRUCTURAL SUPPORTS AND NOT TO THE ROOF DECK.

REFLECTED CEILING NOTES

(ALL NOTES MAY NOT BE INDICATED ON THIS SHEET)

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2. PROVIDE NEW EFS SOFFIT ASSEMBLY AS REQUIRED TO MATCH EXISTING SOFFIT REMOVED FOR CONSTRUCTION.
3. ALIGN BULKHEAD WITH THE EDGE OF THE WALL.
4. ALIGN BULKHEAD WITH EDGE OF EXISTING STRUCTURE (COLUMN/BEAM).

REFLECTED CEILING PLAN LEGEND

10'-4" INDICATES ELEVATION HEIGHT

XX-XX INDICATES CEILING HEIGHT

X1 XX-XX INDICATES ACOUSTIC PANEL CEILING TYPE AND HEIGHT. REFER TO PROJECT MANUAL FOR "TYPE"

LIGHT FIXTURE - REFER TO ELECTRICAL DRAWINGS

LIGHT FIXTURE - REFER TO ELECTRICAL DRAWINGS

LIGHT FIXTURE - REFER TO ELECTRICAL DRAWINGS

CLOCK - REFER TO TECHNOLOGY DRAWINGS

MECHANICAL DIFFUSER - REFER TO MECHANICAL DRAWINGS

MECHANICAL RETURN AIR GRILLE - REFER TO MECHANICAL DRAWINGS

CEILING MOUNTED MECHANICAL UNIT - REFER TO MECHANICAL DRAWINGS

MECHANICAL UNIT HEATER - REFER TO MECHANICAL DRAWINGS

RECESSED CEILING SPEAKER

MOTION DETECTOR

CEILING MOUNTED EXIT LIGHT

CEILING MOUNTED CAMERA

WIRELESS ACCESS POINT (WAP)

CONTROL JOINT IN GYPSUM BOARD CEILING OR BULKHEAD

SOUND REINFORCEMENT SPEAKER

FIRE ALARM HEAT DETECTOR

FIRE ALARM HORN STROBE

FIRE ALARM SPEAKER STROBE

FIRE ALARM STROBE

FIRE ALARM SMOKE DETECTOR

OCCUPANCY SENSOR

ACOUSTICAL CEILING TILE (ACT)

ACOUSTICAL CEILING TILE (ACT)

GYPSUM WALL BOARD BULKHEAD / CEILING EXTERIOR FINISH SYSTEM (E.F.S.)

EXTERIOR INSULATION FINISH SYSTEM (E.I.F.S.)

INTERIOR FINISH SYSTEM (I.F.S.)

EXTERIOR FINISH SYSTEM SOFFIT (E.F.S.)

VERIFICATION NOTE

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ZIONSVILLE, IN 46077

ZIONSVILLE COMMUNITY SCHOOLS




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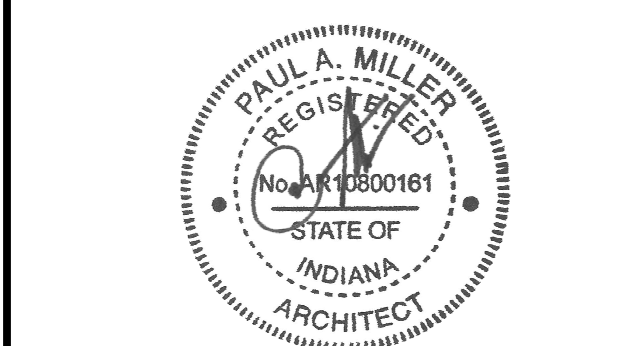
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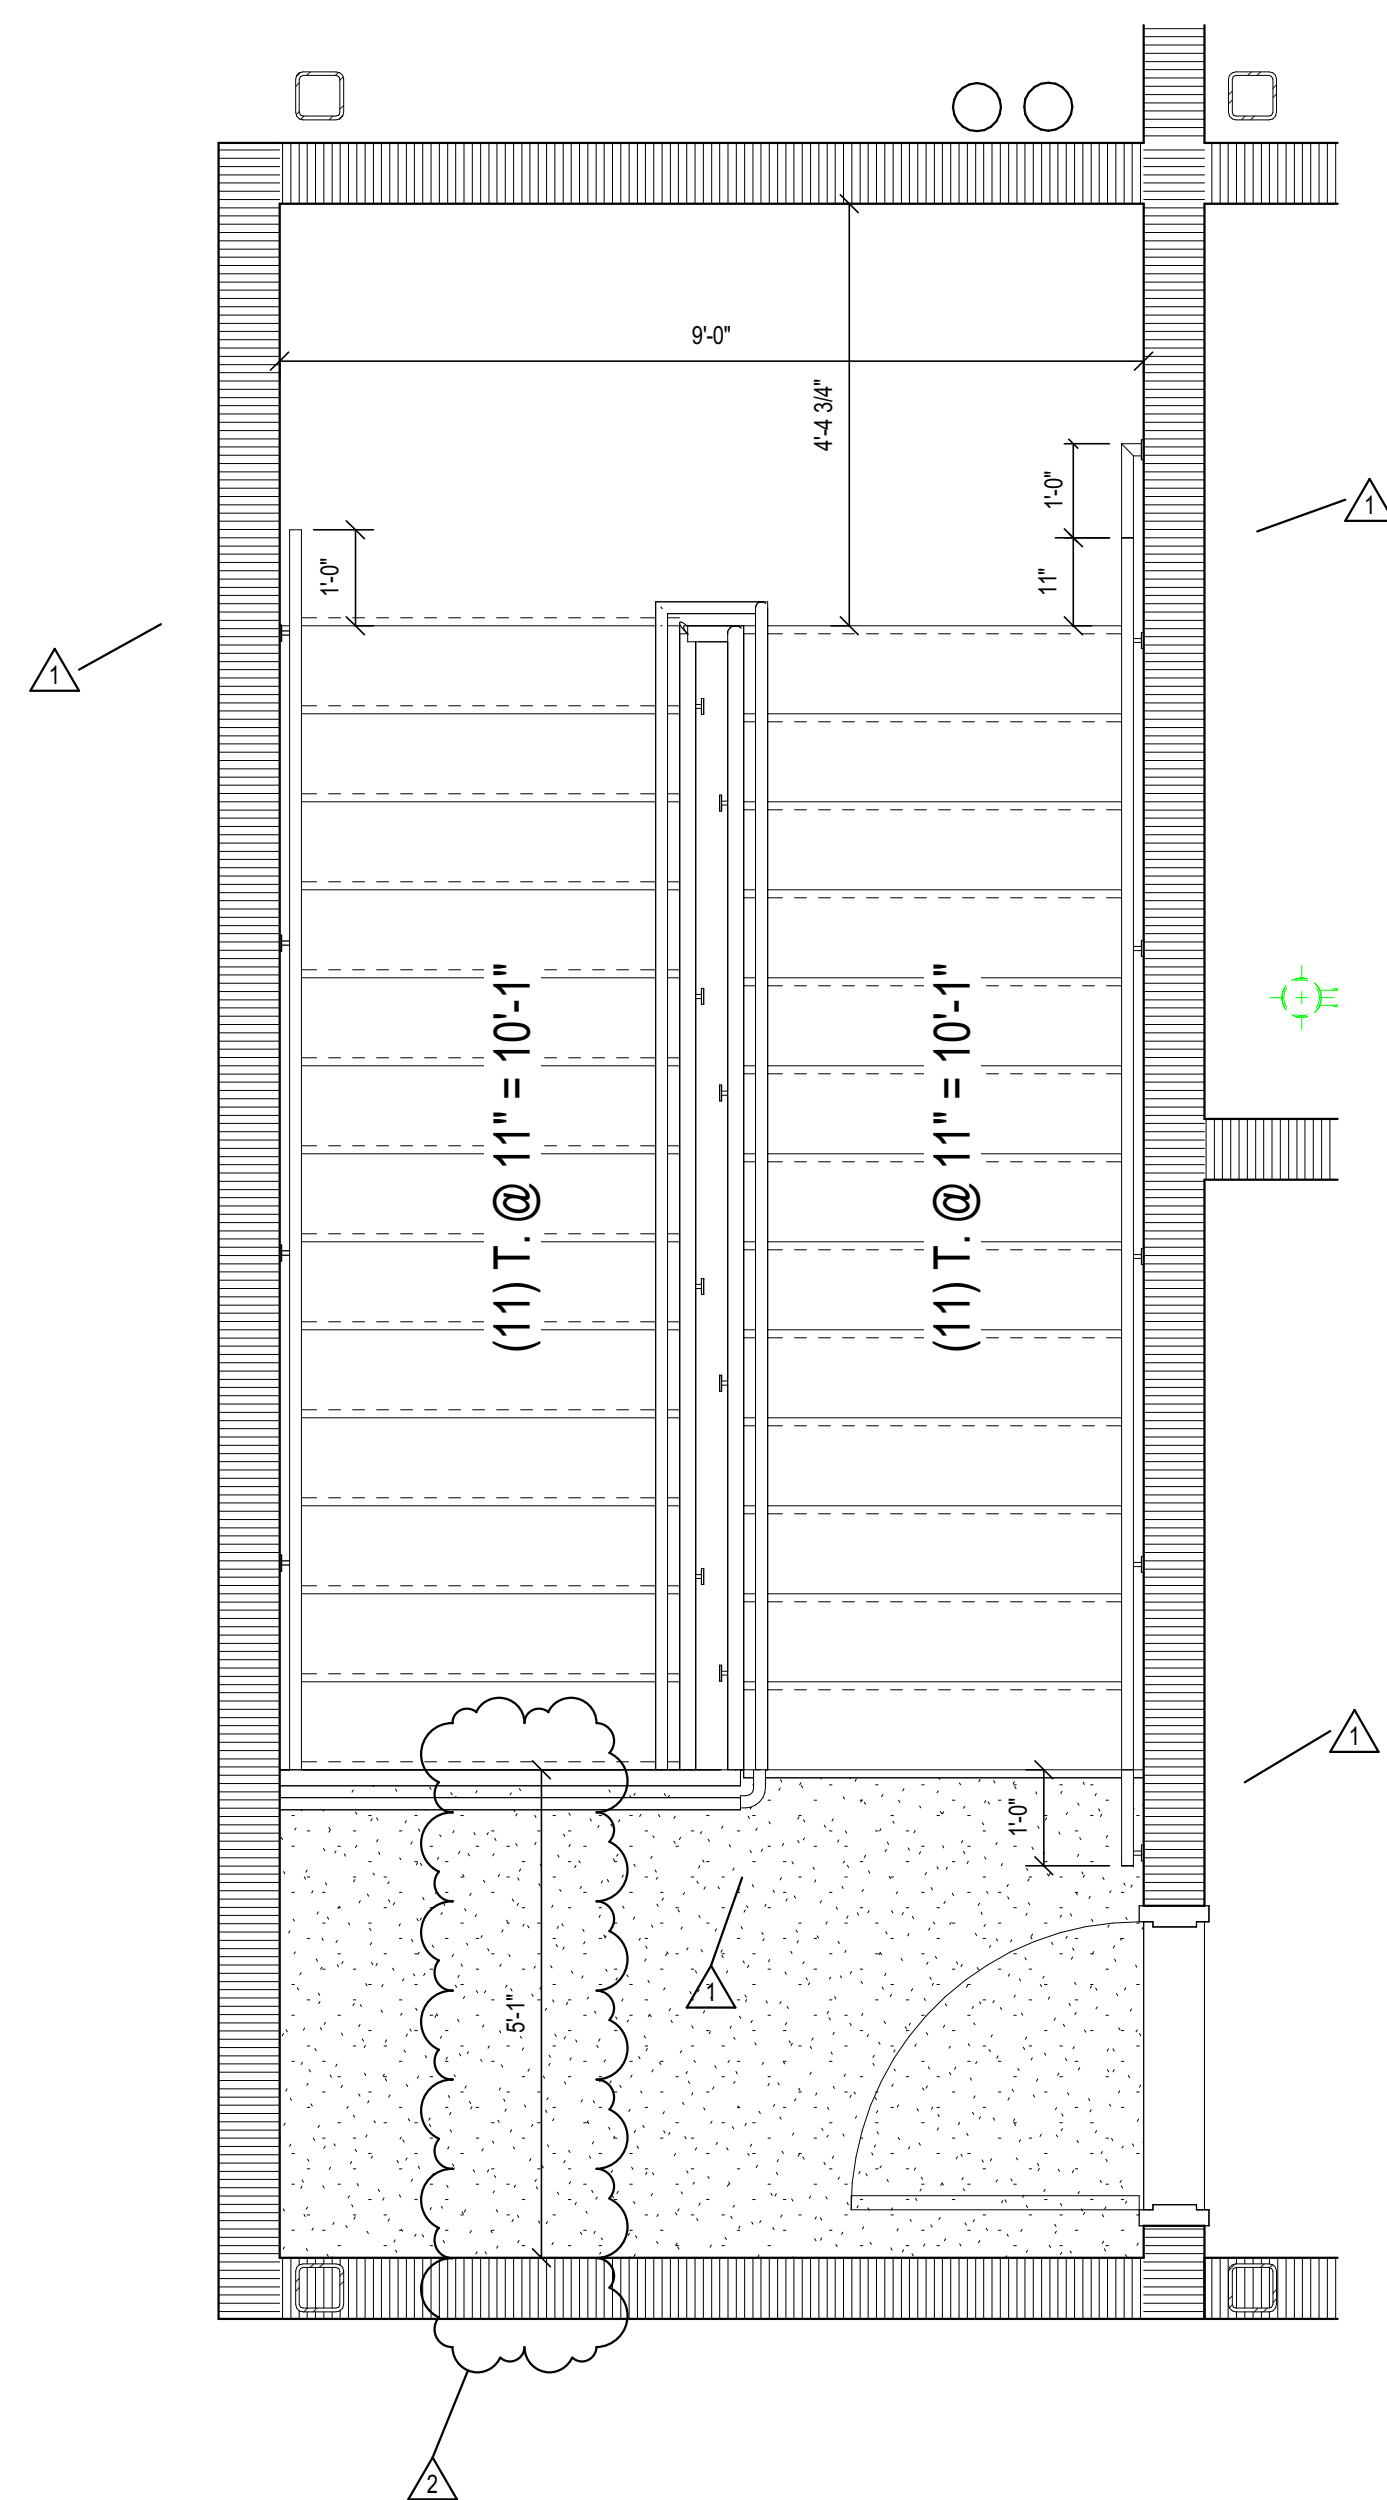


PROJECT MANAGER: JM		
PROJECT NUMBER: 224018.00		
PROJECT ISSUE DATE: 01/21/2025		
REV. NO.	DESCRIPTION	DATE
1	ADDENDUM #1	02/11/2025
2	ADDENDUM #2	02/18/2025


SECOND FLOOR REFLECTED CEILING PLAN

AC-12
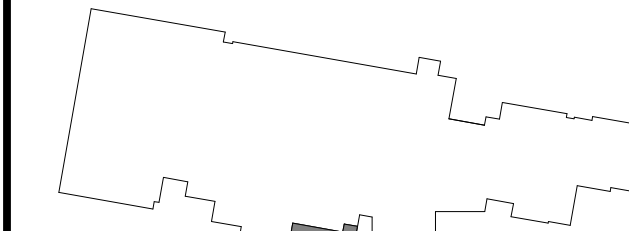
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1 S1 - EAST STAIRCASE
SCALE: 1/2" = 1'-0"



2 STAIR SECTION
SCALE: 1/2" = 1'-0"
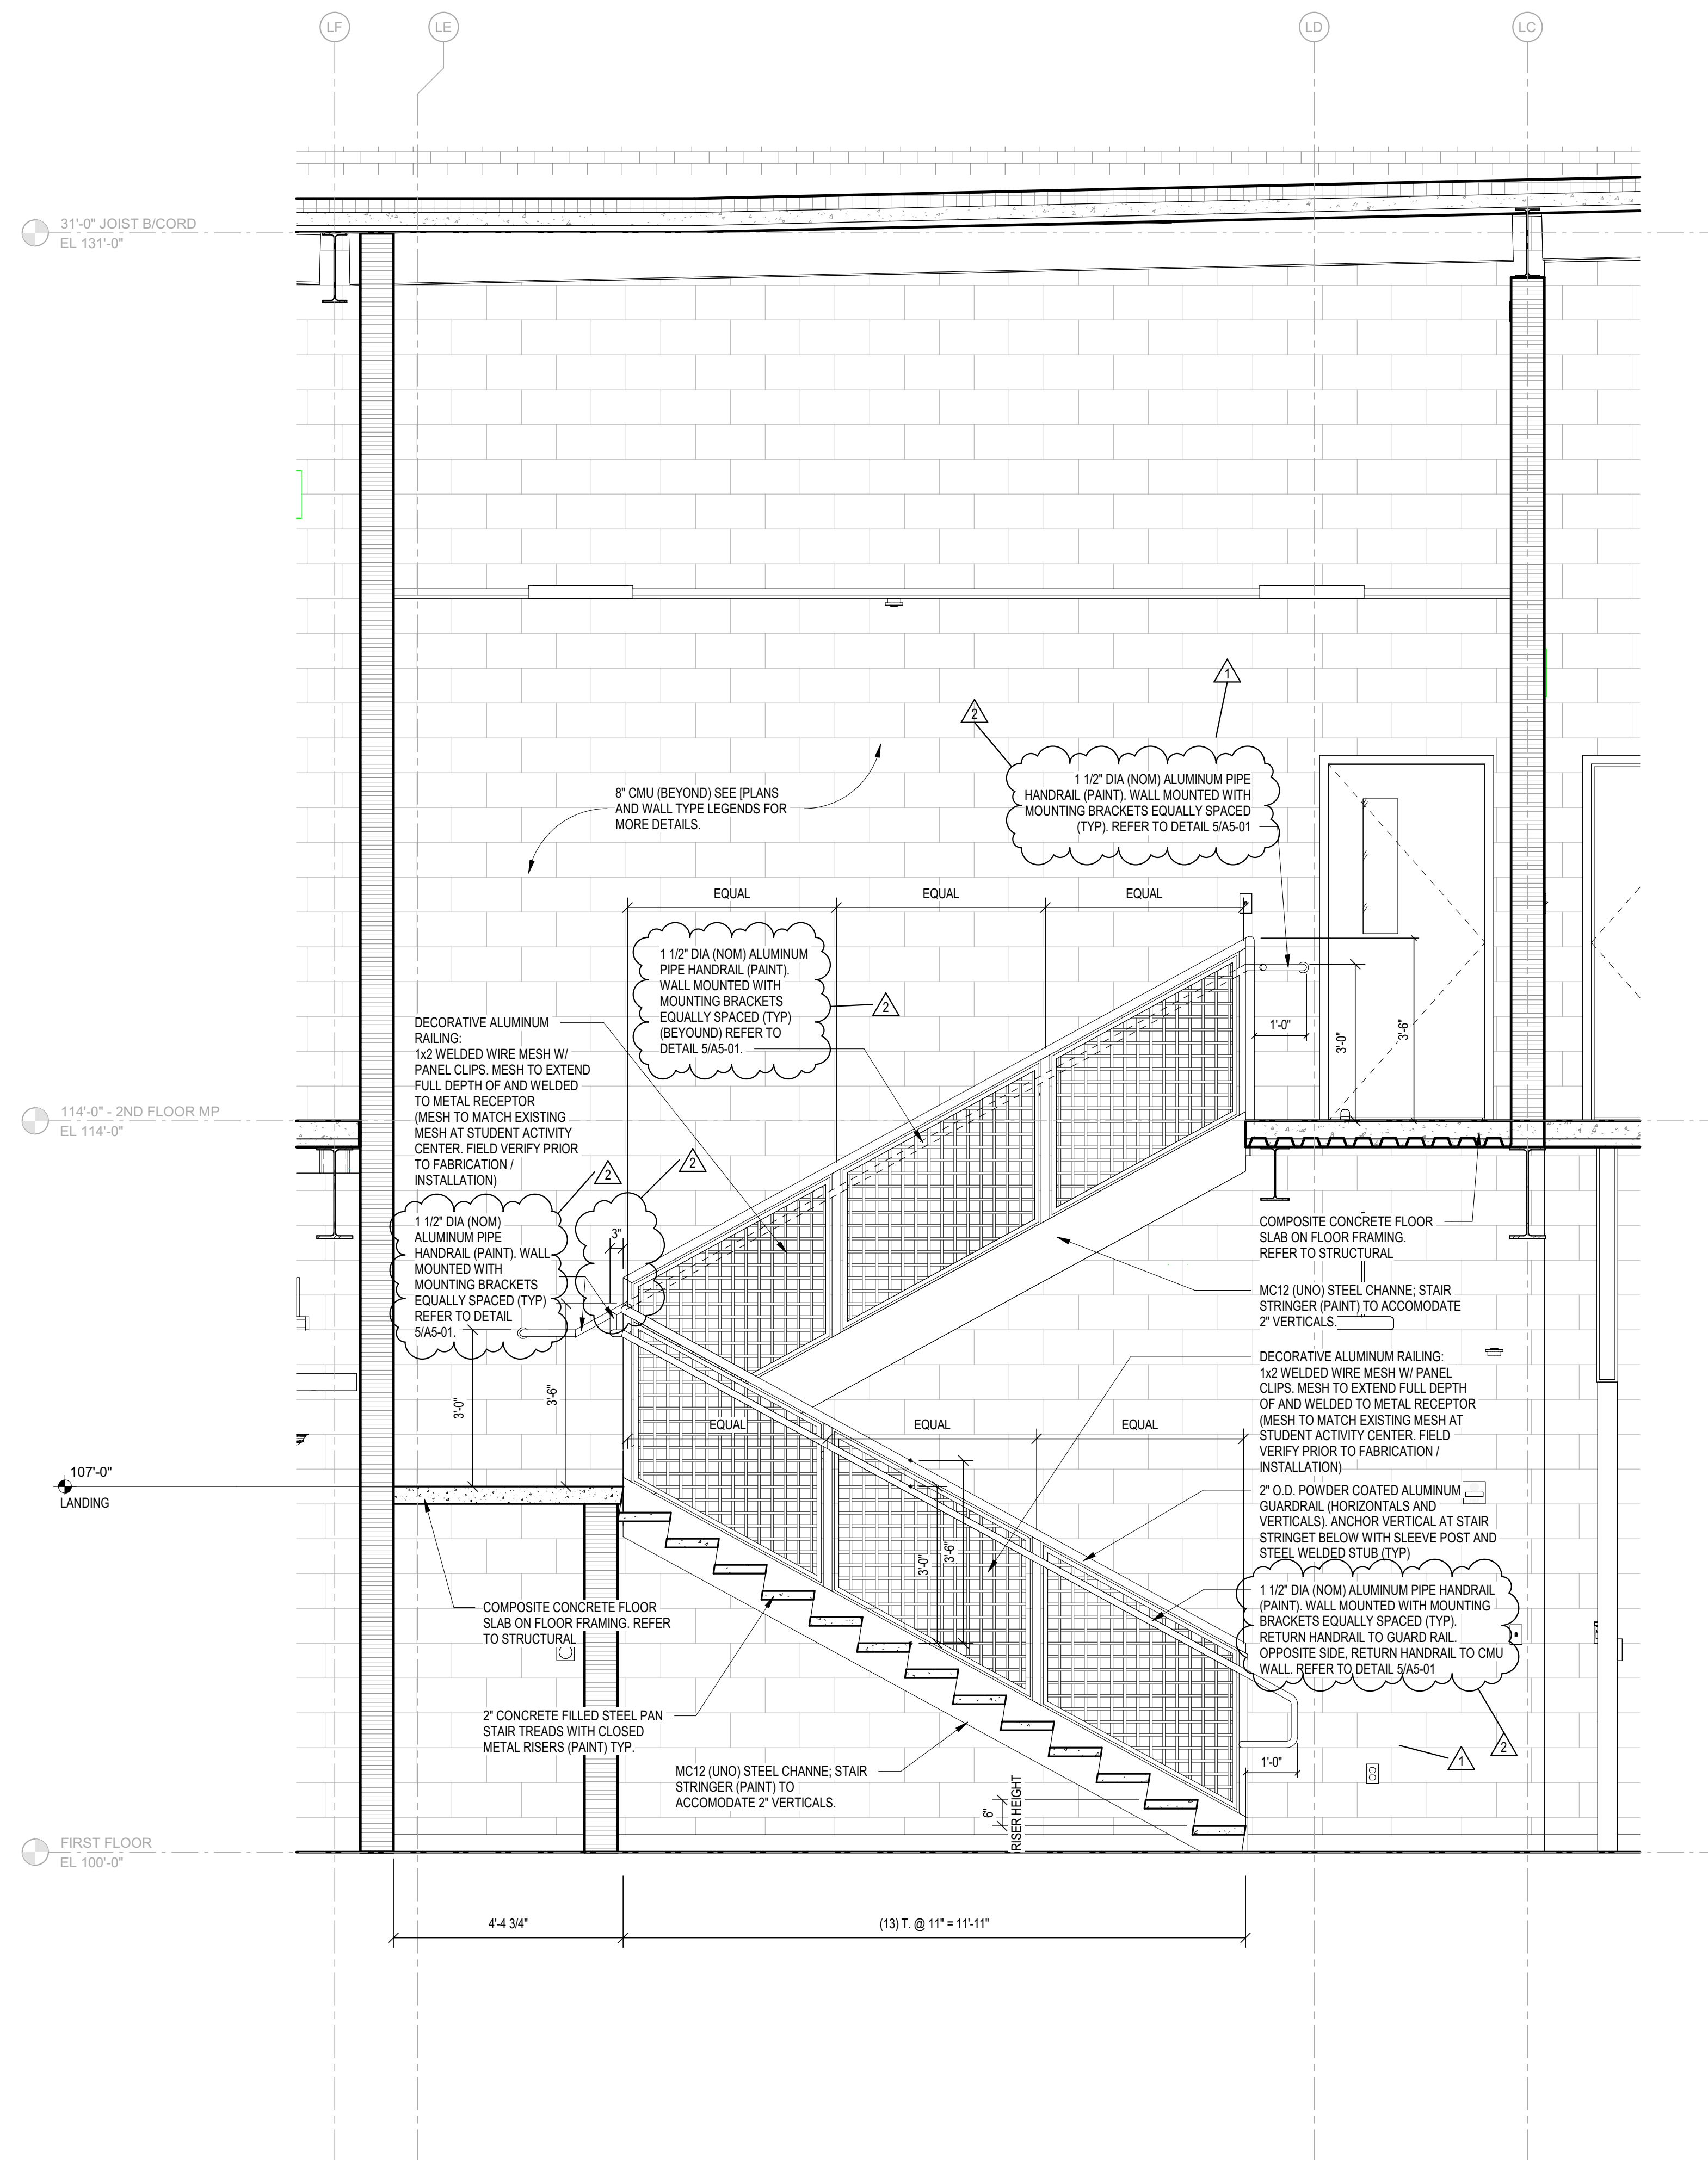
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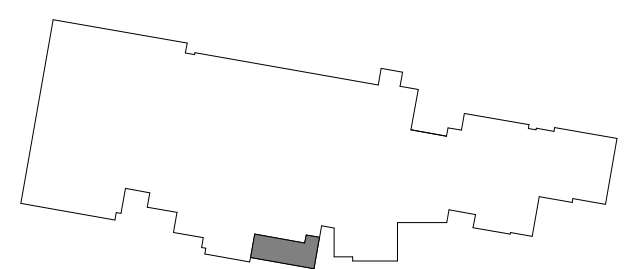
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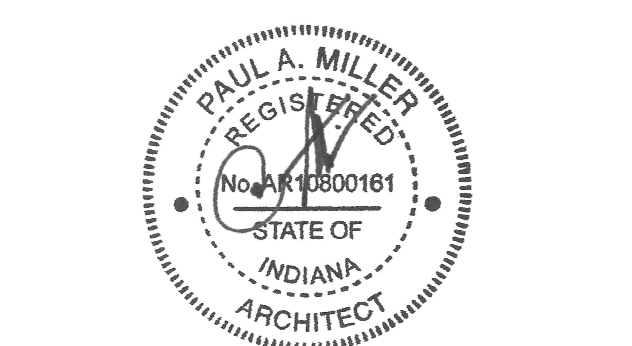
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PROJECT MANAGER: JM
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REV. NO.	DESCRIPTION	DATE
1	ADDENDUM #1	02/11/2025
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VERTICAL CIRCULATION

A3-03

ZIONSVILLE
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SCHOOL ATHLETIC
LOCKER ROOMS
ADDITION AND
RENOVATION

1000 MULBERRY STREET,
ZIONSVILLE, IN 46077


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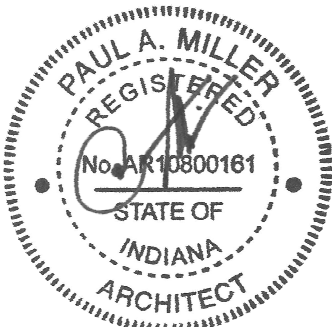


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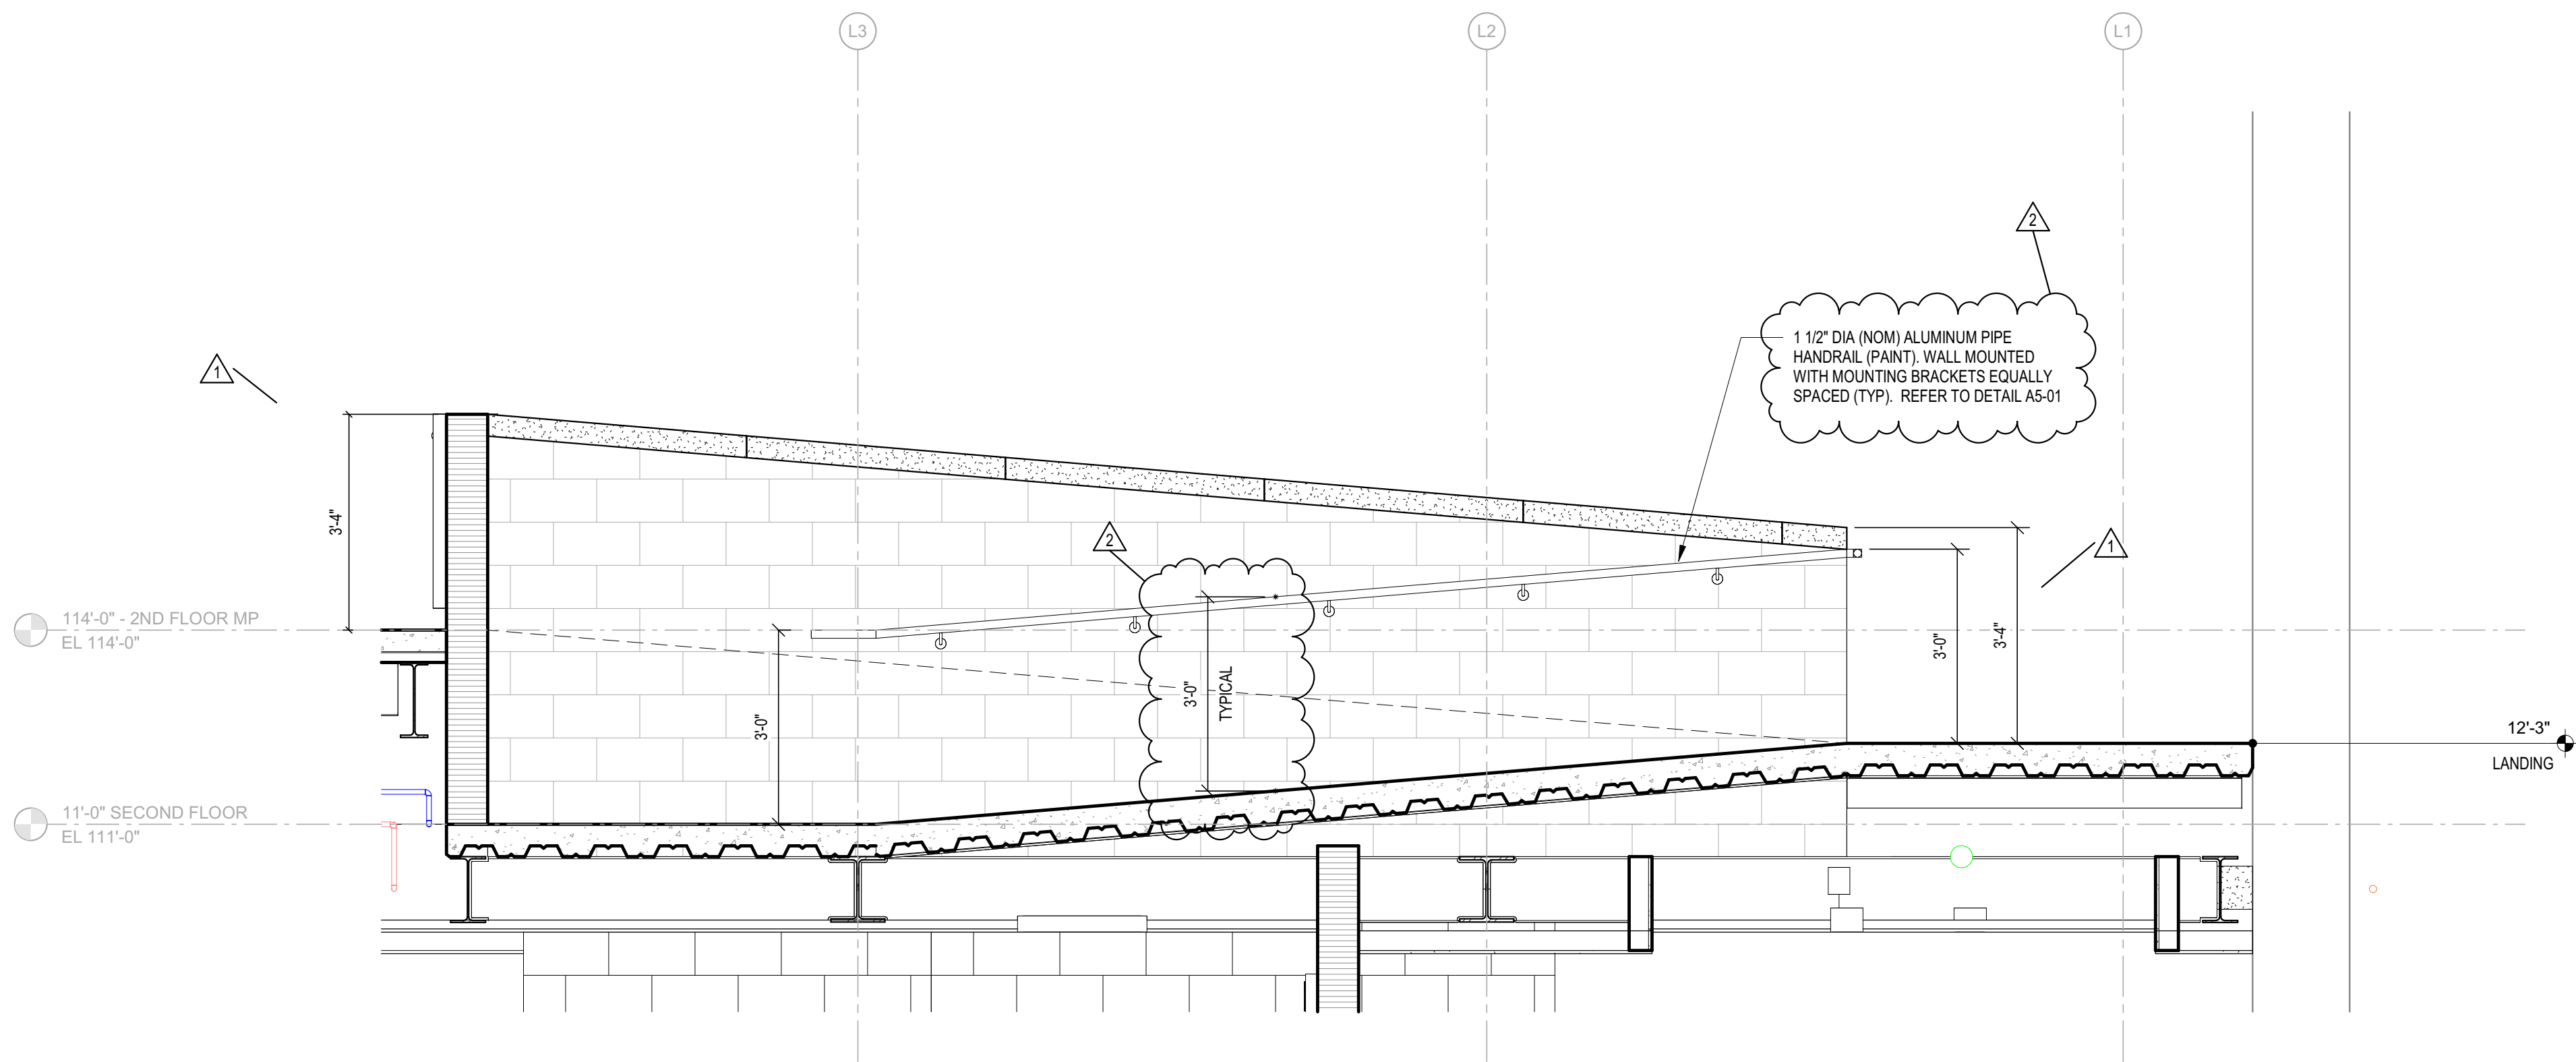


PROJECT MANAGER: JM
DRAWN BY: Author
PROJECT NUMBER: 224018.00
PROJECT ISSUE DATE: 01/21/2025


REV. NO.	DESCRIPTION	DATE
1	ADDENDUM #1	02/11/2025
2	ADDENDUM #2	02/18/2025

VERTICAL CIRCULATION

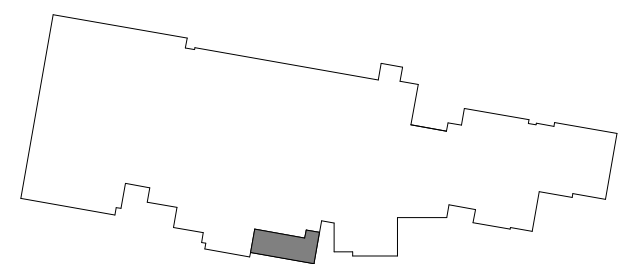A3-04



2 WEST RAMP - SECTION
SCALE: 1/2" = 1'-0"

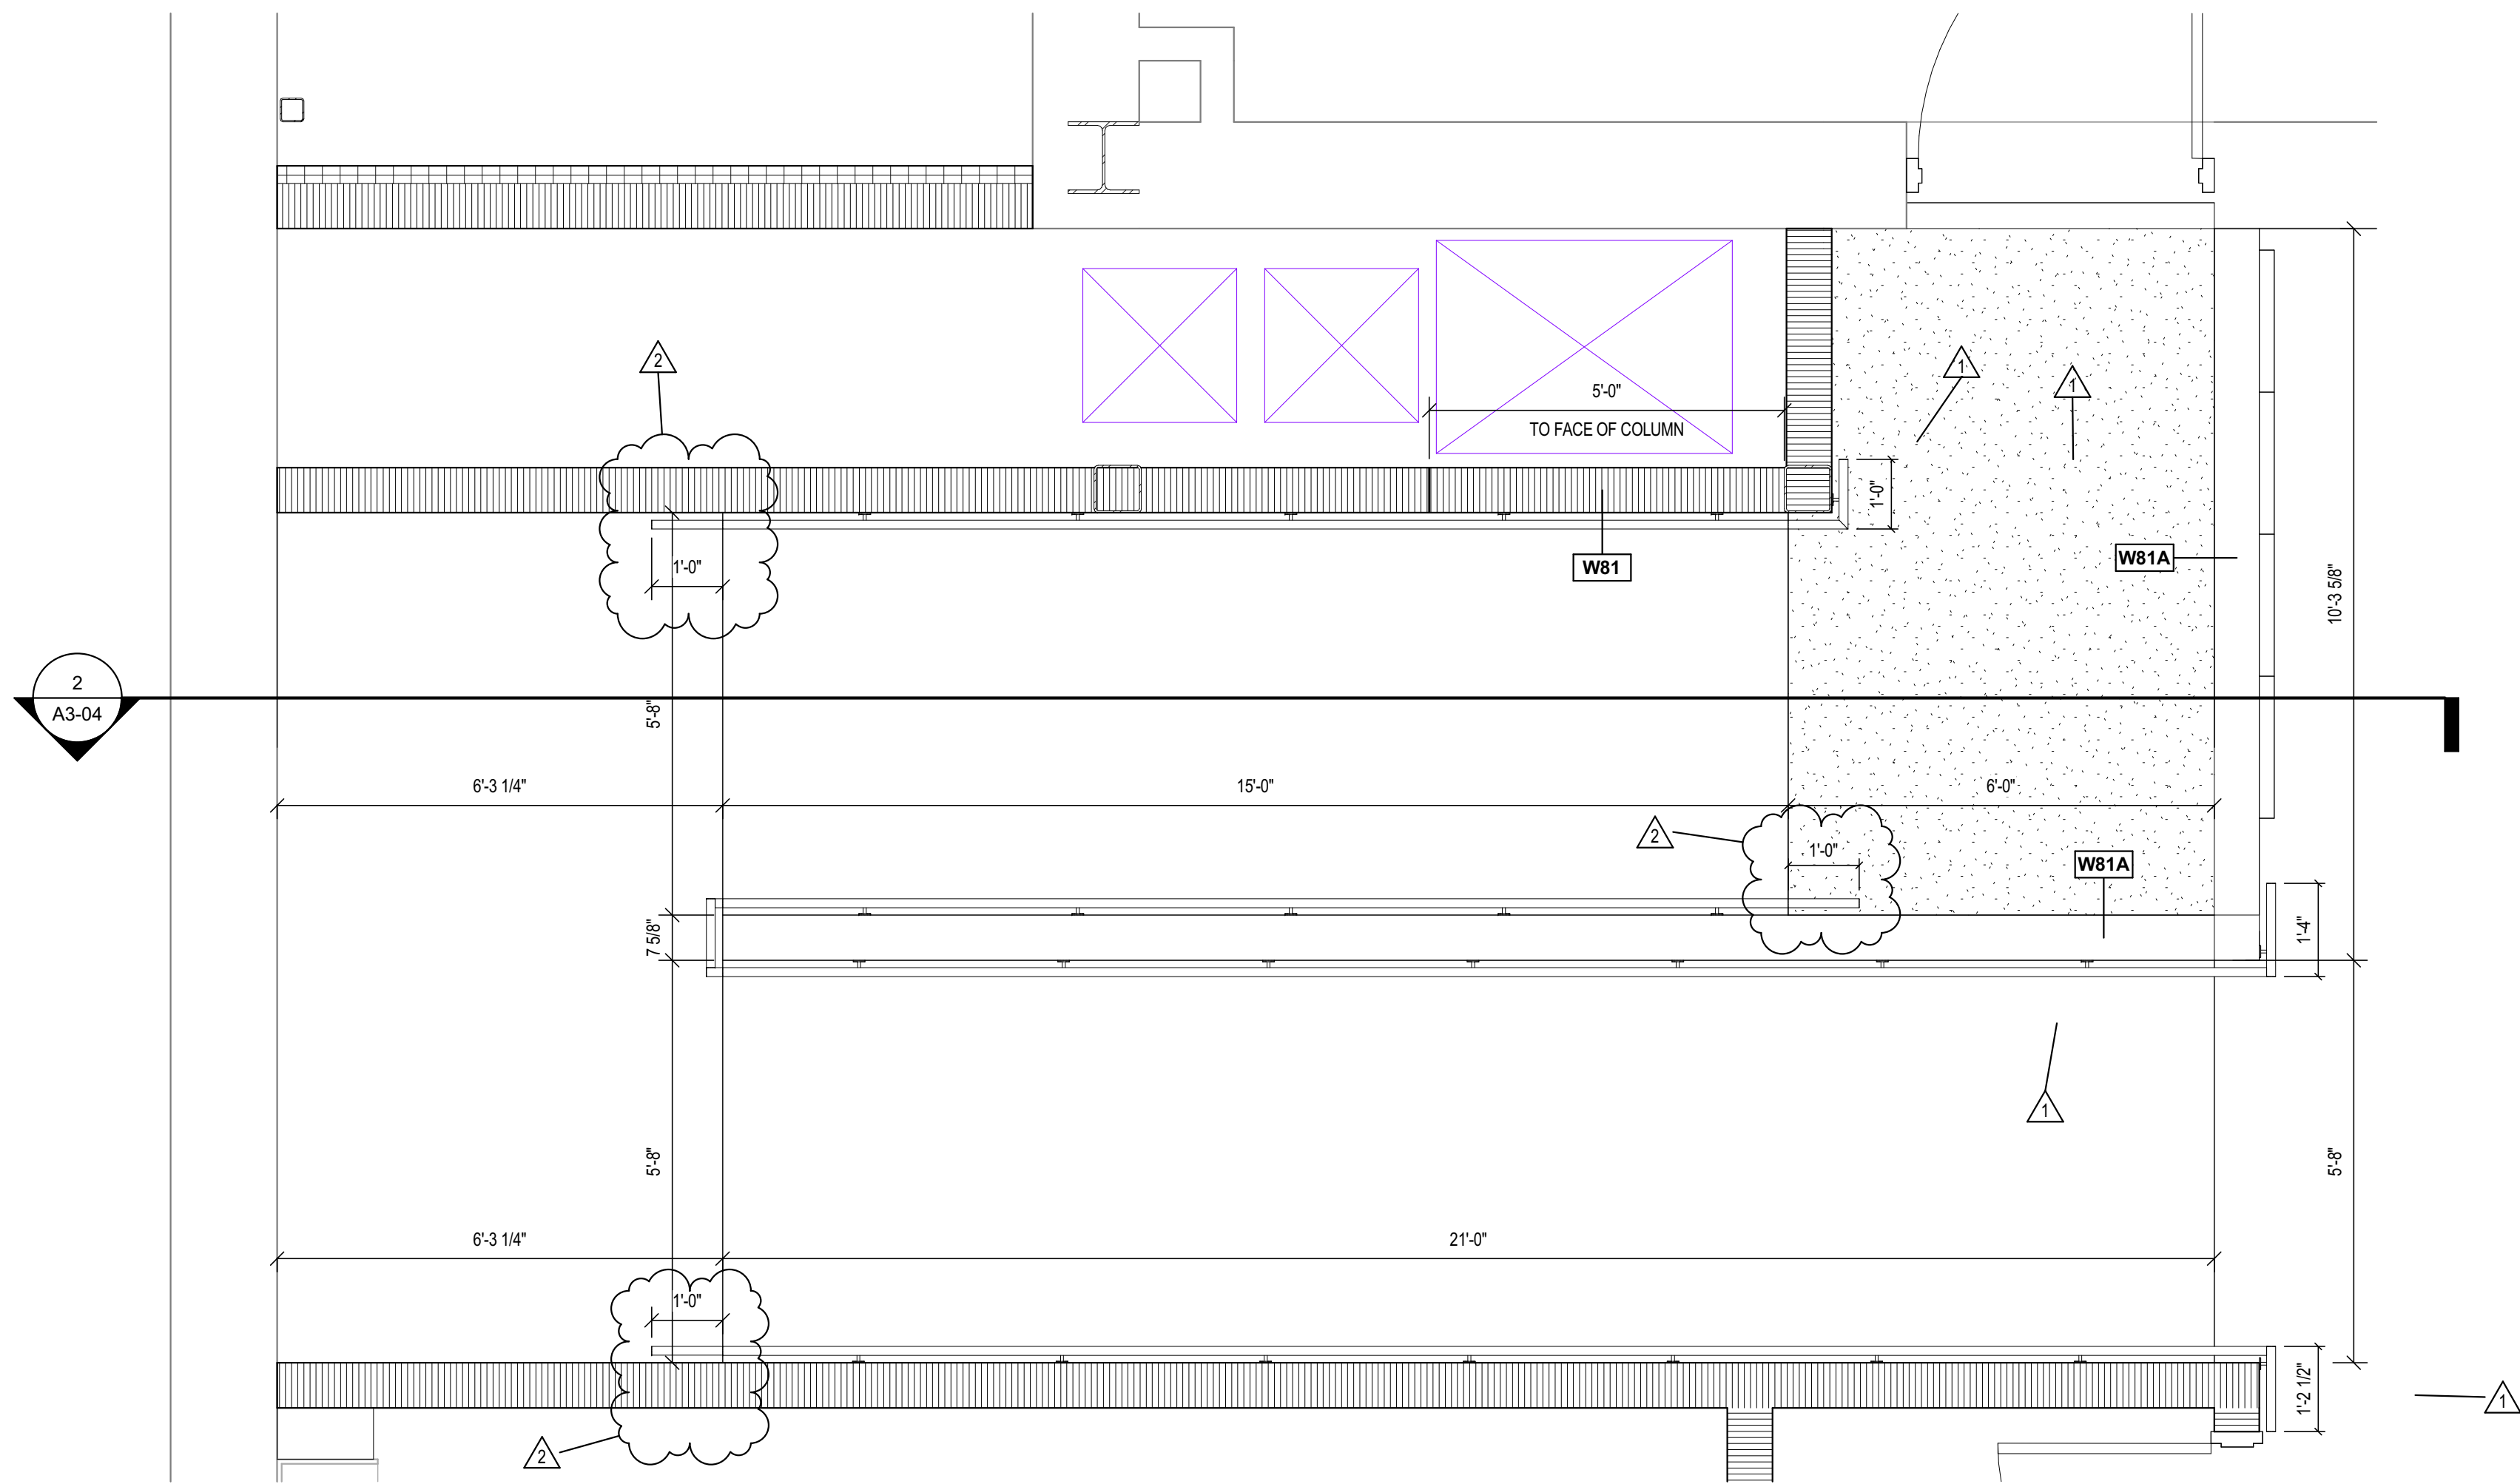

1 A202 - RAMP ENLARGED PLAN
SCALE: 1/2" = 1'-0"

ZIONSVILLE
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LOCKER ROOMS
ADDITION AND
RENOVATION

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ZIONSVILLE, IN 46077


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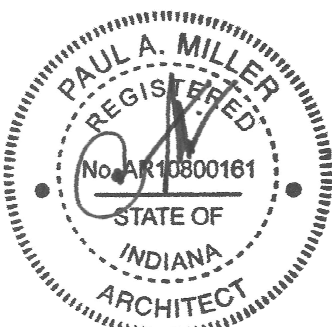


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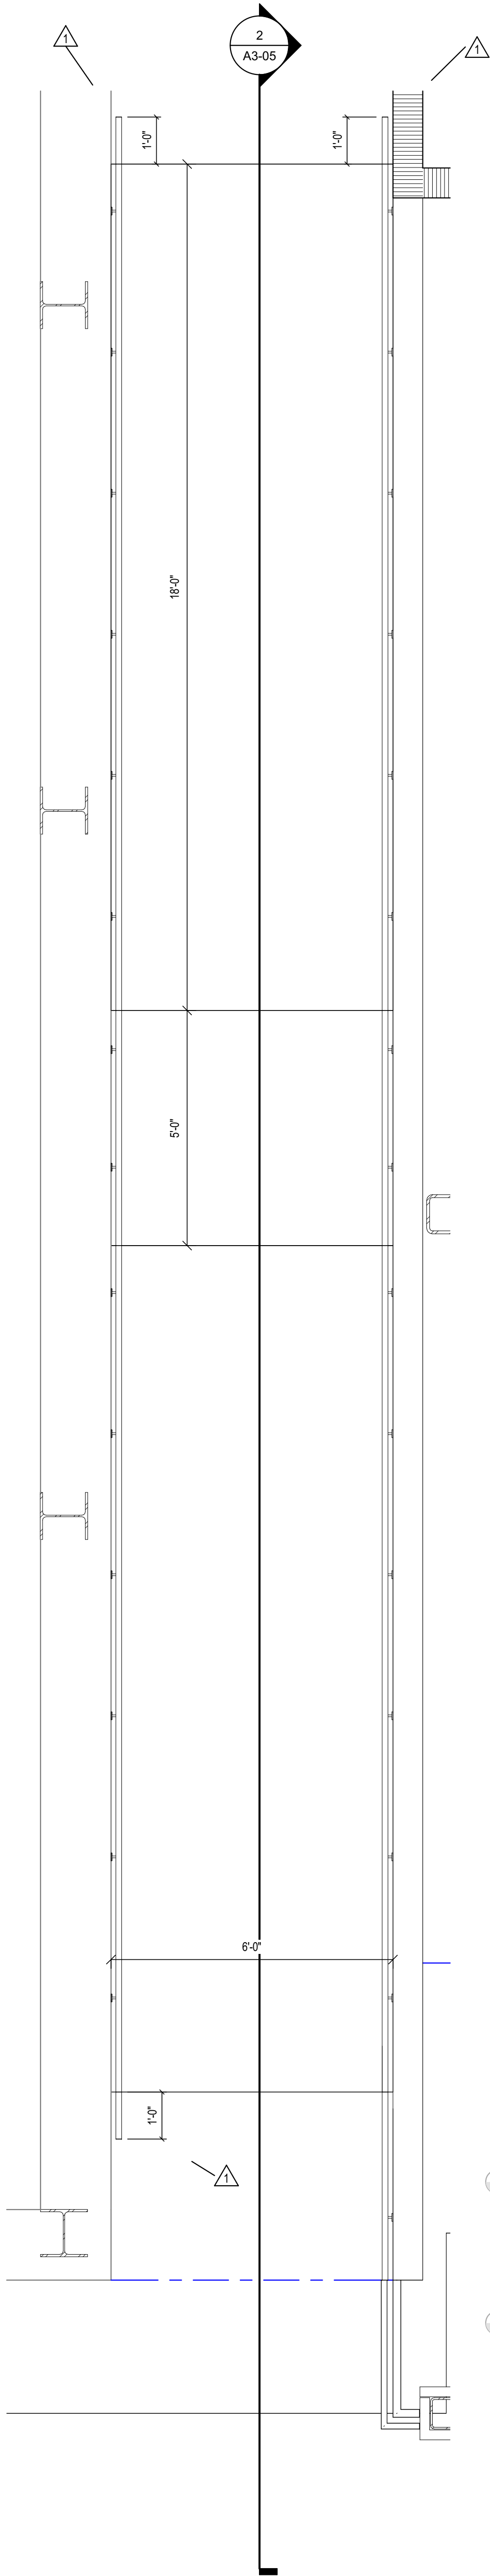


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DRAWN BY: Author
PROJECT NUMBER: 224018.00
PROJECT ISSUE DATE: 01/21/2025


REV. NO.	DESCRIPTION	DATE
1	ADDENDUM #1	02/11/2025
2	ADDENDUM #2	02/18/2025

VERTICAL CIRCULATION

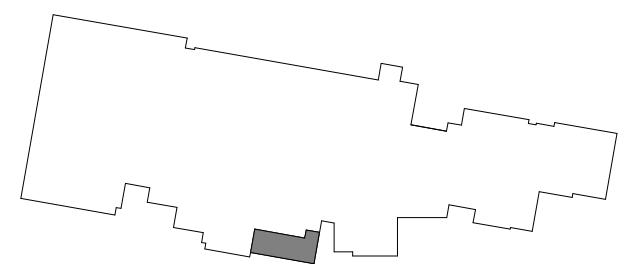A3-05



1 A205 - RAMP ENLARGED PLAN
SCALE: 1/2" = 1'-0"

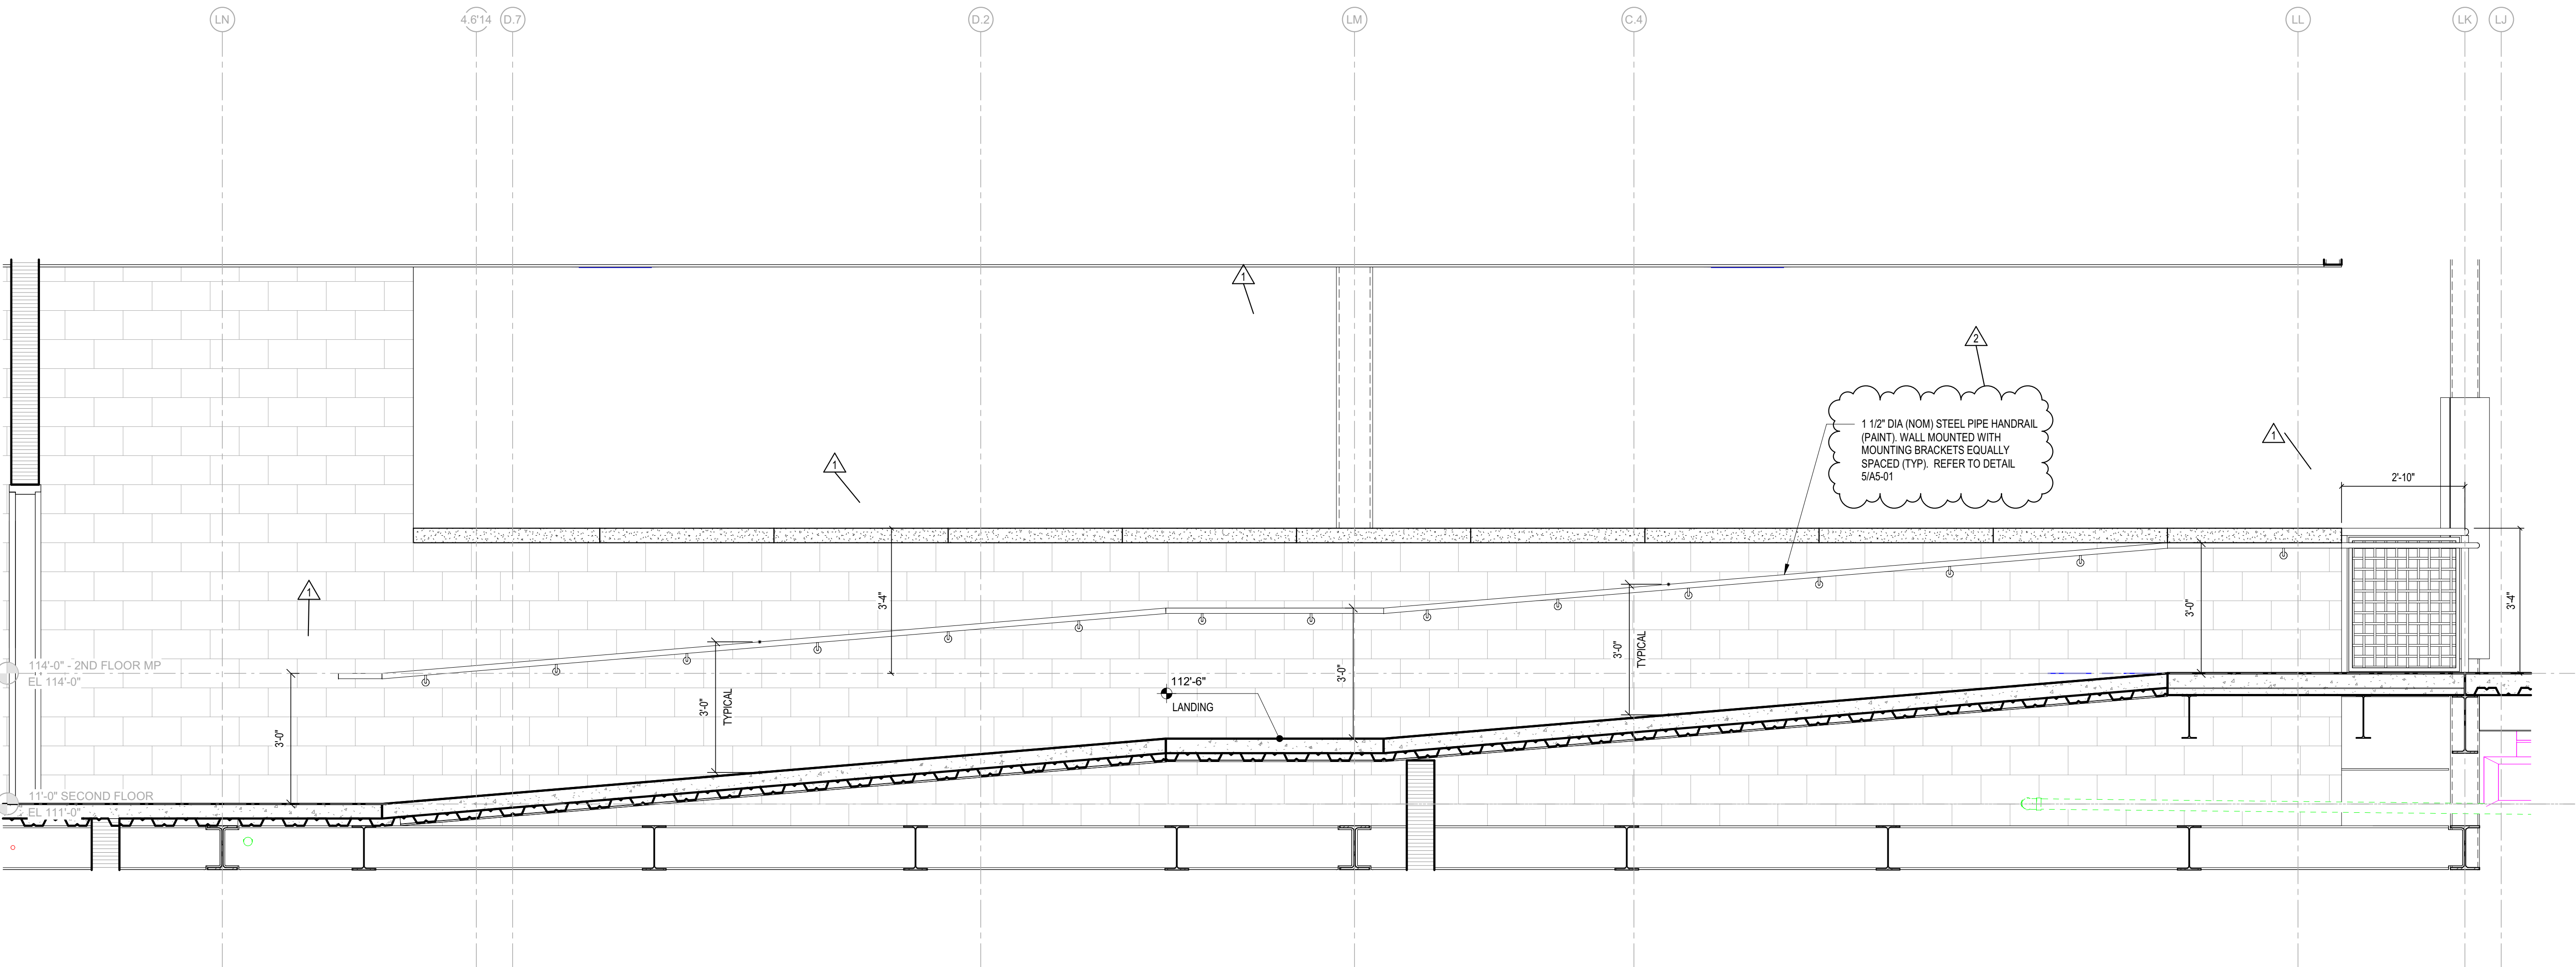

2 RAMP SECTION
SCALE: 1/2" = 1'-0"

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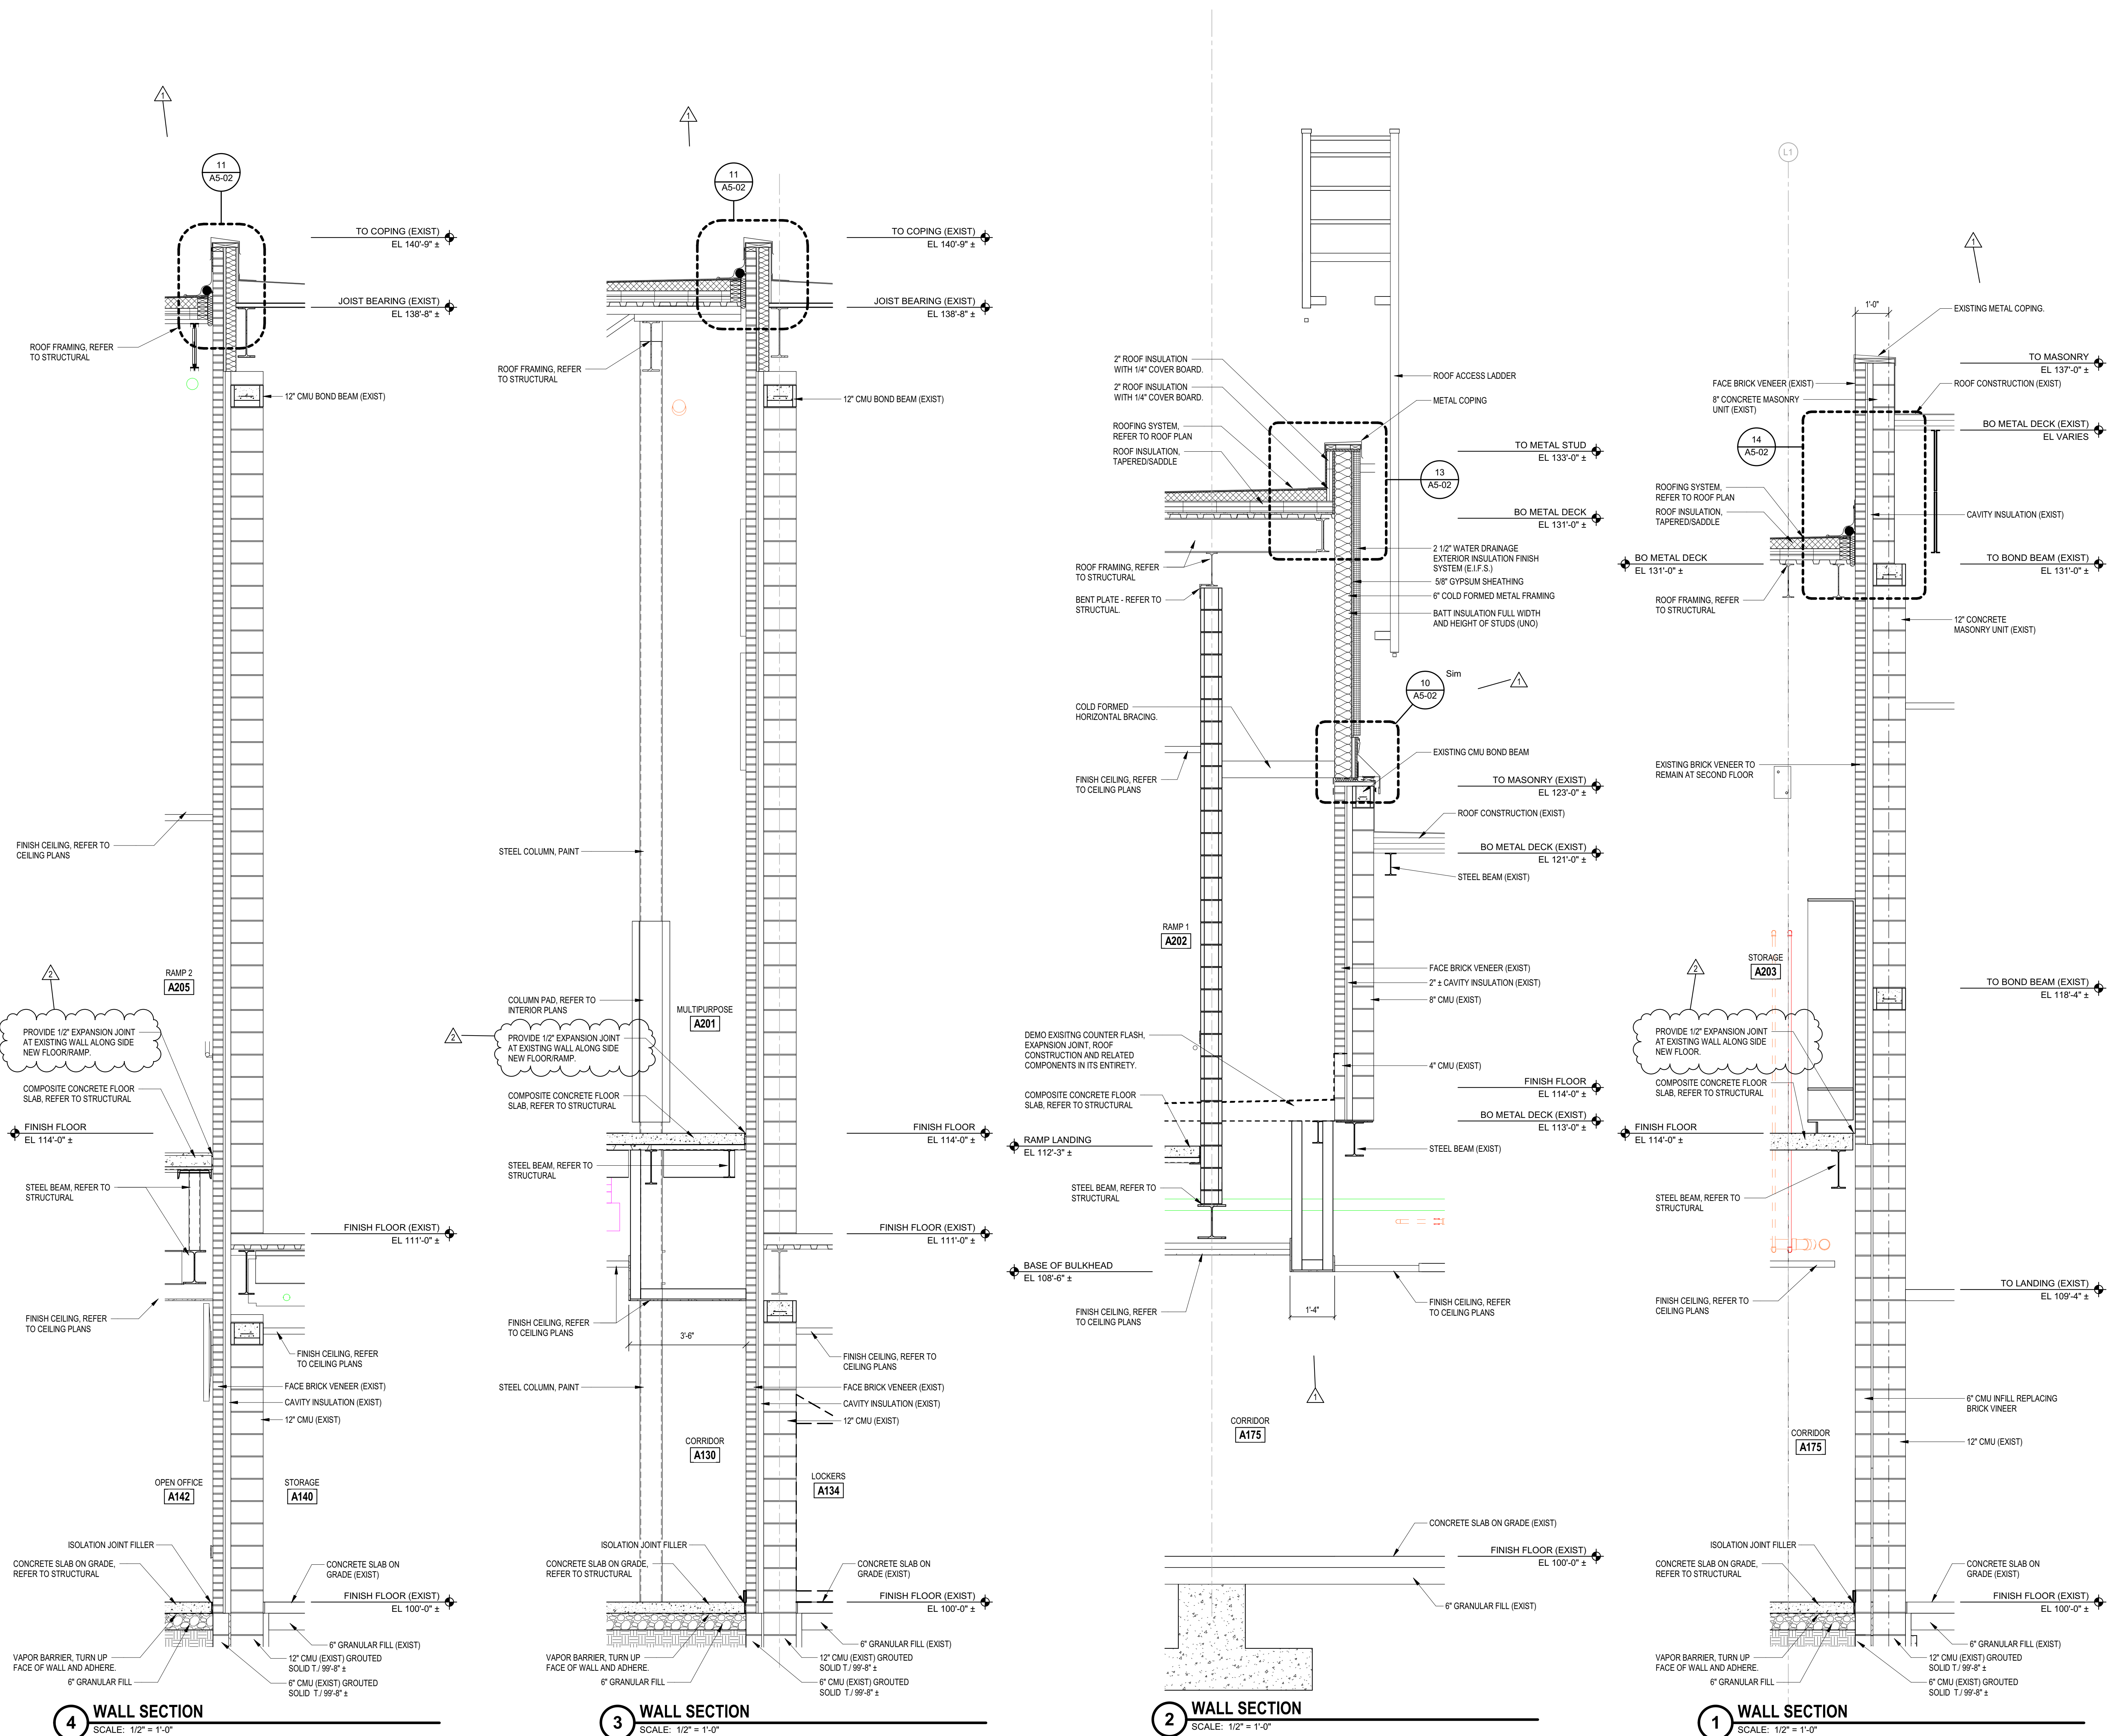
- A. COORDINATE ALL LINTEL AND BOND BEEB REQUIREMENTS WITH STRUCTURAL DRAWINGS AND PROJECT MANUAL.
- B. REFER TO THE STRUCTURAL DRAWINGS FOR ALL FOUNDATION AND FOOTING CONDITIONS.
- C. PROVIDE HORIZ. JOINT REINFORCING, TIES, AND OTHER ANCHORAGE/REINFORCEMENT ITEMS AS REQ'D. PER PROJECT MANUAL.
- D. PROVIDE EXTERIOR WALL JUNCTIONS: REFER TO DIVISION 07 SECTION "THERMAL INSULATION" FOR SPRAY POLYURETHANE INSULATION REQUIRED AT THESE LOCATIONS.
- E. WALL INSULATION PENETRATIONS: PROVIDE SPRAY POLYURETHANE INSULATION OR SEALANT AROUND ALL PENETRATIONS OF THE WALL INSULATION BY PIPING, CONDUITS, FRAMING, STRUCTURE, ETC.

(ALL NOTES MAY NOT BE INDICATED ON THIS SHEET)



CONTRACTOR SHALL VERIFY ALL DIMENSIONS AND CLEARANCES AND ALL EXISTING FIELD CONDITIONS BEFORE STARTING CONSTRUCTION. COMMENCEMENT OF WORK CONSTITUTES ACCEPTANCE OF CONDITIONS.


SHOULD DIFFERENT CONDITIONS BE ENCOUNTERED, CONTACT THE ARCHITECT BEFORE PROCEEDING WITH WORK.



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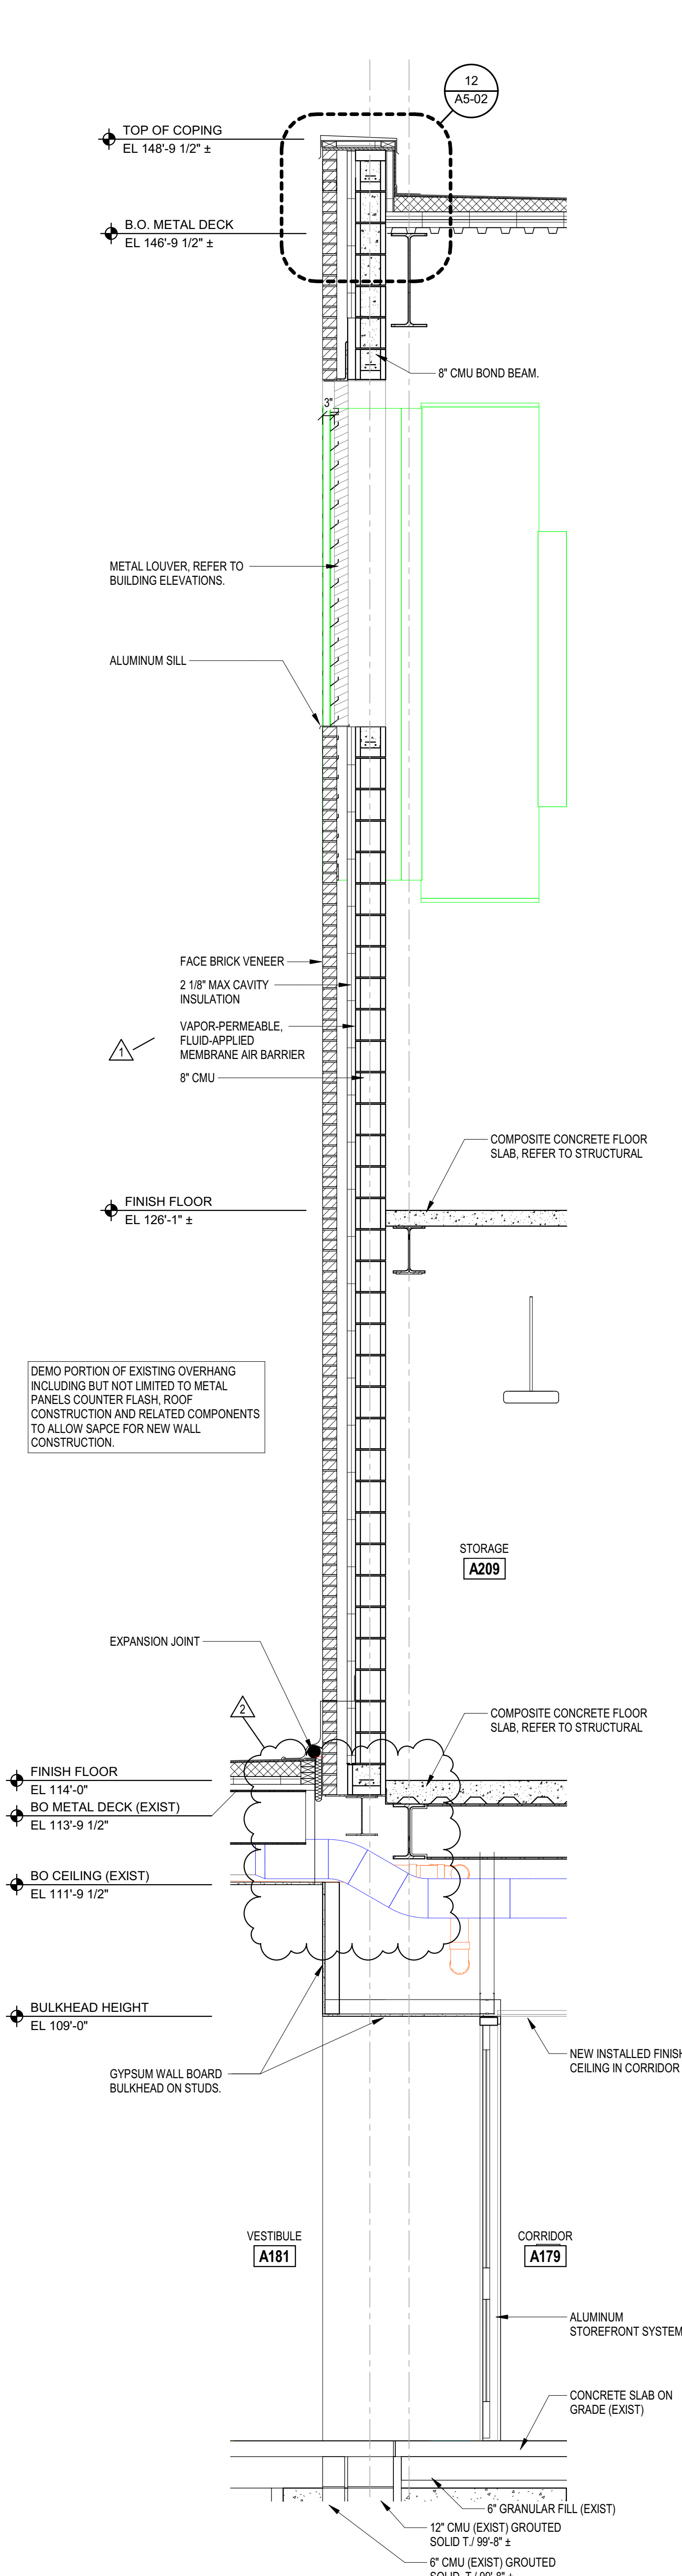
4 WALL SECTION

SCALE: 1/2" = 1'-0"

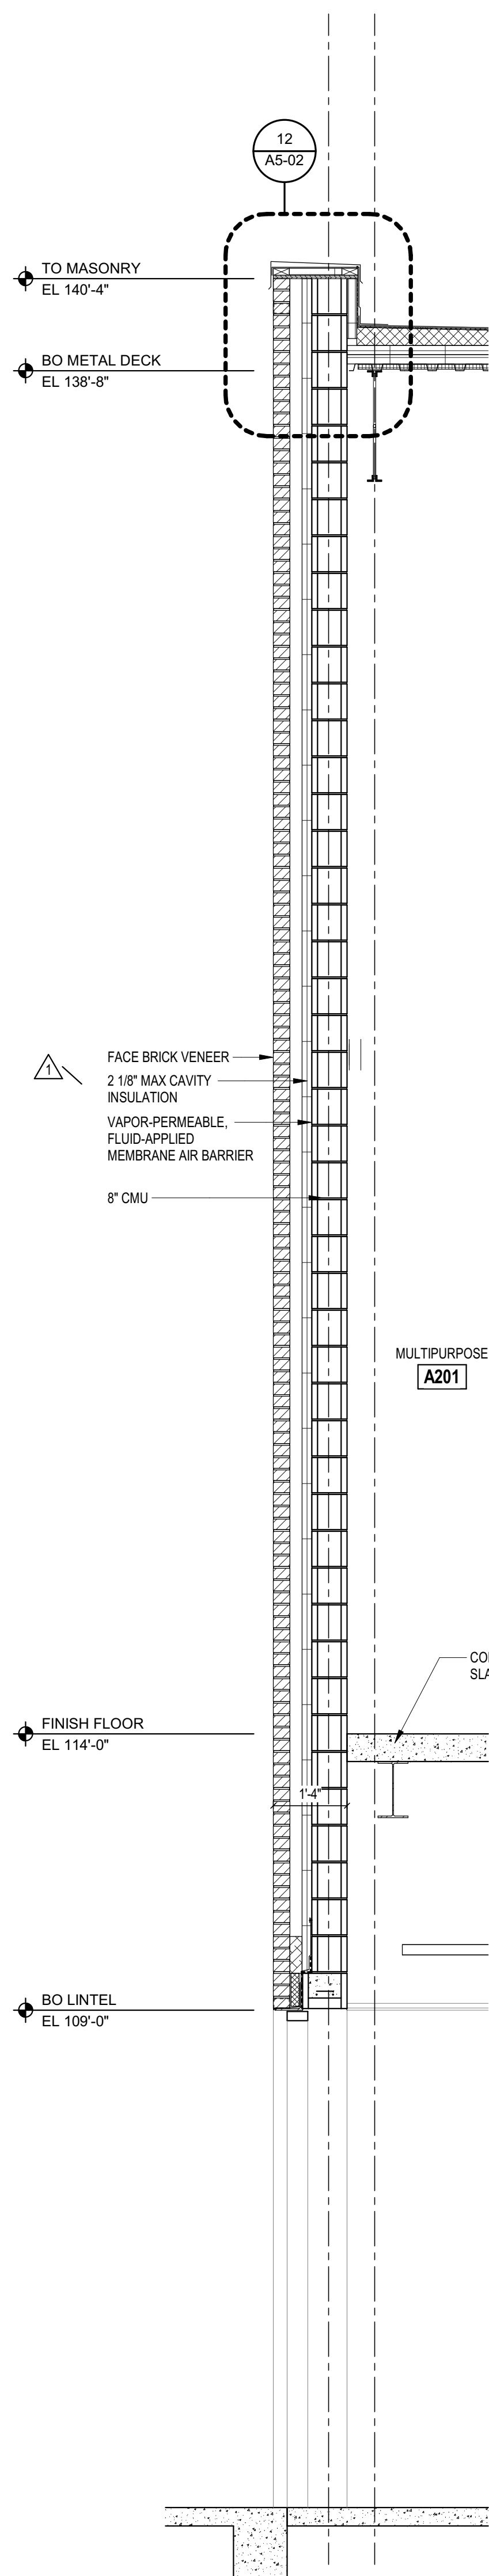


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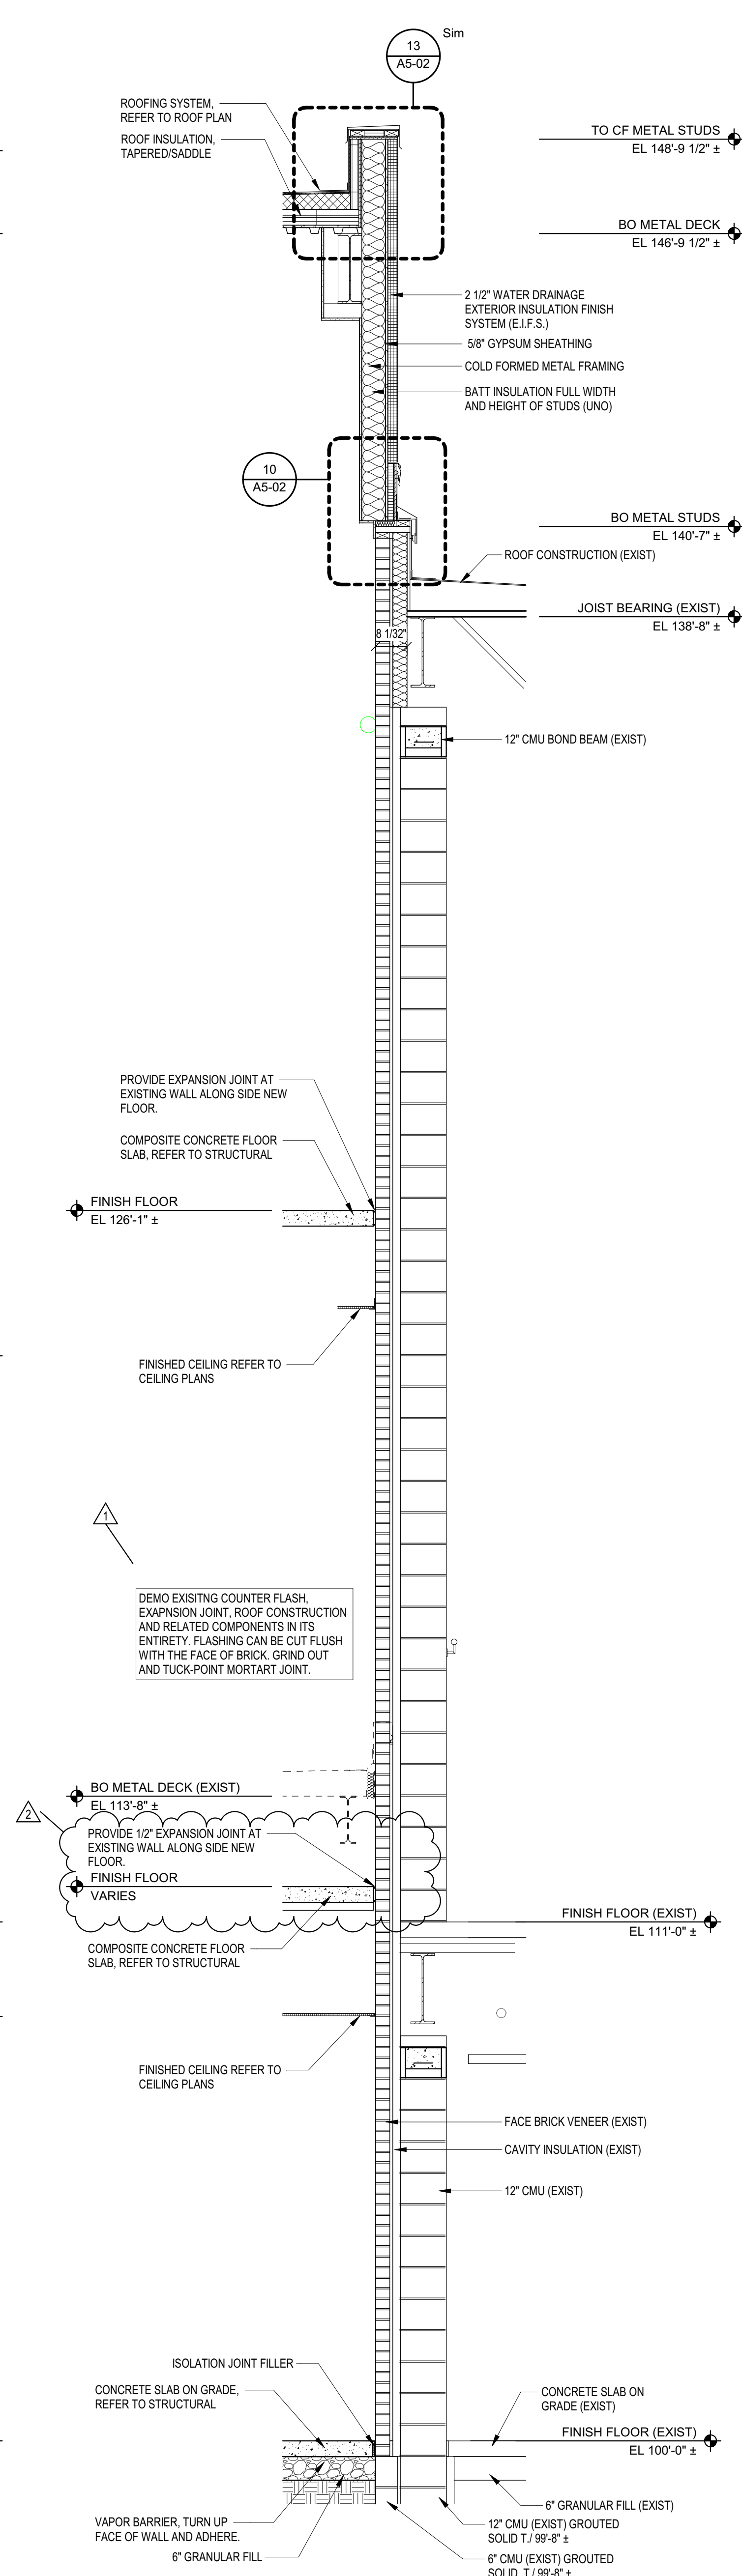
2 WALL SECTION

SCALE: 1/2" = 1'-0"



1 WALL SECTION

SCALE: 1/2" = 1'-0"

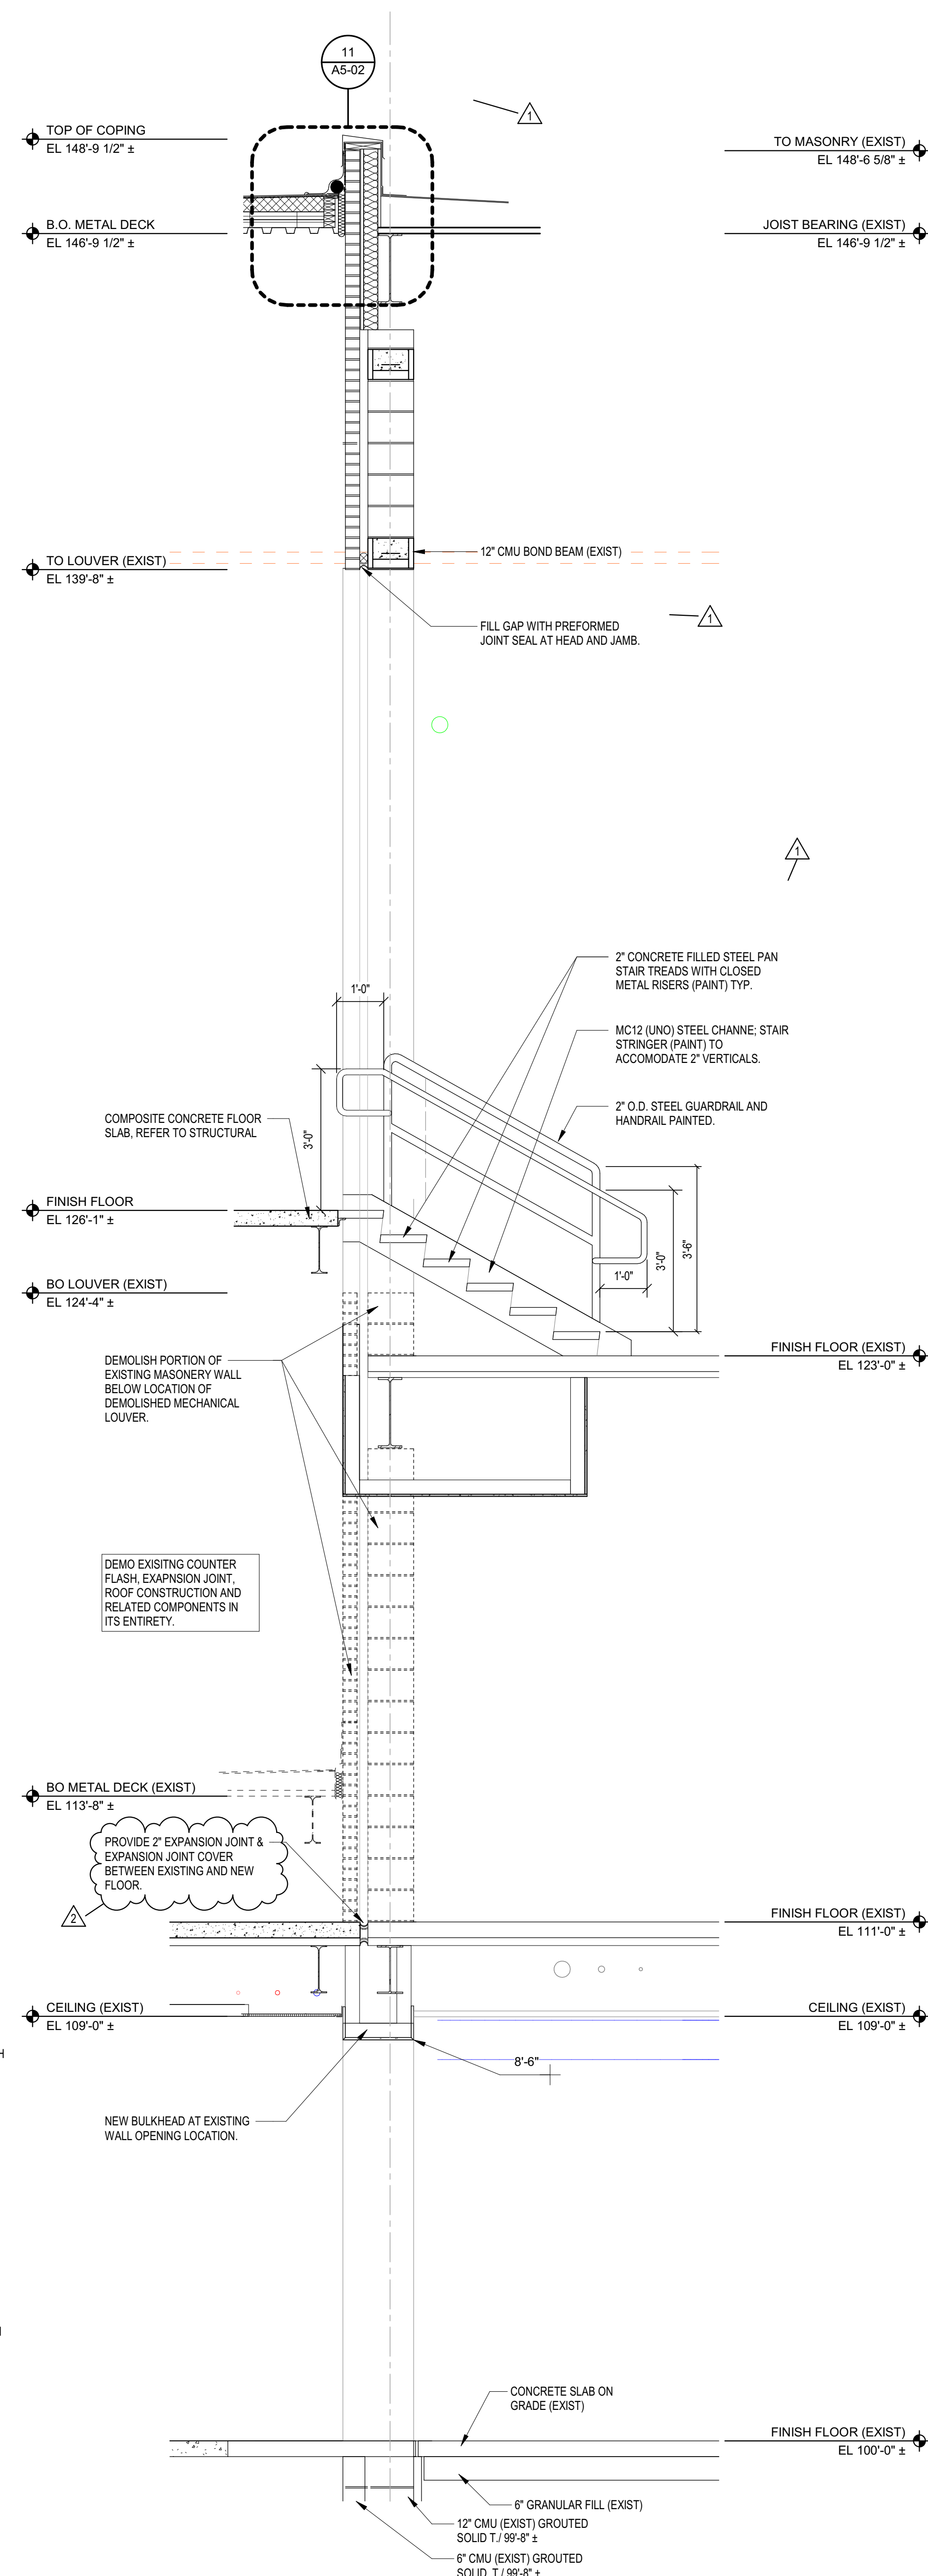

GENERAL NOTES

- COORDINATE ALL LINTEL AND BOND BEAM REQUIREMENTS WITH STRUCTURAL DRAWINGS AND PROJECT MANUAL. REFER TO THE STRUCTURAL DRAWINGS FOR ALL FOUNDATION AND FOOTING CONDITIONS.
- PROVIDE HORIZ. JOINT REINFORCING, TIES, AND OTHER ANCHORAGE/REINFORCEMENT ITEMS AS REQ'D. PER PROJECT MANUAL.
- ROOF TO EXTERIOR WALL JUNCTIONS: REFER TO DIVISION 07 SECTION THERMAL INSULATION FOR SPRAY POLYURETHANE INSULATION REQUIRED AT THESE LOCATIONS.
- WALL INSULATION PENETRATIONS: PROVIDE SPRAY POLYURETHANE INSULATION OR SEALANT AROUND ALL PENETRATIONS OF THE WALL INSULATION BY PIPING, CONDUITS, FRAMING, STRUCTURE, ETC.

WALL SECTION NOTES

(ALL NOTES MAY NOT BE INDICATED ON THIS SHEET)

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ZIONSVILLE COMMUNITY SCHOOLS



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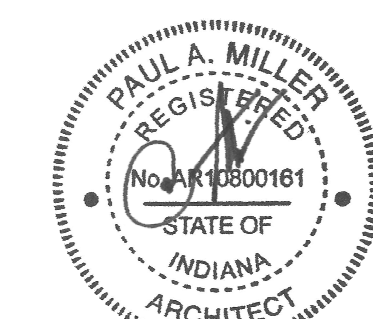
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KEY PLAN



ISSUED FOR BID




PROJECT MANAGER: JM
DRAWN BY: BMD
PROJECT NUMBER: 224018.00
PROJECT ISSUE DATE: 01/21/2025

REV. NO.	DESCRIPTION	DATE
1	ADDENDUM #1	02/11/2025
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WALL SECTIONS

A3-11

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GENERAL NOTES

- A. COORDINATE ALL LINTEL AND BOND BEAM REQUIREMENTS WITH STRUCTURAL DRAWINGS AND PROJECT MANUAL.
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WALL SECTION NOTES
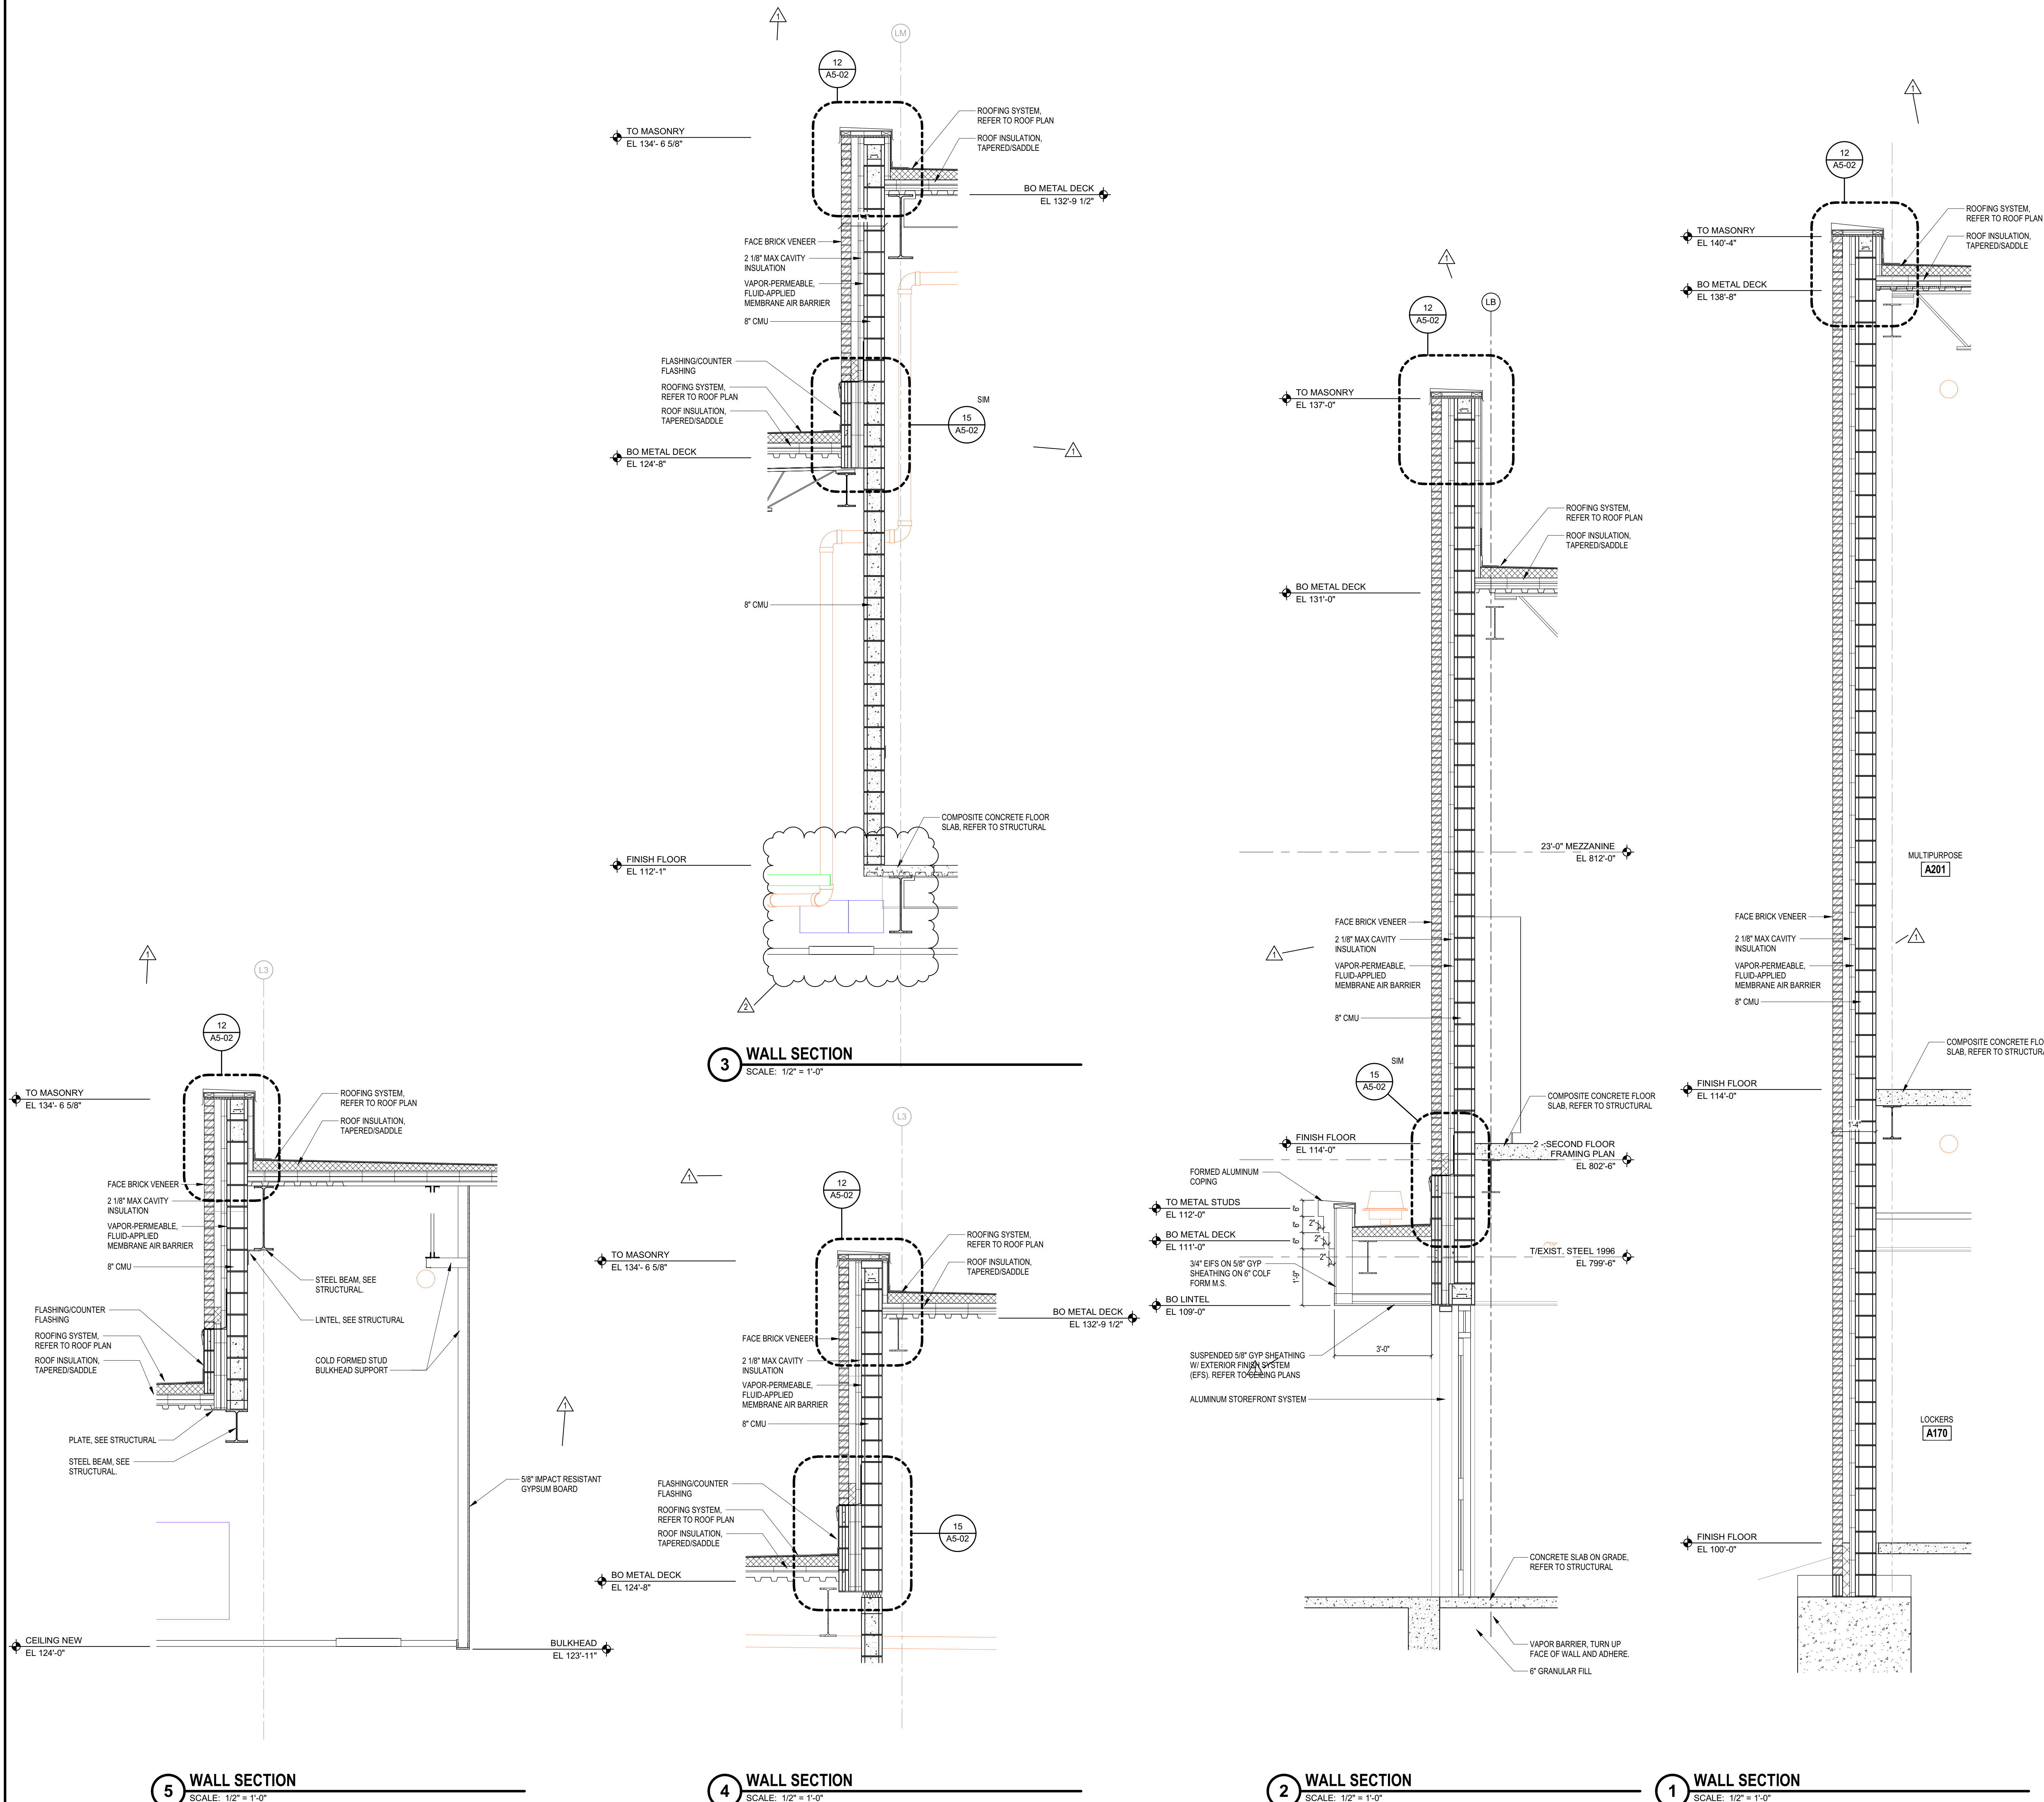
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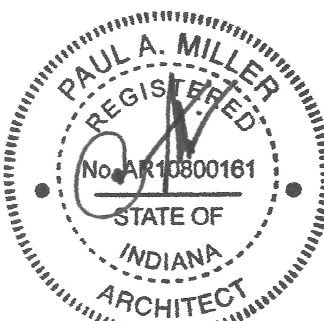
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KEY PLAN

ISSUED FOR BID



PROJECT MANAGER: JM

DRAWN BY: BMD

PROJECT NUMBER: 224018.00

PROJECT ISSUE DATE: 01/21/2025

REV. NO.	DESCRIPTION	DATE
1	ADDENDUM #1	02/11/2025
2	ADDENDUM #2	02/18/2025

WALL SECTIONS

A3-12


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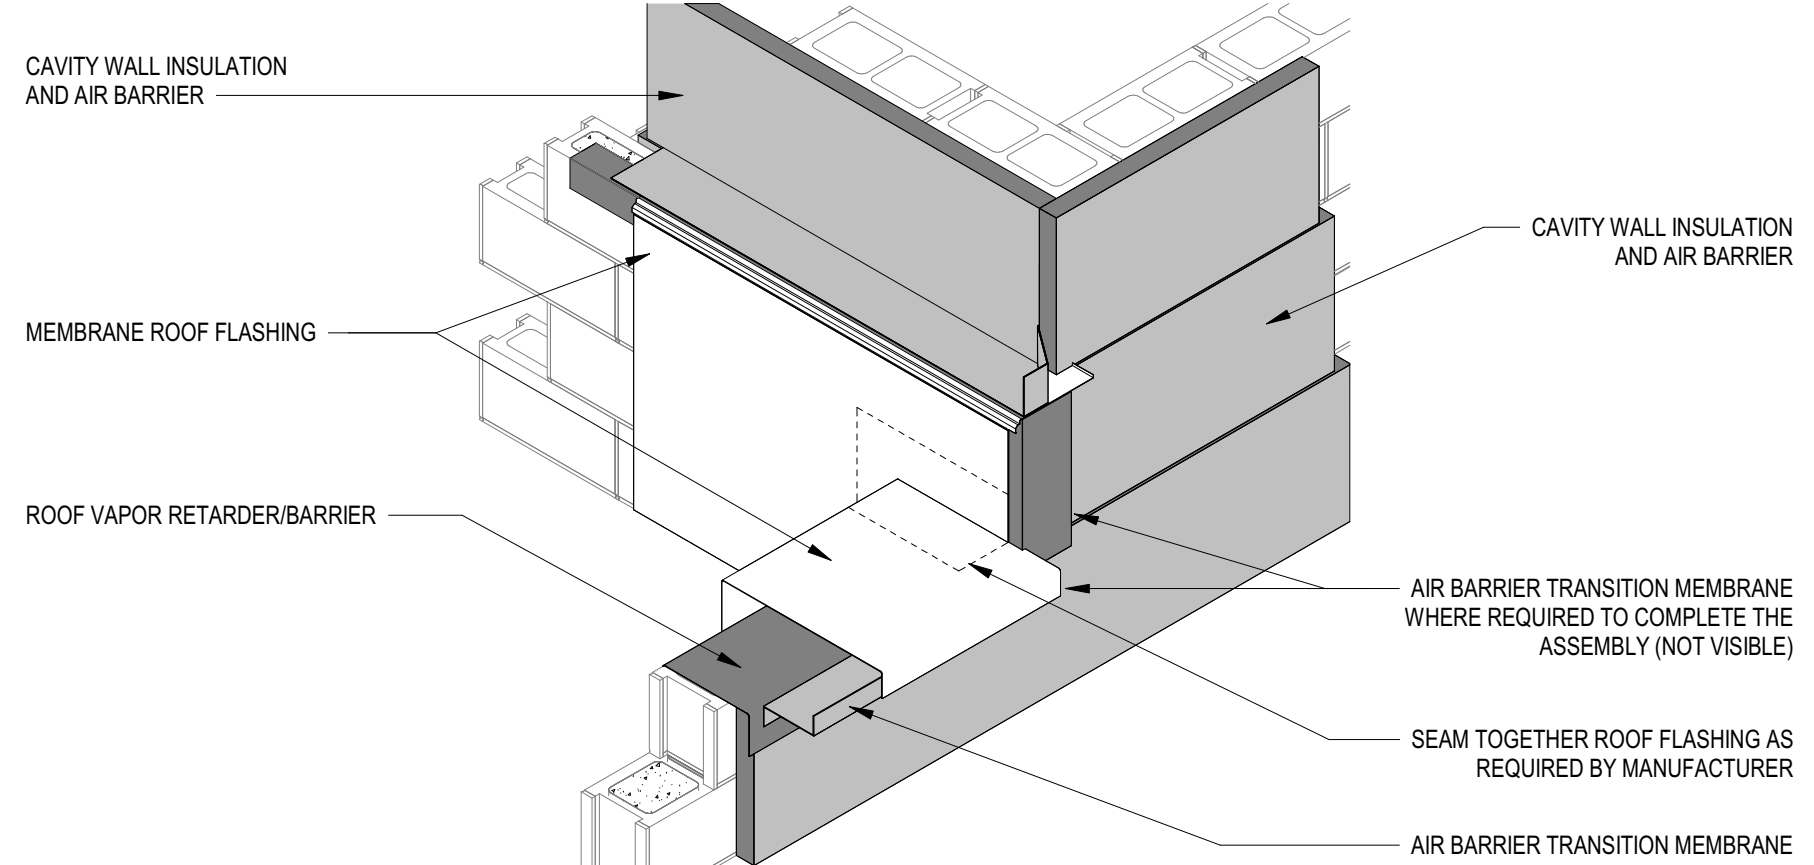
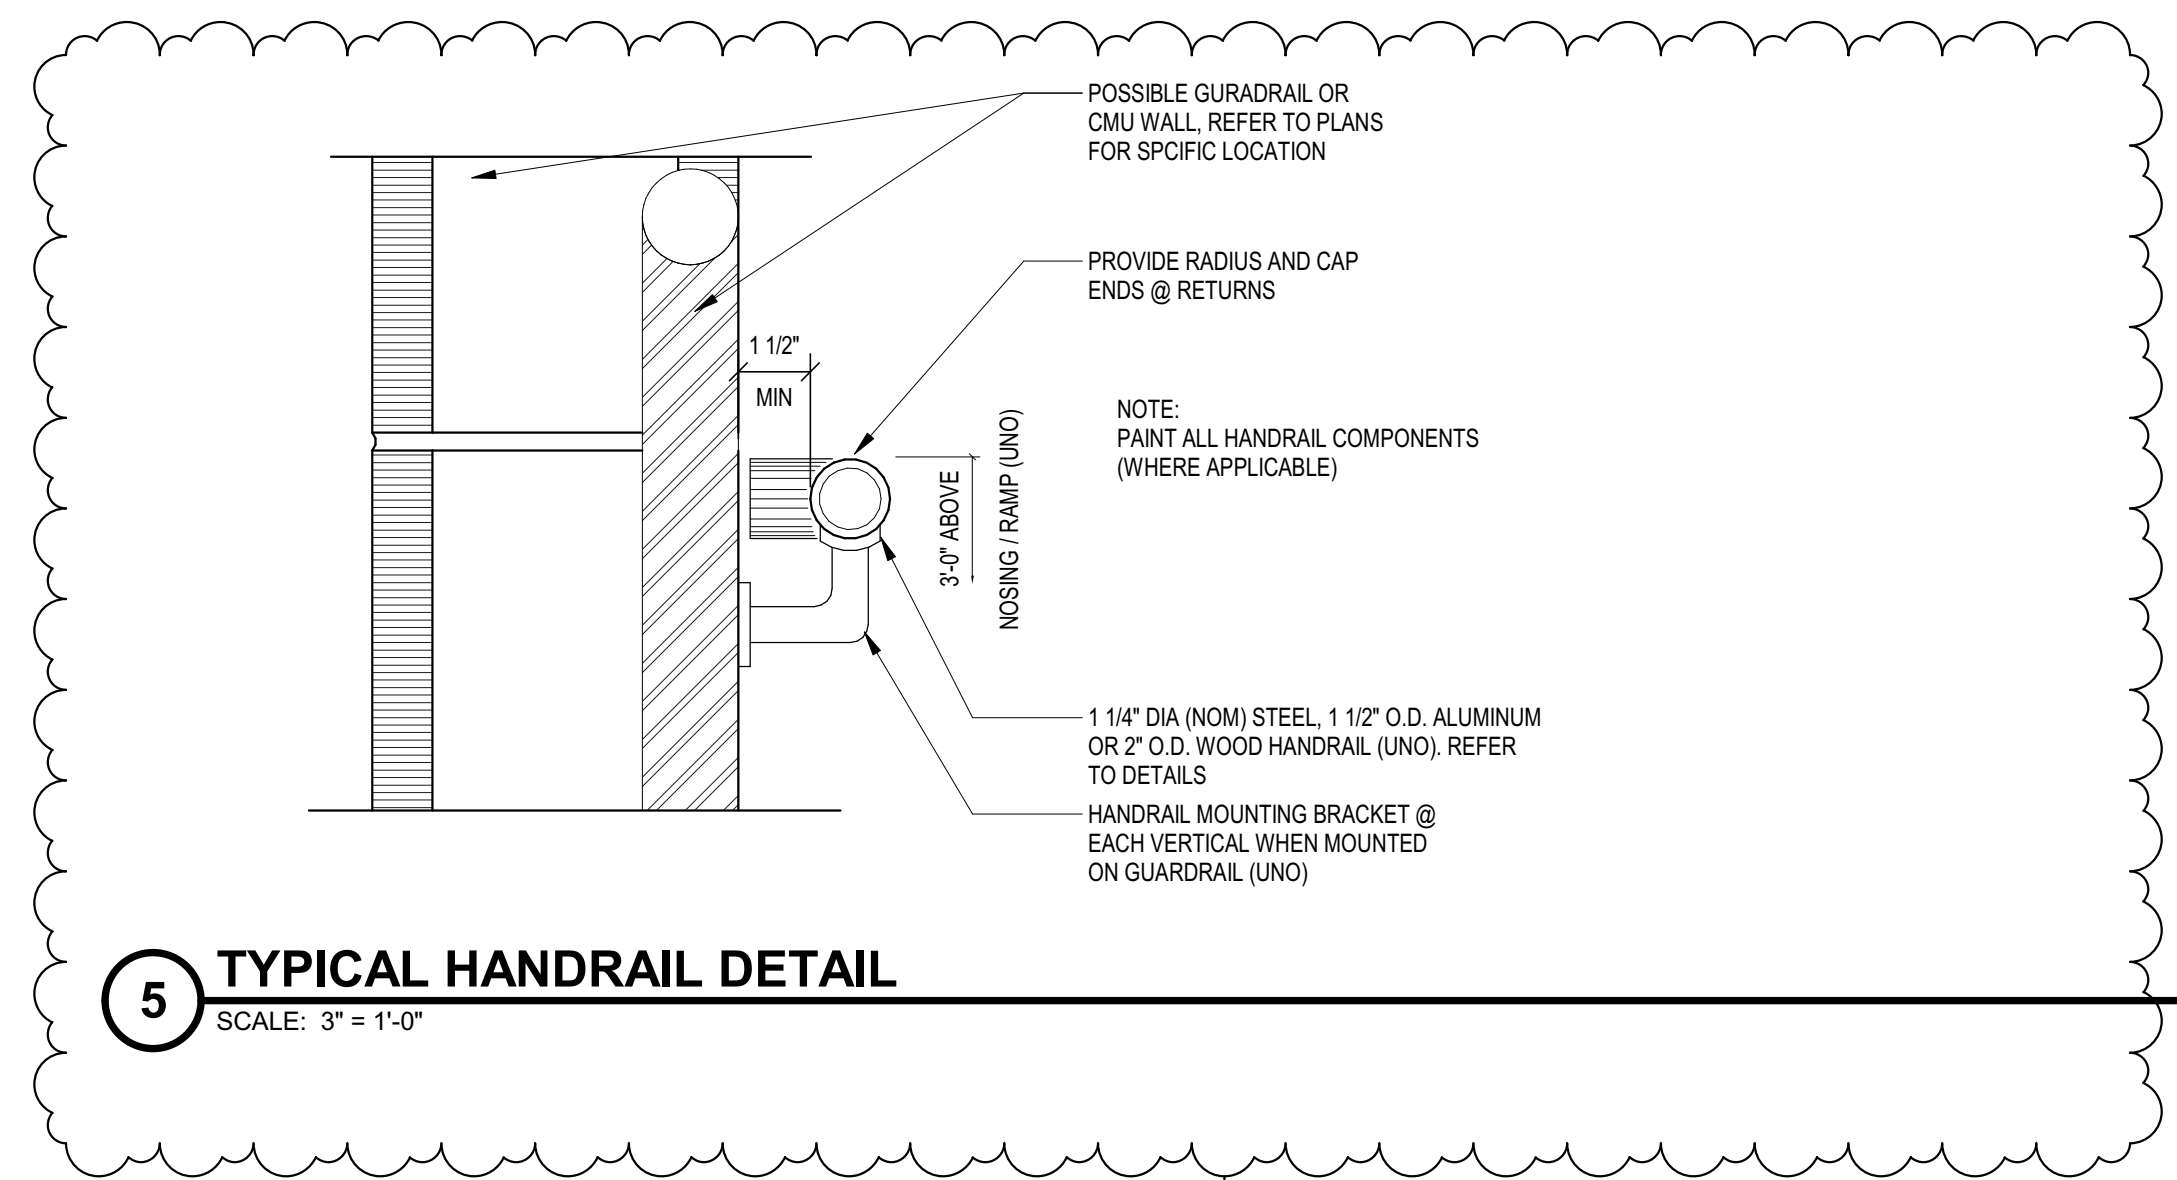
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HOWEY**




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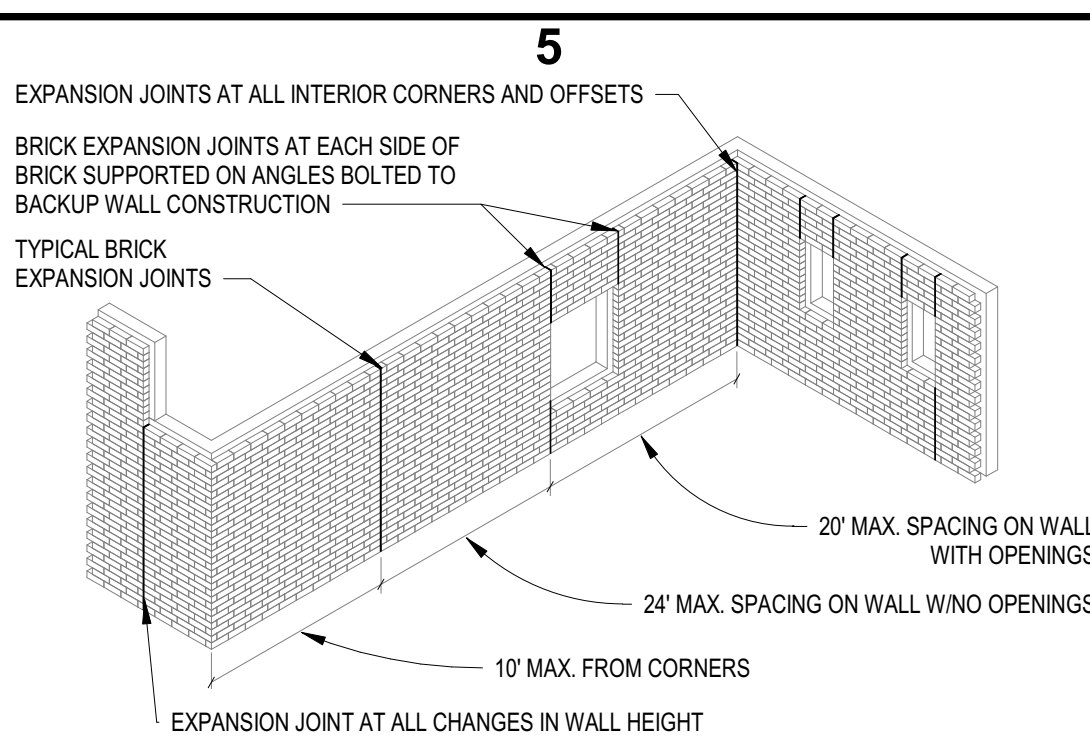
A5-01



AIR BARRIER AND ROOF FLASHINGS

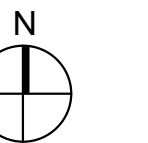


FINISH MATERIALS

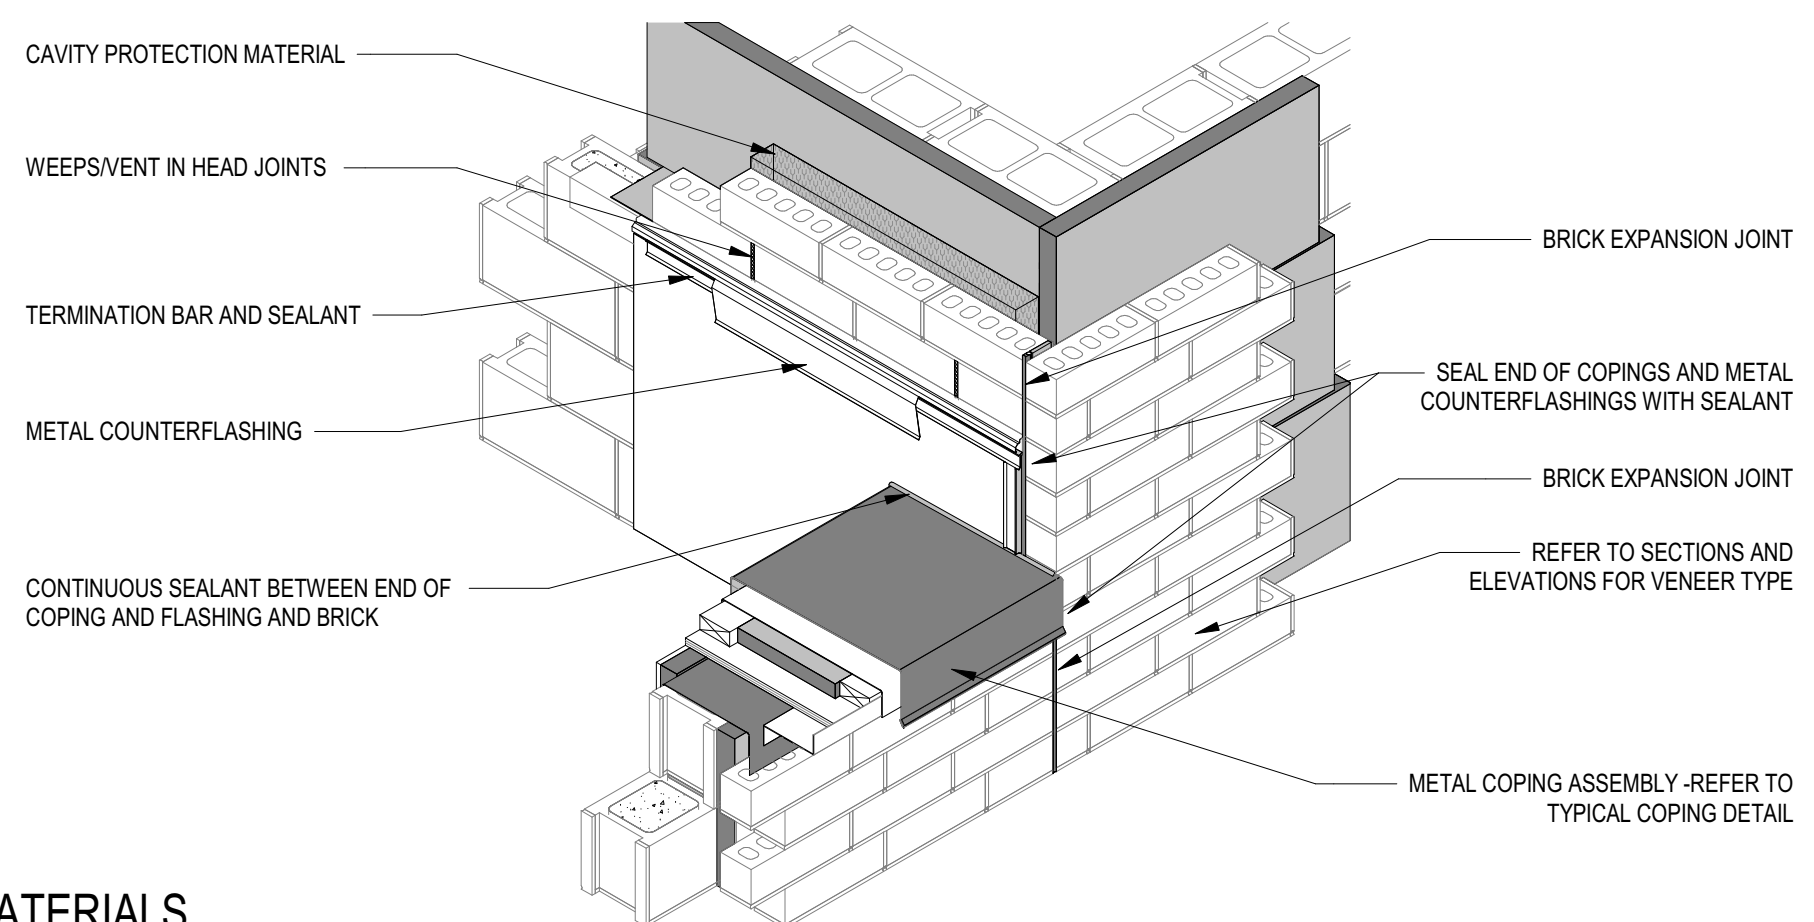


TYPICAL BRICK EXPANSION JOINT (EJ) LOCATIONS

Use this set of details for Backup wall supported shelf angles or steel plates

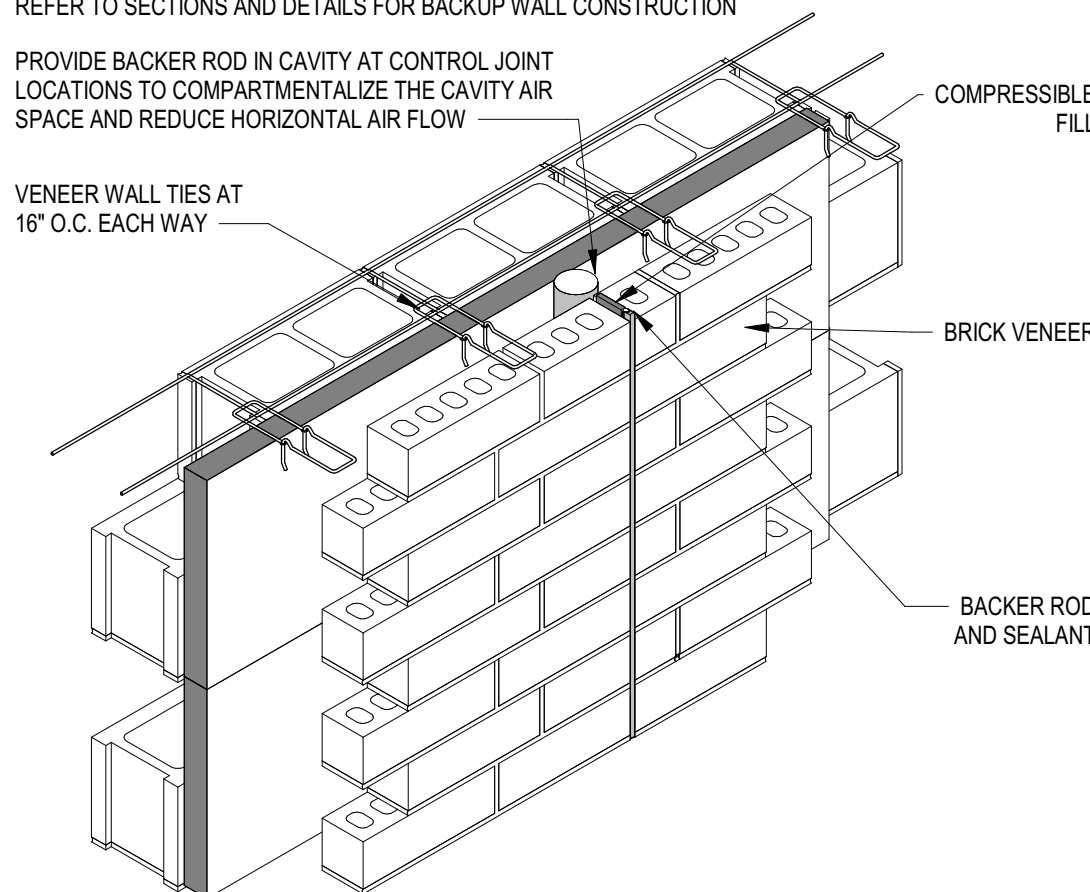


TYPICAL BRICK EXPANSION JOINT DETAIL

REFER TO SECTIONS AND DETAILS FOR BACKUP WALL CONSTRUCTION

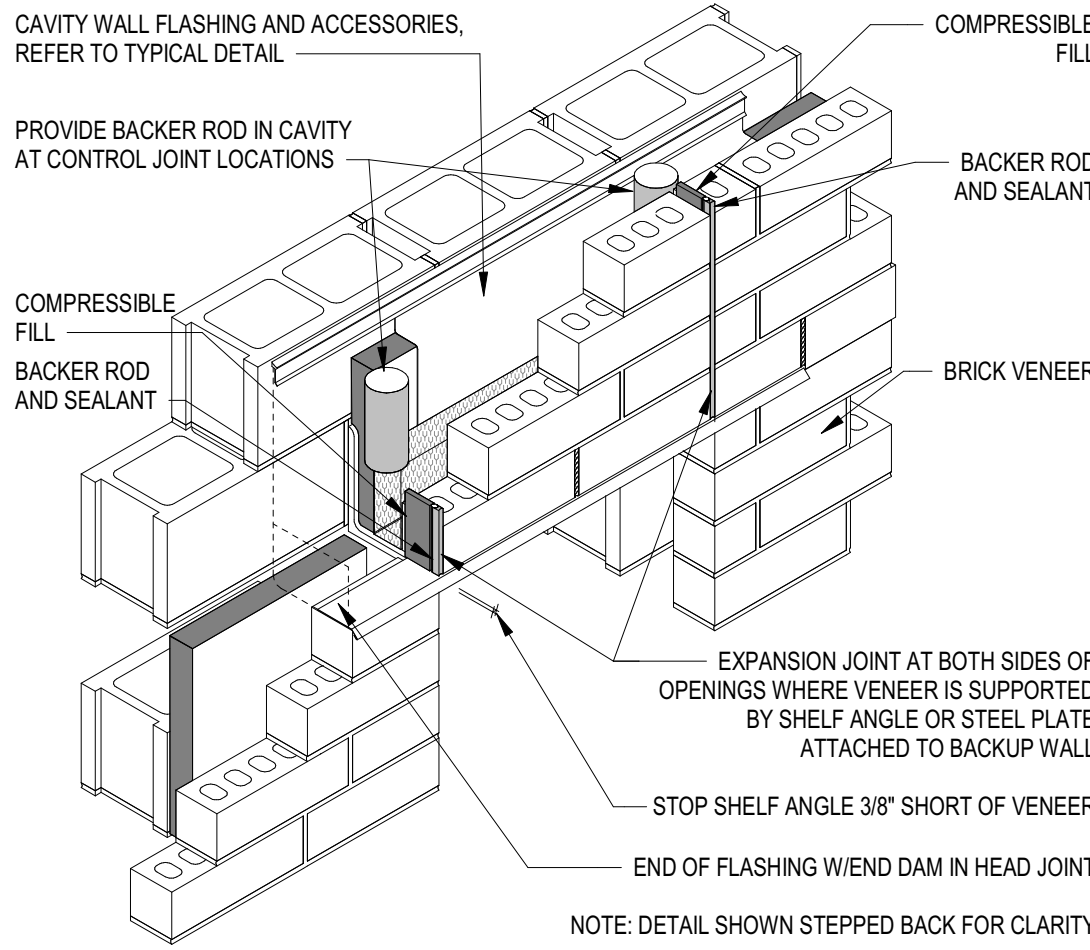


TYPICAL BRICK EXPANSION JOINT AT OPENINGS

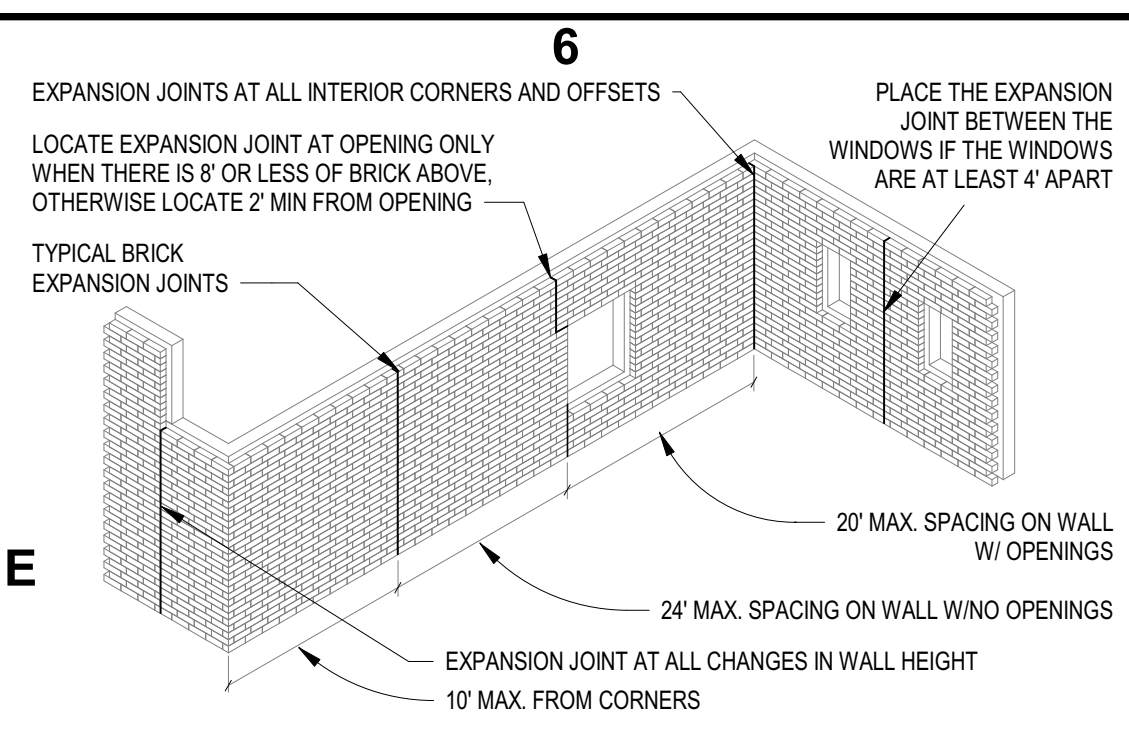


TYPICAL BRICK EXPANSION JOINT (EJ) LOCATIONS

use this set of details for steel angle lintels bearing from brick to brick

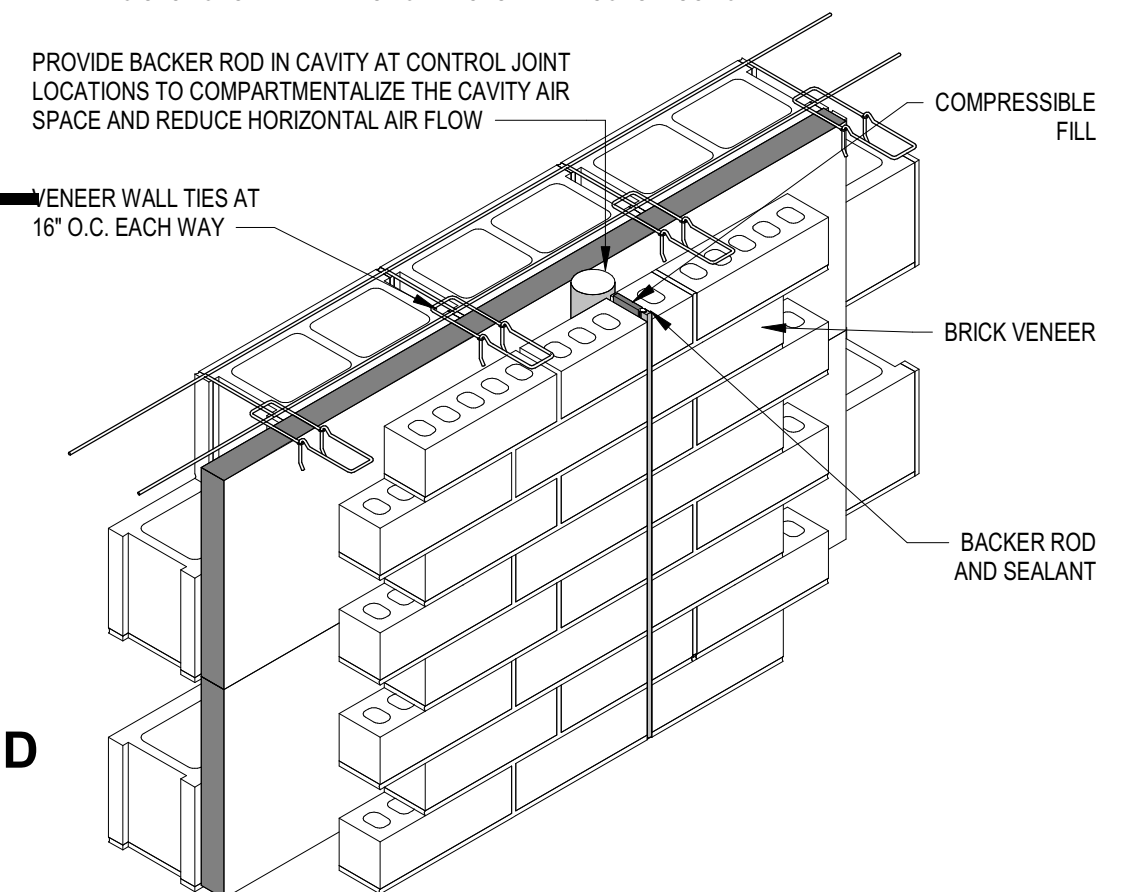

TYPICAL BRICK EXPANSION JOINT DETAIL

REFER TO SECTIONS AND DETAILS FOR BACKUP WALL CONSTRUCTION

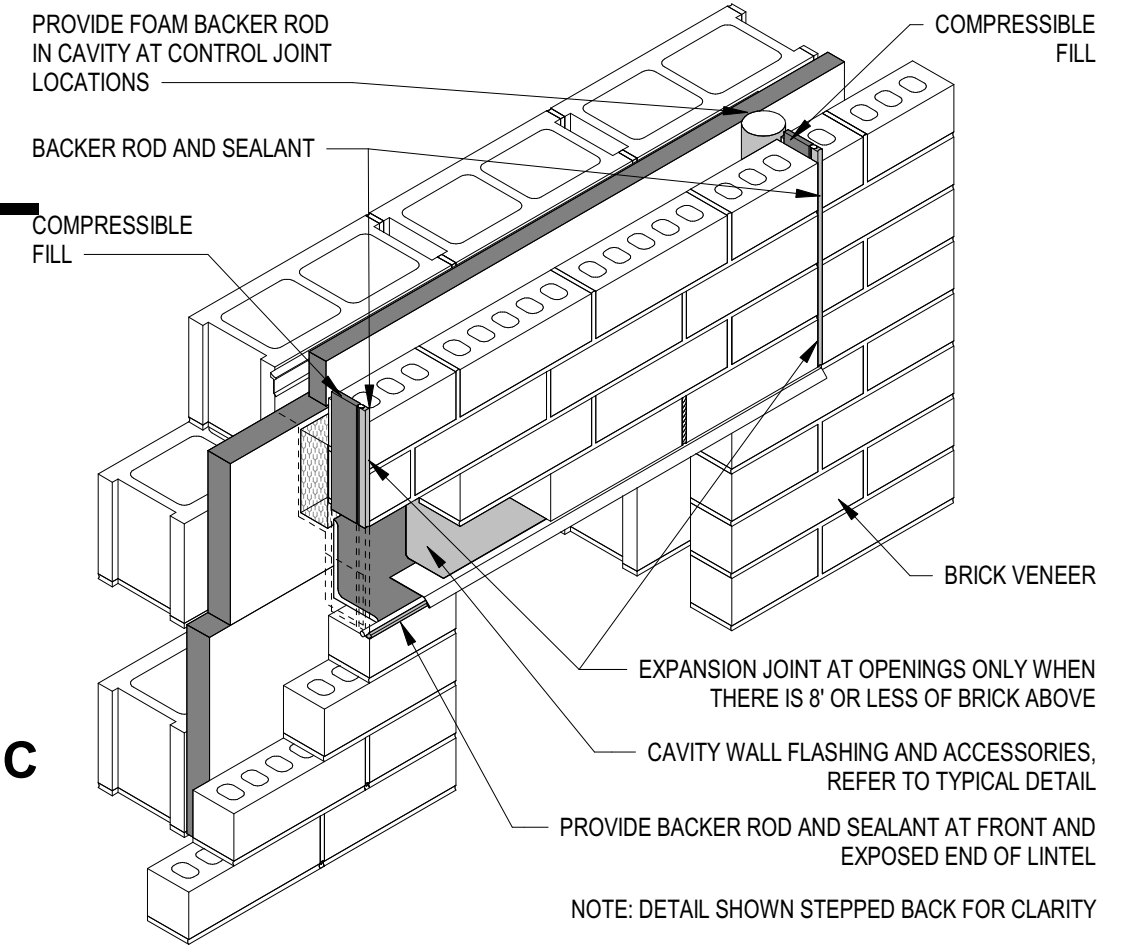

TYPICAL BRICK EXPANSION JOINT AT OPENINGS

1 TYPICAL BRICK EXPANSION JOINTS

2 TYPICAL BRICK EXPANSION JOINTS

3 (A5-994) TYPICAL COPING WALL INTERSECTION
NOT TO SCALE

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ZIONSVILLE COMMUNITY HIGH SCHOOL ATHLETIC LOCKER ROOMS ADDITION AND RENOVATION

1000 MULBERRY STREET,
ZIONSVILLE, IN 46077


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350 E NEW YORK ST, SUITE 300, INDIANAPOLIS, IN 46204



KEY PLAN

ISSUED FOR BID

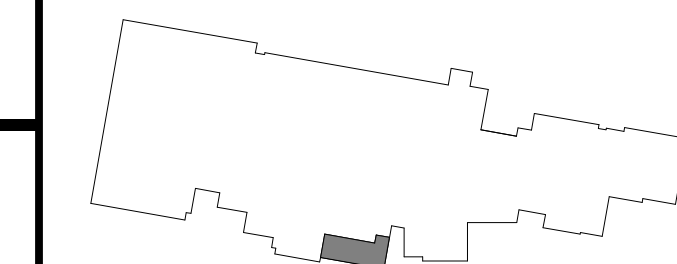

PROJECT MANAGER: JM
DRAWN BY: Author
PROJECT NUMBER: 224018.00
PROJECT ISSUE DATE: 01/21/2025

REV. NO.	DESCRIPTION	DATE
2	ADDENDUM #2	02/18/2025

PLAN DETAILS



A5-03

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**ISSUED FOR BID**[illegible]

SECOND FLOOR FINISH PLAN

AI-12

ROOM LEGEND			
ROOM NO.	OWNER ROOM NO.	ROOM NAME	AREA (S)
A143		VESTIBULE	108 SF
A147		LOCKERS	806 SF
A149		LOCKER	44 SF
A201		MULTIPURPOSE	8,618 SF
A202		RAMP 1	345 SF
A203		STORAGE	682 SF
A204		RAMP 2	46 SF
A205		RAMP 2	310 SF
A206		CORRIDOR	310 SF
A207		LOCKERS	494 SF
A208		BATHROOM	112 SF
A209		STORAGE	399 SF
A210		EXISTING CORRIDOR	1,422 SF
A211		EXISTING CORRIDOR	1,219 SF
A212		SERVICE	50 SF
A213		CL CLOSET	31 SF
A214		EQUIPMENT PLATFORM	1,257 SF
S1		STAIR	174 SF

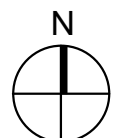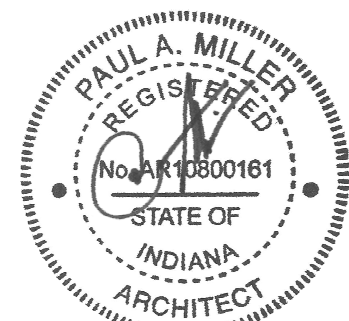A. FIXED CASEWORKS AND TACKBOARDS SHALL REMAIN IN PLACE (UNO)
B. NEW WALL FINISHES SHALL BE INSTALLED ABOVE
C. SEALANT SHALL BE APPLIED AT ALL MATERIAL TRANSITIONS,
D. AND DOORS, WINDOWS, AND TRANSOM LOCATIONS WHERE
E. NEW FINISH ABUTS A DISSIMILAR MATERIAL.
F. REMOVE AND REINSTALL EXISTING DOVE FACETS,
G. SINKS, TUBS, TOILETS, SINK FACETS, AND CLOVES
H. EXISTING ITEMS TO REMAIN AND NEW FINISHES APPLIED
I. ABOVE INCLUDE BUT NOT LIMITED TO THERMOSTATS, AND
J. FIRE EXTINGUISHER CABINETS (UNO)
K. PROVIDE AN EXISTING STEP BETWEEN NEW FLOOR FINISH
L. AND EXISTING FLOOR FINISH
M. PROVIDE NEW RESILIENT TRANSITION STRIPS AT EXPOSURE
N. EDGES OF NEW FLOOR FINISH MEETING FLOOR FINISH
O. PARTIAL AISLES (VERT AND HORIZ) OF BULKHEAD/OFFSET
P. (UNO)
Q. PATCH AND REPAIR ALL HOLES AND IMPERFECTIONS,
R. TO RECEIVE NEW FINISHES
S. DRY IN PLACE DECONTAMINATE RESINOUS/FLOORING
T. CARCART INDICATES CARPET TILE
U. ECTY INDICATES ENTRANCE CHAFFILE
V. LVTI INDICATES LAMINATE VINYL TILE
W. FSI INDICATES FLOOR SEALER
X. RSI INDICATES RESILIENT SEAM
Y. RSI INDICATES RESILIENT STAIR NOSING
Z. RSI INDICATES RESILIENT BASE
AA. (P) INDICATES PARTIAL
AB. ACTI INDICATES ACoustICAL CEILING TILING
AC. ACTI INDICATES ACoustICAL CEILING TILING (FUTURE)
AD. FSI INDICATES INTERIOR FINISH SEALER

(ALL NOTES MAY NOT BE INDICATED ON THIS SHEET)

- 1 VESTIBULE FINISHES TO MATCH ADJACENT LOCKER ROOM FINISHES
- 2
- 3 LOCKER ROOM FINISHES TO MATCH ADJACENT LOCKER ROOM FINISHES. WALLS TO BE P-1 ONLY
- 4 REFER TO A1-51 FOR FLOOR PATTERN DETAILS
- 5 PAINTED WALL, GRAPHIC, INCLUDING LETTERS AND LOGO, AND SIGNAGE TO BE DETERMINED
- 6 NO FINISH SCOPE IN THIS ROOM
- 7 EXISTING BRICK WALL (XBRK), DO NOT PAINT
- 8 NOT USED
- 9 PAINT ALL SIDES OF BULKHEAD, P-4
- 10 PAINT ALL SIDES OF BULKHEAD, P-3
- 11 ROOM TO BE PAINTED P-1 WITH P-4 & P-5 ACCENTS ON ALL WALLS U.N.O.; REFER TO TYP ELEVATION 44-22
- 12 PAINT MEET PORTIONS OF STAIR AND RAILINGS
- 13 RSF-1-2-3 "Z" LOGO INLAID INTO RTF. REFER TO DETAIL A2-51
- 14 RSF-1-2-3 "Z" LOGO INLAID INTO RTF. REFER TO DETAIL A2-51
- 15 RSF-1-2-3 "Z" LOGO INLAID INTO RTF. REFER TO DETAIL A4-51
- 16 RSF-1-2-3 "Z" LOGO INLAID INTO RTF. REFER TO DETAIL A4-51
- 17 "Z" LOGO INLAID INTO RTF. REFER TO DETAIL 6A-51
- 18 PAINT NEW HI DOORS AND FRAMES, COLOR TO BE SELECTED
- 19 ROOM TO BE PAINTED P-1 WITH P-4 & P-5 ACCENTS ON ALL WALLS U.N.O.; REFER TO TYP ELEVATION 54-22
- 20 EXISTING PAINTED WALL TO REMAIN
- 21 IS-1 CEILING OVER SHOWER, REFER TO A-2, SEE SECTIONS DRAWINGS
- 22 IS-1 CEILING OVER ENTRY SHOWER AREA SOUTH OF SHOWER AREA, SEE SECTIONS DRAWINGS
- 23 INCLUDE HIGH-TEMPERATURE COATINGS IN THIS ROOM, REFER TO P-1 NOTE POINTS ON A4-61
- 24 ROOM TO BE PAINTED P-1 WITH P-4 & P-5 ACCENTS ON ALL WALLS U.N.O.; REFER TO TYP ELEVATION 54-22
- 25 PAINTED LOGO, REFER TO DETAIL A2-62
- 26 PAINTED WALL, GRAPHIC, INCLUDING LETTERS, MINIMUM 4 COLORS, FINAL DESIGN TO BE DETERMINED
- 27 REFER TO ELEVATION 44-22
- 28 LVT-3 LOCATED ON FIRST FLOOR ONLY, RSK-1 HATCHING FOR STAIR RAILS AND LANDINGS AS SHOWN WITH INDICATED RTF FLOORING TO ALIGN WITH BULKHEAD ABOVE. INSTALL RTF FLOORING TO MATCH EXISTING RTF FLOORING TO CORRESPOND TO EXISTING EPOXY FLOORING. REFER TO DETAIL ON A4-61

26 LVT-3 LOCATED ON FIRST FLOOR ONLY; RSA-1 INDICATED FOR
STAIR TREADS AND LANDINGS AS SHOWN WITH HATCHING
27 RFT FLOORING TO ALIGN WITH BULKHEAD ABOVE; INSTALL
NEW TRANSITION STRIP TO ALL SIDES OF NEW RFT FLOORING
TO EXISTING EPOXY FLOORING. REFER TO DETAIL ON AI-61


EQUIPMENT PLATFORM - FINISH PLAN

SCALE: 1/8" = 1'-0"

SECOND FLOOR FINISH PLAN

SCALE: 1/8" = 1'-0"

FLOOR PATTERN LEGEND

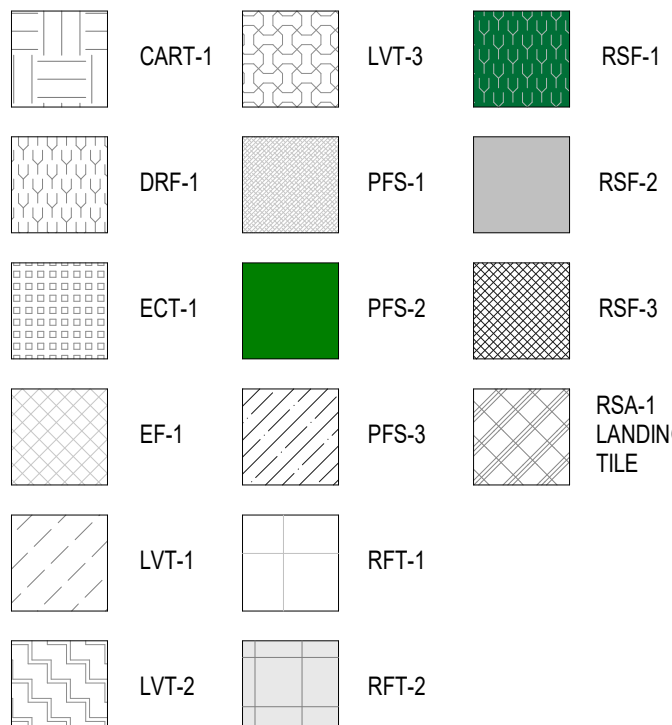


VERIFICATION NOTE


CONTRACTOR SHALL VERIFY ALL DIMENSIONS AND CLEARANCES AND ALL EXISTING FIELD CONDITIONS BEFORE STARTING CONSTRUCTION. COMMENCEMENT OF WORK CONSTITUTES ACCEPTANCE OF CONDITIONS.

SHOULD DIFFERENT CONDITIONS BE ENCOUNTERED, CONTACT THE ARCHITECT BEFORE PROCEEDING WITH WORK.


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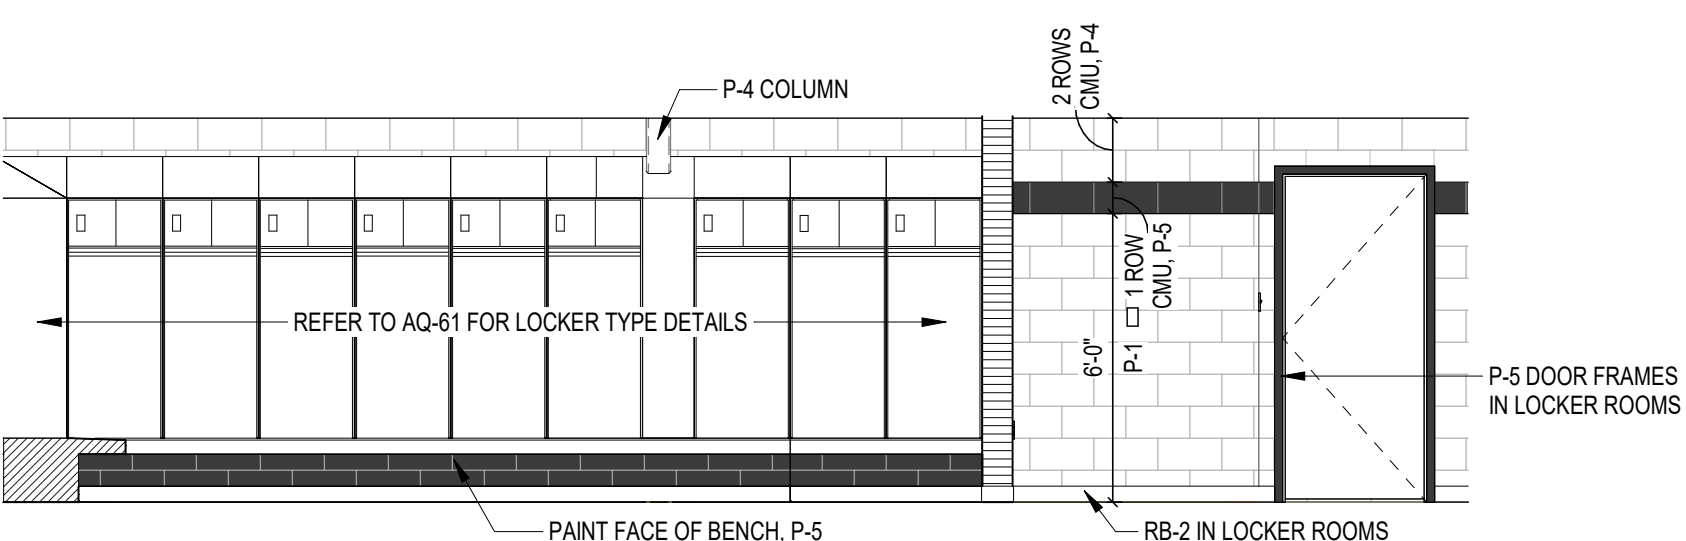
1 A175 CORRIDOR - WEST
SCALE: 1/4" = 1'-0"

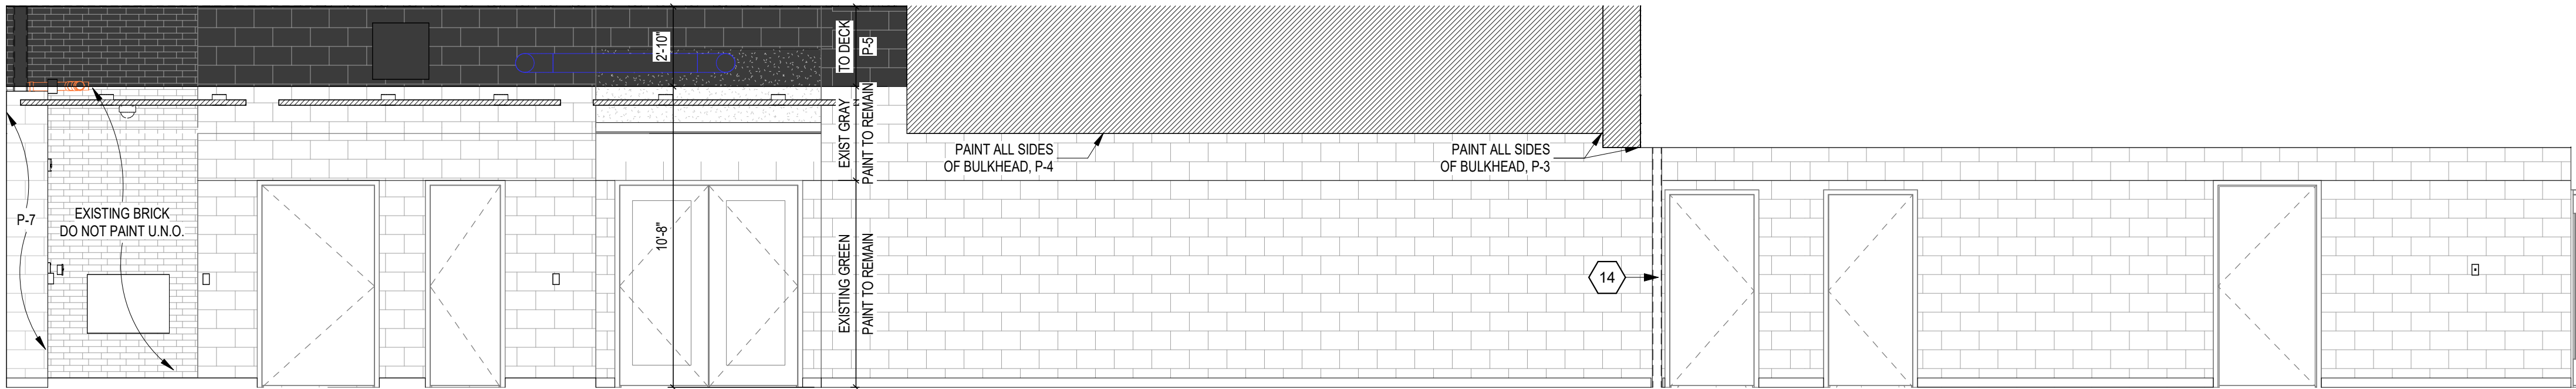


2 NEW GYM ENTRY - WEST
SCALE: 1/4" = 1'-0"

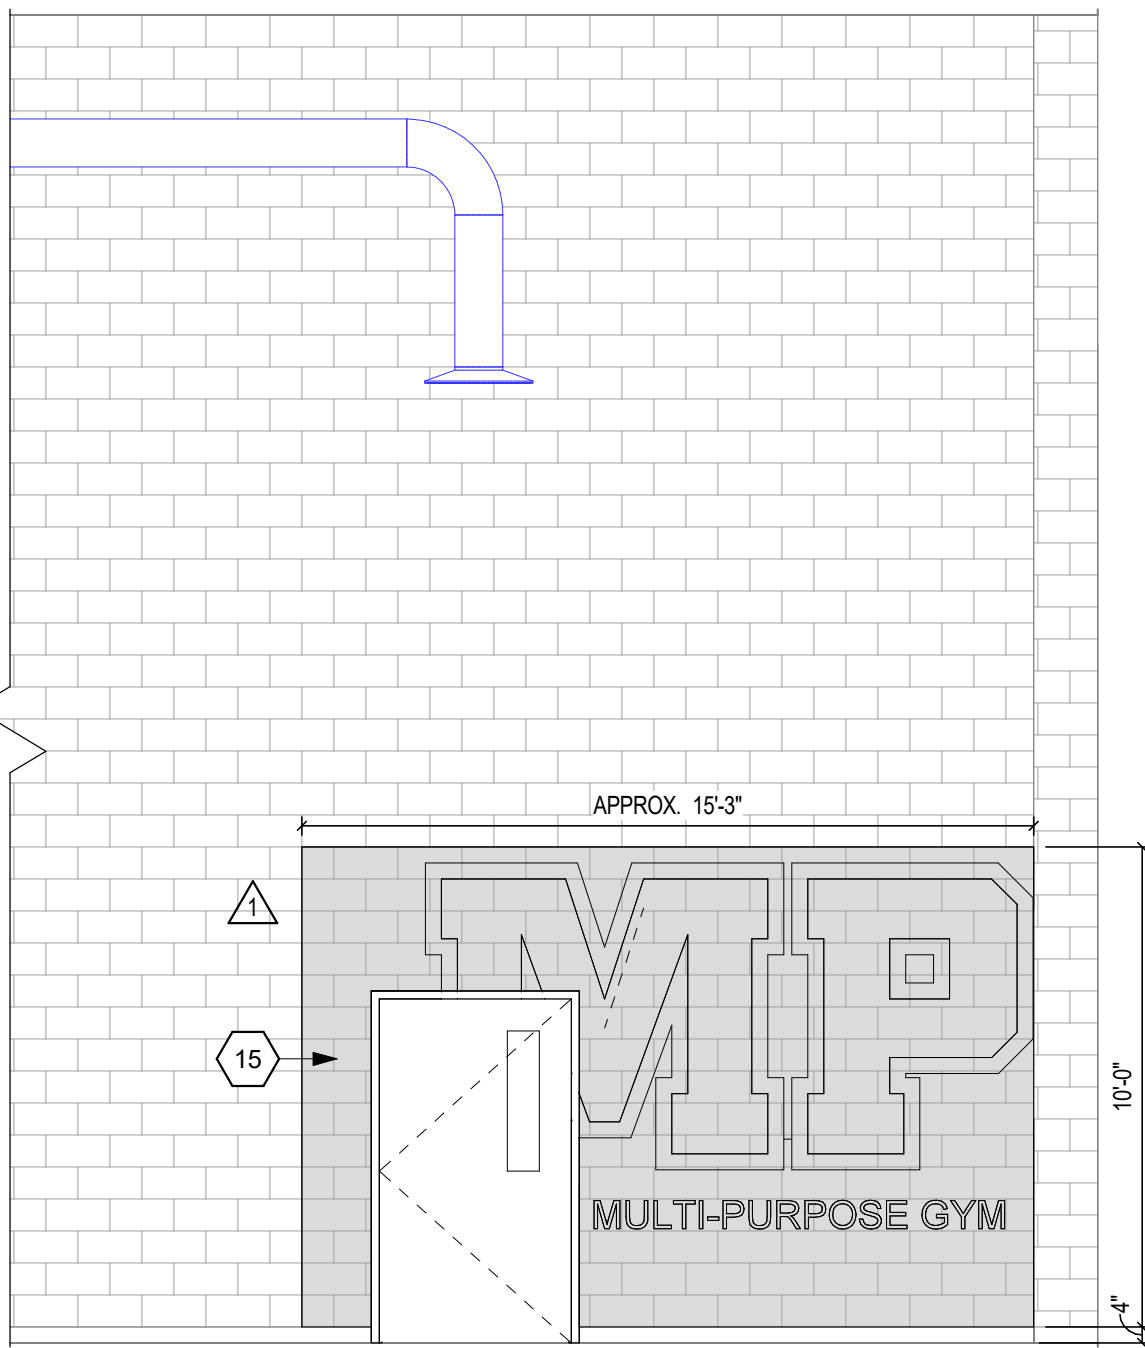


3 NEW GYM ENTRY - EAST
SCALE: 1/4" = 1'-0"

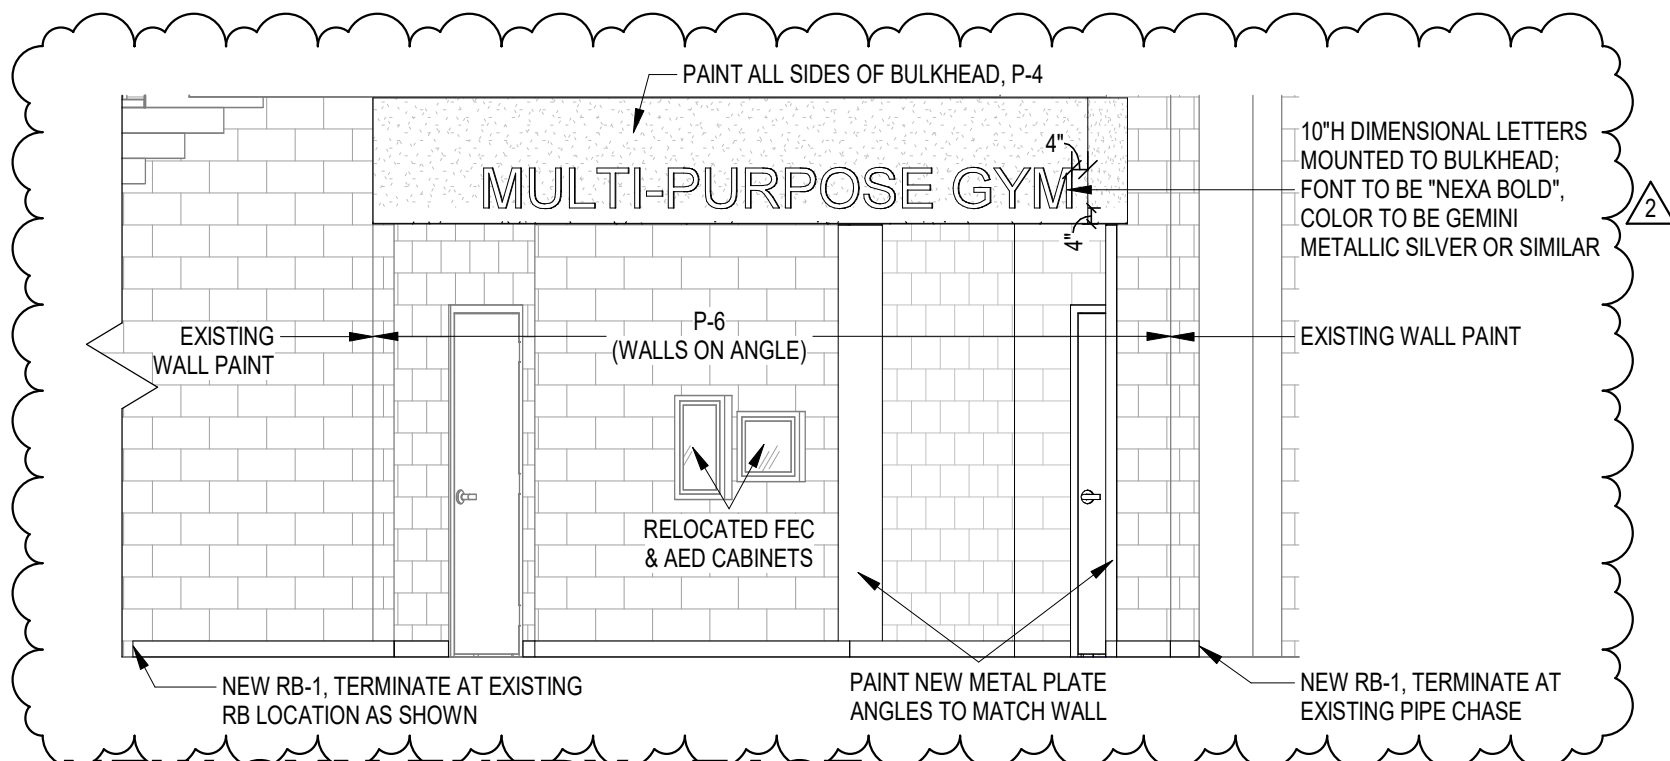


4 EXISTING BUILDING - LOCKER ROOM PAINT
SCALE: 1/4" = 1'-0"

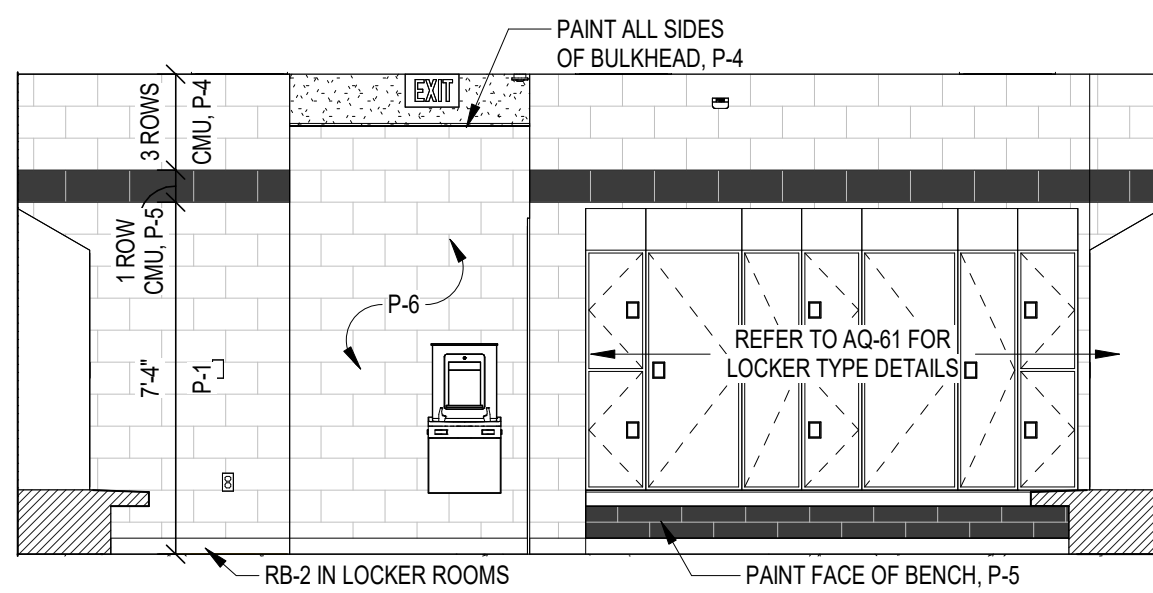


5 ADDITION - LOCKER ROOM PAINT
SCALE: 1/4" = 1'-0"

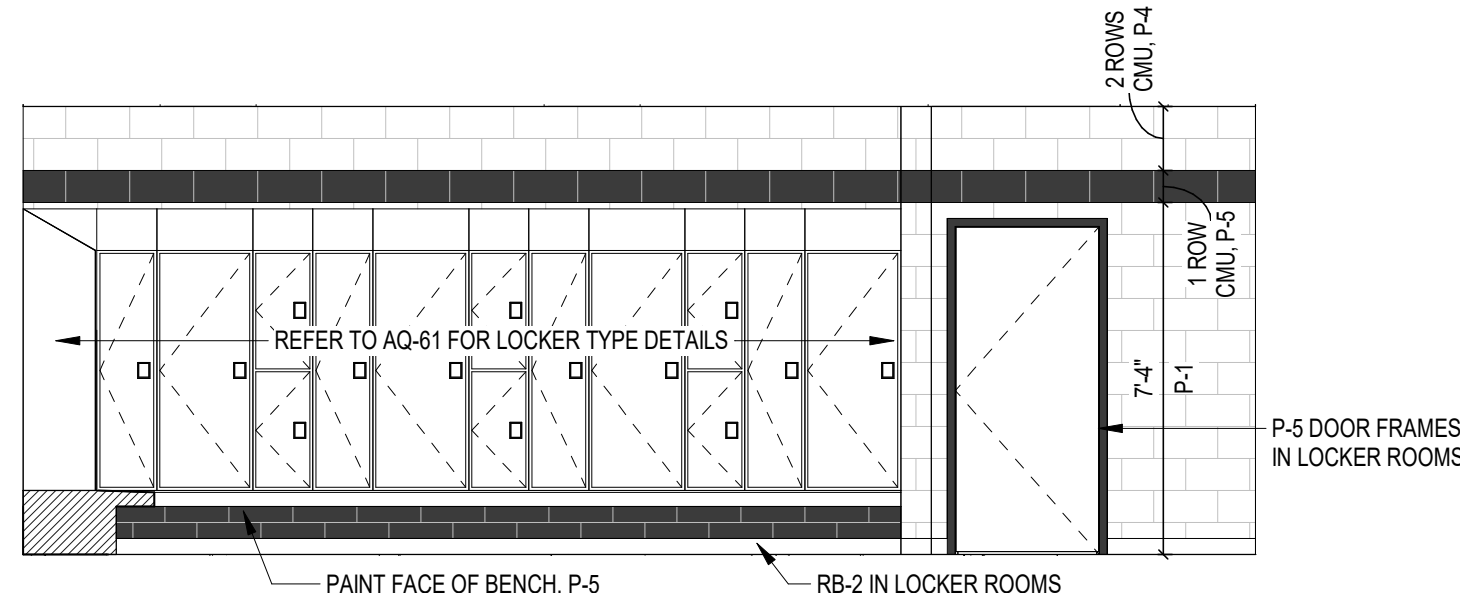

6 SECOND LEVEL - LOCKER ROOM PAINT
SCALE: 1/4" = 1'-0"

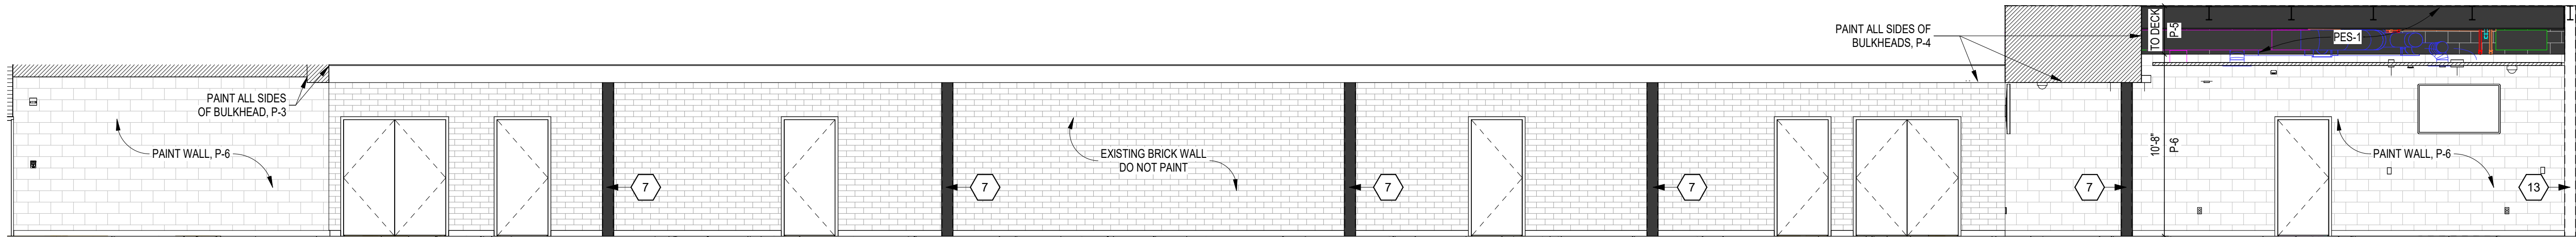

7 A130 CORRIDOR - NORTH
SCALE: 3/16" = 1'-0"

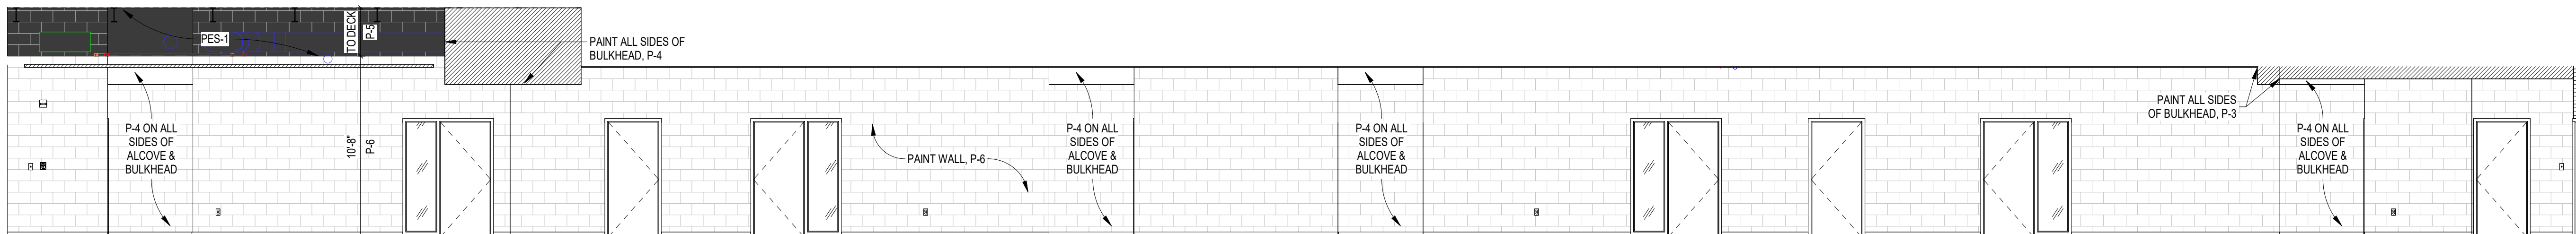

8 A130 CORRIDOR - SOUTH
SCALE: 3/16" = 1'-0"

INTERIOR ELEVATION NOTES

(ALL NOTES MAY NOT BE INDICATED ON THIS SHEET)

- 1 WINDOW, REFER TO A SERIES DRAWINGS
- 2 ALIGN TOP OF AR-AWT WITH TOP OF WINDOW
- 3 ALIGN TOP OF AR-AWT WITH AR-AWT ON ADJACENT WALL
- 4 MECHANICAL GRILLE, REFER TO M SERIES DRAWINGS
- 5 MOTORIZED PROJECTION SCREEN, MOUNTED TO STRUCTURE, REFER TO AQ-12 FOR ADDITIONAL DETAILS
- 6 SHORT THROW PROJECTOR, REFER TO AQ-12 FOR ADDITIONAL DETAILS
- 7 PAINT STEEL COLUMN, P-5
- 8 PAINT STEEL BEAM AT PERIMETER WALL, P-5
- 9 SCOREBOARD, REFER TO SPECIFICATIONS AND AQ-12 FOR ADDITIONAL DETAILS
- 10 MECHANICAL DUCTWORK, REFER TO M SERIES DRAWINGS
- 11 GLASSLESS MIRRORS, REFER TO SPECIFICATIONS
- 12 ACOUSTICAL CURTAIN TRACK, REFER TO SPECIFICATIONS
- 13 PAINT STEEL COLUMN, P-6
- 14 PAINT STEEL COLUMN, P-7
- 15 PAINTED GRAPHIC, DESIGN TO BE DETERMINED, EXTENTS AS NOTED

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ZIONSVILLE COMMUNITY HIGH SCHOOL ATHLETIC LOCKER ROOMS ADDITION AND RENOVATION

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ZIONSVILLE, IN 46077

ZIONSVILLE COMMUNITY SCHOOLS



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KEY PLAN

ISSUED FOR BID



PROJECT MANAGER: JM
DRAWN BY: AML
PROJECT NUMBER: 224018.00
PROJECT ISSUE DATE: 01/21/2025


REV. NO.	DESCRIPTION	DATE
1	ADDENDUM #1	02/11/2025
2	ADDENDUM #2	02/18/2025

VERIFICATION NOTE
CONTRACTOR SHALL VERIFY ALL DIMENSIONS AND CLEARANCES AND ALL EXISTING FIELD CONDITIONS BEFORE STARTING CONSTRUCTION. COMMENCEMENT OF WORK CONSTITUTES ACCEPTANCE OF CONDITIONS.
SHOULD DIFFERENT CONDITIONS BE ENCOUNTERED, CONTACT THE ARCHITECT BEFORE PROCEEDING WITH WORK.

INTERIOR ELEVATIONS

AI-22

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1 FIRST FLOOR EQUIPMENT PLAN
SCALE: 1/8" = 1'-0"

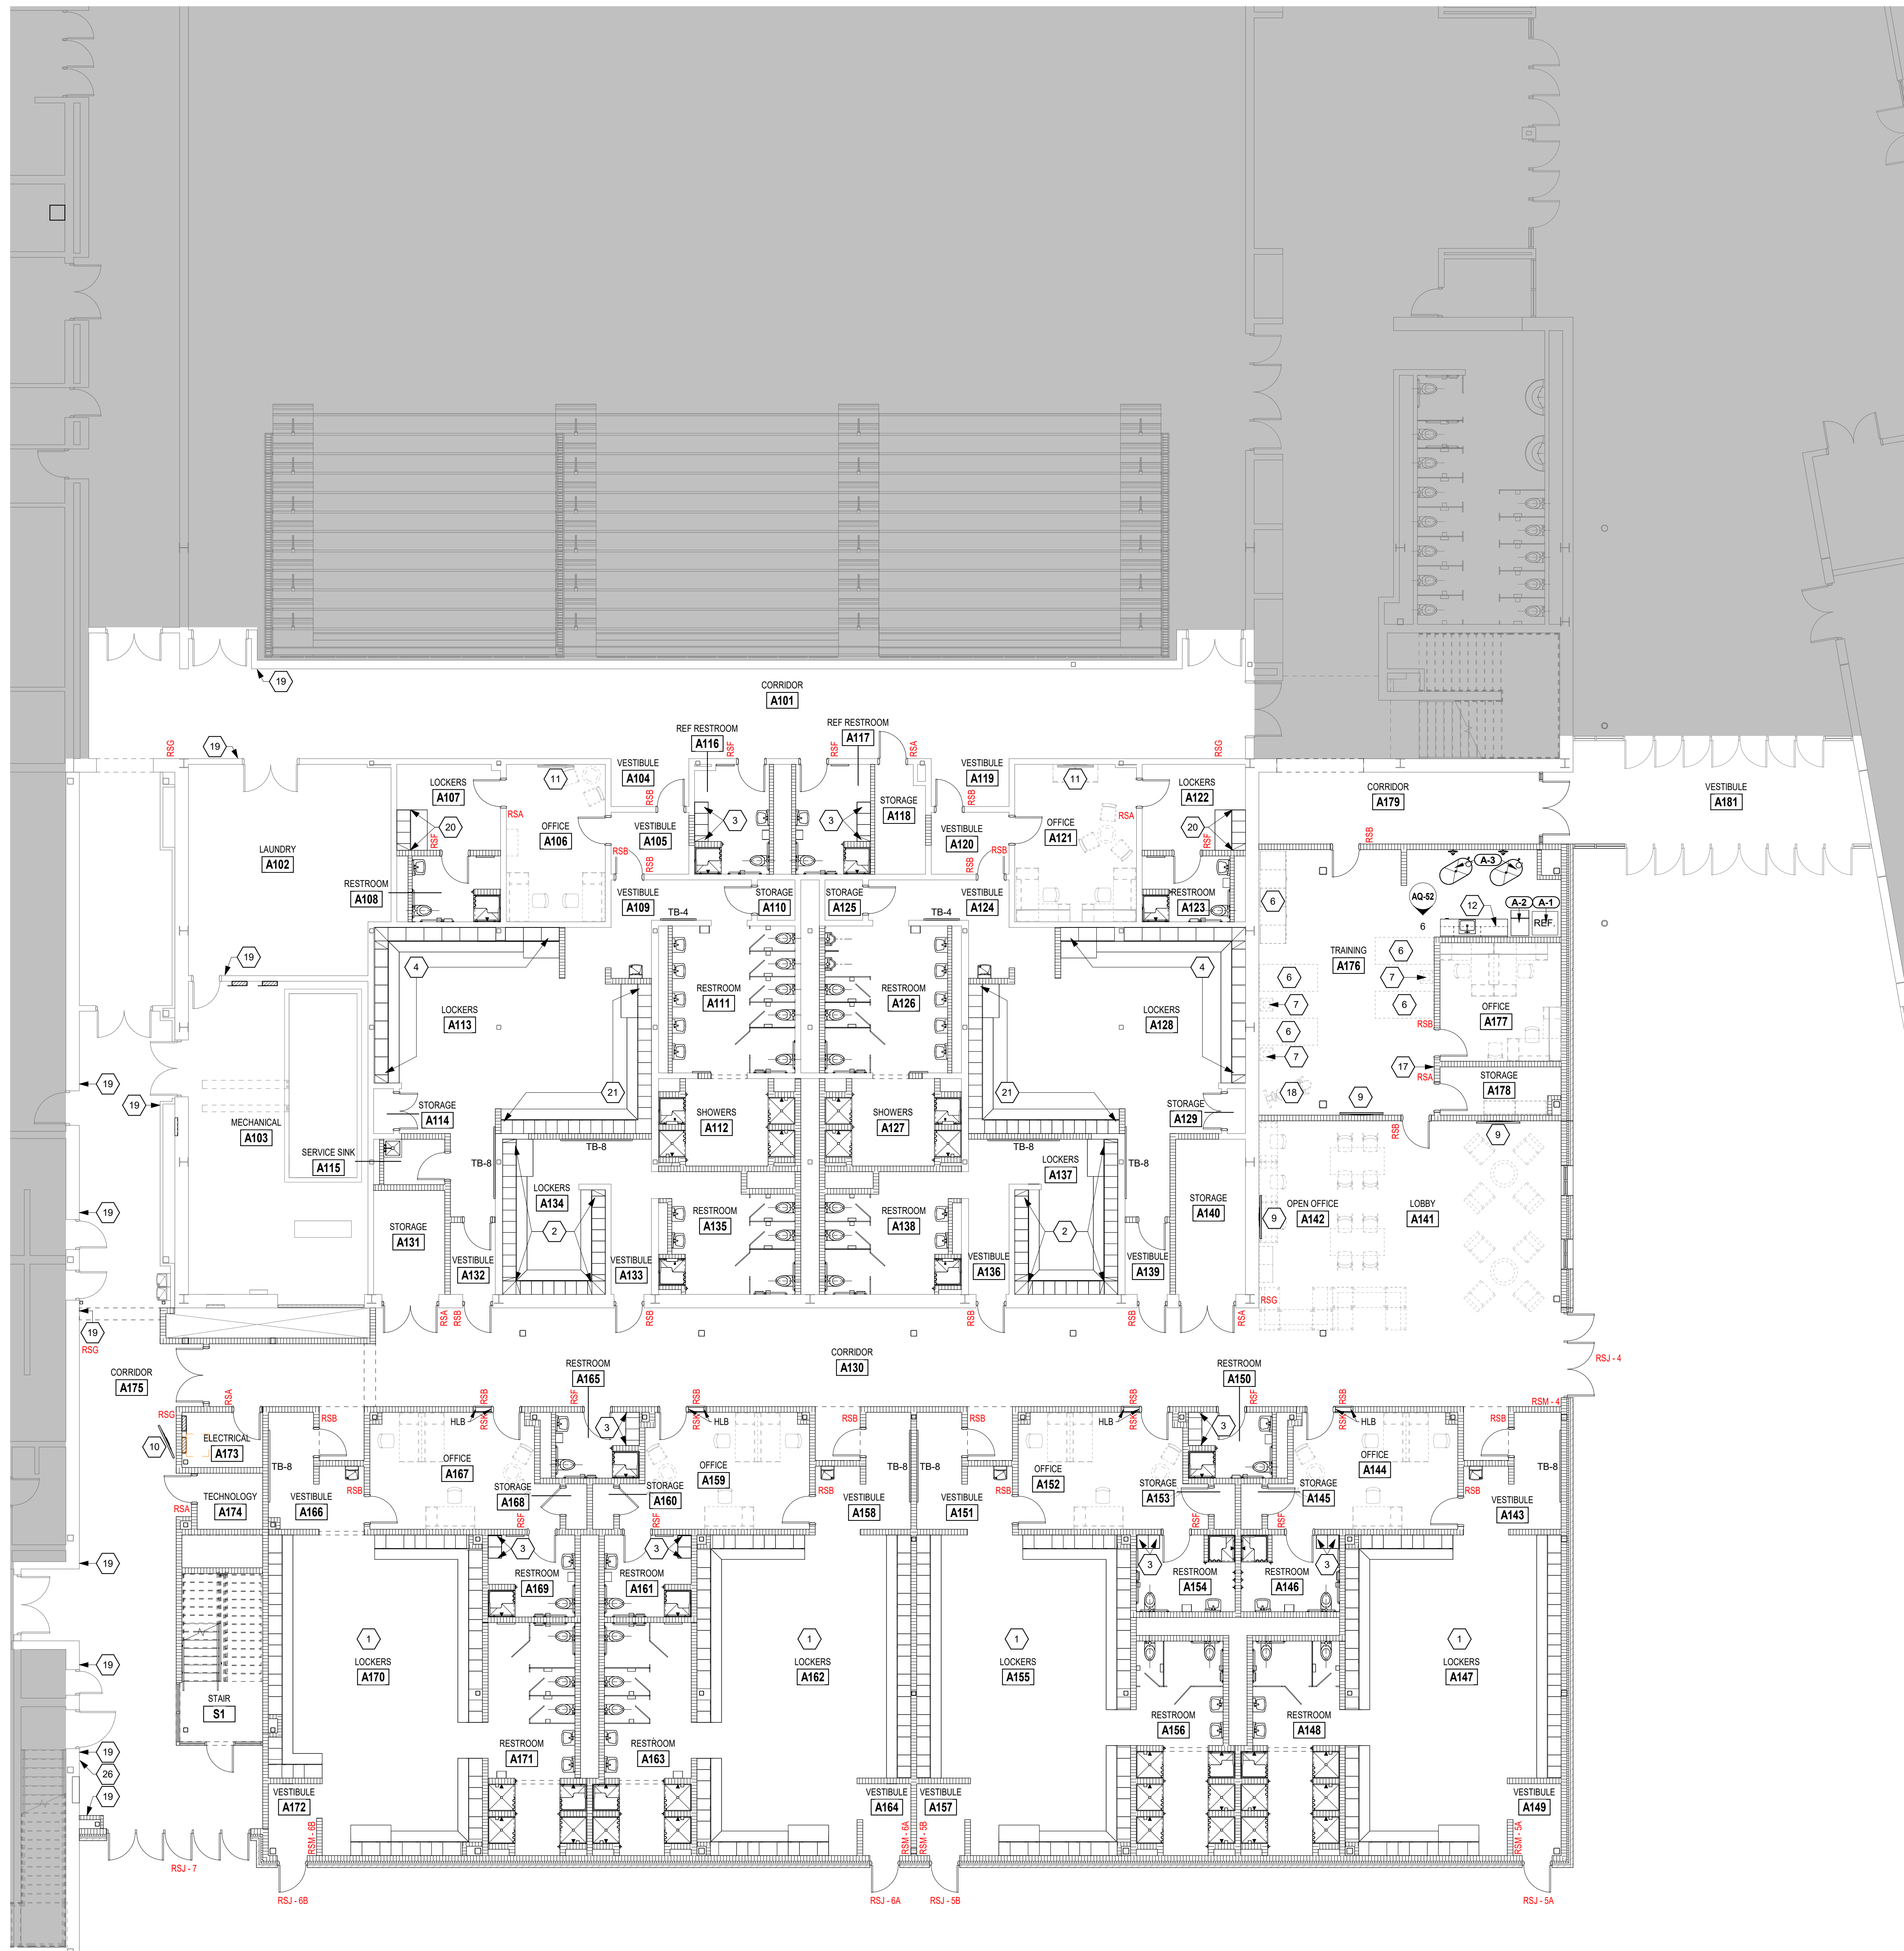ROOM LEGEND			
ROOM NO.	OWNER ROOM NO.	ROOM NAME	AREA (SF)
A101	C8	CORRIDOR	1,376 SF
A102	C8	LAUNDRY	515 SF
A103	C6 MECH	MECHANICAL	897 SF
A104		VESTIBULE	46 SF
A105		VESTIBULE	60 SF
A106		OFFICE	193 SF
A107		LOCKERS	110 SF
A108		RESTROOM	70 SF
A109		VESTIBULE	128 SF
A110		STORAGE	16 SF
A111		RESTROOM	226 SF
A112		SHOWERS	127 SF
A113		LOCKERS	868 SF
A114		STORAGE	11 SF
A115		SERVICE SINK	34 SF
A116		REF RESTROOM	98 SF
A117		REF RESTROOM	99 SF
A118		STORAGE	86 SF
A119		VESTIBULE	46 SF
A120		VESTIBULE	60 SF
A121		OFFICE	237 SF
A122		LOCKERS	110 SF
A123		RESTROOM	70 SF
A124		VESTIBULE	128 SF
A125		STORAGE	16 SF
A126		RESTROOM	226 SF
A127		SHOWERS	127 SF
A128		LOCKERS	668 SF
A129		STORAGE	10 SF
A130		CORRIDOR	1,707 SF
A131		STORAGE	92 SF
A132		VESTIBULE	40 SF
A133		VESTIBULE	62 SF
A134		LOCKERS	215 SF
A135		RESTROOM	182 SF
A136		VESTIBULE	62 SF
A137		LOCKERS	216 SF
A138		RESTROOM	182 SF
A139		VESTIBULE	40 SF
A140		STORAGE	134 SF
A141		LOBBY	396 SF
A142		OPEN OFFICE	306 SF
A143		VESTIBULE	108 SF
A144		OFFICE	250 SF
A145		STORAGE	12 SF
A146		RESTROOM	92 SF
A147		LOCKERS	866 SF
A148		RESTROOM	229 SF
A149		VESTIBULE	44 SF
A150		RESTROOM	66 SF
A151		VESTIBULE	105 SF
A152		OFFICE	240 SF
A153		STORAGE	12 SF
A154		RESTROOM	92 SF
A155		LOCKERS	790 SF
A156		RESTROOM	229 SF
A157		VESTIBULE	44 SF
A158		VESTIBULE	105 SF
A159		OFFICE	240 SF
A160		STORAGE	12 SF
A161		RESTROOM	86 SF
A162		LOCKERS	790 SF
A163		RESTROOM	248 SF
A164		VESTIBULE	44 SF
A165		RESTROOM	66 SF
A166		VESTIBULE	104 SF
A167		OFFICE	250 SF
A168		STORAGE	12 SF
A169		RESTROOM	86 SF
A170		LOCKERS	794 SF
A171		RESTROOM	248 SF
A172		VESTIBULE	44 SF
A173		ELECTRICAL	55 SF
A174		TECHNOLOGY	46 SF
A175	C8	CORRIDOR	1,053 SF
A176	C402	TRAINING	703 SF
A177	C402A	OFFICE	178 SF
A178		STORAGE	69 SF
A179		CORRIDOR	251 SF
A180	C8	CORRIDOR	257 SF
A181		VESTIBULE	387 SF
S1		STAIR	174 SF

- EQUIPMENT GENERAL NOTES**
- A. ALL COUNTERTOPS TO HAVE CONTINUOUS 4" HIGH BACKSPASHES AND ENDSPASHES UNLESS NOTED OTHERWISE.
- B. HIDDEN LINES (---) INDICATE ITEMS TO BE PART OF LOOSE EQUIPMENT PACKAGE OR BY OWNER, NOT INCLUDED IN CONSTRUCTION CONTRACTS. DASHED LINES (---) INDICATE OVERHEAD ITEMS INCLUDED IN CONSTRUCTION CONTRACTS.
- C. (TB) INDICATES 8" HIGH TACK BOARD LENGTH AS INDICATED. REFER TO MOUNTING HEIGHT DRAWING. PROVIDE FILER STRIPS BETWEEN CASEWORK UNITS AND WALL OR BETWEEN ANY UNIT AS REQUIRED. EXTEND COUNTER TO FACE OF WALL OR ADJACENT TALL CABINET. ALL CASEWORK DOORS AND DRAWERS SHALL BE LOCKABLE.
- D. ALL EXPOSED ENDS AND BACKS OF CASEWORK SHALL BE FINISHED.
- E. CASEWORK INSTALLER SHALL CUT CASEWORK AS REQUIRED FOR PLUMBING/ELECTRICAL LINES. CASEWORK INSTALLER SHALL CAULK BETWEEN COUNTERS, BACKSPASHES, AND WALLS.
- F. ALL WALL-MOUNTED CASEWORK SHALL BE MOUNTED WITH THE TOP AT 7'-0" AFF UNLESS OTHERWISE NOTED.
- G. REFER TO A2-61 LIST OF FINISHES FOR COLOR SELECTIONS.
- H. (RWS) INDICATES ROLLER WINDOW SHADES. REFER TO SPECIFICATIONS.
- I. (RS) INDICATES ROOM SIGNAGE. REFER TO A2-51 FOR SIGNAGE DETAILS.
- J. REFER TO A2-51 FOR FIRE EXTINGUISHER CABINET (FEC) AND AUTOMATED EXTERNAL DEFIBRILLATOR CABINET (AED) LOCATIONS.
- K. (NFECD) & (NAED) INDICATE EXISTING, RELOCATED UNITS.
- EQUIPMENT NOTES**
- (ALL NOTES MAY NOT BE INDICATED ON THIS SHEET)
1. ALTERNATING TYPE A, B, AND C LOCKERS WITH CONCRETE BENCH IN THIS ROOM. REFER TO A4-02 & A4-03 FOR ENLARGED PLAN AND A4-61 FOR LOCKER AND BENCH DETAILS.
2. TWO TIER METAL ATHLETIC LOCKERS (TYPE C) AND CONCRETE BENCH. REFER TO A4-02 FOR ENLARGED PLAN AND A4-61 FOR LOCKER AND BENCH DETAILS.
3. SINGLE TIER METAL ATHLETIC LOCKERS WITH METAL BASE (TYPE D). REFER TO A4-01 FOR LOCKER DETAILS.
4. SINGLE TIER METAL ATHLETIC LOCKERS (TYPE E) AND CONCRETE BENCH. REFER TO A4-02 FOR ENLARGED PLAN AND A4-61 FOR LOCKER AND BENCH DETAILS.
5. VOLLEYBALL STANDARDS AND NET TO BE PROVIDED BY OWNER.
6. TREATMENT / MASSAGE / TAPING TABLE, BY OWNER.
7. MUSCLE STRAIN UNIT, BY OWNER.
8. MONITOR, BY OWNER.
9. MONITOR ON ANGLED BRACKET, BY OWNER.
10. EXISTING MONITOR.
11. PL-1 CASEWORK WITH SS-1 COUNTERTOP.
12. WALL-MOUNTED GLASSLESS MIRRORS 48" X 132" PANELS. BASIS OF DESIGN IS ROSE BRAND GLASSLESS MIRRORS. REFER TO ELEVATION.
13. WALL-MOUNTED, BI-PARTING ACOUSTICAL CURTAIN. REFER TO ELEVATION.
14. WALL-MOUNTED SCOREBOARD. MOUNT WITH BOTTOM AT 11'-0" AFF. REFER TO SPECIFICATIONS.
15. MOTOR LED PROJECTION SCREEN. MOUNTED WITH CEILING MOUNT BRACKETS TO STRUCTURAL STEEL BEAM ABOVE. BASIS OF DESIGN IS DRAPER ACUMEN XL 163" DIAGONAL. INCLUDE 16" DROP.
16. WALL-MOUNTED WEB SLIDE UNIT, BY OWNER.
17. EXERCISE BICYCLE, BY OWNER.
18. EXISTING ROOM SIGNAGE TO REMAIN. REMOVE/REINSTALL AS REQUIRED FOR NEW FINISHES.
19. SINGLE TIER METAL ATHLETIC LOCKERS (TYPE B) AND CONCRETE BENCH. REFER TO A4-61 FOR LOCKER AND BENCH DETAILS.
20. ALTERNATING TYPE B AND C LOCKERS WITH CONCRETE BENCH. REFER TO A4-02 FOR ENLARGED PLAN AND A4-61 FOR LOCKER AND CONCRETE BENCH DETAILS.
21. FUTURE BATTING CAGE, BY OWNER.
22. PL-1 CASEWORK REFER TO A4-21 CASEWORK SCHEDULE.
23. 10" DIMENSIONAL SIGNAGE NOTING "MULTI-PURPOSE GYM". REFER TO ELEVATION 3/A-22 FOR ADDITIONAL DETAILS.
24. DETAIL MOUNTED SHORT THROW PROJECTOR WITH PROTECTIVE CASE. BASIS OF DESIGN IS EPSON EB-Z0213B. PROJECTOR TO BE PROVIDED BY OWNER AND CASE TO BE INCLUDED IN PROJECT. REFER TO TECHNOLOGY DRAWINGS.
25. INSTALL NEW DEDICATION PLAQUE.
26. EXISTING BLEACHERS TO REMAIN.
27. VOLLEYBALL COURT LINES. REFER TO DETAIL 1/AQ-52.
28. BASKETBALL COURT LINES. REFER TO DETAIL 2/AQ-52.

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ZIONSVILLE COMMUNITY SCHOOLS

FANNING HOWEY

(800) 452-3573 WWW.FHAI.COM
350 E NEW YORK ST. SUITE 300, INDIANAPOLIS, IN 46204

KEY PLAN

ISSUED FOR BID

PAULA MILLER
REGISTERED
No. 13800161
STATE OF INDIANA
ARCHITECT

PROJECT MANAGER: JM
DRAWN BY: AML
PROJECT NUMBER: 224018.00
PROJECT ISSUE DATE: 01/21/2025

REV. NO.	DESCRIPTION	DATE
1	ADDENDUM #1	02/11/2025
2	ADDENDUM #2	02/18/2025

FIRST FLOOR EQUIPMENT PLAN



AQ-11

**ZIONSVILLE COMMUNITY
SCHOOLS**





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KEY PLAN

ISSUED FOR BID

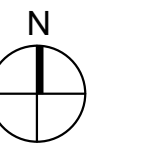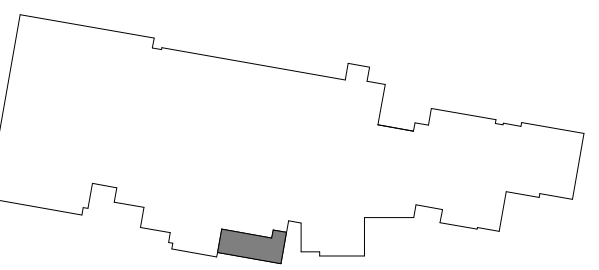REV. NO. 	DESCRIPTION	DATE
1	ADDENDUM #1	02/11/18
2	ADDENDUM #2	02/18/18

SECOND FLOOR EQUIPMENT PLAN

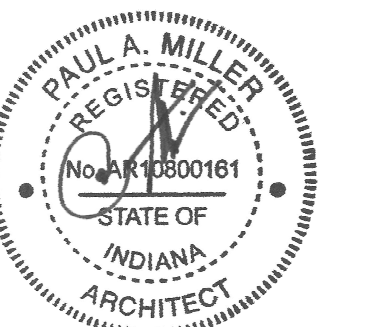AQ-12

EQUIPMENT GENERAL NOTES

EQUIPMENT NOTES

(ALL NOTES MAY NOT BE INDICATED ON THIS SHEET)

- 1 ALTERNATING TYPE A AND C LOCKERS WITH CONCRETE
2 ENLARGED PLATE REFER TO A0-61 AND A4-61 FOR
3 ENLARGED PLATE AND A0-61 FOR LOCKER AND BENCH
4 DETAILS
5 TWO TIER METAL ATHLETIC LOCKERS (TYPE A) AND
6 TWO TIER METAL ATHLETIC LOCKERS WITH METAL BASE
7 (TYPE B); REFER TO A0-61 FOR ENLARGED PLATE
8 AND A0-61 FOR LOCKER AND BENCH DETAILS
9 SINGLE TIER METAL ATHLETIC LOCKERS WITH METAL BASE
10 (TYPE C); REFER TO A0-61 FOR ENLARGED PLATE
11 AND A0-61 FOR LOCKER AND BENCH DETAILS
12 CONCRETE BENCH; REFER TO A0-44-02 FOR ENLARGED PLATE
13 AND A0-44-02 FOR LOCKER AND BENCH DETAILS
14 VOLLEYBALL STANDARDS AND NET TO BE PROVIDED BY
15 OWNER
16 TREATMENT / MASSAGE / TAPING TABLE; BY OWNER
17 MUSCLE STRAP; BY OWNER
18 MONITOR; BY OWNER
19 MONITOR ON ANGLED BRACKET; BY OWNER
20 EXISTING MONITOR
21 PL-1 CUBESHAIR WITH SS-M1 COUNTERTOP
22 WALL-MOUNTED SPRAYING MIRROR; 12" W X 13 1/2" PANELS;
23 BASE DESIGN IS ROSE BRASS GLASSLESS MIRRORS;
24 REFER TO ELEVATION
25 WALL-MOUNTED BIPARTING ACOUSTICAL CURTAIN; REFER
26 TO ELEVATION
27 WALL-MOUNTED SCOREBOARD; MOUNT WITH BOTTOM AT
28 CEILING MONITOR TO SPRAYING MIRROR
29 MOTOR-IZED PROJECTION SCREEN, MOUNTED WITH CEILING
30 MONITOR TO STRUCTURAL STEEL, 13" BEAM ABOVE;
31 PROPS OF DESK IS DRAWER ACUMEN XL, 19" DEAGN;
32 INCLUDE 16" DROP
33 WALL-MOUNTED WELD SUBE UNIT; BY OWNER
34 EXERCISE BICYCLE; BY OWNER
35 TREATMENT ROOM; BY OWNER; REMOVE/REINSTALL
36 AS REQUIRED FOR NEW FINISHES
37 SINGLE TIER METAL ATHLETIC LOCKERS (TYPE B) AND
38 CONCRETE BENCH; REFER TO A0-61 FOR LOCKER AND
39 BENCH DETAILS
40 ALTERNATING TYPE A AND C LOCKERS WITH CONCRETE
41 BENCH; REFER TO A0-44-02 FOR ENLARGED PLATE AND A0-61
42 FOR LOCKER AND CONCRETE BENCH DETAILS
43 FUTURE BATTING CAGE; BY OWNER
44 PL-1 CUBESHAIR; REFER TO 14-21.4 CUBESHAIR SCHEDULE
45 14-11 DIMENSION, SIGNAGE NOTING "MULTI-SERVICE GYM"
46 REFER TO ELEVATION FOR SIGNAGE AND ADDITIONAL DETAILS
47 CEILING- MOUNTED SHIRT-THROW PROJECTOR WITH
48 PROTECTIVE CASE; BASIS OF DESIGN IS EPSON EB-P02118
49 PROJECTOR; TO BE PROVIDED BY OWNER
50 INCLUDE IN PROJECT; REFER TO TECHNOLOGY DRAWINGS
51
52 INSTALL NEW DEDICATION PLAQUE
53 EXISTING BENCH TO BE RELOCATED
54 VOLLEYBALL COURT LINES; REFER TO DETAIL 11A0-52
55 BASKETBALL COURT LINES; REFER TO DETAIL 11A0-52

VERIFICATION NOTE


CONTRACTOR SHALL VERIFY ALL DIMENSIONS AND CLEARANCES AND ALL EXISTING FIELD CONDITIONS BEFORE STARTING CONSTRUCTION. COMMENCEMENT OF WORK CONSTITUTES ACCEPTANCE OF CONDITIONS.

SHOULD DIFFERENT CONDITIONS BE ENCOUNTERED, CONTACT THE ARCHITECT BEFORE PROCEEDING WITH WORK.

SCALE: 1/8" = 1'-0"

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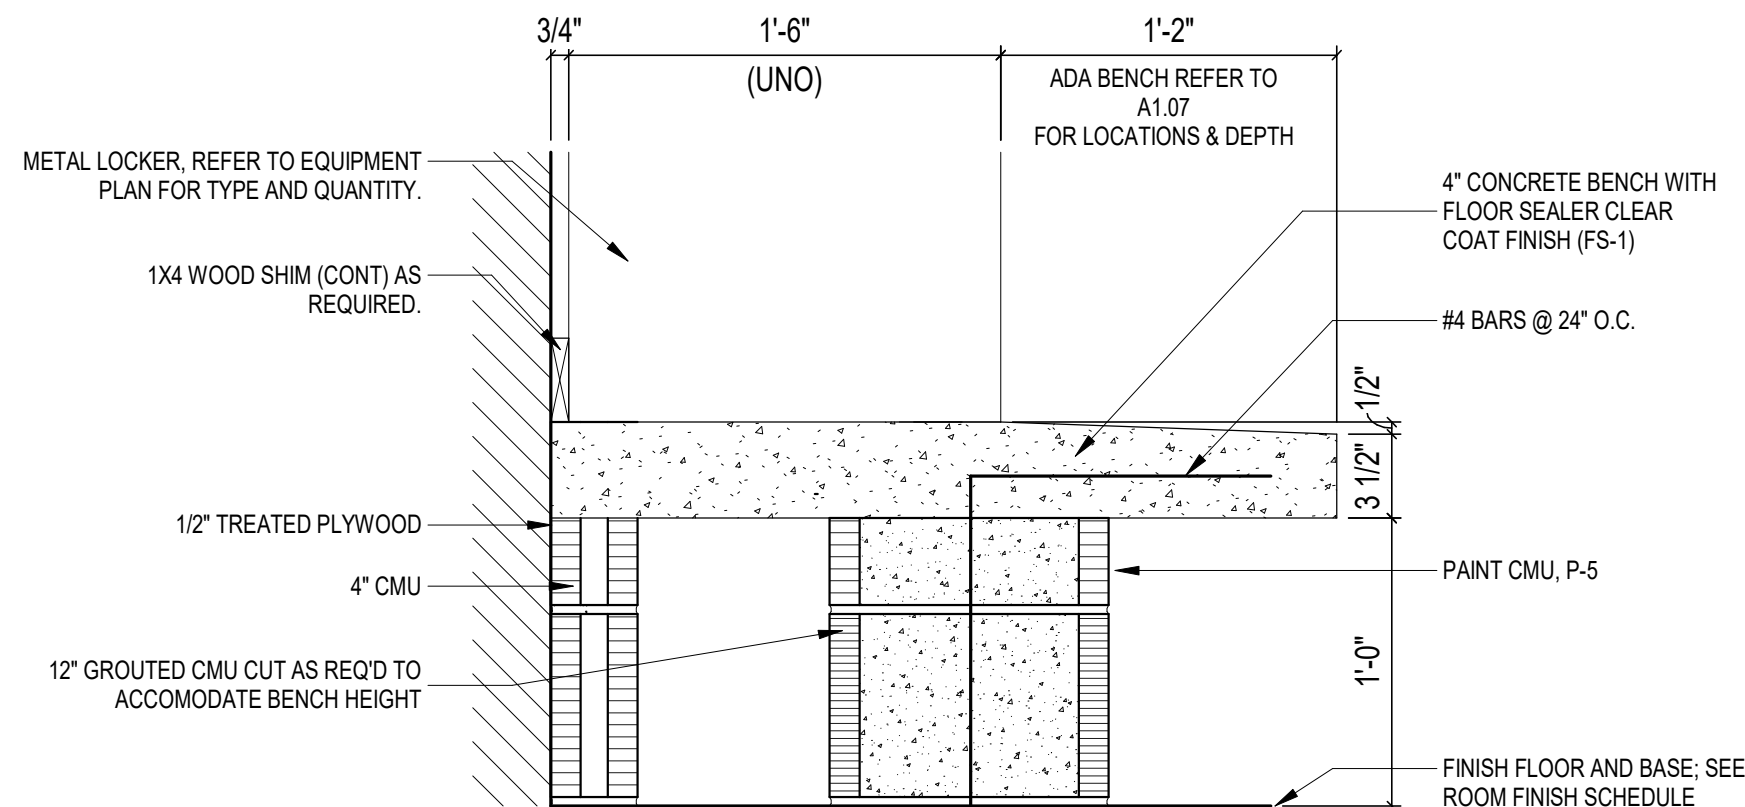


2 LOCKER DETAILS

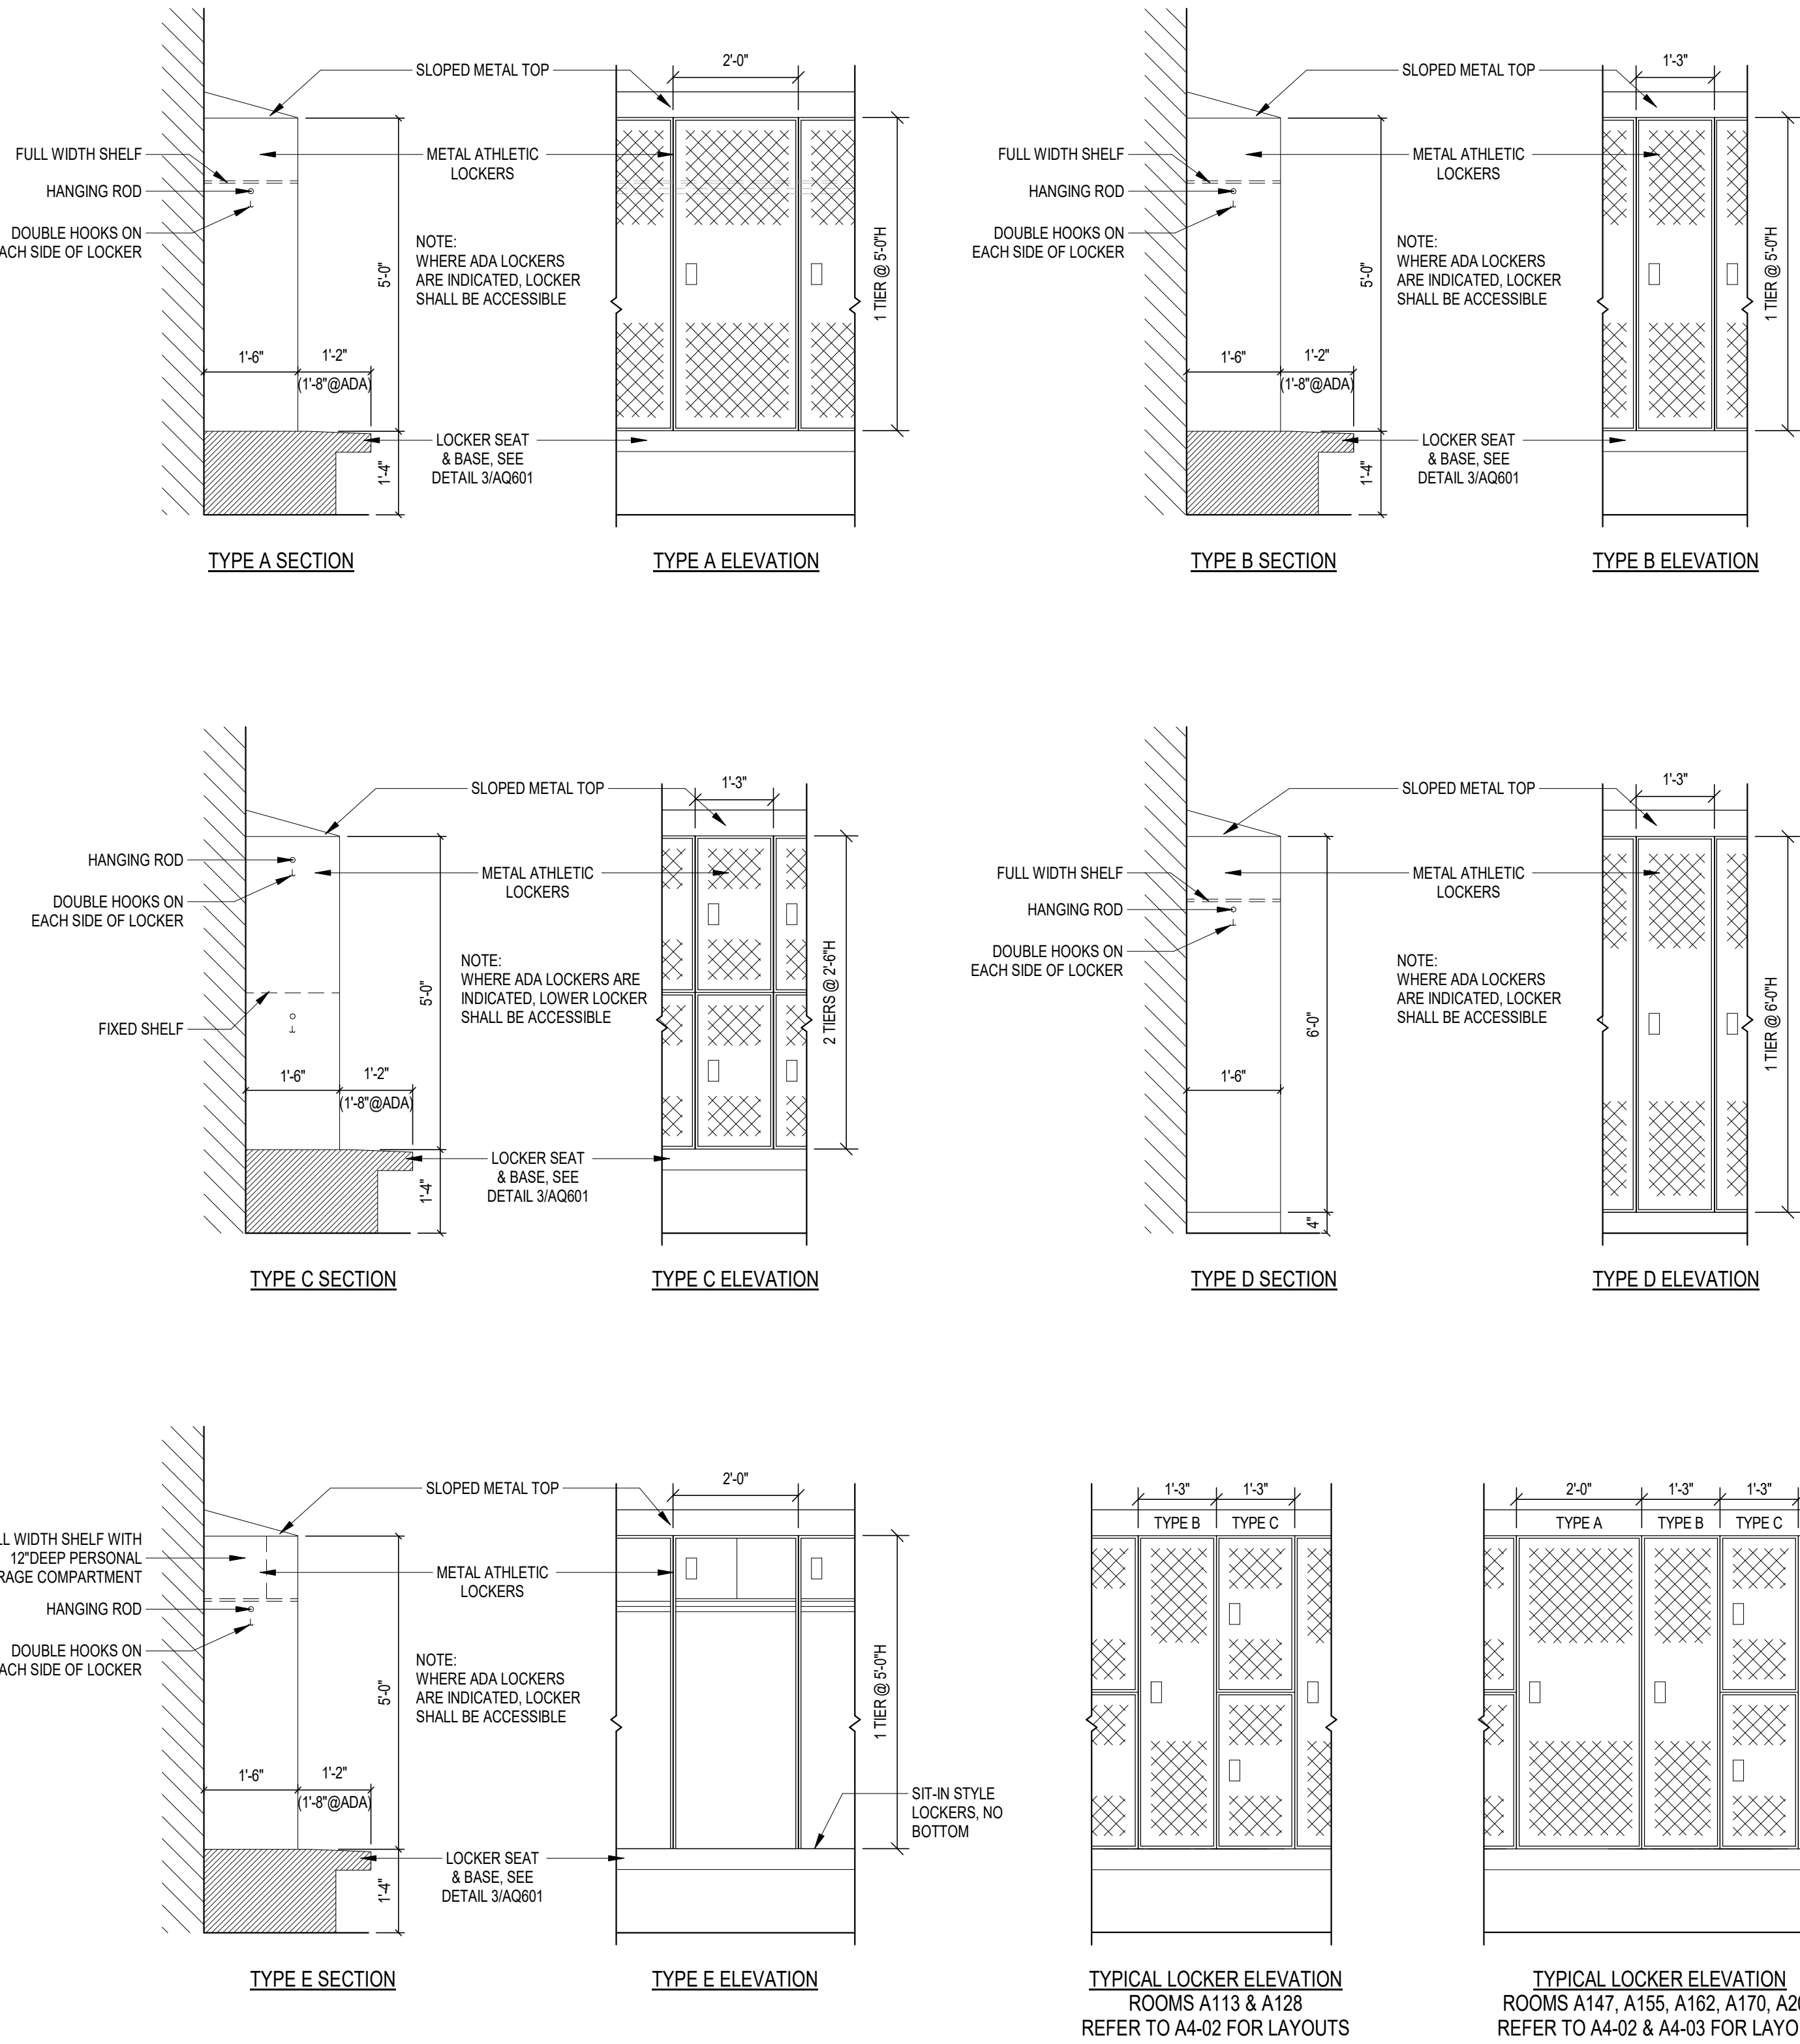SCALE: 1/2" = 1'-0"

3 CONCRETE BENCH SEAT - 18IN DEEP LOCKERS

SCALE: 1 1/2" = 1'-0"



PE EQUIPMENT SCHEDULE PROVIDED AND INSTALLED BY CONTRACTOR			
ITEM NO.	ITEM DESCRIPTION	ELEC. FIELD CONNECTION	BUILDING LOAD & MOUNTING
(PE-1)	SIDE-FOLDING BASKETBALL GOAL • BASIS OF DESIGN: PORTER 08070-200 AND 08079-300 • SIDE FOLDING, SIDE BRACED BASKETBALL BACKSTOP UNIT. INCLUDE ALL NECESSARY FITTINGS, PIPE BEAMS, ELECTRIC WINCH, CABLES, PULLEY, MOUNTING HARDWARE, & CONTROLLER AS REQUIRED FOR COMPLETE INSTALLATION. HEIGHT AS REQUIRED TO ACCOMMODATE STRUCTURE. • INCLUDE SAFETY STRAP BASKETBALL BACKSTOP SAFETY LOCK. • 72"W x 42"H RECTANGULAR GLASS BACKBOARD WITH FRAME, ONE SAFETY BOLT ON CUSHION EDGE/PAD, ONE FRONT MOUNT, POWR-FLEX GOAL, & ONE NYLON ANTI-WHIP NET. • BACKBOARD TO BE EQUIPPED WITH 800 SERIES POWR-TOUCH ELECTRIC HEIGHT ADJUSTMENT FROM 8' TO 10' WITH DIRECT GOAL ATTACHMENT & HEIGHT LOCK FEATURE. • REFER TO EQUIPMENT PLAN FOR DIRECTION OF FOLD. • BASKETBALL GOAL STRUCTURE TO BE MANUFACTURER'S STANDARD WHITE.	1 HP - 115V FOR FOLDING 1 4AMP - 115V FOR HEIGHT ADJUST DIGITAL KEYPAD CONTROL SYSTEM	STRUCTURAL LOAD PER UNIT: APPROXIMATELY 7,600LB STATIC LOAD PER GOAL MOUNTING: PROVIDE 3 BEAMS FOR ATTACHMENT PER GOAL
(PE-2)	GYMNASIUM DIVIDER CURTAIN • BASIS OF DESIGN: PORTER 90670000, 9100700X, 10756-00 • 54 LONG FOLD-UP GYM DIVIDER CURTAIN WITH LOWER SECTION OF 18' HIGH SOLID VINYL WITH 4H MESH ABOVE. INCLUDE ALL NECESSARY FITTINGS, PIPE BEAMS, ELECTRIC HOIST OPERATION, CABLES, PULLEY, MOUNTING HARDWARE, & CONTROLLER FOR COMPLETE INSTALLATION. • INCLUDE LINE SHAFT SAFETY LOCK. • COLOR: STANDARD, TID	1 HP - 115V/60Hz SINGLE PHASE DIGITAL KEYPAD CONTROL SYSTEM	STRUCTURAL LOAD PER UNIT: APPROXIMATELY 18LB/LF MOUNTING: PROVIDE BEAM IN LINE WITH CURTAIN & PROVIDE CROSS-BRACING AS REQUIRED
(PE-3)	VOLLEYBALL FLOOR SLEEVE WITH CHROME COVER AND SECOND-FLOOR ADAPTER • BASIS OF DESIGN: PORTER 08070-200 AND 08079-300 • INDOOR VOLLEYBALL/TENNIS FLOOR SLEEVE FOR GAME POST 3.75" O.D., 3.5" I.D., & 5" DIA. CHROME-PLATED SWIVEL COVER PLATE. • FLOOR SLEEVE TO BE LOCATED 5'-4" FROM COURT LINE, IN ACCORDANCE WITH MANUFACTURER'S RECOMMENDATION. • SLEEVE TO BE INSTALLED IN SLAB BEFORE FINISHED FLOORS ARE IN PLACE. • SECOND FLOOR ADAPTER INCLUDES WELDMENT TO 8"X1" ON UNDERSIDE OF SECOND FLOOR CONCRETE SLAB WITH CENTER 6" INSIDE DIA. BY 10" LONG SLEEVE TO ACCEPT GROUT FOR CASTING 9" LONG FLOOR SLEEVE INTO NON-SHRINK GROUT FILL. • ATTACH ADAPTER TO SLAB WITH MANUFACTURER'S RECOMMENDED ANCHORS.		
(PE-4)	WALL PADDING • BASIS OF DESIGN: PORTER 4120 • 2" WAINSCOT PADDING w/ BONDED FOAM FILLER, REFER TO ELEVATIONS FOR WIDTHS & HEIGHTS • WALL ATTACHMENT Z-CLIP ALUMINUM CHANNELS • PROVIDE MOLDED UNITS AS REQUIRED TO ACCOMMODATE ELECTRICAL DEVICES. • COLOR: BLACK		
(PE-5)	PE EQUIPMENT CONTROL SYSTEM • REFER TO SPECIFICATIONS FOR ADDITIONAL INFORMATION • CONTROL SYSTEM THAT ALLOWS OPERATION OF PE EQUIPMENT WITH DIGITAL TOUCHSCREEN CONTROL PAD. SYSTEM GIVES THE ABILITY TO CONTROL MULTIPLE BASKETBALL GOALS, DIVIDER CURTAIN, AND FUTURE BATTING CAGES FROM ONE LOCATION. • TO BE LOCATED ON CMU WALL AS SHOWN ON EQUIPMENT PLAN		

NOTE: LOADS ARE APPROXIMATE AND BASED ON THE EQUIPMENT ONLY - NOT DYNAMIC FORCES OR LOADS AT INDIVIDUAL CONNECTION POINTS. ACTUAL LOADING INFORMATION SHOULD BE COORDINATED BETWEEN EQUIPMENT SUPPLIER AND PRE-ENGINEERED METAL BUILDING SUPPLIER.

RESIDENTIAL APPLIANCE SCHEDULE PROVIDED AND INSTALLED BY CONTRACTOR			
ITEM NO.	ITEM DESCRIPTION	ELEC. FIELD CONNECTION	PLUMB. FIELD CONNECTION
(A-1)	REFRIGERATOR WITHOUT ICEMAKER • 28 CU FT • FRENCH DOOR • NO DISPENSER • ENERGY STAR QUALIFIED • 70"H x 36"W x 35 11/16"D • COLOR: FINGERPRINT-RESISTANT STAINLESS STEEL • BASIS OF DESIGN: FRIGIDAIRE FRF2823AS	115V, 60Hz, 15AMP	
(A-2)	ICE MACHINE • PRODUCES 456 LB PER 24 HOURS • AIR-COOLED CONDENSER UNIT • UNIT MAKES 1/2" NUGGET ICE WITH 95% HARDNESS RATING • ICE MAKER IS 22"W X 24"D X 23"H • STORAGE BIN HAS 370LB CAPACITY • STORAGE BIN IS 22"W X 14"D X 14"H • COLOR: STAINLESS STEEL • BASIS OF DESIGN IS SCOTSMAN N0422 PRODIGY PLUS NUGGET ICE MACHINE WITH SCOTSMAN B225 STORAGE BIN	115V, 60Hz, 15AMP	X
(A-3)	WHIRLPOOL • 90 GALLON TANK CAPACITY WHIRLPOOL • SEAMLESS WELDED CONSTRUCTION TANK, FABRICATED FROM 304 GAUGE STAINLESS STEEL • INCLUDES 12HP ADJUSTABLE TURBINE WITH LOCKING DEVICE • INCLUDES THERMOMETER • INCLUDES 2" COMBINATION DRAIN OVERFLOW AND FILLER SPOUT • 46"L x 24"W x 25"H • COLOR: STAINLESS STEEL WITH SATIN FINISH • BASIS OF DESIGN IS WHITEHALL MANUFACTURING WHS-90-S	115V, 60Hz, 6.9AMP	X

CASEWORK SCHEDULE					
TYPE	NO.	SIZE			DESCRIPTION
		W	D	H	
B	63	3'-0"	2'-0"	2'-10"	BASE UNIT WITH TWO ADJUSTABLE SHELVES AND TWO HINGED DOORS
BS	122	3'-0"	2'-0"	2'-0"	ADULT ADA SINK BASE UNIT WITH A REMOVABLE ACCESS PANEL
D	115	1'-6"	2'-0"	2'-10"	DRAWER UNIT WITH FOUR EQUAL DRAWERS, 4-12 INCHES DEEP INSIDE
W	14	1'-6"	1'-2"	2'-6"	WALL UNIT WITH ONE ADJUSTABLE SHELF AND ONE HINGED DOOR
W	44	3'-0"	1'-2"	2'-0"	WALL UNIT WITH ONE ADJUSTABLE SHELF AND TWO HINGED DOORS
W	52	3'-0"	1'-2"	2'-6"	WALL UNIT WITH ONE ADJUSTABLE SHELF AND TWO HINGED DOORS
WDS	4	1'-0"	1'-0"	7'-0"	1 UNIT WIDE STUDENT WARDROBE WITH FIXED UPPER SHELF, 12 INCH WIDE COAT COMPARTMENT AND A DOUBLE COAT HOOK
WDS	6	2'-0"	1'-6"	7'-0"	2 UNIT WIDE AND 4 UNIT HIGH CURBIE, BASIS OF DESIGN IS STEVENS CABINET #62202

LIST OF FINISHES		
EQUIPMENT MATERIALS		
HP PLASTIC LAMINATE		
MATERIAL ABBREVIATION	MATERIAL/MANUFACTURER	COLOR SELECTION
PL-1	FORMICA	CHESTNUT WOODLINE 5884-58
MARKERBOARD		
WHITE		
METAL LOCKERS		
MATERIAL ABBREVIATION	MATERIAL/MANUFACTURER	COLOR SELECTION
ATHLETIC LOCKERS	REFER TO SPECIFICATIONS	TO BE SELECTED (GRAY)
SOLID SURFACE MATERIAL		
MATERIAL ABBREVIATION	MATERIAL/MANUFACTURER	COLOR SELECTION
SSM-1 (COUNTERTOPS) SSM-2 (SILLS)	CORIAN / LX HAUSYS / WILSONART CORIAN / LX HAUSYS / WILSONART	GROUP 3, TO BE SELECTED GROUP 2, TO BE SELECTED
TACKBOARDS		
MATERIAL ABBREVIATION	MATERIAL/MANUFACTURER	COLOR SELECTION
TB	KOROSEAL / HARBORWEAVE	SCARBOROUGH
MISCELLANEOUS MATERIALS		
HORIZONTAL LOUVERED BLINDS		
MATERIAL ABBREVIATION	MATERIAL/MANUFACTURER	COLOR SELECTION
HLB	REFER TO SPECIFICATIONS	TO BE SELECTED
KICKPLATES		
STAINLESS STEEL		
SOLID PLASTIC TOILET PARTITIONS/COMPARTMENTS		
MATERIAL ABBREVIATION	MATERIAL/MANUFACTURER	COLOR SELECTION
	REFER TO SPECIFICATIONS	BLACK
SHOWER CURTAINS		
WHITE		

EQUIPMENT MATERIAL/FINISH GEN. NOTES

- COLOR SELECTION OF ALL FINISHES FOR INTERIOR ARCHITECTURAL WOODWORK/CUSTOM CASEWORK ITEMS ARE NOTED ON CASEWORK ELEVATIONS AND DETAIL DRAWINGS.
- EDUCATION CASEWORK FINISHES ARE AS FOLLOWS (UNLESS OTHERWISE NOTED):
 - COUNTERTOPS AND WORKSURFACES ARE TO BE SSM-1, UNLESS OTHERWISE NOTED.
 - HIGH PRESSURE PLASTIC LAMINATE CABINETS/VERTICAL SURFACES ARE TO BE PL-1, UNLESS OTHERWISE NOTED.
 - INTERIOR MELAMINE TO BE WHITE.
 - 3MM AND 1MM PVC EDGES ON CASEWORK ARE TO MATCH PL-1. COLOR SELECTION TO BE DETERMINED.
 - HANDLES TO BE BRUSHED CHROME.
 - HINGES TO BE BRUSHED CHROME.
- THE SAFETY WALL PADDING TO BE BLACK. REFER TO INTERIOR ELEVATIONS FOR DESIGN.
- ALL SAFETY PADDING ON BASKETBALL GOALS TO BE SELECTED BY ARCHITECT FROM MANUFACTURER'S FULL RANGE OF STANDARD AND DESIGNER VINYL COLOR SELECTIONS.
- GYMNASIUM DIVIDER CURTAIN VINYL COLOR TO BE SELECTED; TOP MESH TO BE WHITE. SUBMIT FULL RANGE OF MANUFACTURER'S STANDARD AND DESIGNER COLORS FOR SELECTION & APPROVAL.
- SCOREBOARD CABINET COLOR TO BE GREEN (SUBMIT FULL RANGE OF MANUFACTURER'S STANDARD AND DESIGNER VINYL COLOR SAMPLES FOR SELECTION & APPROVAL).
- REFER TO A1-61 FOR LIST OF FINISHES NOT INCLUDED ON THIS SHEET.

ZIONSVILLE COMMUNITY HIGH SCHOOL ATHLETIC LOCKER ROOMS ADDITION AND RENOVATION

1000 MULBERRY STREET,
ZIONSVILLE, IN 46077

ZIONSVILLE COMMUNITY SCHOOLS



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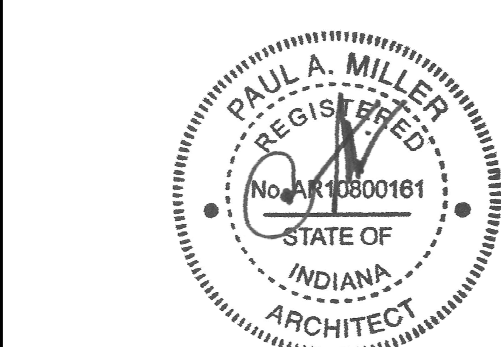
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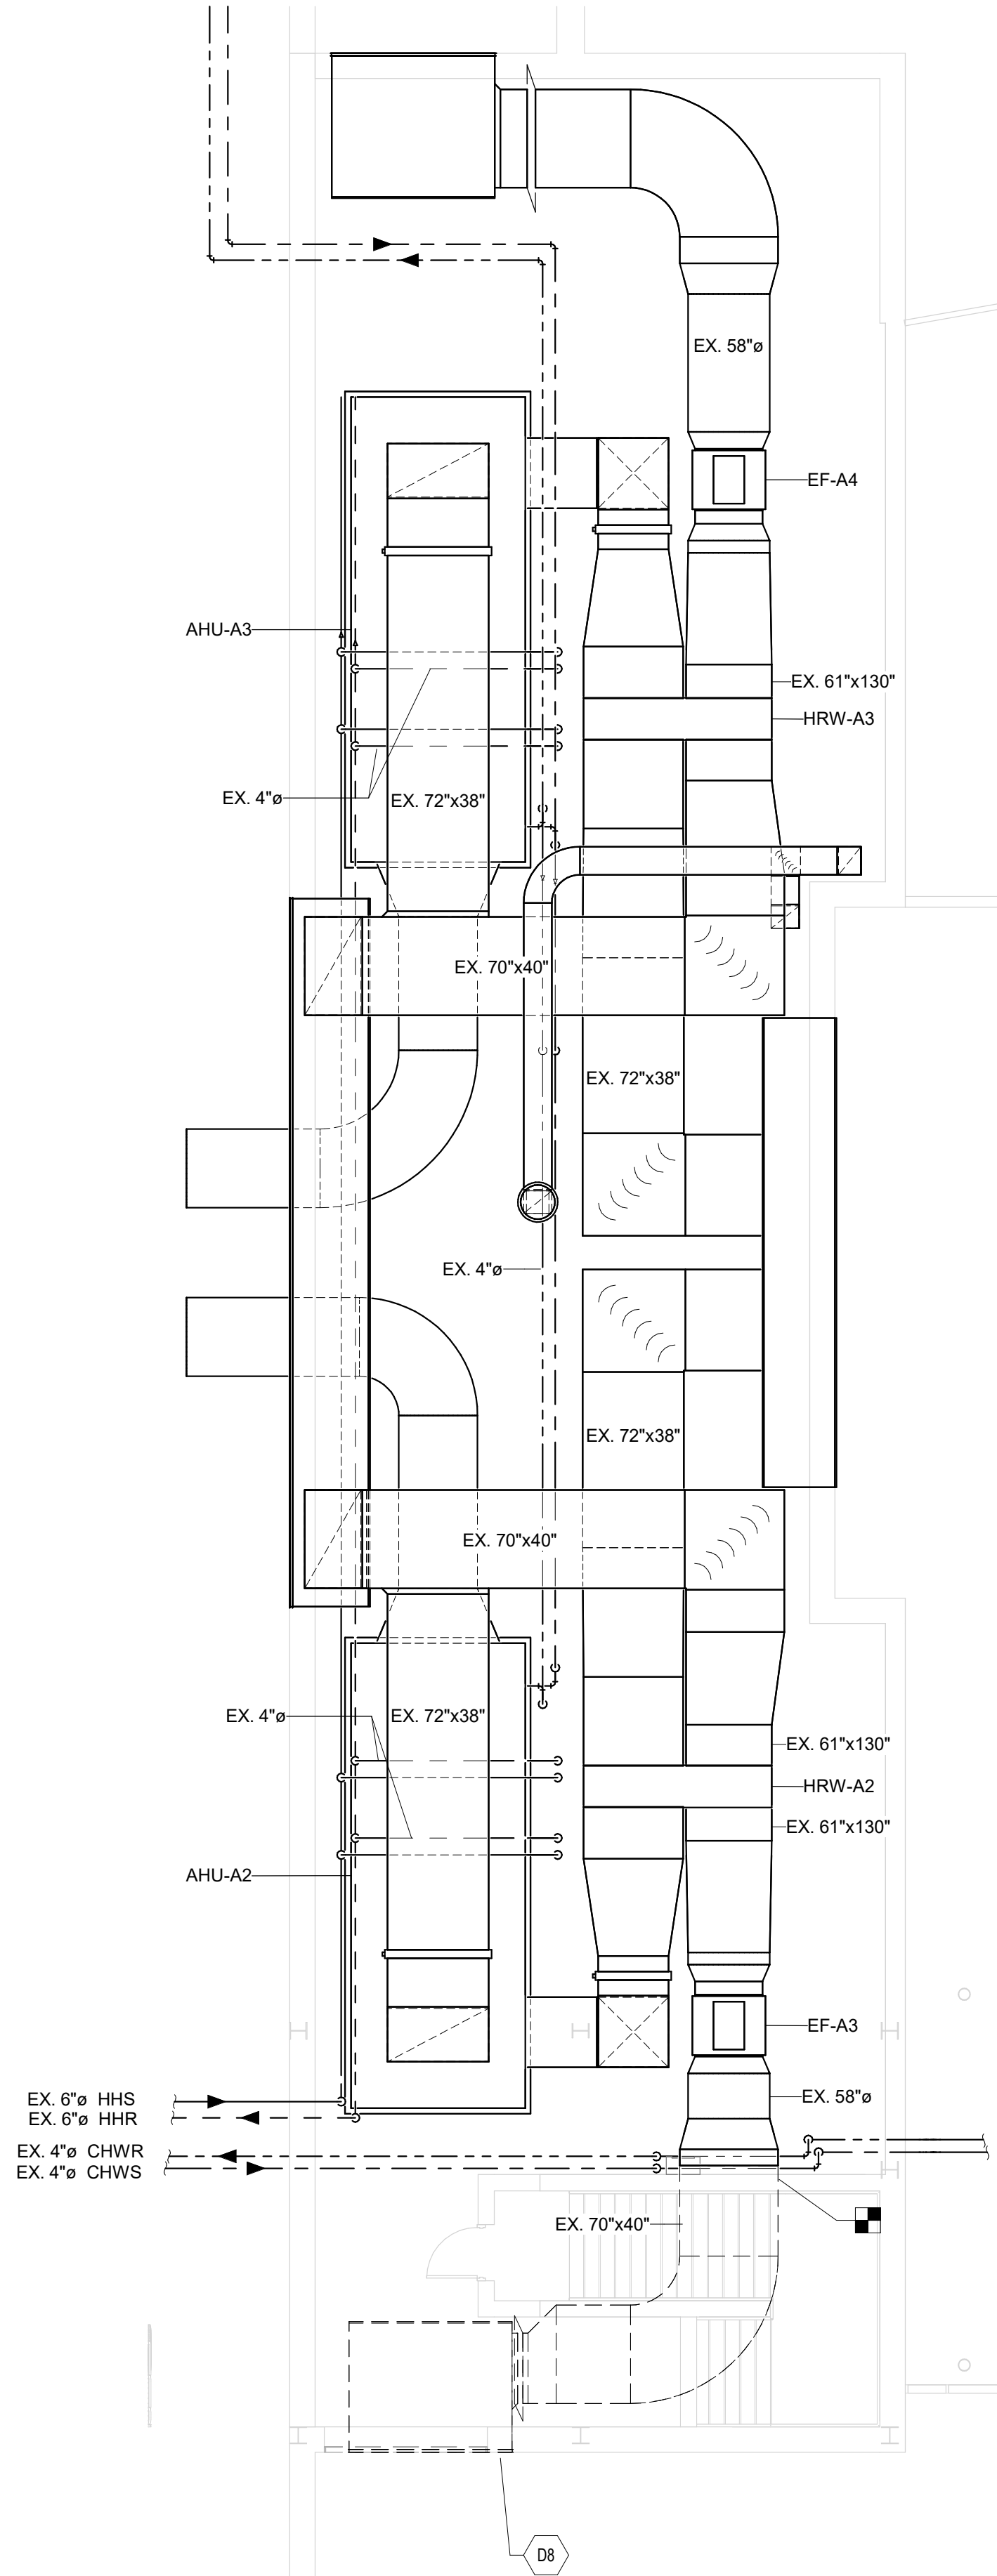
PROJECT MANAGER: JM
DRAWN BY: AML
PROJECT NUMBER: 224018.00
PROJECT ISSUE DATE: 01/21/2025

REV. NO.	DESCRIPTION	DATE
1	ADDENDUM #1	02/11/2025
2	ADDENDUM #2	02/18/2025

EQUIPMENT SCHEDULES & LOCKER DETAILS


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EQUIPMENT PLATFORM MECHANICAL ROOM DEMOLITION

SCALE: 1/8" = 1'-0"



EQUIPMENT PLATFORM MECHANICAL ROOM

SCALE: 1/8" = 1'-0"

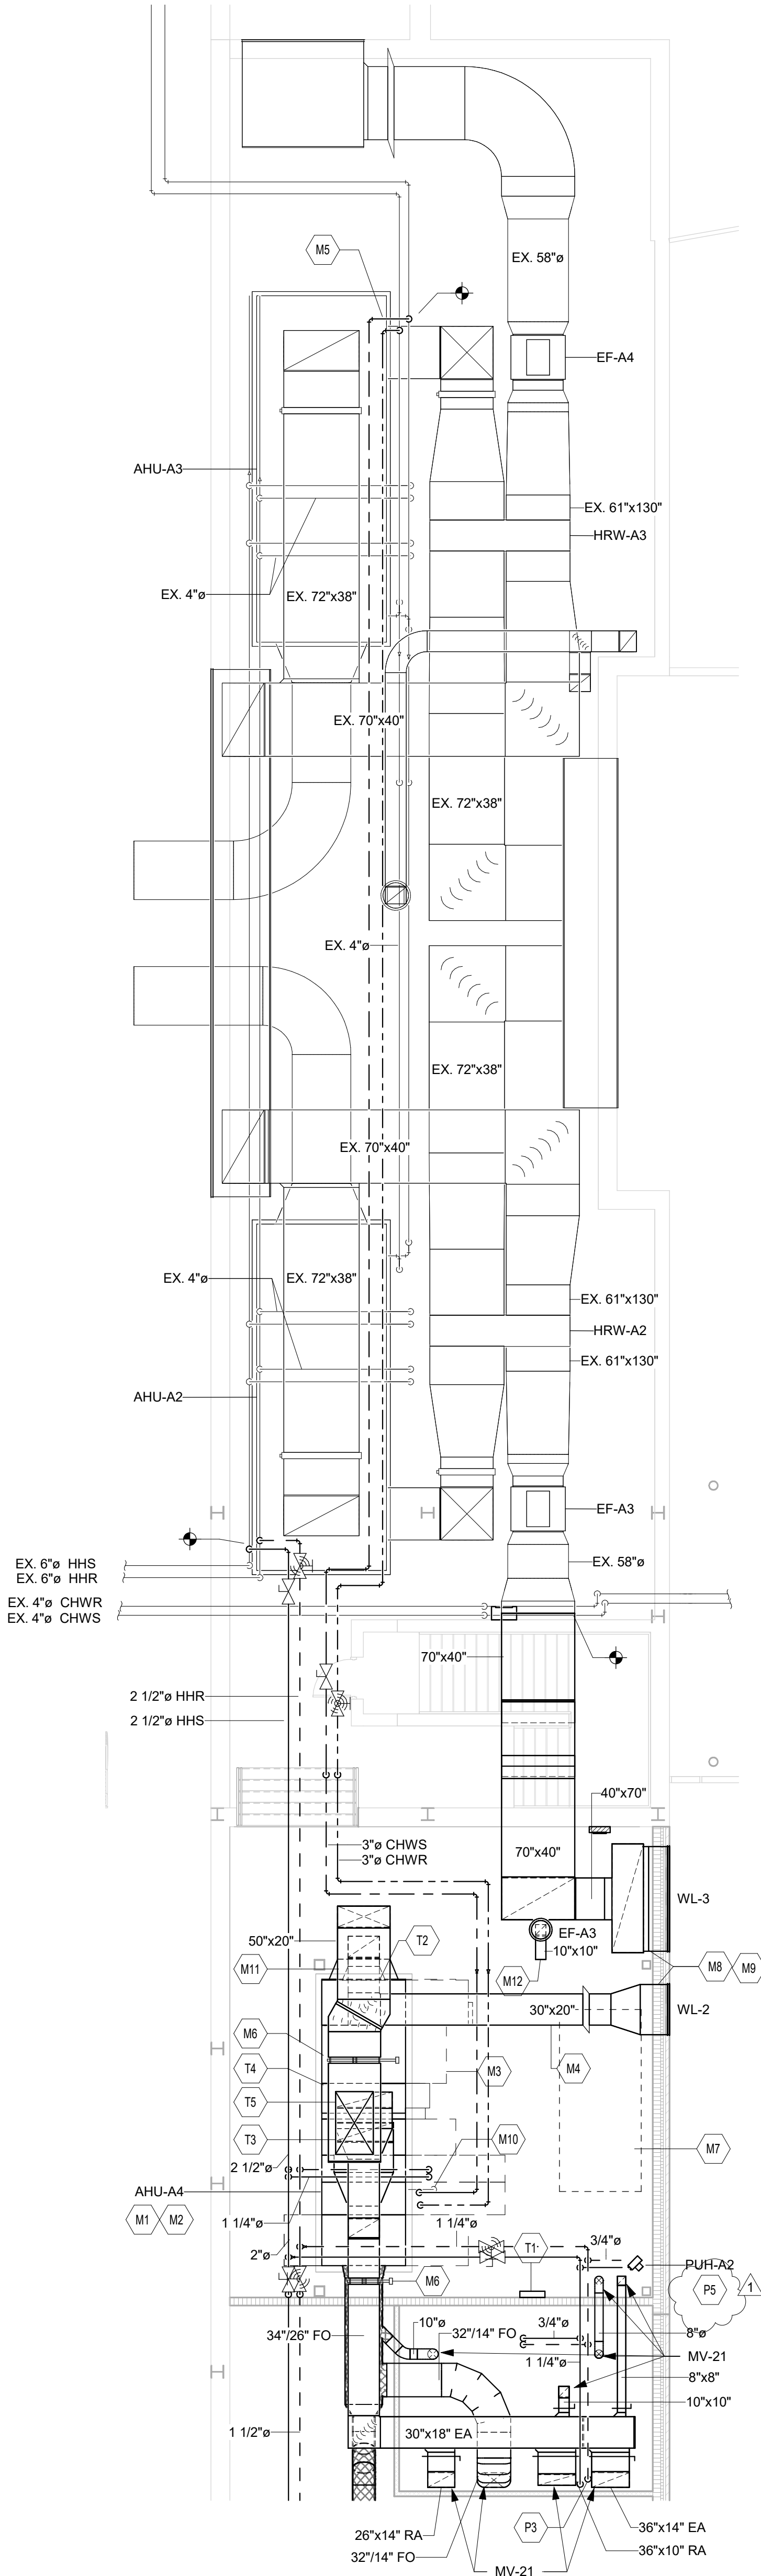MECHANICAL ROOM PLAN GENERAL NOTES

- ALL DUCTWORK, PIPING AND VALVES SHALL BE CONCEALED ABOVE THE CEILING AND WITHIN WALLS, UNLESS OTHERWISE NOTED.
- REFER TO THE SPECIFICATIONS FOR REQUIREMENTS RELATED TO EQUIPMENT QUALITY, CONSTRUCTION AND FINISH OF MATERIALS.
- ARRANGE DUCTWORK, PIPING, ETC. TO ALLOW FOR EASY ACCESS TO COOLS, VALVES, DAMPERS AND CONTROLS. KEEP AREAS ADJACENT TO ACCESS PANELS FREE AND CLEAR OF ANY OBSTRUCTIONS.
- SEAL DUCT PENETRATIONS THROUGH THE FLOOR AND/OR WALLS IN ACCORDANCE WITH MECHANICAL CODE AND SMACNA REQUIREMENTS. SEAL DUCT PENETRATIONS THROUGH FIRE RATED FLOORS AND/OR WALLS WITH A MATERIAL HAVING SAME FIRE RATING AS THE WALL AND/OR FLOOR.
- MECHANICAL CONTRACTOR IS RESPONSIBLE FOR HIS RESPECTIVE WORK FOR REPAIRING AND PATCHING TO MATCH EXISTING SURFACES: SIDEWALKS, STREETS, FLOORS, WALLS, ROOFS, CEILING AND PAVEMENT.
- ALL RECTANGULAR SHEET METAL DUCT SIZES SHOWN ARE INSIDE FREE AREA DIMENSIONS. ALL ROUND DUCT SIZES SHOWN ARE INSIDE DIAMETERS.
- PROVIDE BALANCING DAMPER AT EACH DUCT BRANCH, SERVING DIFFUSER, GRILLE AND REGISTER.
- INSTALL WALL THERMOSTATS, TEMPERATURE SENSORS, HUMIDISTATS, ETC. 44" ABOVE THE FINISH FLOOR IN ACCORDANCE WITH ADA REQUIREMENTS.
- COORDINATE ALL REQUIRED WALL, ROOF AND FLOOR OPENINGS (BOTH DIMENSIONS AND LOCATIONS) WITH ALL OTHER TRADES.
- COORDINATE MECHANICAL SYSTEM INSTALLATION WITH STRUCTURE, FIRE PROTECTION AND LIGHTING LAYOUT. PROVIDE ALL NECESSARY TRANSITIONS TO EQUIPMENT FROM SIZES SHOWN ON PLAN.
- ALL RETURN/EXHAUST AIR DUCT ABOVE LOCKERS/SHOWER AREAS SHALL BE MADE OF ALUMINUM IN ACCORDANCE WITH SMACNA REQUIREMENTS.
- HYDRONIC SUPPLY AND RETURN PIPING SHALL BE THE SAME SIZE UNLESS OTHERWISE NOTED.

MECHANICAL ROOM PLAN NOTES

(ALL NOTES MAY NOT BE INDICATED ON THIS SHEET)

- | NO. | DESCRIPTION |
|-----|---|
| D8 | EXISTING LOUVER TO BE REMOVED ALONG WITH ALL DUCTWORK BACK TO POINT INDICATED. DISPOSE OF ALL MATERIAL OFF SITE. PREPARE EXISTING DUCTWORK FOR CONNECTION TO NEW DUCTWORK. REFER TO NEW WORK PLAN. |
| M1 | INSTALL AIR HANDLER ON 8" HIGH CONCRETE HOUSEKEEPING PAD. COORDINATE AIR HANDLING UNIT LOCATION WITH STRUCTURAL COLUMN. IT IS THE CONTRACTOR'S RESPONSIBILITY TO COORDINATE WITH THE PROVIDED EQUIPMENT. |
| M2 | TRANSITION DUCTWORK AS REQUIRED TO MAKE FINAL CONNECTION TO AIR HANDLING UNIT. |
| M3 | CLEARANCE REQUIRED FOR AIR HANDLING UNIT COIL AND HEAT WHEEL PULLS. |
| M4 | WRAP EXHAUST DUCTWORK WITH INSULATION FROM AIR HANDLING UNIT TO ROOFTOP VENTILATOR/WALL LOUVER. INSTALL BACKDRAFT DAMPER IN DUCTWORK. |
| M5 | ROUTE CHILLED WATER PIPING TO GENERAL AREA INDICATED ON PLAN. COORDINATE WITH EXISTING FIELD CONDITIONS. |
| M6 | ELECTRONIC AIRFLOW MEASURING STATION MOUNTED IN DUCTWORK. STATION PROVIDED BY TEMPERATURE CONTROL CONTRACTOR AND INSTALLED BY MECHANICAL CONTRACTOR. COORDINATE EXACT LOCATION WITH UNIT MANUFACTURER. |
| M7 | APPROXIMATE LOCATION OF FUTURE HVAC EQUIPMENT. |
| M8 | INSTALL DRIP PAN UNDER WALL LOUVER. PAN SHALL BE SEALED WATER TIGHT. DRIP PAN TO EXTEND A MINIMUM OF 6" BEYOND DUCTWORK. |
| M9 | INSULATED SHEET METAL PLENUM MOUNTED BEHIND WALL LOUVER. TRANSITION BOTTOM OF DUCT AT A SLOPE DOWNWARD TO WALL LOUVER. SEAL ALL SEAMS AND EDGES WATER TIGHT. WRAP PLENUM WITH INSULATION. REFER TO DETAIL. |
| M10 | 1" INSULATED COPPER CONDENSATE PIPING TURNED DOWN TO DRAIN. END OF PIPE TO BE CUT AT 45 DEGREE ANGLE. |
| M11 | WRAP OUTSIDE AIR DUCTWORK WITH INSULATION FROM AIR HANDLING UNIT TO ROOFTOP VENTILATOR/WALL LOUVER. |
| M12 | END OF DUCT OPEN TO SPACE. OPENING TO BE PROTECTED WITH BIRDSCREEN. |
| P2 | PIPING ROUTED DOWN THROUGH CHASE. |
| P5 | SUPPORT UNIT HEATER FROM STRUCTURE ABOVE WITH SUPPLEMENTAL STEEL AND THICKERED ROD WITH VIBRATION ISOLATORS AS REQUIRED. |
| T1 | NEW AIR HANDLING UNIT CONTROL PANEL. MODEL LOCATION AS NEEDED BASED ON FIELD CONDITIONS. MOUNT TO EXISTING RAIL. |
| T2 | OUTSIDE AIR CONTROL DAMPERS FACTORY MOUNTED IN AIR HANDLING UNIT. DAMPER OPERATORS PROVIDED AND INSTALLED BY TEMPERATURE CONTROL CONTRACTOR. |
| T3 | RETURN AIR CONTROL DAMPERS FACTORY MOUNTED IN AIR HANDLING UNIT. DAMPER OPERATORS PROVIDED AND INSTALLED BY TEMPERATURE CONTROL CONTRACTOR. |
| T4 | ENERGY RECOVERY WHEEL BYPASS DAMPERS SHALL BE FACTORY MOUNTED IN AIR HANDLING UNIT. WIRING AND TERMINATIONS BY TEMPERATURE CONTROL CONTRACTOR. DAMPER OPERATORS PROVIDED BY TEMPERATURE CONTROL CONTRACTOR. |
| T5 | EXHAUST AIR CONTROL DAMPER SHALL BE FACTORY MOUNTED IN AIR HANDLING UNIT. DAMPER OPERATORS PROVIDED BY TEMPERATURE CONTROL CONTRACTOR. |

VERIFICATION NOTE

CONTRACTOR SHALL VERIFY ALL DIMENSIONS AND CLEARANCES AND ALL EXISTING FIELD CONDITIONS BEFORE STARTING CONSTRUCTION. COMMENCEMENT OF WORK CONSTITUTES ACCEPTANCE OF CONDITIONS.

SHOULD DIFFERENT CONDITIONS BE ENCOUNTERED, CONTACT THE ARCHITECT BEFORE PROCEEDING WITH WORK.

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ZIONSVILLE
COMMUNITY HIGH
SCHOOL ATHLETIC
LOCKER ROOMS
ADDITION AND
RENOVATION

1000 MULBERRY STREET,
ZIONSVILLE, IN 46077

ZIONSVILLE COMMUNITY
SCHOOLS



ZIONSVILLE
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KEY PLAN

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PROJECT MANAGER: JM

DRAWN BY: DJA

PROJECT NUMBER: 224018.00

PROJECT ISSUE DATE: 01/21/2025

REV. NO.	DESCRIPTION	DATE
1	ADDENDUM #2	02/16/2025

MECHANICAL ROOM

M4-01

**ZIONSVILLE COMMUNITY
SCHOOLS**



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50 E NEW YORK ST, SUITE 300, INDIANAPOLIS, IN 46204



PROJECT MANAGER: JM
DRAWN BY: DJA
PROJECT NUMBER: 224018.00
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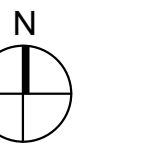
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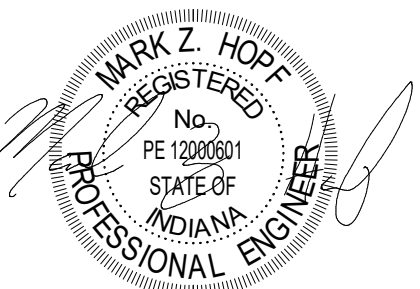


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50 E NEW YORK ST, SUITE 300, INDIANAPOLIS, IN 46204



SUED FOR BID



REV. _____

FIRST FLOOR PIPING & TEMPERATURE CONTROL PLAN

MP-11

- A. ALL PIPING AND VALVES SHALL BE CONCEALED ABOVE THE CEILING AND WITHIN WALLS, UNLESS OTHERWISE NOTED.
- B. REFER TO THE SPECIFICATIONS FOR REQUIREMENTS RELATED TO EQUIPMENT QUALITY, CONSTRUCTION AND FINISH MATERIAL.
- C. ARRANGE PIPING, ETC. TO ALLOW FOR EASY ACCESS TO KILLS, VALVES, DAMPERS AND CONTROLS. KEEP AREAS ADJACENT TO ACCESS PANELS FREE AND CLEAR OF ANY OBSTRUCTIONS.
- D. MECHANICAL CONTRACTOR IS RESPONSIBLE FOR HIS RESPECTIVE WORK FOR REPAIRING AND PATCHING TO MATCH EXISTING SURFACES, SIDEWALKS, STREETS, FLOORS, WALLS, ROOFS, CEILING AND PAVEMENT.
- E. HANGING SUPPLY AND RETURN AIR GRILLS SHALL BE THE SAME SIZE UNLESS OTHERWISE NOTED.
- F. ALL THERMOSTATS/SENSORS TO BE MOUNTED WITH BOTTOM AT 44" AFF UNLESS NOTED OTHERWISE.


(ALL NOTES MAY NOT BE INDICATED ON THIS SHEET)

NO.	DESCRIPTION
P1	DASHED LINE INDICATES APPROXIMATE CLEARANCE REQUIRED IN FRONT OF CONTROL PANEL TO VARIABLE VOLUME DAMPERS.
P2	PIPING ROUTED UP THROUGH BASE.
P3	PAINT PIPING INSULATION WHERE SEEN THROUGH FLOATING CEILINGS TO COLOR SELECTED BY THE ARCHITECT/ENGINEER.
P6	EXTEND CONDENSATE PIPING ABOVE EXISTING RESTROOM CEILING. CONNECT TO EXISTING CONDENSATE LINE ROUTED TO MECHANICAL ROOM. MODIFY ROUTING AS REQUIRED BASED ON EXISTING CONDITIONS. ADD CONDENSATE PUMP IF REQUIRED BASED ON EXISTING CONDITIONS. COORDINATE WITH ALL TRADES.
P7	EXTEND HYDRONIC PIPING ABOVE EXISTING RESTROOM CEILING. MODIFY ROUTING AS REQUIRED BASED ON EXISTING CONDITIONS.
P9	FIELD VERIFY SIZE AND LOCATION OF EXISTING PIPING IN AREA. TRANSITION NEW PIPING INTO EXISTING PIPING.

P6	EXTEND CONDENSATE PIPING ABOVE EXISTING RESTROOM CEILING. CONNECT TO EXISTING CONDENSATE LINE. ROUTED TO MECHANICAL ROOM. MODIFY ROUTING AS REQUIRED BASED ON EXISTING CONDITIONS. ADD CONDENSATE PUMP IF REQUIRED BASED ON EXISTING CONDITIONS. COORDINATE WITH ALL TRADES.
P7	EXTEND HYDRONIC PIPING ABOVE EXISTING RESTROOM CEILING. MODIFY ROUTING AS REQUIRED BASED ON EXISTING CONDITIONS.
P9	FIELD VERIFY SIZE AND LOCATION OF EXISTING PIPING IN AREA. TRANSITION NEW PIPING INTO EXISTING PIPING.

P7	EXTEND HYDRONIC PIPING ABOVE EXISTING RESTROOM CEILING. MODIFY ROUTING AS REQUIRED BASED ON EXISTING CONDITIONS.
P9	FIELD VERIFY SIZE AND LOCATION OF EXISTING PIPING IN AREA. TRANSITION NEW PIPING INTO EXISTING PIPING.

SCALE: 1/8" = 1'-0"

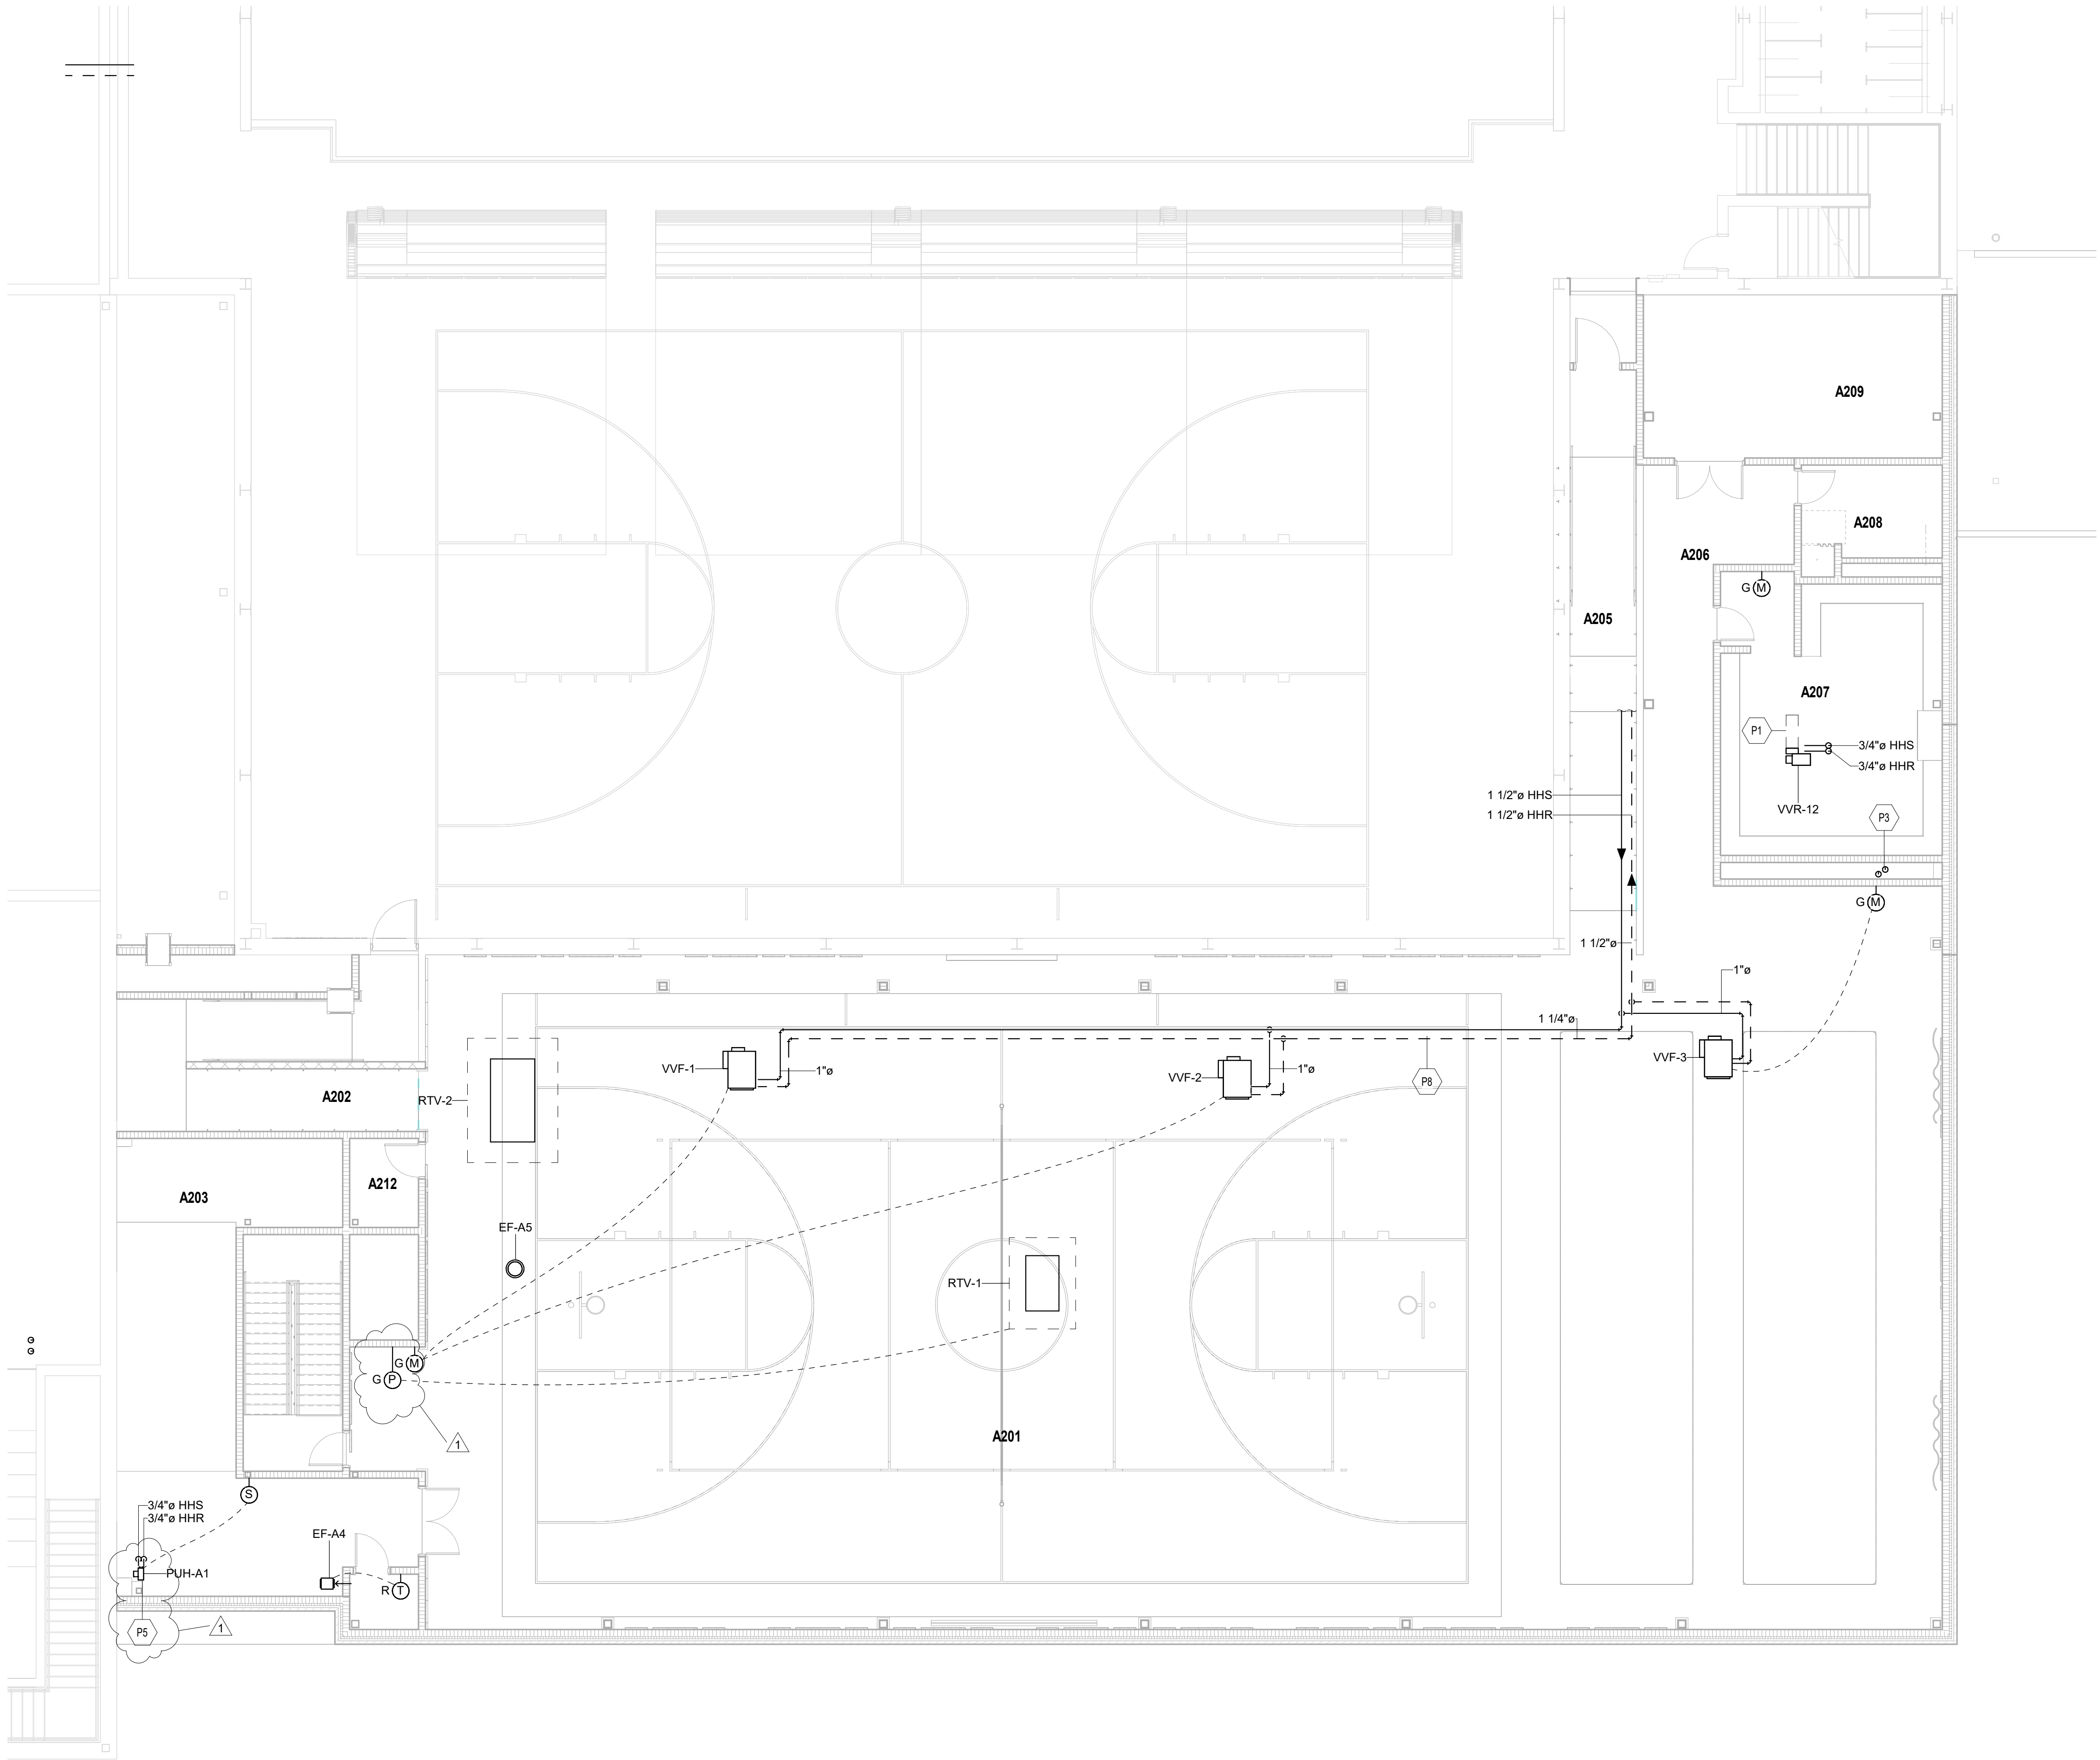

SECOND FLOOR PIPING PLAN

SCALE: 1/8" = 1'-0"

ROOM LEGEND		
ROOM NO.	ROOM NAME	AREA (SF)
A143	VESTIBULE	108 SF
A147	LOCKERS	806 SF
A149	VESTIBULE	44 SF
A201	MULTIPURPOSE	8616 SF
A202	RAMP 1	345 SF
A203	STORAGE	682 SF
A204	VESTIBULE	46 SF
A205	RAMP 2	317 SF
A206	CORRIDOR	310 SF
A207	LOCKERS	494 SF
A208	BATHROOM	112 SF
A209	STORAGE	399 SF
A210	EXISTING CORRIDOR	1422 SF
A212	SERVICE	50 SF
A213	IT CLOSET	31 SF
C203	Room	1098 SF
S1	STAIR	174 SF
XAE204	EXISTING CORRIDOR	2568 SF

HVAC PIPING PLAN GENERAL NOTES

- A. ALL PIPING AND VALVES SHALL BE CONCEALED ABOVE THE CEILING AND WITHIN WALLS, UNLESS OTHERWISE NOTED.
- B. REFER TO THE SPECIFICATIONS FOR REQUIREMENTS RELATED TO EQUIPMENT QUALITY, CONSTRUCTION AND FINISH OF MATERIALS.
- C. ARRANGE PIPING, ETC. TO ALLOW FOR EASY ACCESS TO COILS, VALVES, DAMPERS AND CONTROLS. KEEP AREAS ADJACENT TO ACCESS PANELS FREE AND CLEAR OF ANY OBSTRUCTIONS.
- D. MECHANICAL CONTRACTOR IS RESPONSIBLE FOR HIS RESPECTIVE WORK FOR REPAIRING AND PATCHING TO MATCH EXISTING SURFACES, SIDEWALKS, STREETS, FLOORS, WALLS, ROOFS, CEILING AND PAVEMENT.
- E. HYDRONIC SUPPLY AND RETURN PIPING SHALL BE THE SAME SIZE UNLESS OTHERWISE NOTED.
- F. ALL THERMOSTATS/SENSORS TO BE MOUNTED WITH BOTTOM AT 44" AFF UNLESS NOTED OTHERWISE.

HVAC PIPING PLAN NOTES

(ALL NOTES MAY NOT BE INDICATED ON THIS SHEET)

NO. DESCRIPTION

- P1 DASHED LINE INDICATES APPROXIMATE CLEARANCE REQUIRED IN FRONT OF CONTROL PANEL TO VARIABLE VOLUME TERMINAL.
- P2 PIPING ROUTED DOWN THROUGH CHASE.
- P5 SUPPORT UNIT HEATER FROM STRUCTURE ABOVE WITH SUPPLEMENTAL STEEL AND THREADED ROD WITH VIBRATION ISOLATORS AS REQUIRED.
- P8 PAINT PIPING INSULATION TO COLOR SELECTED BY THE ARCHITECT/ENGINEER.

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ZIONSVILLE COMMUNITY HIGH SCHOOL ATHLETIC LOCKER ROOMS ADDITION AND RENOVATION

1000 MULBERRY STREET,
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ZIONSVILLE COMMUNITY SCHOOLS



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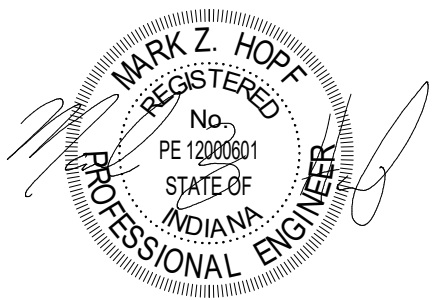
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KEY PLAN

ISSUED FOR BID



PROJECT MANAGER: JM
DRAWN BY: DJA
PROJECT NUMBER: 224018.00
PROJECT ISSUE DATE: 01/21/2025

REV. NO.	DESCRIPTION	DATE
1	ADDENDUM #2	02.18.2025

VERIFICATION NOTE
CONTRACTOR SHALL VERIFY ALL DIMENSIONS AND CLEARANCES AND ALL EXISTING FIELD CONDITIONS BEFORE STARTING CONSTRUCTION. COMMENCEMENT OF WORK CONSTITUTES ACCEPTANCE OF CONDITIONS.

SHOULD DIFFERENT CONDITIONS BE ENCOUNTERED, CONTACT THE ARCHITECT BEFORE PROCEEDING WITH WORK.

SECOND FLOOR PIPING & TEMPERATURE CONTROL PLAN

MP-21

**ZIONSVILLE COMMUNITY
SCHOOLS**



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[illegible]

MV-11

ROOM NO.	ROOM NAME	AREA (SF)
A101	CORRIDOR	1376 SF
A102	LAUNDRY	515 SF
A103	MECHANICAL	70 SF
A104	VESTIBULE	46 SF
A105	VESTIBULE	60 SF
A106	OFFICE	193 SF
A107	LOCKERS	110 SF
A108	RESTROOM	70 SF
A109	RESTROOM	129 SF
A110	STORAGE	19 SF
A111	RESTROOM	226 SF
A112	SHOWERS	127 SF
A113	LOCKERS	868 SF
A114	STORAGE	11 SF
A115	SERVICE SINK	34 SF
A116	REF RESTROOM	98 SF
A117	REF RESTROOM	96 SF
A118	STORAGE	85 SF
A119	VESTIBULE	46 SF
A120	VESTIBULE	60 SF
A121	OFFICE	237 SF
A122	LOCKERS	110 SF
A123	RESTROOM	70 SF
A124	VESTIBULE	129 SF
A125	STORAGE	19 SF
A126	RESTROOM	226 SF
A127	SHOWERS	127 SF
A128	LOCKERS	659 SF
A129	STORAGE	10 SF
A130	CORRIDOR	1707 SF
A131	STORAGE	92 SF
A132	VESTIBULE	41 SF
A133	VESTIBULE	62 SF
A134	LOCKERS	215 SF
A135	RESTROOM	182 SF
A136	VESTIBULE	62 SF
A137	LOCKERS	216 SF
A138	RESTROOM	182 SF
A139	VESTIBULE	40 SF
A140	STORAGE	134 SF
A141	LOBBY	396 SF
A142	OPEN OFFICE	306 SF
A143	VESTIBULE	108 SF
A144	OFFICE	250 SF
A145	STORAGE	12 SF
A146	RESTROOM	92 SF
A147	LOCKERS	806 SF
A148	RESTROOM	229 SF
A149	VESTIBULE	44 SF
A150	RESTROOM	66 SF
A151	VESTIBULE	106 SF
A152	OFFICE	249 SF
A153	STORAGE	12 SF
A154	RESTROOM	92 SF
A155	LOCKERS	799 SF
A156	RESTROOM	229 SF
A157	VESTIBULE	44 SF
A158	VESTIBULE	105 SF
A159	OFFICE	249 SF
A160	STORAGE	12 SF
A161	RESTROOM	86 SF
A162	LOCKERS	799 SF
A163	VESTIBULE	248 SF
A164	VESTIBULE	44 SF
A165	RESTROOM	66 SF
A166	VESTIBULE	306 SF
A167	OFFICE	250 SF
A168	STORAGE	12 SF
A169	RESTROOM	86 SF
A170	LOCKERS	794 SF
A171	RESTROOM	249 SF
A172	VESTIBULE	44 SF
A173	ELECTRONICAL	55 SF
A174	TECHNOLOGY	46 SF
A175	CORRIDOR	100 SF
A176	TRAINING	703 SF
A177	OFFICE	178 SF
A178	STORAGE	69 SF
A179	CORRIDOR	251 SF
A180	STORAGE	257 SF
A181	VESTIBULE	387 SF
S1	STAIR	174 SF

ALL DUCTWORK, PIPING AND VALVES SHALL BE CONCEALED ABOVE THE CEILING AND WITHIN WALLS. LESS VISIBLE AREAS SHALL BE CONCEALED IN WALLS.

REFER TO THE SPECIFICATIONS FOR REQUIREMENTS RELATED TO EQUIPMENT QUALITY, CONSTRUCTION AND INSTALLATION OF MATERIALS.

ARRANGE DUCTWORK, PIPING, ETC. TO ALLOW FOR EASY ACCESS TO COILS, VALVES, DAMPERS AND CONTROLS. PROVIDE SUFFICIENT CLEARANCE TO ACCESS PANELS FREELY AND CLEAR OF ANY OBSTRUCTIONS.

SEAL PENT PENETRATIONS THROUGH THE FLOOR AND ROOF TO PREVENT AIR LEAKAGE. IN ACCORDANCE WITH SMACNA REQUIREMENTS, SEAL DUCT PENETRATIONS THROUGH FIRE RATED FLOORS AND WALLS WITH A MATERIAL HAVING SAME FIRE RATING AS THE WALL AND AN FLOOR.

MECHANICAL CONTRACTOR IS RESPONSIBLE FOR HIS RESPECTIVE WORK FOR THE PROTECTING AND PATCHING TO MATCH SURFACE FINISHES OF THE CEILING, WALLS, FLOORS, WALLS, ROOFS, SIDING AND PAVEMENT.

ALL RECTANGULAR SHEET METAL DUCT SIZES SHOWN ON DRAWINGS ARE NOMINAL. ALL ROUND DUCT SIZES SHOWN ARE INSIDE DIMENSIONS.

PROVIDE BALANCING DAMPERS AT EACH DUCT BRANCH AND EACH FLOOR. PROVIDE GRILLE OR DIFFUSERS AT FLOORS, WALLS, THERMOSTATS, TEMPERATURE SENSORS, HUMIDISTATS ETC. 4" ABOVE THE FINISH FLOOR IN ACCORDANCE WITH ALL APPLICABLE CODES.

COORDINATE ALL REQUIRED WALL, ROOF AND FLOOR OPENINGS (BOTH DIMENSIONS AND LOCATIONS) WITH ALL OTHER TRADES.

COORDINATE MECHANICAL SYSTEM INSTALLATION WITH STRUCTURE, FIRE PROTECTION AND LIGHTING LAYOUT. COORDINATE WITH ALL OTHER TRADES.

FROM SIZES SHOWN ON PLAN.

ALL RETURN EXHAUST AIR DUCT ABOVE ROOF SHALL BE ALUMINUM OR GALVANIZED STEEL OR ALUMINUM IN ACCORDANCE WITH SMACNA REQUIREMENTS.

(ALL NOTES MAY NOT BE INDICATED ON THIS SHEET)

NO.	DESCRIPTION
1	EXISTING VARYING VOLUME TERMINAL, TO BE REINSTATE AT THIS APPROXIMATE LOCATION. COORDINATE EXACT LOCATION WITH EXISTING CONDITIONS AND ALL TRADES. REBALANCE TO NOTIFY AIRFLOW.
2	EXISTANCE AND/OR MOVED EXISTING DUCTWORK TO REBALANCE EXISTING CONDITIONS AND ALL TRADES. BALANCE / REBALANCE TO NOTIFY AIRFLOW.
3	REPLACE EXISTING DAMPER TO MAINTAIN TO MAINTAIN THE DOWNSTREAM DIFFUSER AIRFLOWS.
4	PROVIDE 12"x12" ACCESS PANEL IN DRYWALL CEILING TO ACCESS BALANCE DIFFUSER.
5	REPLACE EXISTING AIR HANDLING UNIT AS REQUIRED TO MAINTAIN LISTED DISPERSE AIRFLOWS. TEST AND BALANCE EXISTING UNIT.
6	REPLACE EXISTING EXHAUST FAN AS REQUIRED TO MAINTAIN LISTED AIR SERVICE AIRFLOWS. TEST AND BALANCE EXISTING UNIT.
7	PROVIDE DAMPER IN VERTICALLY DUCTWORK TO GROUND FLOOR AND LOCATION OF EXISTING DUCTWORK IN AREA. TRANSITION NEW DUCTWORK INTO EXISTING DUCTWORK.
8	DO NOT REMOVE DUCTWORK; REFER TO SPECIFICATIONS TO PAINT DUCTWORK TO OR SELECTED BY THE ARCHITECT/ENGINEER. CLEAN AND PREPARE DUCTWORK TO ENSURE PAINT ADHERES TO DUCTWORK.
9	APPROXIMATE LOCATION TO OPEN TO PLUMBING SPACE ABOVE CEILING.
10	APPROXIMATE LOCATION OF DUCT STATIC PRESSURE SENSOR. SENSOR PROVIDED BY THE TEMPERATURE AND HUMIDITY CONTRACTOR AND THE MECHANICAL CONTRACTOR. COORDINATE EXACT LOCATION WITH ALL TRADES.
11	REMOVE EXISTING OPENING DUCTWORK ABOVE THE CEILING. COORDINATE EXACT LOCATION WITH ALL TRADES.
12	IN THE BOTH 24x24 COMBUSTION AIR DUCTWORK INTO EXISTING DUCTWORK IN THIS AREA. ROUTE DUCTWORK UP THROUGH TO NEW EXHAUST FAN.

CONTRACTOR SHALL VERIFY ALL DIMENSIONS AND CLEARANCES AND ALL EXISTING FIELD CONDITIONS BEFORE STARTING CONSTRUCTION. COMMENCEMENT OF WORK CONSTITUTES ACCEPTANCE OF CONDITIONS.

SHOULD DIFFERENT CONDITIONS BE ENCOUNTERED, CONTACT THE ARCHITECT BEFORE PROCEEDING WITH WORK.



SCALE: 1/8" = 1'-0"

ZIONSVILLE COMMUNITY HIGH SCHOOL ATHLETIC LOCKER ROOMS ADDITION AND RENOVATION

1000 MULBERRY STREET,
ZIONSVILLE, IN 46077

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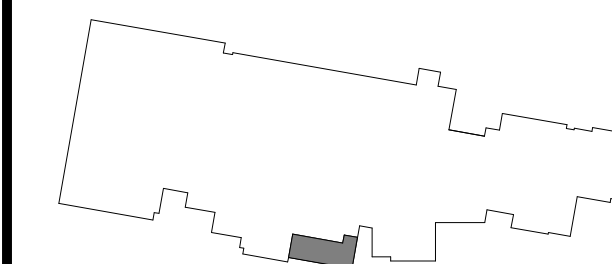
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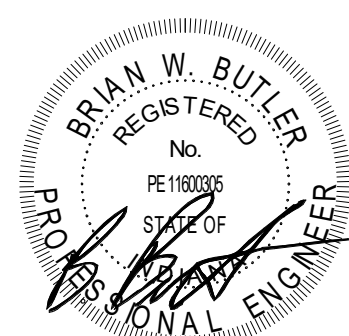
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PROJECT MANAGER: JM
DRAWN BY: RDR
PROJECT NUMBER: 224018.00
PROJECT ISSUE DATE: 01/21/2025

REV. NO.	DESCRIPTION	DATE
1	ADDENDUM #1	02/11/2025
2	ADDENDUM #2	02/18/2025


PANELBOARD SCHEDULE -
LUMINAIRE SCHEDULE - ONE-LINE
DIAGRAM

E-61

LUMINAIRE SCHEDULE											
PLAN TYPE	MANUFACTURER/CATALOG	MOUNTING	NO.	WATTS	LAMPS TYPE	LUMENS	APPLIED VOLTAGE	DESCRIPTION			
LD61	HALO H66 SERIES LITHONIA LDM6 SERIES PRESOLITE LF6-6RD SERIES	RECESSED	1	22 W	LED	1500 lm	277 V	6-INCH ROUND APERTURE OPEN REFLECTOR LED DOWNLIGHT, MEDIUM DISTRIBUTION, WHITE SPECULAR FINISH, WHITE FLANGE, SELF-FLANGED, 0-10VDC DIMMING, 4000K, BAR HANGER ACCESSORY.			
LD61X	HALO H66 SERIES LITHONIA LDM6 SERIES PRESOLITE LF6-6RD SERIES	RECESSED	1	22 W	LED	1500 lm	277 V	6-INCH ROUND APERTURE OPEN REFLECTOR LED DOWNLIGHT, MEDIUM DISTRIBUTION, WHITE SPECULAR FINISH, WHITE FLANGE, SELF-FLANGED, 0-10VDC DIMMING, 4000K, BAR HANGER ACCESSORY. PROVIDE WITH EMERGENCY TRANSFER DEVICE.			
LDW61	LITHONIA LDM6 SERIES PRESOLITE LF6-6RD 3H SERIES PORTFOLIO LD66 SERIES	RECESSED	1	8 W	LED	1000 lm	277 V	6-INCH ROUND APERTURE LED SHOWER LIGHT WITH REGRESSED LENS REFLECTOR, WHITE REFLECTOR AND TRIM, SELF-FLANGED, IP65 WET LOCATION LISTED.			
LDW61X	LITHONIA LDM6 SERIES PRESOLITE LF6-6RD 3H SERIES PORTFOLIO LD66 SERIES	RECESSED	1	8 W	LED	1000 lm	277 V	6-INCH ROUND APERTURE LED SHOWER LIGHT WITH REGRESSED LENS REFLECTOR, WHITE REFLECTOR AND TRIM, SELF-FLANGED, IP65 WET LOCATION LISTED. PROVIDE WITH EMERGENCY TRANSFER DEVICE.			
LE1X	LITHONIA WSR LED SERIES MCGRAW EDISON IMPACT SERIES BEACON PD12 SERIES	SURFACE WALL	1	34 W	LED	3900 lm	277 V	HALF-CYLINDER LED WALL MOUNTED LUMINAIRE WITH DIE CAST ALUMINUM HOUSING, BOTTOM DIFFUSER FLUSH WITH THE DIE CASTING, TYPE 3 DISTRIBUTION, 70 CRI LEDS, LUMINAIRE COLOR: DARK BRONZE, MOUNT ONTO JUNCTION BOX.			
LF2	LITHONIA CPX SERIES EATON METALUX CBT SERIES COLUMBIA CBT SERIES	RECESSED	1	36 W	LED	4000 lm	277 V	2 BY 4-FOOT, BACK LIT FLAT PANEL WITH ALUMINUM FRAME, 4000K, 80+ CRI, 0-10V DIMMING.			
LF2X	LITHONIA CPX SERIES EATON METALUX CBT SERIES COLUMBIA CBT SERIES	RECESSED	1	36 W	LED	4000 lm	277 V	2 BY 4-FOOT, BACK LIT FLAT PANEL WITH ALUMINUM FRAME, 4000K, 80+ CRI, 0-10V DIMMING, PROVIDE WITH EMERGENCY TRANSFER DEVICE.			
LF3	LITHONIA CPX SERIES EATON METALUX CBT SERIES COLUMBIA CBT SERIES	RECESSED	1	47 W	LED	4800 lm	277 V	2 BY 4-FOOT BACK LIT FLAT PANEL WITH ALUMINUM FRAME, 10% DIMMING, 4000K			
LF3X	LITHONIA CPX SERIES EATON METALUX CBT SERIES COLUMBIA CBT SERIES	RECESSED	1	47 W	LED	4800 lm	277 V	2 BY 4-FOOT BACK LIT FLAT PANEL WITH ALUMINUM FRAME, 10% DIMMING, 4000K, PROVIDE WITH EMERGENCY TRANSFER DEVICE			
LFW1	LITHONIA EPANL SERIES EATON METALUX 24 FP SERIES COLUMBIA CBT SERIES	RECESSED	1	39 W	SOLID STATE LED	4400 lm	277 V	1 BY 4-FOOT BACK LIT FLAT PANEL WITH ALUMINUM FRAME, 10% DIMMING, LISTED FOR WET LOCATIONS, IP65 RATED, NSF LISTED, FLANGE KIT			
LFW1X	LITHONIA EPANL SERIES EATON METALUX 24 FP SERIES COLUMBIA CBT SERIES	RECESSED	1	39 W	SOLID STATE LED	4400 lm	277 V	1 BY 4-FOOT BACK LIT FLAT PANEL WITH ALUMINUM FRAME, 10% DIMMING PROVIDE WITH EMERGENCY TRANSFER DEVICE. LISTED FOR WET LOCATIONS, IP65 RATED, NSF LISTED, FLANGE KIT			
LH18	METALUX OHB SERIES LITHONIA IBO SERIES COLUMBIA PEL SERIES	SUSPENDED	1	133 W	LED	18000 lm	277 V	RECTANGULAR LED HIGH BAY, GENERAL DISTRIBUTION, FROSTED ACRYLIC LENSES, 0-10VDC DIMMING, PROVIDE WITH WIRE GUARD, ALL MOUNTING HARDWARE AND ACCESSORIES FOR AIRCRAFT CABLE SUSPENSION.			
LH18X	METALUX OHB SERIES LITHONIA IBO SERIES COLUMBIA PEL SERIES	SUSPENDED	1	133 W	LED	18000 lm	277 V	RECTANGULAR LED HIGH BAY, GENERAL DISTRIBUTION, FROSTED ACRYLIC LENSES, 0-10VDC DIMMING, PROVIDE WITH WIRE GUARD ALL MOUNTING HARDWARE AND ACCESSORIES FOR AIRCRAFT CABLE SUSPENSION. PROVIDE WITH EMERGENCY TRANSFER DEVICE.			
LR2	METALUX WNLED SERIES LITHONIA SBL SERIES COLUMBIA LAW SERIES	SUSPENDED	1	48 W	LED	4000 lm	277 V	4-FOOT LED WRAP AROUND FIXTURE, ACRYLIC PRISMATIC DIFFUSER, 0-10VDC DIMMING, IF SUSPENDED, INSTALL AT 10-FOOT AFF WITH CONDUIT STEMS (UNO), 4000K			
LR2X	METALUX WNLED SERIES LITHONIA SBL SERIES COLUMBIA LAW SERIES	SUSPENDED	1	48 W	LED	4000 lm	277 V	4-FOOT LED WRAP AROUND FIXTURE, ACRYLIC PRISMATIC DIFFUSER, 0-10VDC DIMMING, PROVIDE WITH EMERGENCY TRANSFER DEVICE. IF SUSPENDED, INSTALL AT 10-FOOT AFF WITH CONDUIT STEMS (UNO), 4000K			
XC	SURE-LITES CX SERIES LITHONIA SIGNATURE SERIES DUAL-LITE SEMPRA SERIES	SURFACE CEILING	1	3 W	RED LED	0 lm	277 V	CAST ALUMINUM AC ONLY EXIT SIGN, SINGLE FACE, DIRECTIONAL ARROWS INDICATED, BLACK HOUSING, REFER TO PROJECT MANUAL FOR ADDITIONAL REQUIREMENTS.			
XVW	SURE-LITES LX SERIES LITHONIA LV SERIES DUAL-LITE SEVL SERIES	SURFACE WALL	1	3 W	RED LED	0 lm	277 V	CAST ALUMINUM, VANDAL RESISTANT AC ONLY EXIT SIGN, SINGLE FACE, DIRECTIONAL ARROWS INDICATED, BLACK HOUSING, LISTED FOR WET LOCATIONS, REFER TO PROJECT MANUAL FOR ADDITIONAL REQUIREMENTS.			
XV	SURE-LITES CX SERIES LITHONIA SIGNATURE SERIES DUAL-LITE SEMPRA SERIES	SURFACE WALL	1	3 W	RED LED	0 lm	277 V	CAST ALUMINUM AC ONLY EXIT SIGN, SINGLE FACE, DIRECTIONAL ARROWS INDICATED, BLACK HOUSING, REFER TO PROJECT MANUAL FOR ADDITIONAL REQUIREMENTS.			

LUMINAIRE SCHEDULE - GENERAL NOTES

- SEE SPECIFICATIONS FOR DRIVER REQUIREMENTS
- FOR ALL DOWNLIGHTING FIXTURES, PROVIDE REQUIRED MOUNTING HARDWARE FOR MOUNTING IN LAY-IN TYPE CEILINGS.
- CONTRACTOR TO VERIFY TYPES AND QUANTITY OF LIGHT FIXTURES REQUIRING EMERGENCY TRANSFER DEVICES AND PROVIDE REQUIRED QUANTITY OF EMERGENCY TRANSFER DEVICES, LABOR, MATERIAL, ETC. IN THE PROJECT BID FOR FIELD INSTALLATION OF EMERGENCY TRANSFER DEVICES.
- LIGHT FIXTURE SUBMITTALS TO INCLUDE DATA SHEETS FOR ALL FIXTURE TYPES, INCLUDING ADDITIONAL DATA SHEETS FOR DRIVER COMBINATIONS REQUIRED TO MEET THE INSTALLATION REQUIREMENTS OF THE VARIOUS FIXTURE TYPES INDICATED IN THE REMARKS COLUMN OF THE FIXTURE SCHEDULES OR ON THE DRAWINGS. SUBMITTALS SHALL ALSO INDICATE COLOR FOR ANY CUSTOM COLOR LIGHT FIXTURES.
- COLOR TEMPERATURE FOR ALL LIGHT FIXTURES IS TO BE 4,000K UNLESS NOTED OTHERWISE

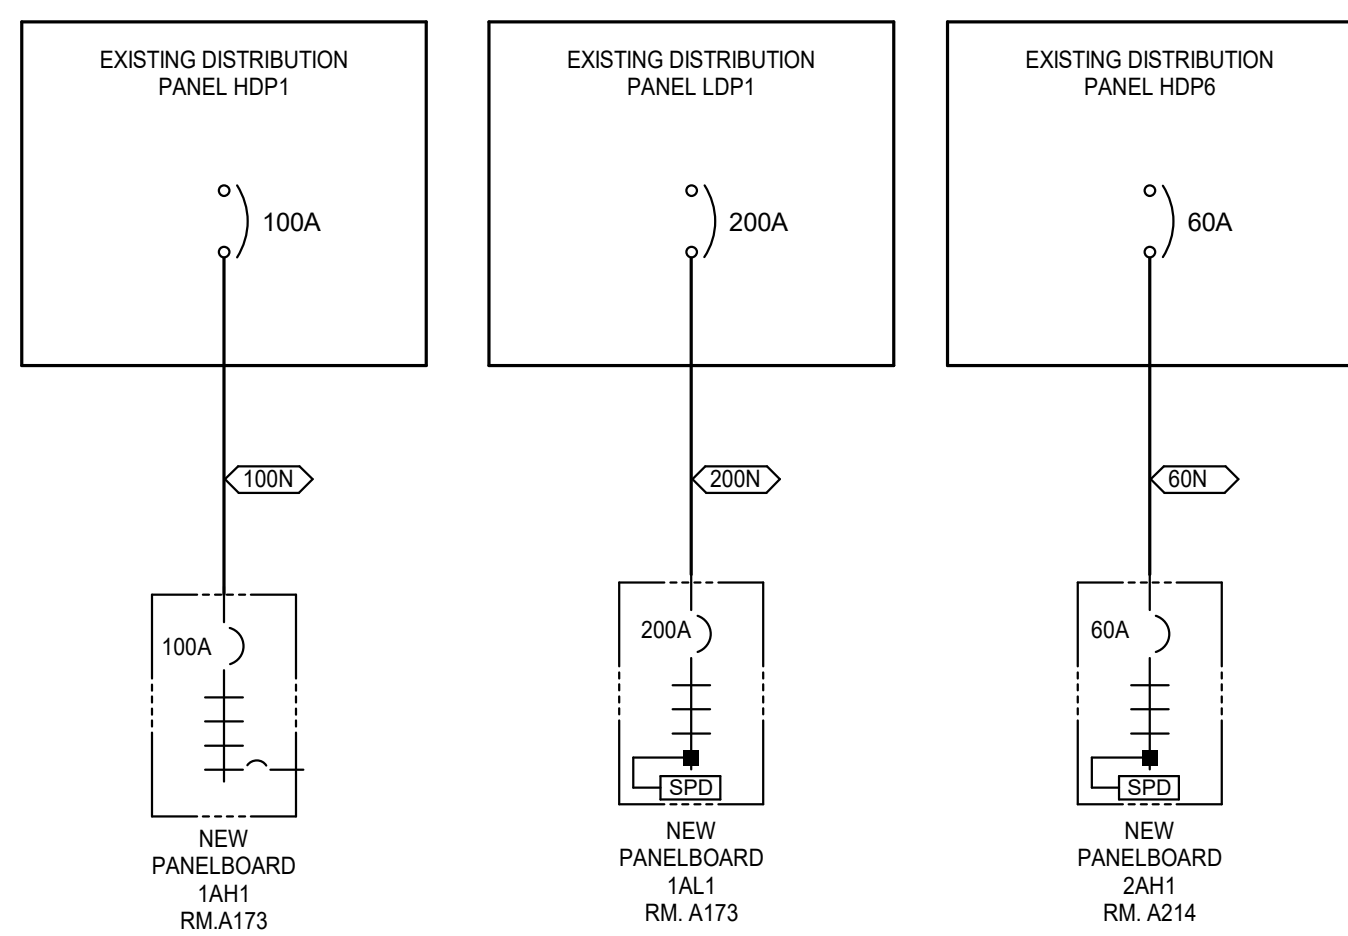

ONE- LINE DIAGRAMS

NO SCALE

Branch Panel: 2AH1

Location: A214
Supply From: HDP6
Mounting: Surface
Enclosure: Type 1

Volts: 480/277 Wye
Phases: 3
Wires: 4

A.I.C. Rating:
Mains Type: MLO
Mains Rating: 60 A
MCB Rating: 60 A

Notes: INTEGRAL SURGE PROTECTION

CKT	Circuit Description	Trip	Poles	A (VA)	B (VA)	C (VA)	Poles	Trip	Circuit Description	CKT	
1	LIGHTING RM. A205-A209, A214	20 A	1	660	3192			1	20 A LIGHTING RM. A201	2	
3	LIGHTING RM. A202, A203, A212, A213, S1	20 A	1		474	3381		20 A	VVFS	4	
5	AHU-A4, EXHAUST FAN 5HP RM. A214	20 A	3				2105, 7479	3	60 A AHU-A4, SUPPLY FAN 20HP, RM. A214	6	
7	--	--	--	2105	7479			--	--	8	
9	--	--	--		2105	7479		--	--	10	
11	AHU-A4, HEAT WHEEL 3HP RM. A214	20 A	3			1330	0	20 A	Spare	12	
13	--	--	--	1330	0			1	20 A Spare	14	
15	--	--	--		1330	0		1	20 A Spare	16	
17	Spare	20 A	1				0	0	1	20 A Spare	18
19	Spare	20 A	1	0	0			1	20 A Spare	20	
21	Spare	20 A	1		0	0		1	20 A Spare	22	
23	Spare	20 A	1				0	0	1	20 A Spare	24
25	Spare	20 A	1	0	0			1	20 A Spare	26	
27	Spare	20 A	1		0	0		1	20 A Spare	28	
29	Spare	20 A	1				0	0	1	20 A Spare	30
Total Load:				14766 VA	14769 VA	10914 VA					
Total Amps:				55 A	55 A	39 A					

Legend:

Load Classification	Connected Load	Demand Factor	Estimated Demand	Panel Totals
Lighting	4326 VA	100.00%	4326 VA	Total Conn. Load: 43049 VA Total Est. Demand: 45720 VA Total Conn.: 49 A Total Est. Demand: 55 A
Motor	32742 VA	117.13%	38351 VA	
HVAC	3381 VA	90.00%	3043 VA	

Notes:

Branch Panel: 1AH1

Location: A173
Supply From: Exit, HDP1
Mounting: Surface
Enclosure: Type 1

Volts: 480/277 Wye
Phases: 3
Wires: 4

A.I.C. Rating:
Mains Type: MLO
Mains Rating: 100 A
MCB Rating: 100 A

Notes: INTEGRAL SURGE PROTECTION

CKT	Circuit Description	Trip	Poles	A (VA)	B (VA)	C (VA)	Poles	Trip	Circuit Description	CKT
1	LIGHTING RM. A130, A141, A142, A173, A174,...	20 A	1	1553	1638				LIGHTING RM. A158-A172	2
3	LIGHTING RM. A143-A157	20 A	1		1632	0			Spare	4
5	Spare	20 A	1			0	0	1	20 A Spare	6
7	Spare	20 A	1	0	0			1	20 A Spare	8
9	Spare	20 A	1		0	0		1	20 A Spare	10
11	Spare	20 A	1			0	0	1	20 A Spare	12
13	Spare	20 A	1	0	0			1	20 A Spare	14
15	Spare	20 A	1		0	0		1	20 A Spare	16
17	Spare	20 A	1			0	0	1	20 A Spare	18
19	Spare	20 A	1	0	0			1	20 A Spare	20
21	Spare	20 A	1		0	0		1	20 A Spare	22
23	Spare	20 A	1			0	0	1	20 A Spare	24
25	Spare	20 A	1	0	0			1	20 A Spare	26
27	Spare	20 A	1		0	0		1	20 A Spare	28
29	Spare	20 A	1			0	0	1	20 A Spare	30
Total Load:				3191 VA	1632 VA	0 VA				
Total Amps:				12 A	7 A	0 A				

Legend:

Load Classification	Connected Load	Demand Factor	Estimated Demand	Panel Totals
Lighting	4823 VA	100.00%	4823 VA	Total Conn. Load: 4823 VA Total Est. Demand: 4823 VA Total Conn.: 6 A Total Est. Demand: 6 A

Notes:

Branch Panel: 1AL1

Location: A173
Supply From: T-A1
Mounting: Surface
Enclosure: Type 1

Volts: 208/120 Wye
Phases: 3
Wires: 4

A.I.C. Rating:
Mains Type: M.C.B
Mains Rating: 200 A
MCB Rating: 200 A


Notes: INTEGRAL SURGE PROTECTION

CKT	Circuit Description	Trip	Poles	A	B	C	Poles	Trip	Circuit Description	CKT	
1	W.C. RM. A201 (NOTE 1)	20 A	1	180	1080			20 A	RECEPTS RM. A202, A203, A212, A213	2	
3	RECEPTS RM. A201	20 A	1		1260	439		20 A	PUH, EFS RM. A201, A203	4	
5	RECEPTS RM. A201	20 A	1				1260	720	20 A	T.T.B. RM. A213	6
7	W.C. RM. A201 (NOTE 1)	20 A	1	180	180			20 A	TECH RACK RM. A213	8	
9	RECEPTS RM. A205-A209	20 A	1		1260	360		20 A	TECH RACK RM. A213	10	
11	VVR-12 RM. A201	20 A	1				0	180	20 A	SCOREBOARD RM. A201	12
13	BACKSTOP RM. A201	30 A	1	230	230			30 A	BACKSTOP RM. A201	14	
15	DIVIDER CURTAIN RM. A201	30 A	1		230	180		20 A	VIDEO PROJECTOR RM. A201	16	
17	PROJECTION SCREEN RM. A201	20 A	1			230	1127	20 A	AUTOMATIC DOOR OPENER RM. A175	18	
19	CUH-A1 RM. A175 EF, RM A166 EF, RM A170	20 A	1	1439	0			20 A	VVRS	20	
21	RECEPTS RM. A175, S1	20 A	1		1260	0		20 A	VVRS	22	
23	RECEPTS RM. A130, A173, A174	20 A	1			1080	720	20 A	T.T.B. RM. A174	24	
25	TECH RACK RM. A174	20 A	1	180	360			30 A	TECH RACK RM. A174	26	
27	RECEPTS RM. A165, A166, A170, A171	20 A	1		900	1890		20 A	RECEPTS RM. A187	28	
29	W.C. RM. A158, A160 (NOTE 1)	20 A	1			360	1890	20 A	RECEPTS RM. A159	30	
31	RECEPTS RM. A158, A161-A164	20 A	1	900	360			20 A	W.C. RM. A143, A151 (NOTE 1)	32	
33	RECEPTS RM. A151, A154-A156	20 A	1		1080	1890		20 A	RECEPTS RM. A152	34	
35	RECEPTS RM. A143, A146-A148, A150	20 A	1			1260	1890	20 A	RECEPTS RM. A144	36	
37	AUTOMATIC DOOR OPERATOR RM. A141	20 A	1	1127	1260			20 A	RECEPTS RM. A141	38	
39	RECEPTS RM. A142	20 A	1		1080	1080		20 A	RECEPTS RM. A176, A178	40	
41	RECEPTS RM. A176	20 A	1			1260	1620	20 A	RECEPTS RM. A177	42	
43	RECEPTS RM. A176, A179	20 A	1	1080	180			20 A	WHIRLPOOL RM. A176	44	
45	REFRIG. RM. A176	20 A	1		1000	180		20 A	WHIRLPOOL RM. A176	46	
47	ICE MAKER RM. A176	20 A	1			180	1440	20 A	RECEPTS RM. A121	48	
49	RECEPTS RM. A122, A133, A128, A130, A140	20 A	1	1260	1080			20 A	RECEPTS RM. A112, A126, A134, A135, A137...	50	
51	W.C. RM. A109, A124 (NOTE 1)	20 A	1		360	900		20 A	RECEPTS RM. A105, A116-A120	52	
53	RECEPTS RM. A106	20 A	1			1440	1440	20 A	RECEPTS RM. A107-A109, A113-A115, A131...	54	
55	GYM EQUIPMENT CONTROLLER RM. A201	20 A	1	180	180			20 A	BACKSTOP HEIGHT ADJUSTER RM. A201	56	
57	BACKSTOP HEIGHT ADJUSTER RM. A201	20 A	1		180	0		20 A	Spare	58	
59	Spare	20 A	1			0	0	20 A	Spare	60	
61	Spare	20 A	1	0	0			20 A	Spare	62	
63	Spare	20 A	1	0	0	0		20 A	Spare	64	
65	Spare	20 A	1			0	0	20 A	Spare	66	
67	Spare	20 A	1	0	0			20 A	Spare	68	
69	Spare	20 A	1		0	0	0	20 A	Spare	70	
71	Spare	20 A	1			0	0	20 A	Spare	72	
		Total Load:		11666 VA	15529 VA	18097 VA					

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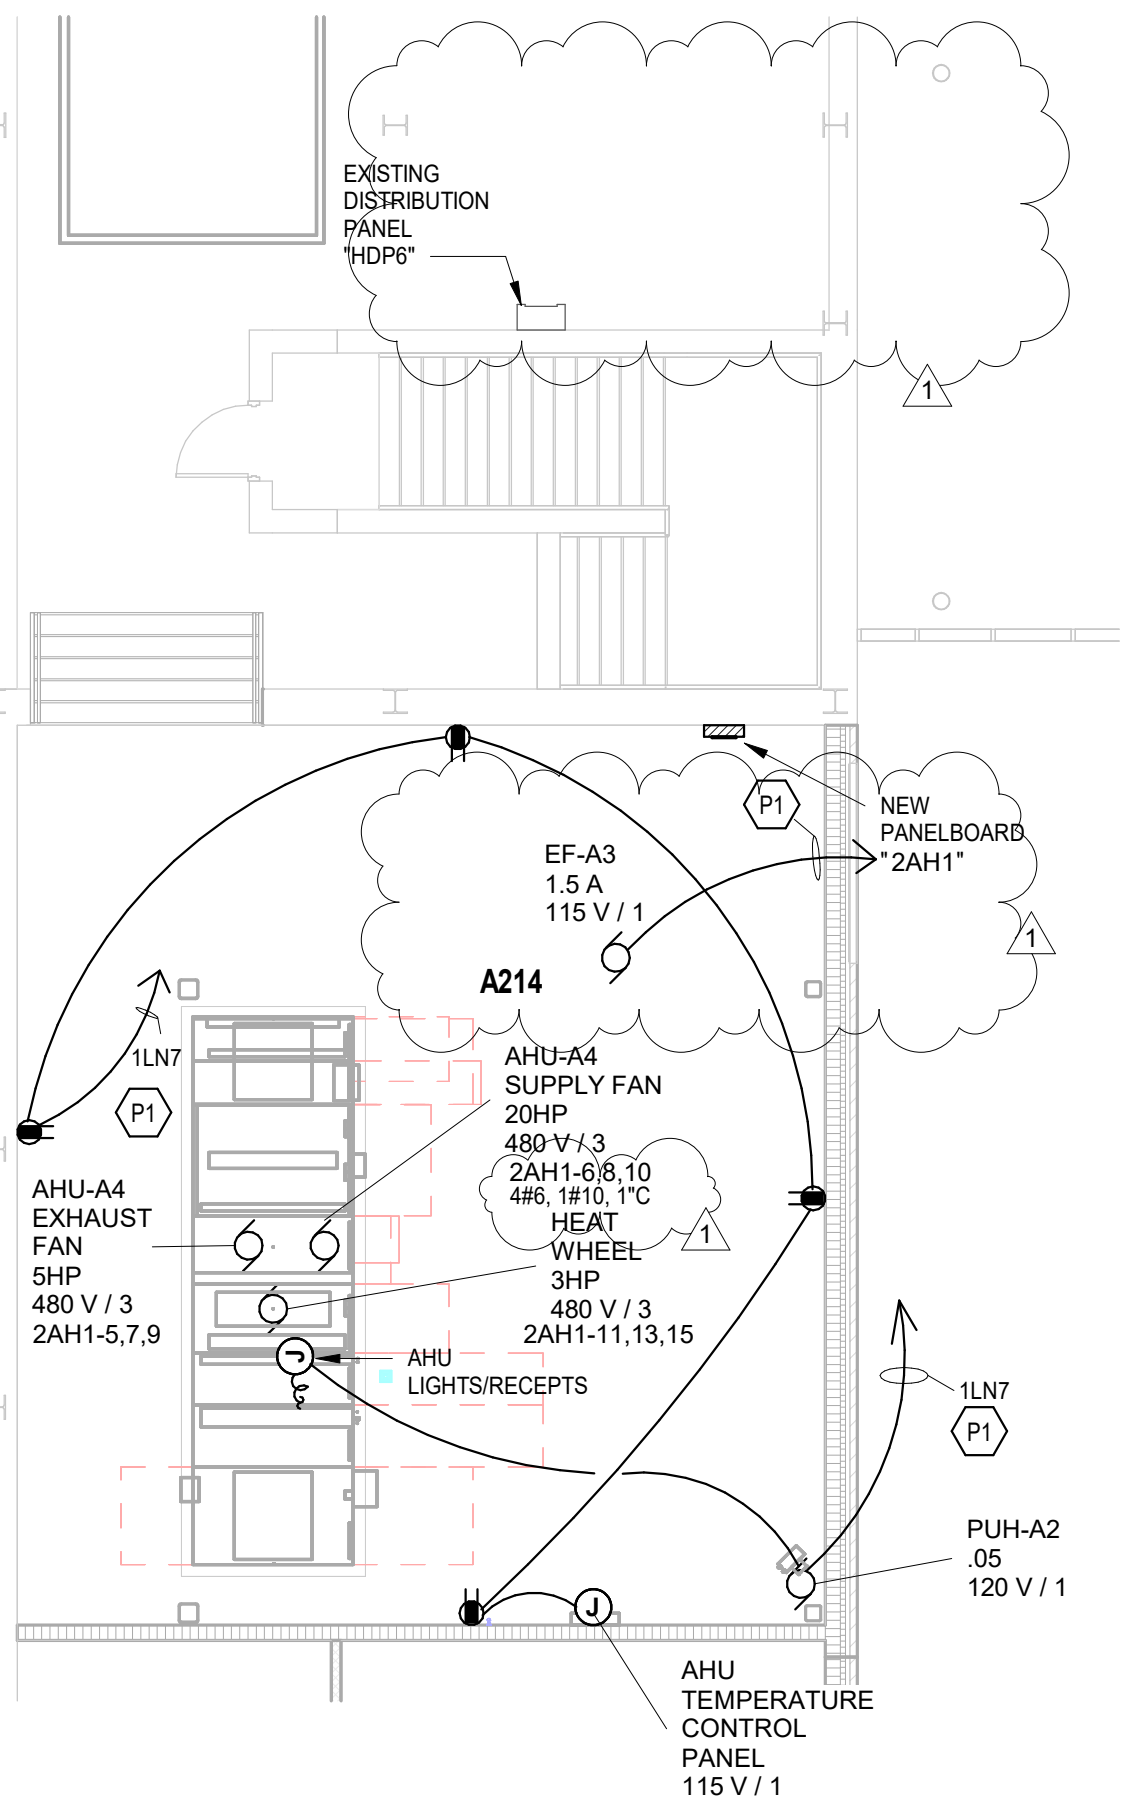
SECOND FLOOR POWER PLAN

EP-12


ROOM LEGEND - SECOND FLOOR UNIT A		
ROOM NO.	ROOM NAME	AREA (SF)
A201	MULTIPURPOSE	8618 SF
A202	RAMP 1	345 SF
A203	STORAGE	682 SF
A204	VESTIBULE	46 SF
A205	RAMP 2	317 SF
A206	CORRIDOR	310 SF
A207	LOCKERS	494 SF
A208	BATHROOM	112 SF
A209	STORAGE	399 SF
A210	EXISTING CORRIDOR	1422 SF
A211	EXISTING CORRIDOR	1219 SF
A212	SERVICE	50 SF
A213	IT CLOSET	31 SF
A214	EQUIPMENT PLATFORM	1257 SF

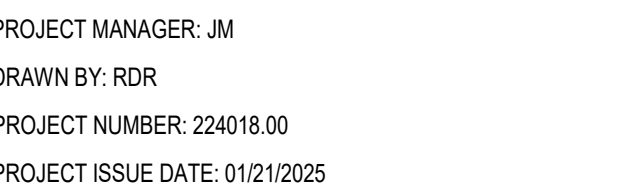1. PROVIDE REINFORCED TYPED PANELBOARD DIRECTORIES FOR EACH PANELBOARD ABOVE AND MODIFIED UNDER CONSTRUCTION. FIELD VERIFY EXISTING CIRCUIT BREAKERS WITH OWNERS. VERIFY ALL CIRCUIT BREAKERS IN THE PANELBOARD DIRECTORY IS ACCURATE. UNIPASS SPARE BREAKERS SHALL BE IN THE OFF POSITION. VOLTAGE PROTECTION RECEPTACLE TO BE MOUNTED ABOVE WALL MOUNTED RECEPTACLE.
2. CONTRACTOR SHALL VERIFY ALL DIMENSIONS AND CLEARANCES AND ALL EXISTING FIELD CONDITIONS BEFORE STARTING CONSTRUCTION. COMMENCEMENT OF WORK SHALL BE AFTER THE RECEPTION OF ALL NECESSARY PERMITS AND DRAWINGS. IF ANY ENCOUNTERED, CONTACT THE ARCHITECT BEFORE PROCEEDING WITH WORK.
3. PROVIDE RECEPTACLE TO BE MOUNTED ABOVE WALL MOUNTED RECEPTACLE NUMBER ON THE FACE OF EACH COVER PLATE WITH A TYPED LAMINATED LABEL.
4. PROVIDE "GFCI PROTECTED" LABEL ON COVER PLATE FOR ANY GFCI PROTECTED DEVICES.
5. CONTRACTOR SHALL INCREASE CIRCUIT CONDUCTOR SIZE TO COMPENSATE FOR VOLTAGE DROP DUE TO EXCESSIVE CIRCUIT LENGTHS. IN NO CASE SHALL VOLTAGE DROP EXCEED 3% TO THE END OF THE LINE.
6. REFER TO MECHANICAL PLANS FOR LOCATION OF MECHANICAL EQUIPMENT. LOCATE DISCONNECT SWITCHES PER NEC.
7. REFER TO ELECTRICAL SCHEMATIC AND MECHANICAL DRAWINGS FOR ADDITIONAL CIRCUIT, WIRING AND CONTROL CONNECTIONS.
8. ALL DEVICES, EQUIPMENT, FIXTURES, AND THE LIKE, SHALL BE BONDED WITH A RIGIDLY ATTACHED EQUIPMENT BONDING JUNCTION BOX TO THE EQUIPMENT.
9. MECHANICAL/ELECTRICAL BONDING OF METALLIC RACEWAY SYSTEM.
10. ALL EXISTING RECEPTABLES UNDER NEW OUTSIDE OF THE BUILDING THAT ARE TO REMAIN SHALL BE REPLACED WITH NEW DEVICES AND COVER PLATES AND WIRE BACK TO EXISTING CONDUITS.

KEYNOTES	
P1	WIRE TO SPARE 24V, 1POLE CIRCUIT BREAKER IN EXISTING DESIGNATED PANELBOARD.
P2	ACCESS CONTROL SECURITY JUNCTION BOX MOUNTED ABOVE CEILING FOR THE SECURITY DEVICES AND WIRING TO THE NEAREST DEPENDENT RECEPTACLE CIRCUIT IN THIS ROOM.
P3	TECHNOLOGY RACK/BACKSHEETS COORDINATE MOUNTING LOCATIONS FOR INSTALLATION OF EQUIPMENT. TECHNOLOGY CONTRACTORS PRIOR TO ROUGH-IN PROVIDE #10 CONDUCTORS.
P4	TECHNOLOGY RACK/BACKSHEET RECEPTABLES REFER TO DETAIL "26-002" FOR MOUNTING LOCATIONS AND INSTALLATION REQUIREMENTS. PROVIDE #10 CONDUCTORS.
P6	WIRING AND CONTROLLERS FOR THE BASKETBALL BACKSTOP ARE PROVIDED BY THE BACKSTOP MANUFACTURER. CONDUITS, BACKBOXES, AND WIRING ARE PROVIDED BY DIVISION 26 CONTRACTOR PER THE MANUFACTURERS REQUIREMENTS.
P7	SCOREBOARD BY OTHERS. PROVIDE POWER RECEPTACLE AT THIS LOCATION, REFER TO ARCHITECTURAL SECTIONS AND ELEVATION ELEVATIONS DRAWINGS SPEC FOR THE EXACT LOCATION AND INSTALLATION REQUIREMENTS OF THE SCOREBOARD.
P8	ALL SWITCHES FOR EQUIPMENT ARE PROVIDED BY THE EQUIPMENT MANUFACTURER.
P9	NO EXPOSED CONDUIT PERMITTED BELOW THE BOTTOM CHORD OF THE CEILING TRUSS IN THIS ROOM UNLESS NECESSARY BY THE DIVISION 26 CONTRACTOR.
P10	PROVIDE ROUGH-INS NOW FOR THE FUTURE BATTING GAGE. RUN A 3/4 INCH CONDUIT TO THE CRM EQUIPMENT CONTAINER AND ANOTHER 3/4 INCH TO PANEL BOARD 14 IN PANEL BOARD 14.
P12	CONTROLLER FOR BACKSTOPS, DIVIDER CURTAIN, AND FUTURE BATTING GAGES CONDUITS, BACKBOXES, AND WIRING ARE PROVIDED BY THE DIVISION 26 CONTRACTOR PER THE MANUFACTURERS REQUIREMENTS.




EQUIPMENT PLATFORM POWER PLAN

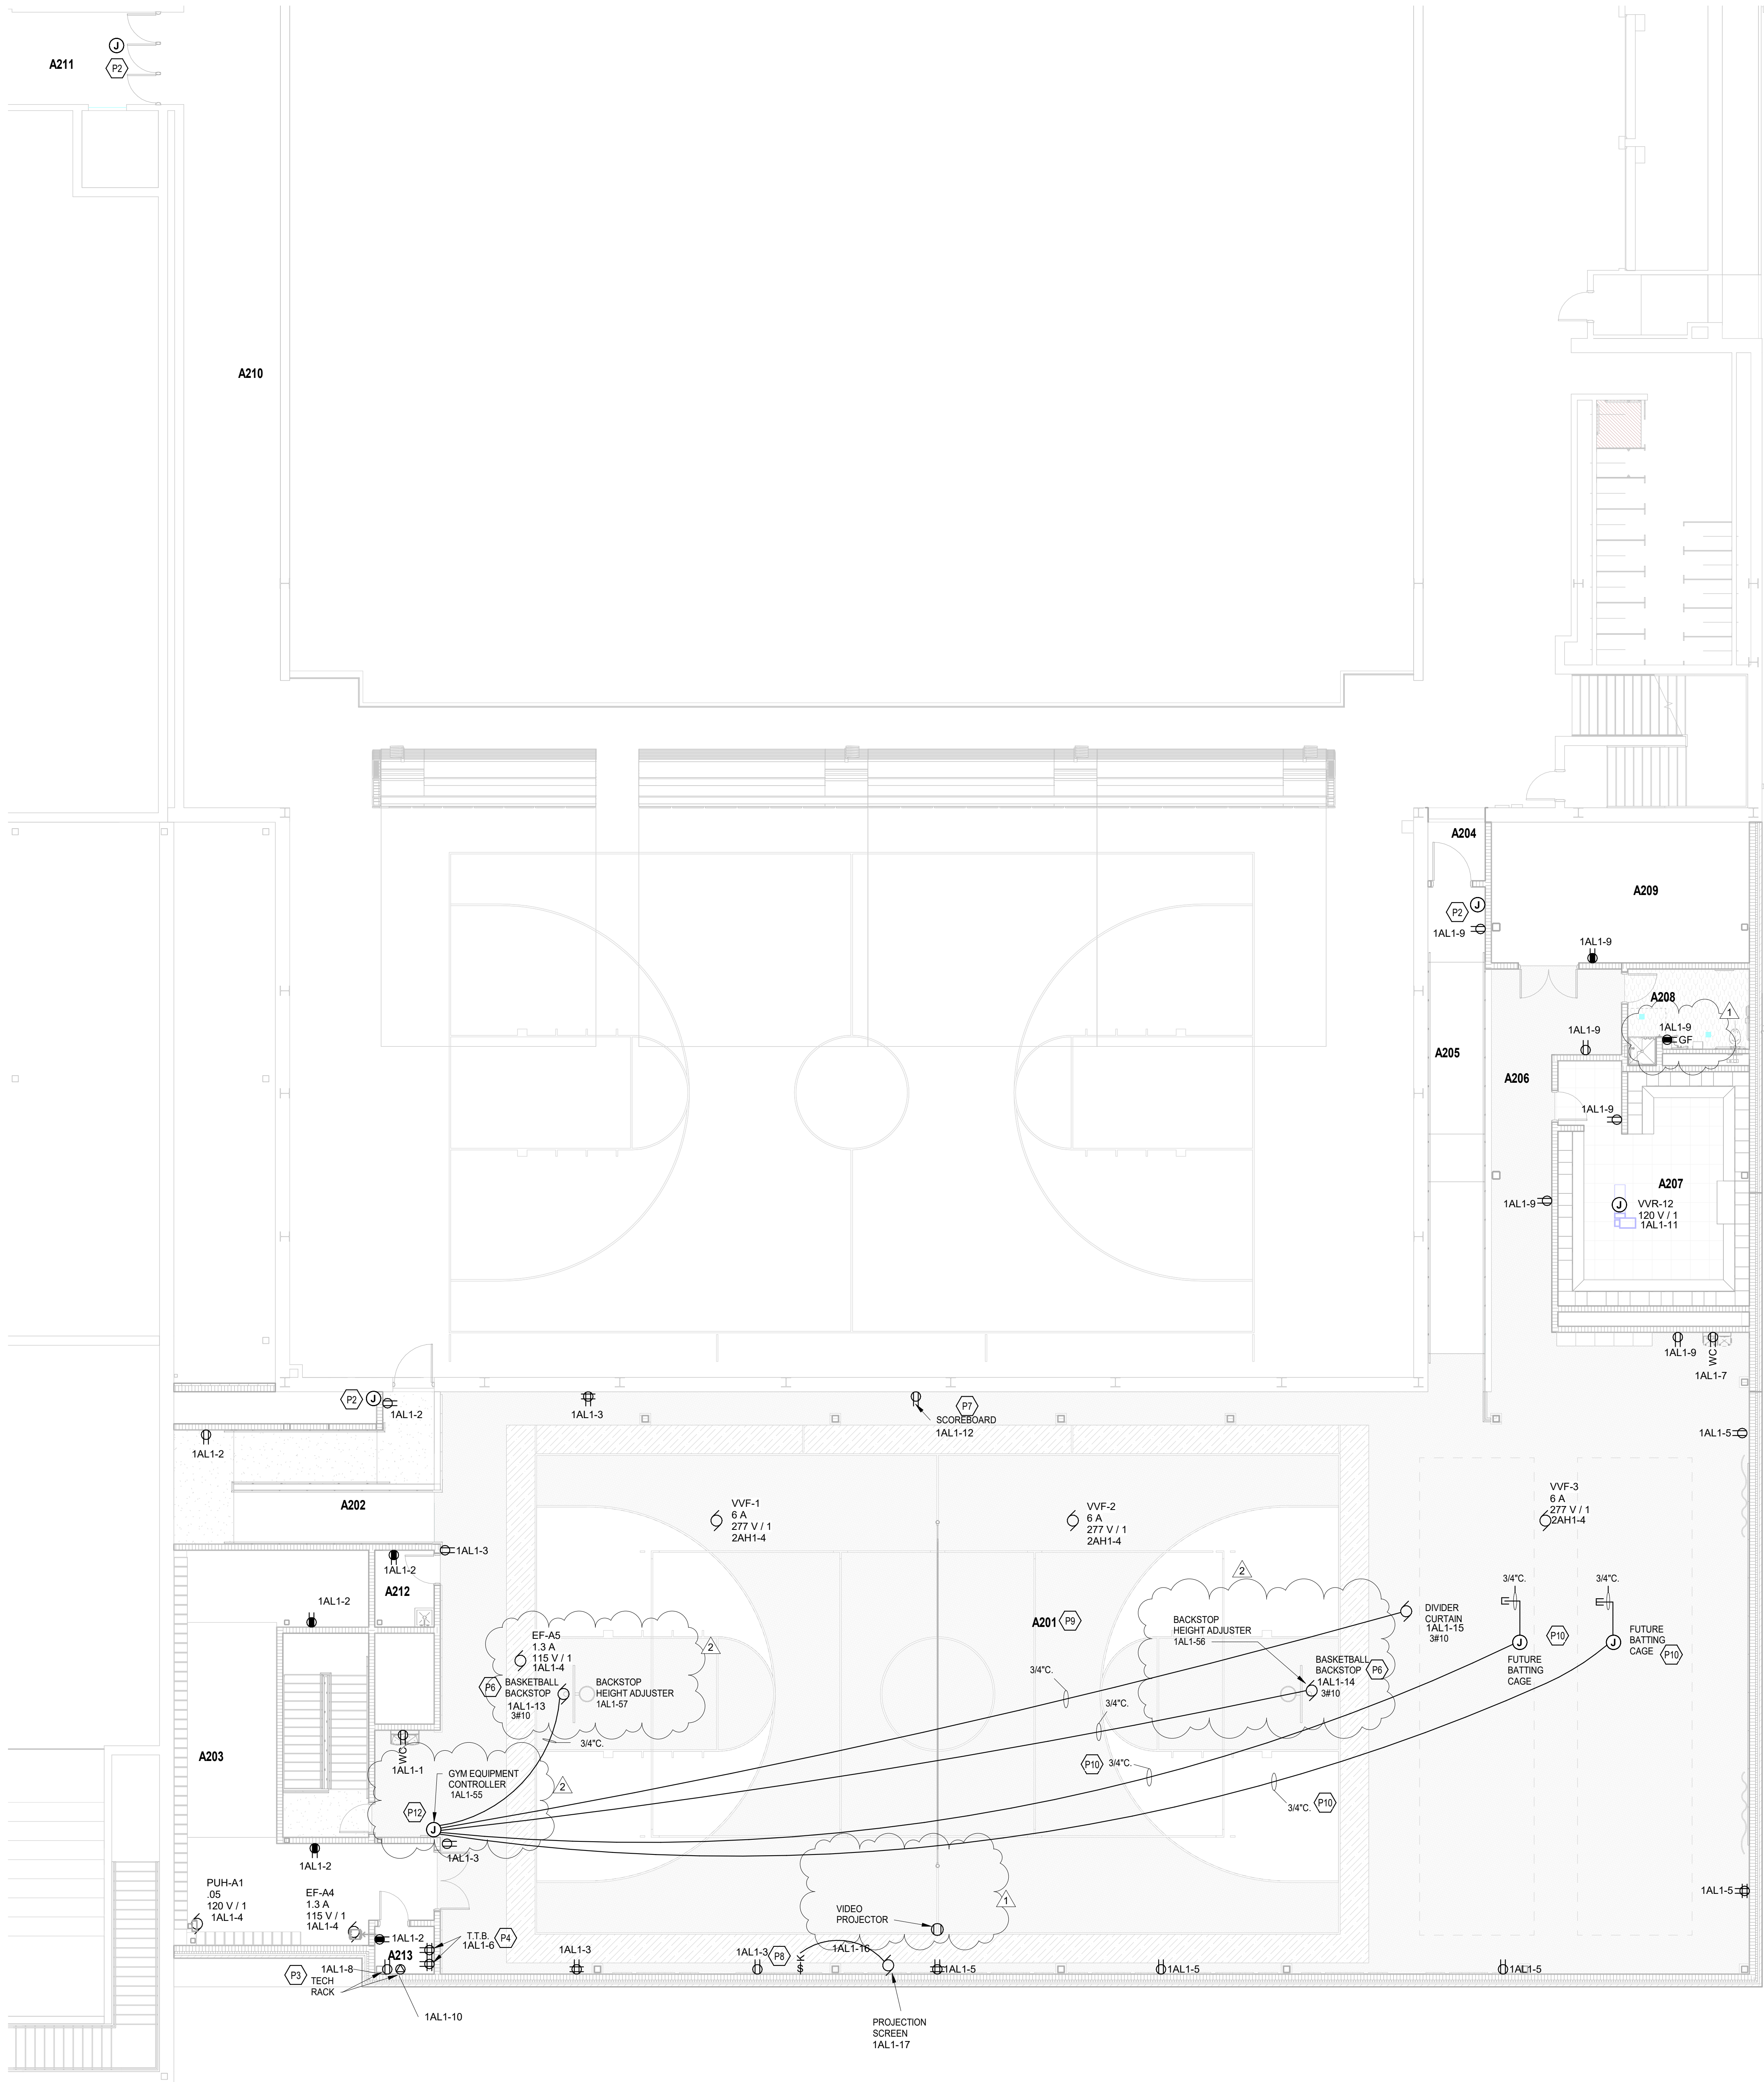

SECOND FLOOR POWER PLAN

SCALE: 1/8" = 1'-0"

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ROOM LEGEND			
ROOM NO.	OWNER ROOM NO.	ROOM NAME	AREA (SF)
114'-0" - 2ND FLOOR MP			
A201		MULTIPURPOSE	8616 SF
A202		RAMP 1	345 SF
A203		STORAGE	682 SF
A205		RAMP 2	317 SF
A206		CORRIDOR	310 SF
A207		LOCKERS	494 SF
A208		BATHROOM	112 SF
A209		STORAGE	399 SF
A211		EXISTING CORRIDOR	1219 SF
A212		SERVICE	50 SF
A213		IT CLOSET	31 SF
FIRST FLOOR			
A143		VESTIBULE	108 SF
A147		LOCKERS	806 SF
A149		VESTIBULE	44 SF
S1		STAIR	174 SF
SECOND FLOOR			
A204		VESTIBULE	46 SF
A210		EXISTING CORRIDOR	1422 SF
C203		Room	1098 SF
XAE204		EXISTING CORRIDOR	2568 SF

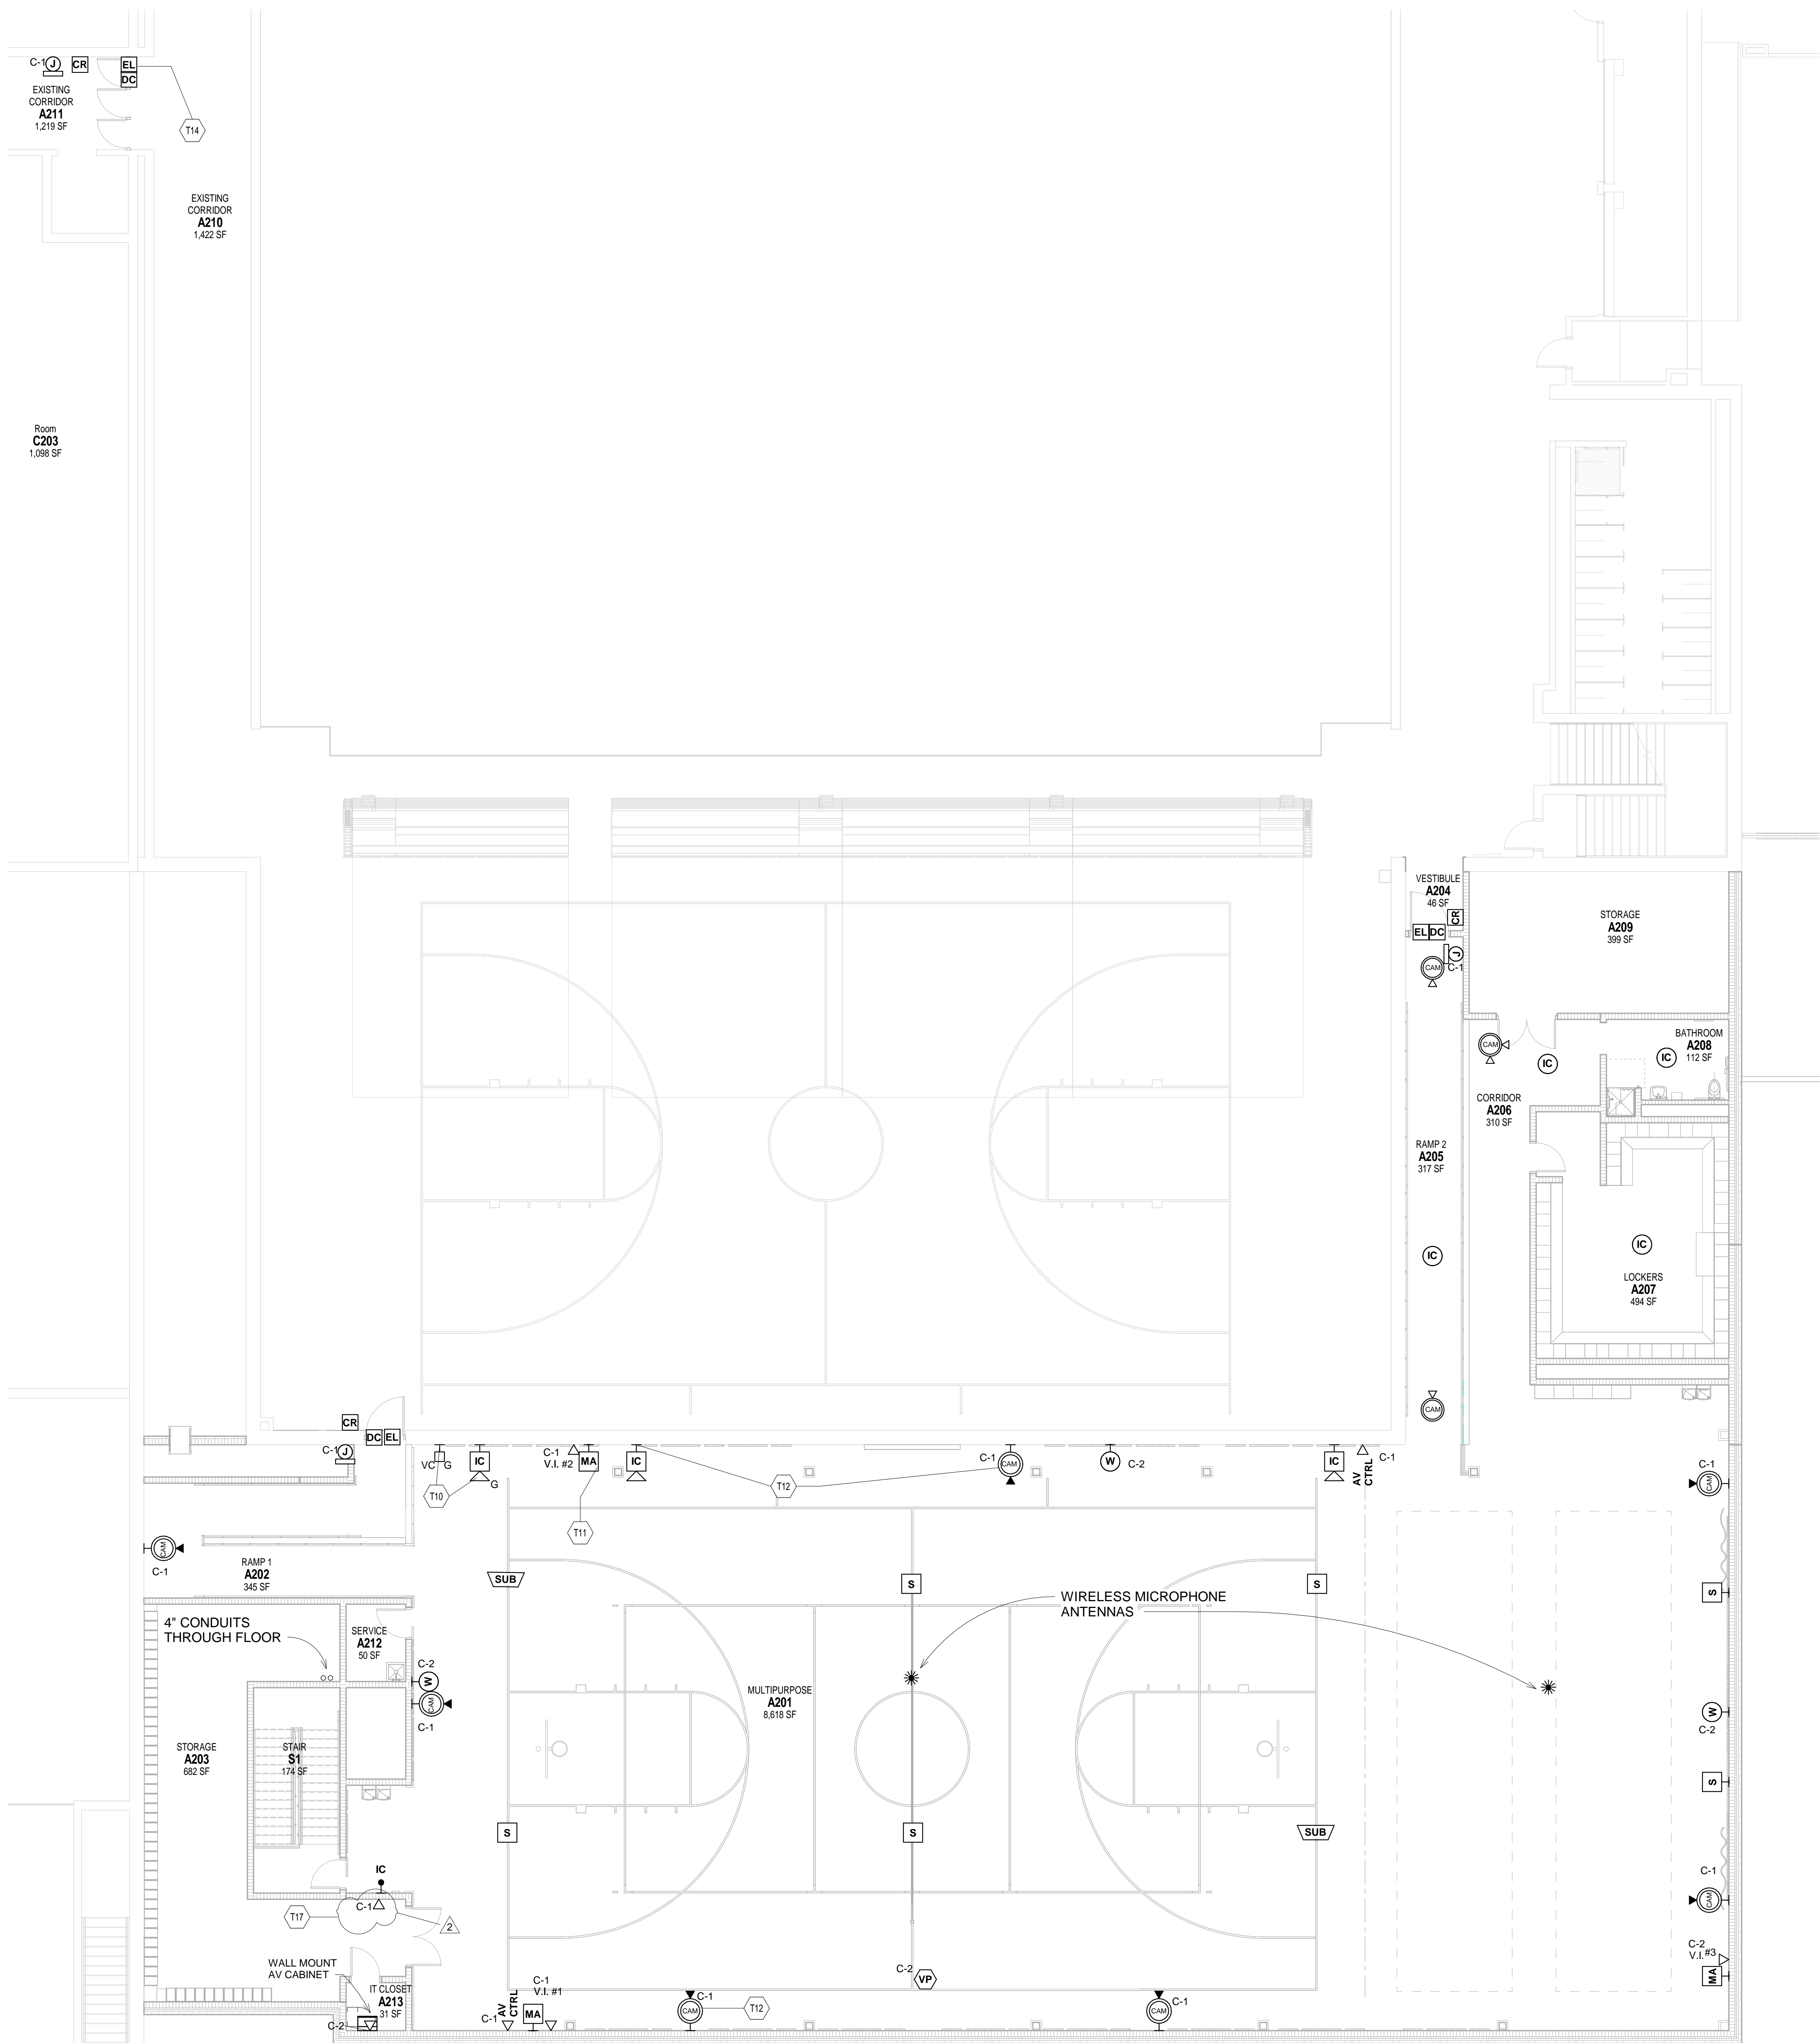TECHNOLOGY PLAN GENERAL NOTES

A. DEVICES SHALL BE INSTALLED AT LOCATIONS SHOWN ON DRAWINGS. LOCATIONS OF DEVICES SHALL BE COORDINATED WITH OTHER ELECTRICAL DEVICES/ CASEWORK/ ARCHITECTURAL FEATURES AND OTHER TRADES PRIOR TO ROUGH-IN. IF RELOCATION OF DEVICES IS REQUIRED DUE TO LACK OF COORDINATION BETWEEN ELECTRICAL DRAWINGS AND OTHER TRADES, ANY ASSOCIATED COSTS SHALL BE RESPONSIBILITY OF ELECTRICAL CONTRACTOR.

TECHNOLOGY PLAN NOTES

(ALL NOTES MAY NOT BE INDICATED ON THIS SHEET)

NOTE

T10 SPEAKERS AND VOLUME CONTROLS MARKED WITH A 'G' IS EQUIPMENT FOR THE VARSITY GYM MONITORING SOUND SYSTEM AS SHOWN ON T501 NOTE #8.

T11 PROVIDE LOCKABLE WALL BOXES AS SHOWN ON T501 DETAIL #6.

T12 EQUIPMENT LOCATED IN MULTIPURPOSE ROOM A201 SHALL HAVE PROTECTIVE WIRE/PLASTIC GUARDS TO PROTECT IT FROM GYMNASIUM ACTIVITIES.

T14 ROUGH IN DOOR CONTROL CABLE AND ALL CONTROL/MONITORING HARDWARE TO THESE 3 INTERIOR DOORS. THESE WILL TERMINATE TO THE NEAREST VERKADA ACP.

T17 LEAVE A 25' COIL AND TERMINATE THIS CABLE WITH JACK MODULE IN A SINGLE PORT SURFACE MOUNT BOX.

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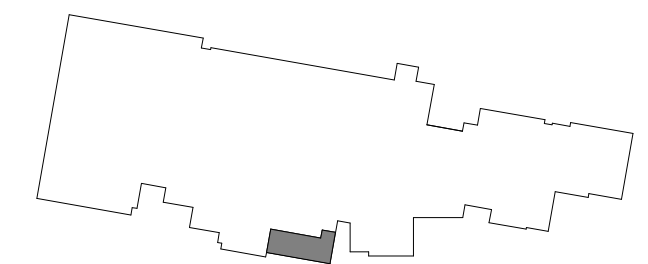
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ARCHITECT


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KEY PLAN

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PROJECT MANAGER: JAM
DRAWN BY: CDT
PROJECT NUMBER: 224018.00
PROJECT ISSUE DATE: 01-21-2025

REV. NO.	DESCRIPTION	DATE
2	Addendum #2	2-18-25

SECOND FLOOR TECHNOLOGY PLAN

T-12

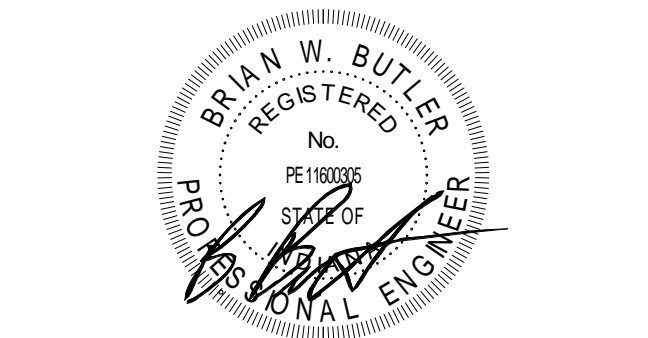VERIFICATION NOTE

CONTRACTOR SHALL VERIFY ALL DIMENSIONS AND CLEARANCES AND ALL EXISTING FIELD CONDITIONS BEFORE STARTING CONSTRUCTION. COMMENCEMENT OF WORK CONSTITUTES ACCEPTANCE OF CONDITIONS.

SHOULD DIFFERENT CONDITIONS BE ENCOUNTERED, CONTACT THE ARCHITECT BEFORE PROCEEDING WITH WORK.