

**ADDENDUM  
NO. 1**

**March 15, 2024**

Carmel Middle School Intense Behavior  
Support Program  
300 S. Guilford Road  
Carmel, IN 46032

**TO: ALL BIDDERS OF RECORD**

This Addendum forms a part of and modifies the Bidding Requirements, Contract Forms, Contract Conditions, the Specifications and the Drawings dated February 15, 2024, by Fanning/Howey. Acknowledge receipt of the Addendum in the space provided on the Bid Form. Failure to do so may subject the Bidder to disqualification.

This Addendum consists of Pages ADD 1-1 and attached Fanning/Howey Addendum No. 1, dated March 15, 2024, consisting of 2 items, 1 page and Revised Drawing Sheets: G1.0 and E4.01

**A. SPECIFICATION SECTION 01 12 00 – MULTIPLE CONTRACT SUMMARY**

Paragraph 3.03 A. Bid Category No. 1 – General Trades

Delete the following Specification Section:

Section 32 12 16 - Asphalt Paving

ADDENDUM NO. 1

Carmel Middle School – Intense Behavior Support Program (IBSP)

Carmel Clay Schools  
Carmel, Indiana

Project No. 222009.01

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Addendum No. 1, 2 items, 1 page  
Revised Drawing Sheets: G1.0 and E4.01

March 15, 2024

I hereby certify that this Addendum was prepared by me or under my direct supervision and that I am a duly registered Architect/Engineer under the Laws of the State of Indiana.

FANNING/HOWEY ASSOCIATES, INC.  
ARCHITECTS/ENGINEERS/CONSULTANTS



Paul A. Miller, License No. AR10800161  
Expiration Date: 12/31/2025

TO: ALL BIDDERS OF RECORD

ADDENDUM NO. 1 to Drawings and Project Manual, dated February 15, 2024, for the Carmel Middle School – Intense Behavior Support Program for Carmel Clay Schools, 5201 E. 131<sup>st</sup> St., Carmel, Indiana 46033; as prepared by Fanning/Howey Associates, Inc., Indianapolis, Indiana.  
This Addendum shall hereby be and become a part of the Contract Documents the same as if originally bound thereto.

The following clarifications, amendments, additions, revisions, changes, and modifications change the original Contract Documents only in the amount and to the extent hereinafter specified in this Addendum.

Each bidder shall acknowledge receipt of this Addendum in his proposal or bid.

NOTE: Bidders are responsible for becoming familiar with every item of this Addendum. (This includes miscellaneous items at the very end of this Addendum.)

RE: ALL BIDDERS

ITEM NO. 1. PROJECT MANUAL, SECTION 32 12 16 – ASPHALT PAVING

- A. Delete this Section in its entirety.


ITEM NO. 2. REVISED DRAWING SHEETS

- A. Drawing Sheets: G1.0 and E4.01 has been revised, dated 3/11/24, and are included with and hereby made a part of this Addendum. These Drawings supersede the original documents.

END OF ADDENDUM



LUMINAIRE SCHEDULE									
PLAN TYPE	MANUFACTURER/CATALOG	MOUNTING	LAMPS				APPLIED VOLTAGE	DESCRIPTION	VA LOAD
			NO.	WATTS	TYPE	LUMENS			
LAV2X	KENALL BHR54 SERIES KIRLIN VRL SERIES AMICO AMBIENT EQUAL OR A/E APPROVED EQUAL	RECESSED	1	25 W	LED	2500 lm	277 V	4-FOOT BY 4-INCH VANDAL RESISTANT LED ARCHITECTURAL FIXTURE, EXTRUDED ALUMINUM CONSTRUCTION, WITH FROSTED LENS, DIE-CAST ROUNDED END CAPS, 0-10VDC DIMMING DRIVER, 80+ CRI, 3000K. PROVIDE WITH EMERGENCY BATTERY DRIVER.	25 VA
LV2	LITHONIA CPX SERIES METALUX CST SERIES COLUMBIA CFP SERIES	RECESSED	1	35 W	SOLID STATE LED	4000 lm	277 V	2 BY 4-FOOT BACK-LIT FLAT PANEL TROFFER, 10% DIMMING, 4000K, 80+ CRI.	35 VA
LV2A	LITHONIA CPX SERIES ALS LPTW SERIES COLUMBIA VSY24 SERIES	RECESSED	1	35 W	SOLID STATE LED	4000 lm	277 V	2 BY 4-FOOT BACK-LIT FLAT PANEL TROFFER, 10% DIMMING, COLOR TUNING FROM 2700K-6500K, 80+ CRI.	35 VA
LV2AX	LITHONIA CPX SERIES ALS LPTW SERIES COLUMBIA VSY24 SERIES	RECESSED	1	35 W	SOLID STATE LED	4000 lm	277 V	2 BY 4-FOOT BACK-LIT FLAT PANEL TROFFER, 10% DIMMING, COLOR TUNING FROM 2700K-6500K, 80+ CRI., WITH EMERGENCY BATTERY DRIVER.	35 VA
LV2X	LITHONIA CPX SERIES METALUX CST SERIES COLUMBIA CFP SERIES	RECESSED	1	35 W	SOLID STATE LED	4000 lm	277 V	2 BY 4-FOOT BACK-LIT FLAT PANEL TROFFER, 10% DIMMING, 4000K, 80+ CRI., WITH EMERGENCY BATTERY DRIVER.	35 VA
XC	SURE-LITES CX SERIES CHLORIDE 55 LINE SERIES LITHONIA SIGNATURE SERIES DUAL-LITE SEMPRA SERIES OR A/E APPROVED EQUAL	SURFACE CEILING	1	3 W	RED LED	0 lm	277 V	CAST ALUMINUM AC ONLY EXIT SIGN, SINGLE FACE, DIRECTIONAL ARROWS INDICATED, WHITE HOUSING. REFER TO PROJECT MANUAL FOR ADDITIONAL REQUIREMENTS.	3 VA

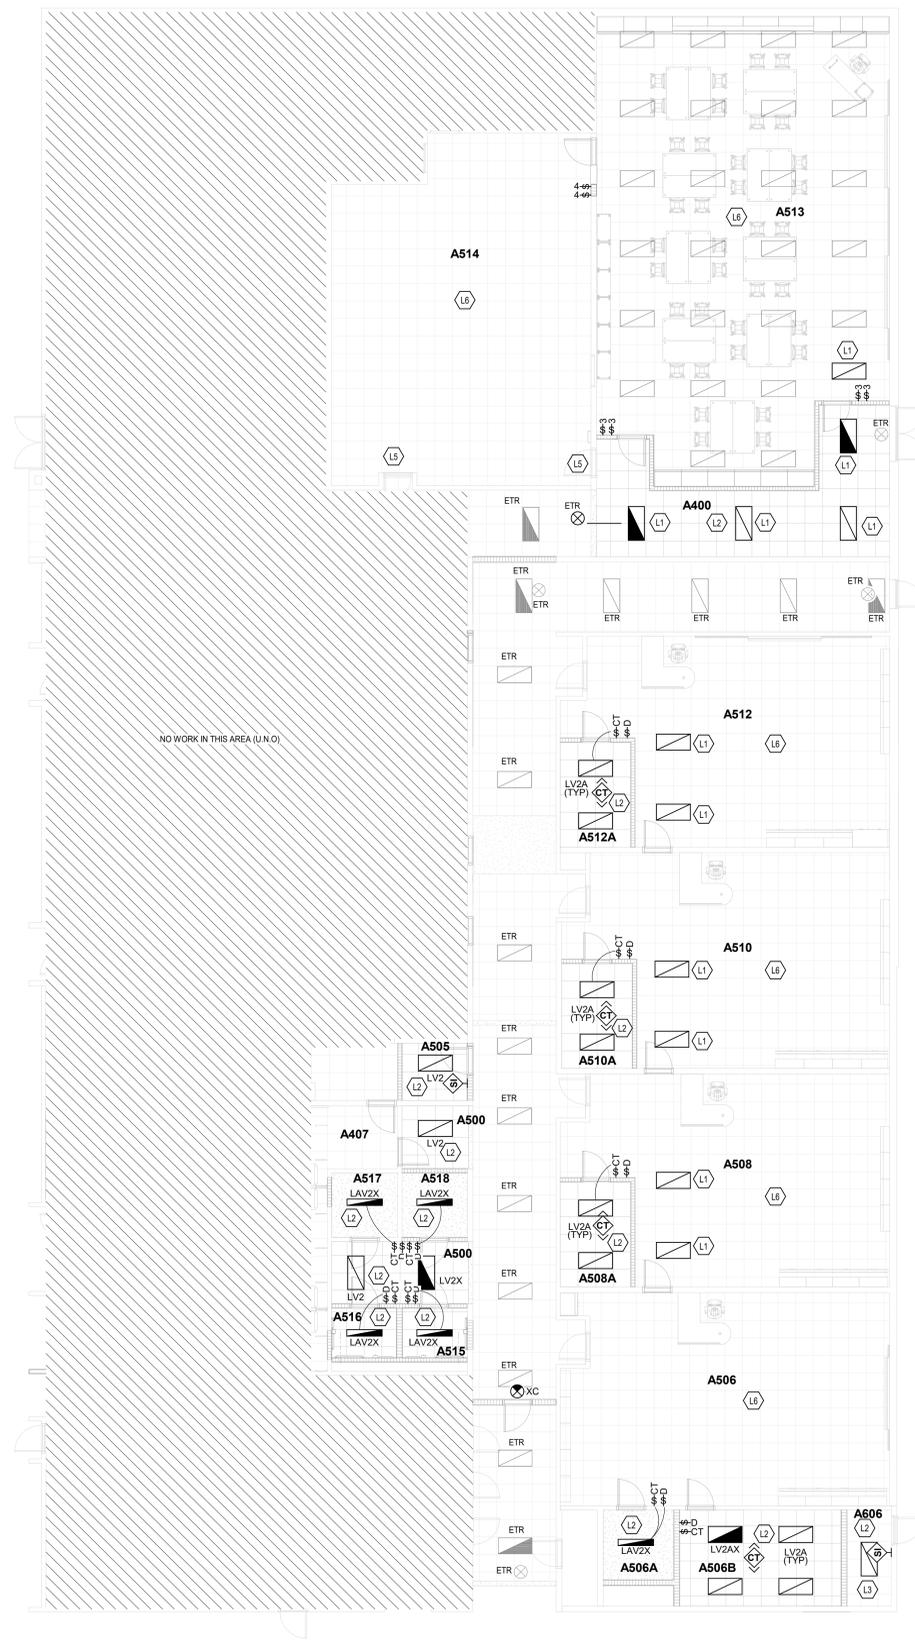

**LIGHTING PLAN**  
SCALE: 1/8" = 1'-0"

ROOM LEGEND - FIRST FLOOR		
ROOM NO.	ROOM NAME	AREA (SF)
A400	CORRIDOR	891 SF
A407	TEACHER BREAKROOM	990 SF
A410	SCIENCE LAB	1153 SF
A411x	CLASSROOM	1124 SF
A500	CORRIDOR	1446 SF
A505	STORAGE	48 SF
A506	IBSP CLASSROOM	888 SF
A506A	SECLUSION	64 SF
A506B	STUDENT BREAKROOM	201 SF
A507	SENSORY ROOM	117 SF
A508	IBSP CLASSROOM	783 SF
A508A	STUDENT BREAKROOM	99 SF
A510	IBSP CLASSROOM	784 SF
A510A	STUDENT BREAKROOM	96 SF
A511	THERAPIST OFFICE	187 SF
A511A	TECHNOLOGY	68 SF
A512	IBSP CLASSROOM	771 SF
A512A	STUDENT BREAKROOM	96 SF
A513	MODULAR LAB	1660 SF
A513ax	STORAGE	236 SF
A514	PRODUCTION	1113 SF
A514ax	STORAGE	191 SF
A515	RESTROOM	42 SF
A516	RESTROOM	42 SF
A517	SECLUSION	55 SF
A518	SECLUSION	55 SF
A519x	ELEC.	48 SF
A606	STORAGE	55 SF

KEYNOTES	
L1	LIGHT FIXTURE RELOCATED FROM EXISTING LOCATION SHOWN ON ED 1
L2	CORRECT TO LIGHTING TO CIRCUITS TIED BACK DURING DEMOLITION.
L3	INSTALL EXISTING 2X4 LIGHT FIXTURE REMOVED FROM OTHER SPACES DURING DEMOLITION.
L5	REMOVE 3-WAY SWITCHES AT THIS DOOR. PROVIDE NEW 4-WAY SWITCHES AND WIRING. CONNECT ALL AWAY SWITCHING IN THIS ROOM TO CONTROL THE LIGHTING WITH BI-LEVEL SWITCHING AT THE 3 DOORS INTO THE SPACE.
L6	LIGHTING AND CONTROLS IN THIS SPACE ARE EXISTING TO REMAIN, UNLESS NOTED OTHERWISE.


# CARMEL MIDDLE SCHOOL - INTENSE BEHAVIOR SUPPORT PROGRAM (IBSP)

300 SOUTH GUILFORD ROAD  
CARMEL, IN 46032



ARCHITECT  
**FANNING HOWE**

317-848-0966 WWW.FHAI.COM

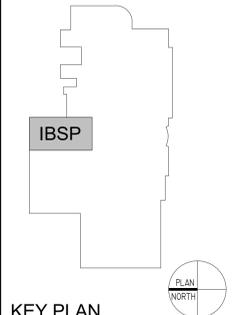

CONSTRUCTION DOCUMENTS



DRAWN BY: AMN  
PROJECT NUMBER: 222009.01  
PROJECT ISSUE DATE: 02/15/2024

REV. NO.	DESCRIPTION	DATE
1	ADDENDUM #1 REVISIONS	3-11-2024

LIGHTING PLAN  
**E4.01**